

S S B

387 East Main Street

Rochester, NY 14604-2107 Voice: 585.232.8300 Fax: 585.232.9221 www.swbr.com

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ROCHESTER, NEWYORK

THESE DOCUMENTS AND ALL THE IDEAS, ARRANGEMENTS, DESIGNA

Bergmann architects // engineers // planners

28 East Main Street 200 First Federal Plaza Rochester, New York 14614-1909 office: 585.232.5135

fax: 585.232.4652 www.bergmannpc.com

REVISIONS

no. date by description

PROJECT:

COBBS HILL VILLAGE

CLIENT:
ROCHESTER MGMT
249 NORTON VILLAGE
LANE
ROCHESTER, NY 14609

OVERALL DEMOLITION
PLAN


C-080

NO. drawn by P. HILL checked A. HART proj. mgr. proj. no. 15915.00

STATUS:
SITE PLAN APPLICATION

ISSUE DATE:

E: 04.21.2017

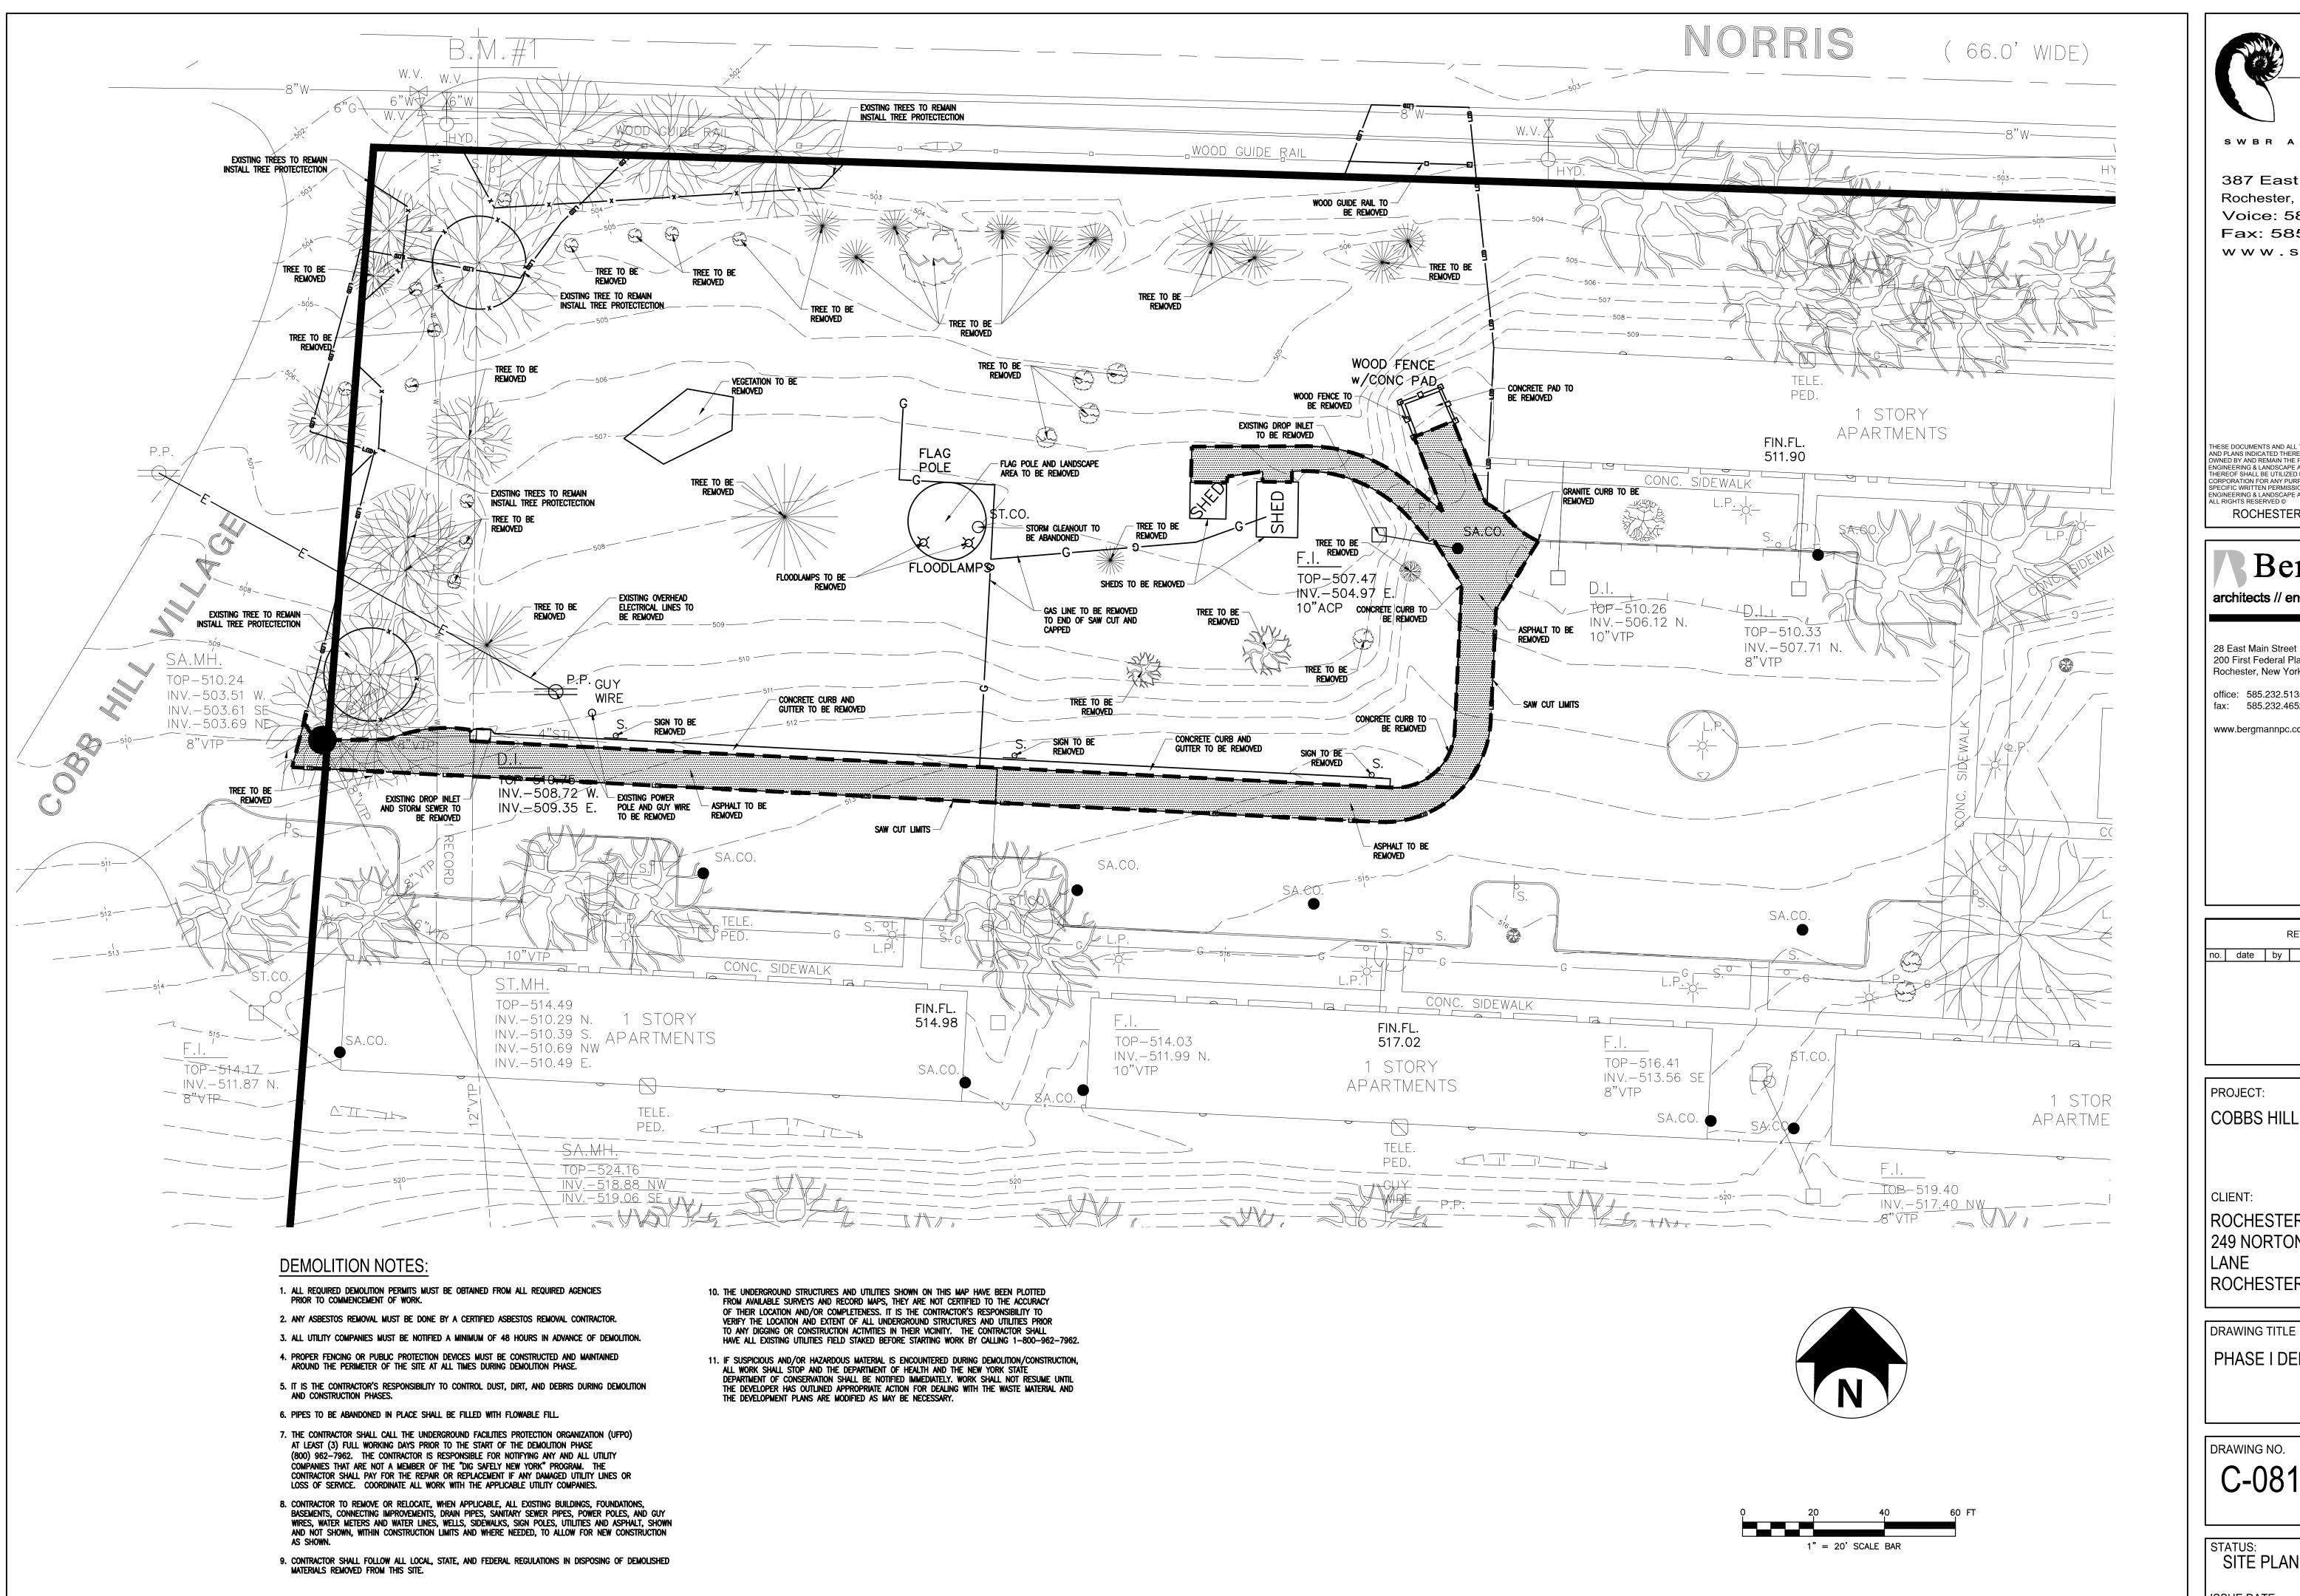



SWBR ARCHITECTS

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PROJECT:

COBBS HILL VILLAGE

ROCHESTER MGMT 249 NORTON VILLAGE LANE ROCHESTER, NY 14609


DRAWING TITLE PHASE I DEMOLITION PLAN

drawn by P. HILL

DRAWING NO. C-08² proj. mgr. proj. no. 15915.00

SITE PLAN APPLICATION

ISSUE DATE:

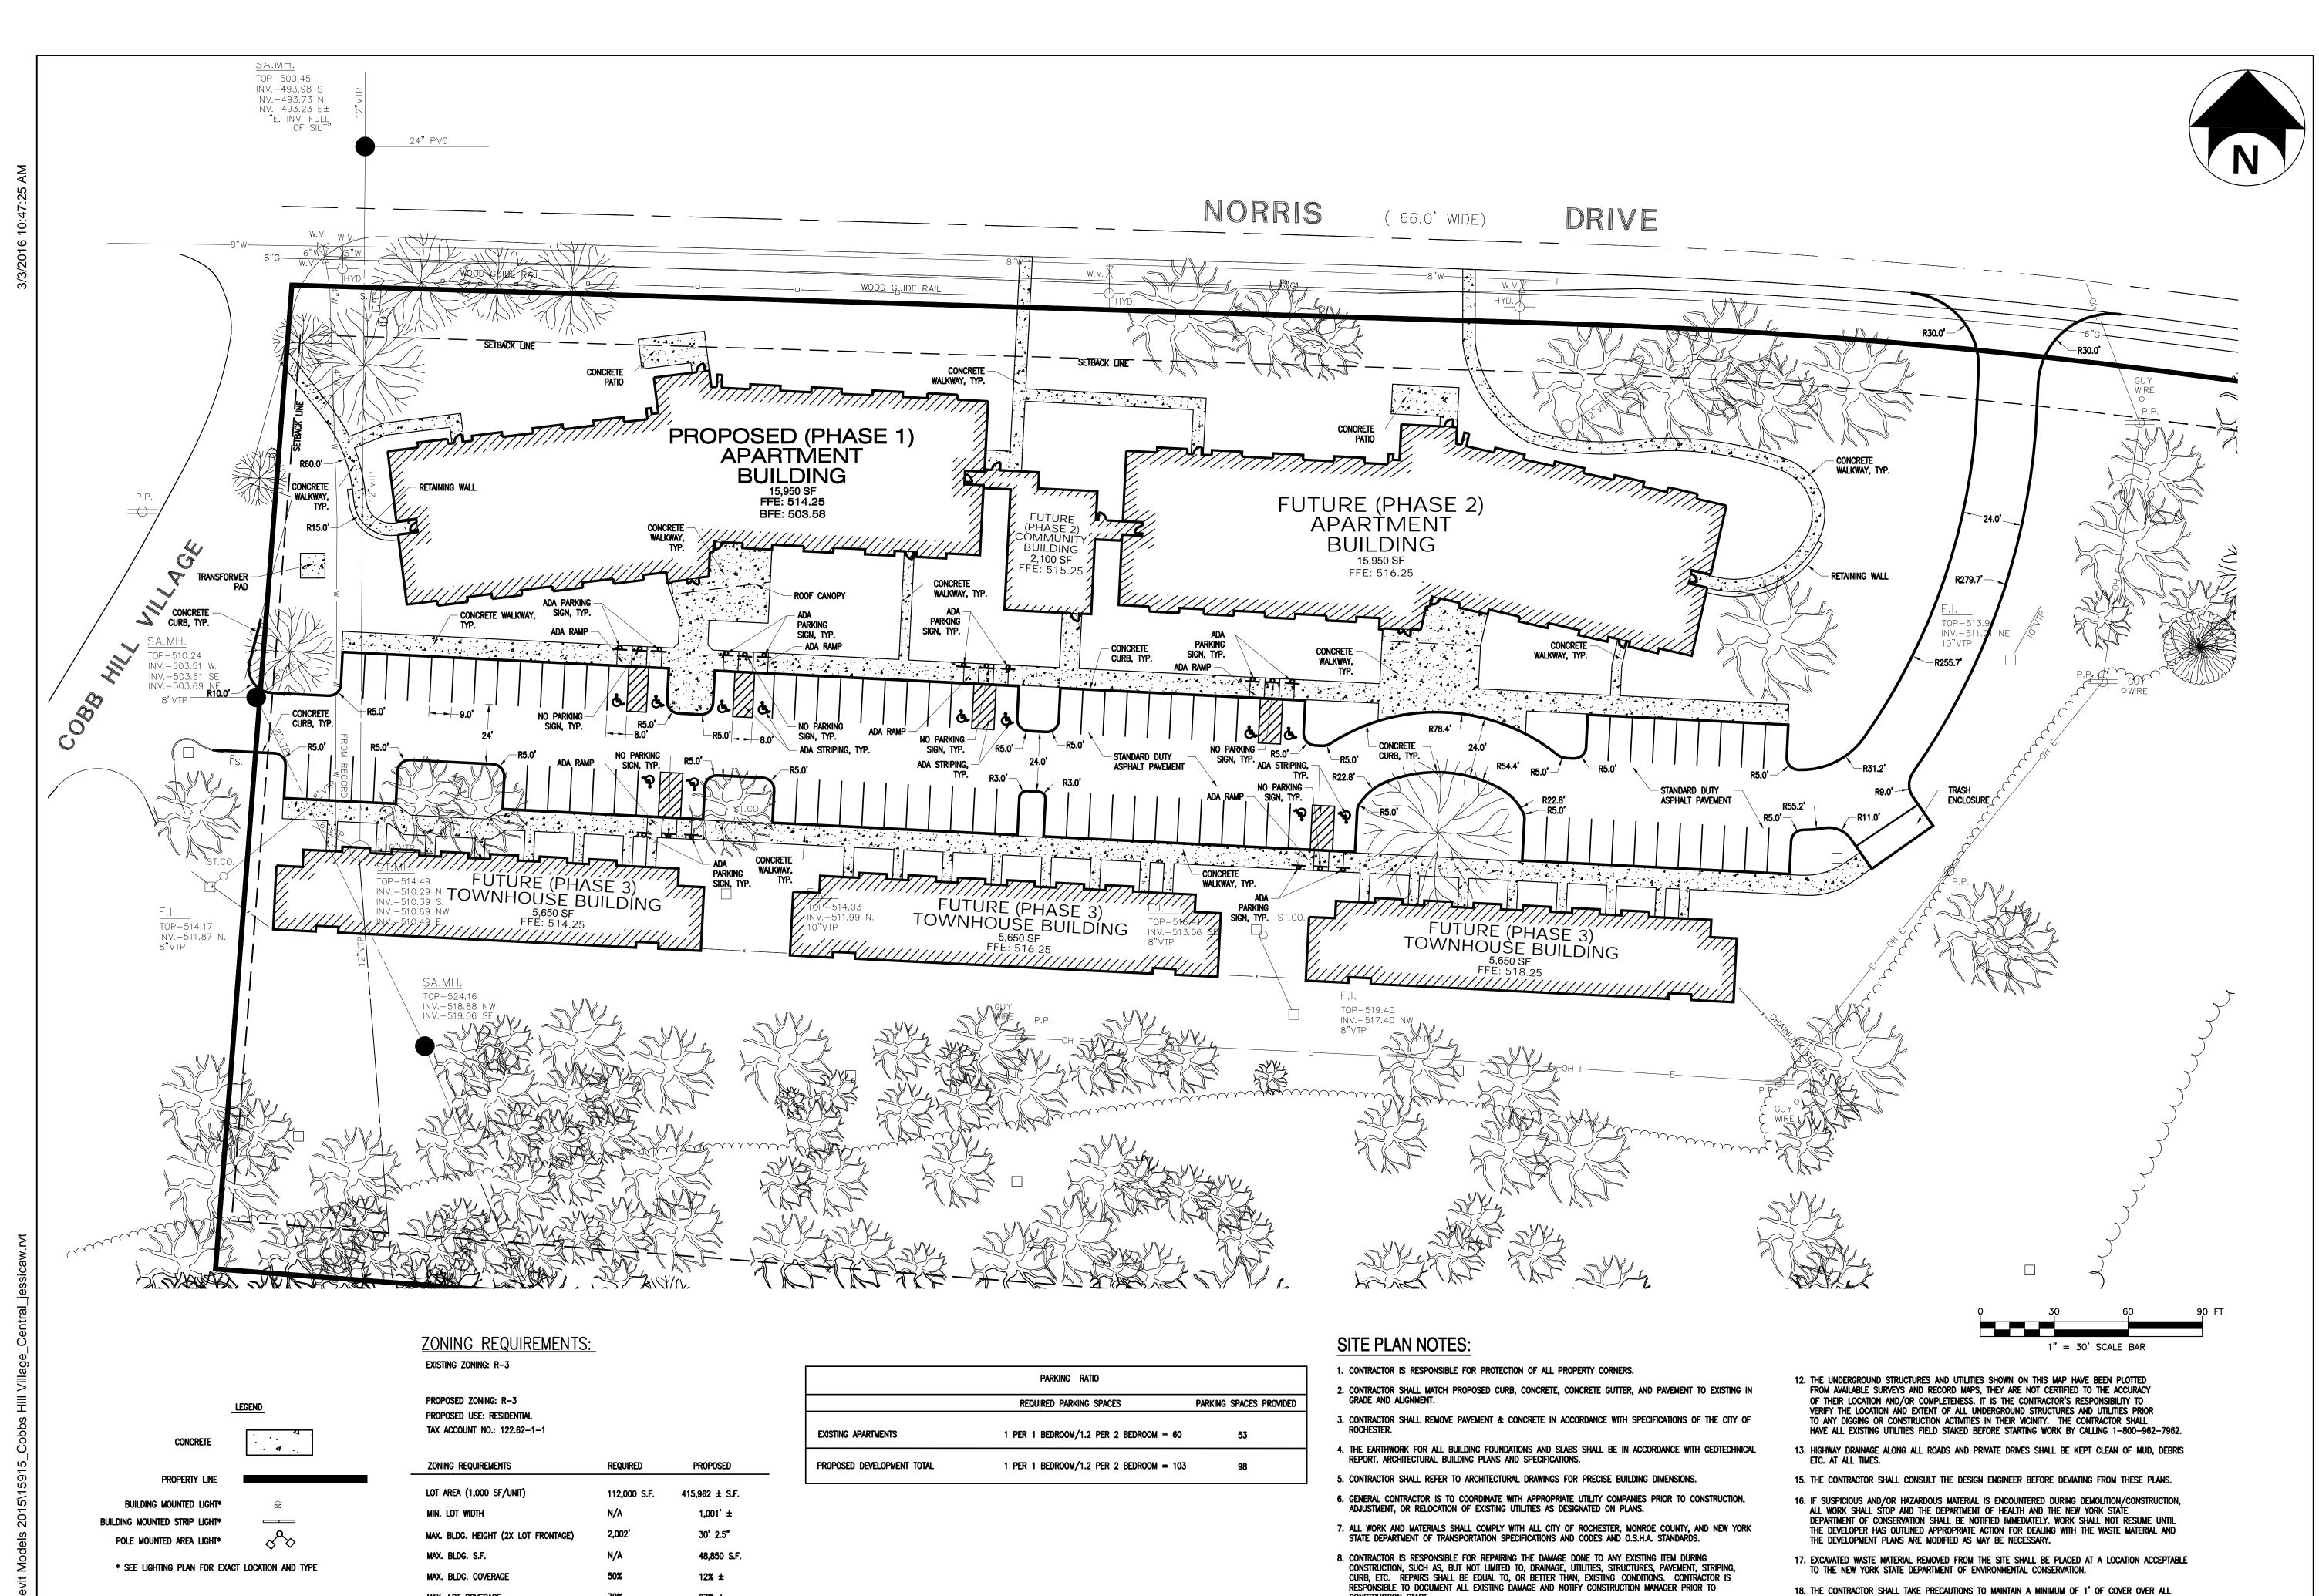

CONSTRUCTION START.

9. ALL CONCRETE TO HAVE A MINIMUM 28 DAY COMPRESSION STRENGTH OF 3,000 psi, OR AS NOTED.

10. ALL UNSURFACED AREAS DISTURBED BY GRADING OPERATIONS SHALL RECEIVE TOPSOIL TO A COMPACTED DEPTH OF 4 INCHES, SEED, MULCH AND WATER.

11. ALL NECESSARY INSPECTIONS AND/OR CERTIFICATIONS REQUIRED BY CODES AND/OR UTILITY SERVICE

COMPANIES SHALL BE PERFORMED PRIOR TO ANNOUNCED BUILDING POSSESSION AND FINAL

MAX. LOT COVERAGE

FRONT BLDG. SETBACK:

SIDE BUILDING SETBACK:

REAR BUILDING SETBACK:

27% ±

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PROJECT: COBBS HILL VILLAGE

ROCHESTER MGMT 249 NORTON VILLAGE ROCHESTER, NY 14609

DRAWING TITLE OVERALL SITE PLAN

EXISTING AND NEW STORM AND SANITARY PIPES DURING ALL CONSTRUCTION OPERATIONS.

19. ALL EXISTING SURFACE APPURTENANCES (I.E. WATER VALVES, CATCH BASIN FRAMES AND GRATES, MANHOLE COVERS) WITHIN THE PROJECT LIMITS SHALL BE ADJUSTED TO FINISHED GRADE. (NO


DATED MAY 1, 2008, AND ANY SUBSEQUENT APPENDICES.

20. UNLESS COVERED BY THE CONTRACT SPECIFICATIONS OR AS NOTED ON THE PLANS, ALL WORK SHALL CONFORM TO THE NEW YORK STATE DEPARTMENT OF TRANSPORTATION STANDARD SPECIFICATIONS

proj. no. 15915.00

SITE PLAN APPLICATION

ISSUE DATE:

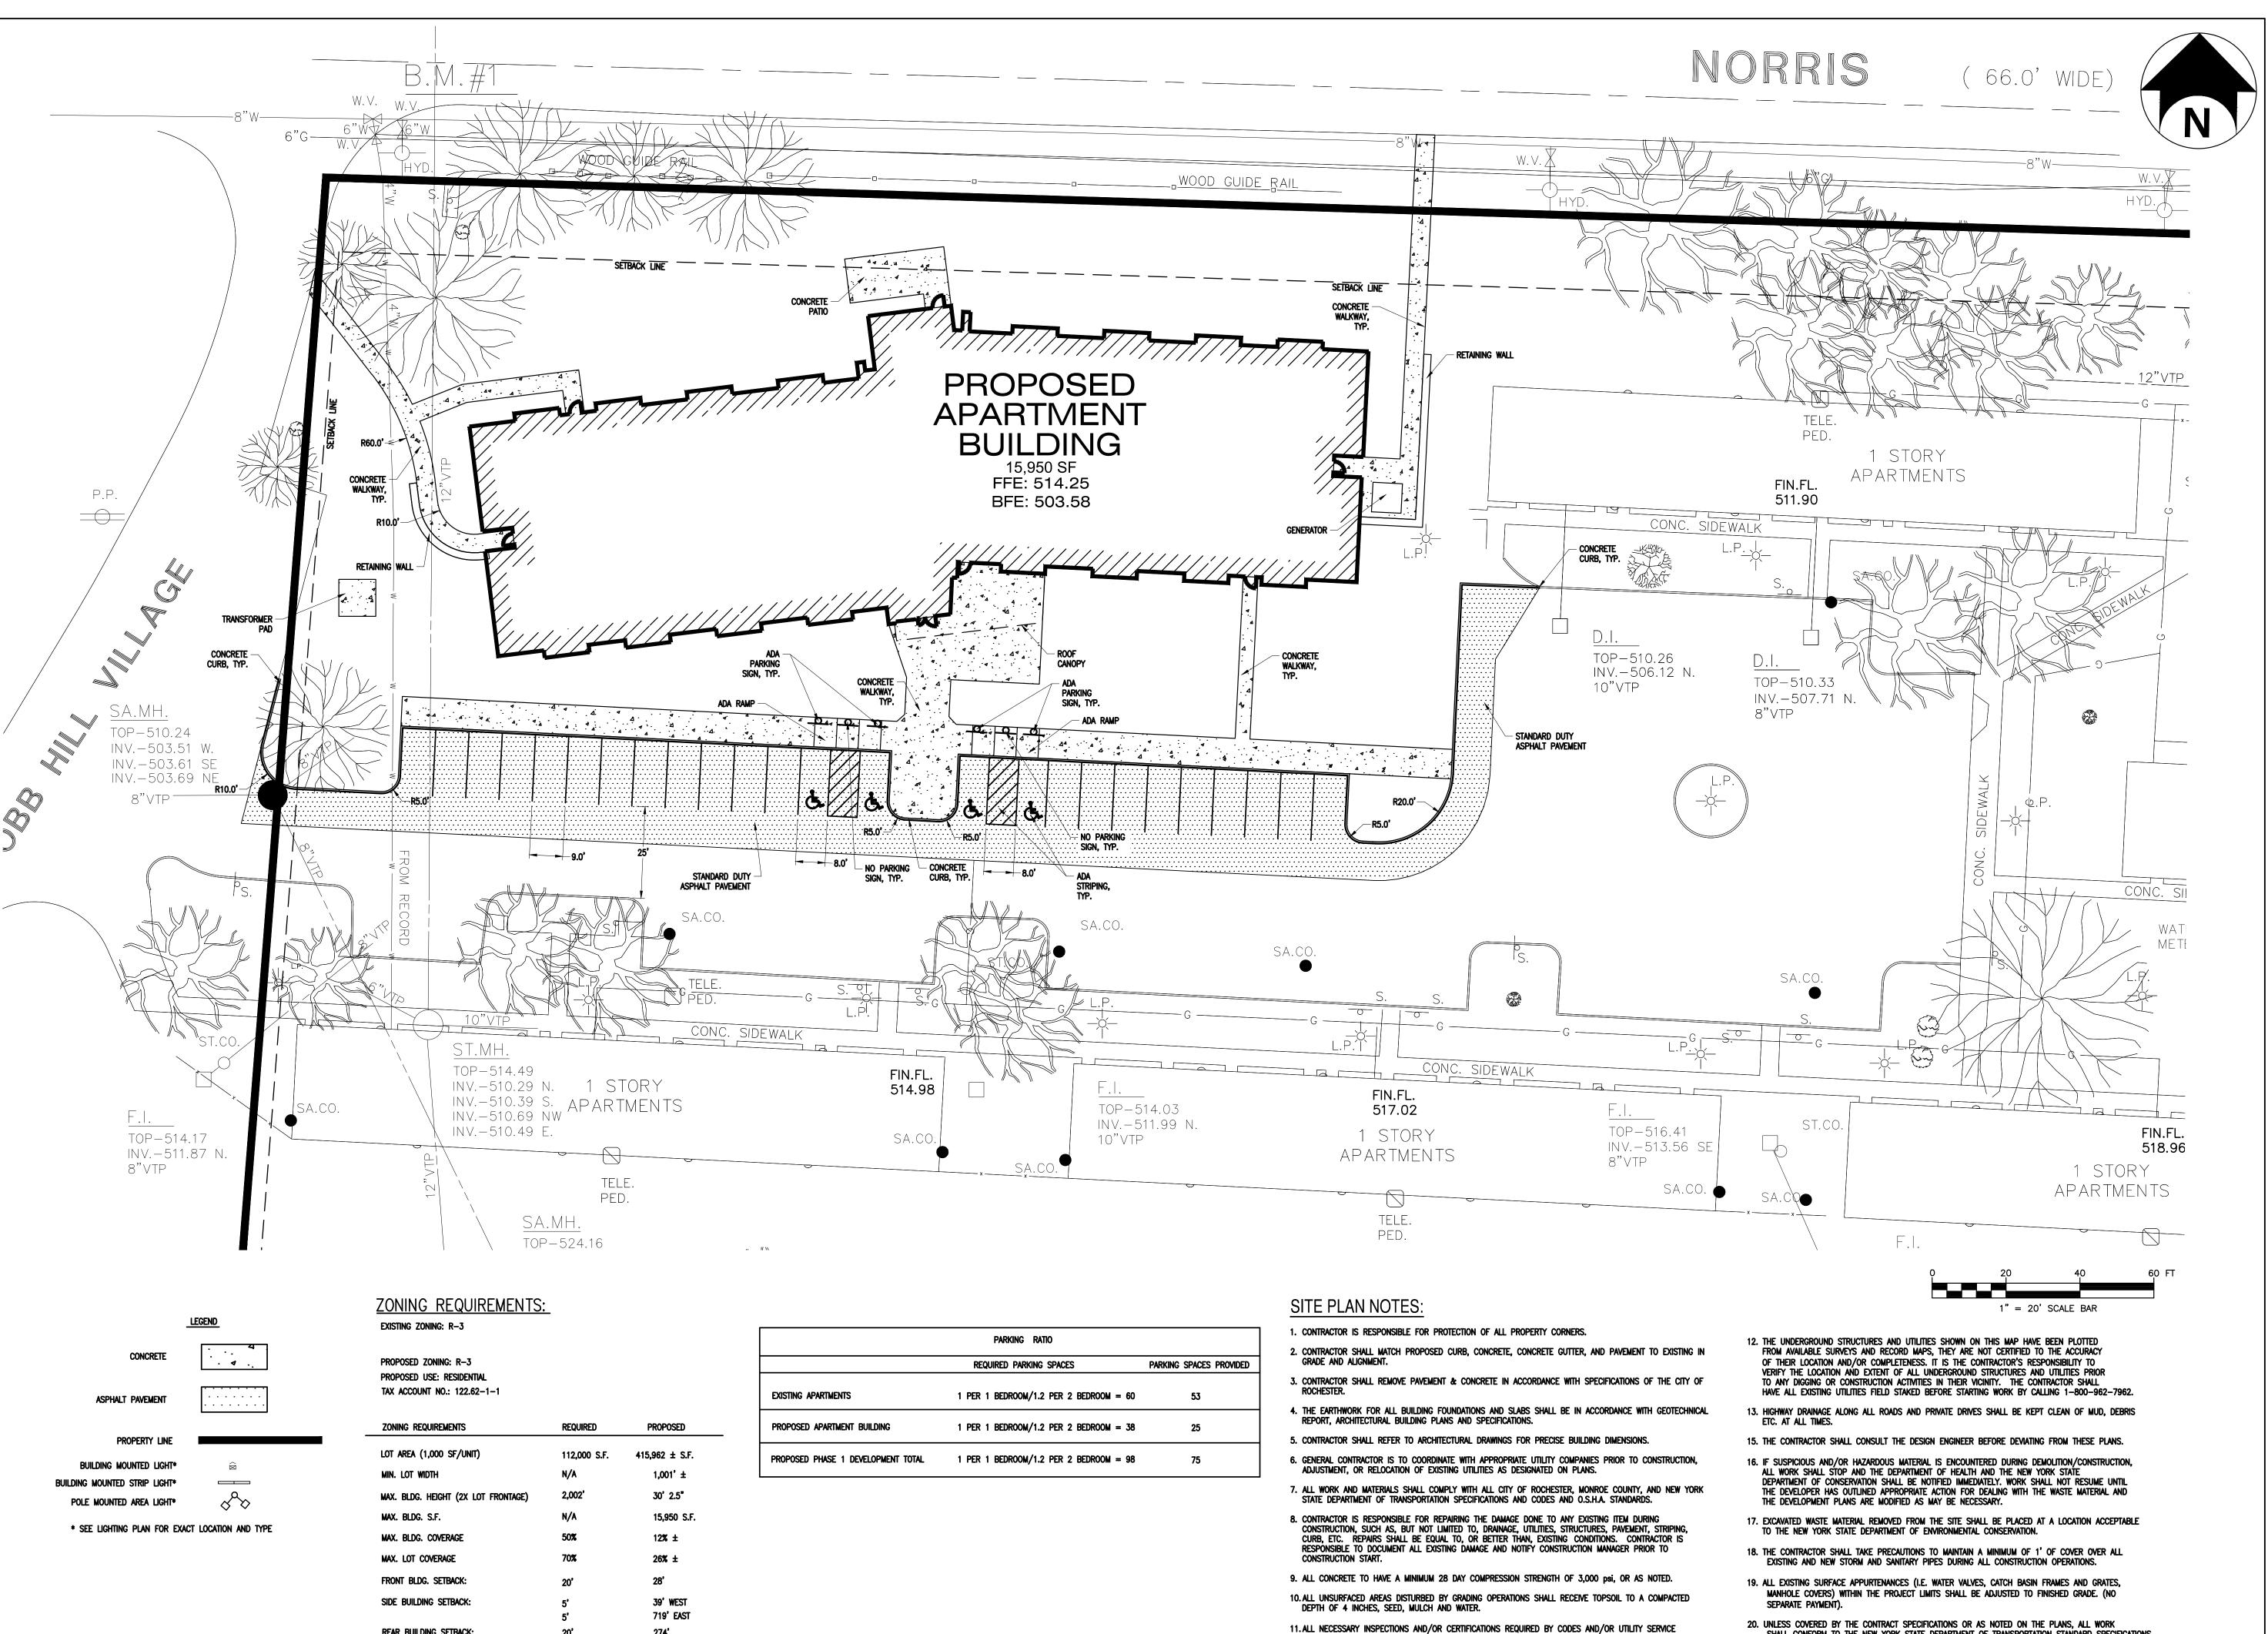

REAR BUILDING SETBACK:

274'

SWBR ARCHITECTS

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REVISIONS							
0.	date	by	description				

PROJECT: COBBS HILL VILLAGE

ROCHESTER MGMT 249 NORTON VILLAGE ROCHESTER, NY 14609

DRAWING TITLE PHASE I SITE PLAN

proj. mgr. proj. no. 15915.00

SITE PLAN APPLICATION

ISSUE DATE:

SHALL CONFORM TO THE NEW YORK STATE DEPARTMENT OF TRANSPORTATION STANDARD SPECIFICATIONS

DATED MAY 1, 2008, AND ANY SUBSEQUENT APPENDICES.

COMPANIES SHALL BE PERFORMED PRIOR TO ANNOUNCED BUILDING POSSESSION AND FINAL

UTILITY PLAN NOTES:

- 1. CONTRACTOR IS RESPONSIBLE FOR REPAIRS OF DAMAGE TO ANY EXISTING UTILITY DURING CONSTRUCTION AT NO COST TO THE OWNER.
- 2. ALL FILL MATERIAL IS TO BE IN PLACE, AND COMPACTED BEFORE INSTALLATION OF PROPOSED UTILITIES.
- WHERE WATER CROSSES BELOW STORM OR SANITARY, EITHER;
 A. MAINTAIN MINIMUM 18" VERTICAL SEPARATION;
 B. CONSTRUCT SEWER USING WATER MAIN STANDARD PIPE AND TESTING SAID PIPE AT 150 PSI; OR
 C. ENCASE WATER OR SEWER FOR TWO FULL LENGTHS OF WATER PIPE.
- 4. ALL UTILITIES SHOULD BE KEPT TEN (10') APART (PARALLEL) OR WHEN CROSSING 18" VERTICAL CLEARANCE (OUTSIDE EDGE OF PIPE TO OUTSIDE EDGE OF PIPE.)
- 5. LINES UNDERGROUND SHALL BE INSTALLED, INSPECTED AND APPROVED BEFORE
- 6. TOPS OF EXISTING MANHOLES AND WATER VALVE BOXES SHALL BE ADJUSTED AS NECESSARY TO BE FLUSH WITH FINAL PAVEMENT ELEVATIONS.
- 7. ALL CONCRETE FOR ENCASEMENTS AND THRUST BLOCKS SHALL HAVE A MINIMUM
- 28 DAY COMPRESSION STRENGTH AT 3,000 P.S.I. UNLESS NOTED OTHERWISE.
- 8. CONTRACTOR IS RESPONSIBLE FOR COMPLYING TO THE CONSTRUCTION REQUIREMENTS OF THE CITY OF ROCHESTER AND MONROE COUNTY PURE WATERS WITH REGARDS TO LATERALS AND INSTALLATION OF THE SEWER LINES.
- 9. ALL NECESSARY INSPECTIONS AND/OR CERTIFICATIONS REQUIRED BY CODES AND/OR UTILITY SERVICE COMPANIES SHALL BE PERFORMED PRIOR TO ANNOUNCED BUILDING POSSESSION AND THE FINAL
- CONTRACTOR SHALL COORDINATE WITH ALL UTILITY COMPANIES FOR INSTALLATION REQUIREMENTS AND SPECIFICATIONS AND NOTIFY INSPECTORS 72 HOURS BEFORE CONNECTING TO ANY EXISTING LINE.
- 11. CONTRACTOR SHALL REFER TO ARCHITECTURAL PLANS AND SPECIFICATIONS FOR ACTUAL LOCATION OF ALL UTILITY ENTRANCES TO INCLUDE SANITARY SEWER LATERALS, DOMESTIC, AND FIRE PROTECTION WATER SERVICE, ELECTRICAL, TELEPHONE, AND GAS SERVICES. CONTRACTOR SHALL COORDINATE INSTALLATION OF UTILITIES, IN SUCH A MANNER AS TO AVOID CONFLICTS AND ASSURE PROPER DEPTHS ARE ACHIEVED AS WELL AS COORDINATING WITH TOWN UTILITY REQUIREMENTS AS TO LOCATION AND SCHEDULING FOR TIE-INS/CONNECTIONS PRIOR TO CONNECTING TO EXISTING LITTLES.

- 12. CONTRACTOR SHALL COMPLY TO THE FULLEST EXTENT
 WITH THE LATEST STANDARDS OF OSHA DIRECTIVES OR
 ANY OTHER AGENCY HAVING JURISDICTION FOR
 EXCAVATION AND TRENCHING PROCEDURES. THE
 CONTRACTOR SHALL USE SUPPORT SYSTEMS, SLOPING,
 BENCHING, AND OTHER MEANS OF PROTECTION. THIS TO
 INCLUDE BUT NOT LIMITED FOR ACCESS AND EGRESS FROM
 ALL EXCAVATION AND TRENCHING. CONTRACTOR IS RESPONSIBLE
 TO COMPLY WITH PERFORMANCE CRITERIA FOR OSHA.
- 13. REFER TO BUILDING ELECTRICAL PLANS FOR SITE LIGHTING ELECTRICAL CIRCUITRY DESIGN AND LAYOUT.
- 14. CONTRACTOR SHALL MAINTAIN A MINIMUM OF 5'-0" COVER ON ALL WATER LINES IN
- GRASS AREAS, AND MIN. 6'-0" COVER PAVEMENT AREAS.

 15. ALL ABANDONED WATER AND SEWER LINES TO BE ABANDONED PER THE CITY OF
- ROCHESTER AND MONROE COUNTY PURE WATERS SPECIFICATIONS.
- 16. BUILDING CONTRACTOR IS RESPONSIBLE FOR ALL UTILITY WORK WITHIN FIVE FEET OF RUILDING
- 17. CONTRACTOR SHALL FIELD VERIFY ALL PROPOSED & EXISTING PIPE INVERT ELEVATIONS BEFORE ORDERING MANHOLE AND CATCH BASIN STRUCTURES.
- 18. ALL STORM PIPE ENTERING STRUCTURES SHALL BE GROUTED TO ASSURE CONNECTION AT STRUCTURE IS WATERTIGHT.
- 19. ALL STORM STRUCTURES SHALL HAVE A SMOOTH UNIFORM POURED MORTAR INVERT FROM INVERT IN TO INVERT OUT.
- 20. THE UNDERGROUND STRUCTURES AND UTILITIES SHOWN ON THIS MAP HAVE BEEN PLOTTED FROM AVAILABLE SURVEYS AND RECORD MAPS, THEY ARE NOT CERTIFIED TO THE ACCURACY OF THEIR LOCATION AND/OR COMPLETENESS. IT IS THE CONTRACTOR'S RESPONSIBILITY TO VERIFY THE LOCATION AND EXTENT OF ALL UNDERGROUNDSTRUCTURES AND UTILITIES PRIOR TO ANY DIGGING OR CONSTRUCTION ACTIVITIES IN THEIR VICINITY. THE CONTRACTOR SHALL HAVE ALL EXISTING UTILITIES FIELD STAKED BEFORE STARTING WORK BY CALLING 1-800-962-7962 A MINIMUM OF 48 HOURS BEFORE COMMENCEMENT OF WORK TO HAVE ALL EXISTING UTILITIES FIELD STAKED OR MARKED WITHIN THE PROJECT AREA.
- 21. A LICENSED PLUMBER WILL BE RESPONSIBLE FOR PROVIDING ALL THE PREPARATION TO TAP THE 8" RWW MAIN. THE RWW WILL PERFORM THE WET TAP. THE TAPPING FEE WILL BE \$500. A DEPOSIT OF \$2,200 TO ABANDON BOTH EXISTING SERVICES WILL BE REQUIRED. IF THE PERMIT OFFICE ALLOWS, THE LICENSED PLUMBER HAS THE OPTION TO ABANDON THE EXISTING SERVICES AND THE RWW WILL REFUND THE DEPOSIT OTHERWISE, THE ROCHESTER WATER BUREAU WILL KEEP THE DEPOSIT AND PERFORM THE ABANDONMENTS. ALL FEES MENTIONED ABOVE WILL BE PAID AT THE PERMIT OFFICE, ALONG WITH THE METER FEES (BASED ON METER SIZES),ROAD CUT FEES AND ROWFEES (BASED ON SQUARE FOOTAGE).
- 22. AS DIRECTED BY MONROE COUNTY PURE WATERS REFER TO MCPW NOTE 7, CONTRACTOR TO DETERMINE IF THE EXISTING LATERAL CAN BE UTILIZIED FOR CONNECTION AND REPAIR IF NECESSARY.

MCPW - ROCHESTER PURE WATERS DISTRICT SEWER

- 1. THIS PLAN REQUIRES APPROVAL AND ISSUANCE OF A PLUMBING PERMIT FROM THE CITY OF
- 2. PRIOR TO CONSTRUCTION, A SEWER CONNECTION PERMIT MUST BE OBTAINED FROM THE MONROE COUNTY PURE WATERS (MCPW) PERMIT OFFICE AT 444 EAST HENRIETTA ROAD, BUILDING 15, ROCHESTER. NEW YORK 14620-4643, PHONE #753-7600

ROCHESTER PLUMBING DEPARTMENT.


- 3. SEWER CONNECTION PERMIT(S) CAN ONLY BE ISSUED TO A PLUMBER LICENSED IN THE CITY OF ROCHESTER AND WHO IS FULLY INSURED AND BONDED IN THE ROCHESTER PURE WATERS DISTRICT (RPWD). PAYMENT (CHECK OR MONEY ORDER TO "RPWD") OF ALL APPLICABLE PERMIT FEES MUST BE PAID PRIOR TO PERMIT ISSUANCE.
- 4. THE RPWD SHALL BE NOTIFIED FORTY-EIGHT HOURS IN ADVANCE OF A CONNECTION OR TAP. [753-7600 (OPT. 5)]. THE RPWD SHALL MAKE ALL FOUR AND SIX INCH DIAMETER TAPS TO
- 5. SANITARY/STORM/COMBINATION SEWER LATERAL(S) AND APPURTENANCES SHALL BE CONSTRUCTED IN CONFORMANCE WITH THE REQUIREMENTS OF THE ROCHESTER PURE WATERS
- DISTRICT.
- 6. CLEANOUTS SHALL BE INSTALLED ON ALL 4" AND 6" DIAMETER SEWER LATERALS AT THE RIGHT-OF-WAY (ROW) LINE, OR THE SEWER EASEMENT LINE WHERE APPLICABLE. (THE SEWER EASEMENT, RIGHT-OF-WAY AND/OR PROPERTY LINE MUST BE STAKED OUT PRIOR TO INSTALLATION OF LOT LINE CLEANOUTS TO ENSURE PROPER LOCATION OF THE CLEANOUTS. [REFER TO CLEANOUT DETAIL FOR PROPER INSTALLATION]).

- 7. IF AN EXISTING LATERAL IS TO BE UTILIZED, THE PLUMBER/CONTRACTOR MUST ENSURE THAT THE LATERAL IS IN GOOD CONDITION AND IS FREE OF DEBRIS (DIRT, MUD, STONE, ROOTS, ETC.) VIA A VIDEO TAPED INSPECTION PERFORMED BY THE PLUMBER/CONTRACTOR OR HIS/HER/THEIR AGENT. PRIOR TO CONNECTION, THE VIDEO TAPED INSPECTION OF THE EXISTING LATERAL MUST BE PRESENTED TO THE DISTRICT FOR REVIEW AND APPROVAL TO UTILIZE AN EXISTING LATERAL. IT IS THE RESPONSIBILITY OF THE BUILDER OR THEIR AGENT
- 8. ANY NEW PORTION OF A SEWER LATERAL INSTALLED WITHIN THE PUBLIC RIGHT-OF-WAY AND SEWER EASEMENT MUST BE SDR-21 PVC.

TO CLEAN AND/OR REPLACE THE PIPE/LATERAL AS NEEDED.

- 9. ANY EXISTING LATERALS NOT UTILIZED MUST BE ABANDONED TO MONROE COUNTY PURE WATERS (MCPW) STANDARDS AT THE PROPERTY LINE OR, WHERE APPLICABLE, THE SEWER EASEMENT LINE.
- 10.FLOOR DRAINS IF CONSTRUCTED, SHALL BE CONNECTED TO THE SANITARY/COMBINATION SEWER. FLOOR DRAINS DO NOT INCLUDE FOUNDATION/FOOTER DRAINS. NOTE: ALL DISCHARGES TO THE SANITARY/COMBINATION SEWER MUST COMPLY WITH THE EFFLUENT LIMITS OF THE LOCAL AND/OR MONROE COUNTY SEWER USE LAW.
- 11. ANY PORTION OF A SEWER/LATERAL WITH LESS THAN FOUR-FEET (4') OF COVER WILL
 REQUIRE CONCRETE ENCASEMENT. SEWERS/LATERALS WITH LESS THAN THREE-FEET (3') OF
 COVER ARE NOT ALLOWED.
- 12. THE REQUIREMENTS OF THE HIGHWAY/PROPERTY OWNER SHALL BE ADHERED TO FOR ITEMS ABOVE THE PIPE BEDDING, INCLUDING, BUT NOT LIMITED TO, MAINTENANCE AND PROTECTION OF TRAFFIC, BACKFILL MATERIAL AND SURFACE RESTORATION.
- 13. CONTRACTOR TO CONFIRM EXISTING INVERT BEFORE CONSTRUCTION OF PROPOSED STORM SEWER SYSTEM.

		_
DNROE COUNTY HEALTH DEPARTMENT	ROCHESTER PURE WATERS DISTRICT	
		CITY OF ROCHESTER WATER BUREAU
		APPROVED BY:
		<u>X</u>
		DATE:

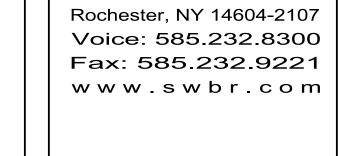

SWBR ARCHITECTS

387 East Main Street

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no. date by description

PROJECT:

COBBS HILL VILLAGE

CLIENT:
ROCHESTER MGMT
249 NORTON VILLAGE
LANE
ROCHESTER, NY 14609

DRAWING TITLE

OVERALL UTILITY PLAN

DRAWING NO.

C-110

drawn by P. HILL checked A. HART proj. mgr. proj. no. 15915.00

STATUS: SITE PLAN APPLICATION

ISSUE DATE: 04.21.2017

1" = 30' SCALE BAR

LEGEND:

PROPOSED WATER

PROPOSED GAS

LIGHTPOLE

WATER VALVE

FIRE HYDRANT

CLEAN-OUT

SANITARY MANHOLE

STORM CATCH BASIN

PROPOSED SANITARY SEWER

PROPOSED STORM SEWER

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SA.CO.

MCPW - ROCHESTER PURE WATERS DISTRICT SEWER

I. THIS PLAN REQUIRES APPROVAL AND ISSUANCE OF A PLUMBING PERMIT FROM THE CITY OF ROCHESTER PLUMBING DEPARTMENT.

TOP-514.17

- 2. PRIOR TO CONSTRUCTION, A SEWER CONNECTION PERMIT MUST BE OBTAINED FROM THE MONROE COUNTY PURE WATERS (MCPW) PERMIT OFFICE AT 444 EAST HENRIETTA ROAD, BUILDING 15, ROCHESTER. NEW YORK 14620-4643, PHONE #753-7600
- 3. SEWER CONNECTION PERMIT(S) CAN ONLY BE ISSUED TO A PLUMBER LICENSED IN THE CITY OF ROCHESTER AND WHO IS FULLY INSURED AND BONDED IN THE ROCHESTER PURE WATERS DISTRICT (RPWD). PAYMENT (CHECK OR MONEY ORDER TO "RPWD") OF ALL APPLICABLE PERMIT FEES MUST BE PAID PRIOR TO PERMIT ISSUANCE.
- 4. THE RPWD SHALL BE NOTIFIED FORTY—EIGHT HOURS IN ADVANCE OF A CONNECTION OR TAP. [753-7600 (OPT. 5)]. THE RPWD SHALL MAKE ALL FOUR AND SIX INCH DIAMETER TAPS TO
- 5. SANITARY/STORM/COMBINATION SEWER LATERAL(S) AND APPURTENANCES SHALL BE CONSTRUCTED IN CONFORMANCE WITH THE REQUIREMENTS OF THE ROCHESTER PURE WATERS
- 6. CLEANOUTS SHALL BE INSTALLED ON ALL 4" AND 6" DIAMETER SEWER LATERALS AT THE RIGHT-OF-WAY (ROW) LINE, OR THE SEWER EASEMENT LINE WHERE APPLICABLE. (THE SEWER EASEMENT, RIGHT-OF-WAY AND/OR PROPERTY LINE MUST BE STAKED OUT PRIOR TO INSTALLATION OF LOT LINE CLEANOUTS TO ENSURE PROPER LOCATION OF THE CLEANOUTS. [REFER TO CLEANOUT DETAIL FOR PROPER INSTALLATION]).

- 7. IF AN EXISTING LATERAL IS TO BE UTILIZED, THE PLUMBER/CONTRACTOR MUST ENSURE THAT THE LATERAL IS IN GOOD CONDITION AND IS FREE OF DEBRIS (DIRT, MUD, STONE, ROOTS, ETC.) VIA A VIDEO TAPED INSPECTION PERFORMED BY THE PLUMBER/CONTRACTOR OR HIS/HER/THEIR AGENT. PRIOR TO CONNECTION, THE VIDEO TAPED INSPECTION OF THE EXISTING LATERAL MUST BE PRESENTED TO THE DISTRICT FOR REVIEW AND APPROVAL TO UTILIZE AN EXISTING LATERAL. IT IS THE RESPONSIBILITY OF THE BUILDER OR THEIR AGENT
- TO CLEAN AND/OR REPLACE THE PIPE/LATERAL AS NEEDED. 8. ANY NEW PORTION OF A SEWER LATERAL INSTALLED WITHIN THE PUBLIC RIGHT-OF-WAY AND SEWER EASEMENT MUST BE SDR-21 PVC.

INV.-510.49 E.

- 9. ANY EXISTING LATERALS NOT UTILIZED MUST BE ABANDONED TO MONROE COUNTY PURE WATERS (MCPW) STANDARDS AT THE PROPERTY LINE OR, WHERE APPLICABLE, THE SEWER
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- 11. ANY PORTION OF A SEWER/LATERAL WITH LESS THAN FOUR-FEET (4') OF COVER WILL REQUIRE CONCRETE ENCASEMENT. SEWERS/LATERALS WITH LESS THAN THREE-FEET (3') OF COVER ARE NOT ALLOWED.
- 12. THE REQUIREMENTS OF THE HIGHWAY/PROPERTY OWNER SHALL BE ADHERED TO FOR ITEMS ABOVE THE PIPE BEDDING, INCLUDING, BUT NOT LIMITED TO, MAINTENANCE AND PROTECTION OF TRAFFIC, BACKFILL MATERIAL AND SURFACE RESTORATION.
- 13. CONTRACTOR TO CONFIRM EXISTING INVERT BEFORE CONSTRUCTION OF PROPOSED STORM

ONROE COUNTY HEALTH DEPARTMENT	ROCHESTER PURE WATERS DISTRICT	
TY OF ROCHESTER WATER BUREAU		
PPROVED BY:		
DATE:		


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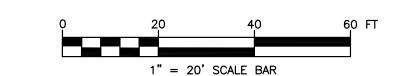
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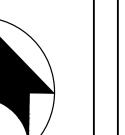
PROPOSED UNDERGROUND ELECTRIC	UGE
PROPOSED WATER	v
PROPOSED SANITARY SEWER	SAN
PROPOSED STORM SEWER	тг
PROPOSED GAS	G
LIGHTPOLE	ᄱ
WATER VALVE	+
FIRE HYDRANT	প
SANITARY MANHOLE	©
CLEAN-OUT	C.O.•
STORM CATCH BASIN	•
STORM MANHOLE	o o
	PROPOSED WATER PROPOSED SANITARY SEWER PROPOSED STORM SEWER PROPOSED GAS LIGHTPOLE WATER VALVE FIRE HYDRANT SANITARY MANHOLE CLEAN—OUT STORM CATCH BASIN



UTILITY PLAN NOTES:

- 1. CONTRACTOR IS RESPONSIBLE FOR REPAIRS OF DAMAGE TO ANY EXISTING UTILITY DURING CONSTRUCTION AT NO COST TO THE OWNER.
- ALL FILL MATERIAL IS TO BE IN PLACE, AND COMPACTED BEFORE INSTALLATION OF PROPOSED UTILITIES.
- 3. WHERE WATER CROSSES BELOW STORM OR SANITARY, EITHER;
- A. MAINTAIN MINIMUM 18" VERTICAL SEPARATION; B. CONSTRUCT SEWER USING WATER MAIN STANDARD PIPE AND TESTING SAID PIPE C. ENCASE WATER OR SEWER FOR TWO FULL LENGTHS OF WATER PIPE.
- 4. ALL UTILITIES SHOULD BE KEPT TEN (10') APART (PARALLEL) OR WHEN CROSSING 18" VERTICAL CLEARANCE (OUTSIDE EDGE OF PIPE TO OUTSIDE EDGE OF PIPE.)
- 5. LINES UNDERGROUND SHALL BE INSTALLED, INSPECTED AND APPROVED BEFORE
- 6. TOPS OF EXISTING MANHOLES AND WATER VALVE BOXES SHALL BE ADJUSTED AS NECESSARY TO BE FLUSH WITH FINAL PAVEMENT ELEVATIONS.
- 7. ALL CONCRETE FOR ENCASEMENTS AND THRUST BLOCKS SHALL HAVE A MINIMUM 28 DAY COMPRESSION STRENGTH AT 3,000 P.S.I. UNLESS NOTED OTHERWISE.
- 8. CONTRACTOR IS RESPONSIBLE FOR COMPLYING TO THE CONSTRUCTION REQUIREMENTS OF THE CITY OF ROCHESTER AND MONROE COUNTY PURE WATERS WITH REGARDS TO LATERALS AND INSTALLATION OF THE SEWER LINES.
- 9. ALL NECESSARY INSPECTIONS AND/OR CERTIFICATIONS REQUIRED BY CODES AND/OR UTILITY SERVICE COMPANIES SHALL BE PERFORMED PRIOR TO ANNOUNCED BUILDING POSSESSION AND THE FINAL CONNECTION OF SERVICE.
- 10. CONTRACTOR SHALL COORDINATE WITH ALL UTILITY COMPANIES FOR INSTALLATION REQUIREMENTS AND SPECIFICATIONS AND NOTIFY INSPECTORS 72 HOURS BEFORE CONNECTING TO ANY EXISTING LINE.
- 11. CONTRACTOR SHALL REFER TO ARCHITECTURAL PLANS AND SPECIFICATIONS FOR ACTUAL LOCATION OF ALL UTILITY ENTRANCES TO INCLUDE SANITARY SEWER LATERALS, DOMESTIC, AND FIRE PROTECTION WATER SERVICE. ELECTRICAL TELEPHONE. AND GAS SERVICES. CONTRACTOR SHALL COORDINATE INSTALLATION OF UTILITIES, IN SUCH A MANNER AS TO AVOID CONFLICTS AND ASSURE PROPER DEPTHS ARE ACHIEVED AS WELL AS COORDINATING WITH TOWN UTILITY REQUIREMENTS AS TO LOCATION AND SCHEDULING FOR TIE-INS/CONNECTIONS PRIOR TO CONNECTING TO EXISTING
- 12. CONTRACTOR SHALL COMPLY TO THE FULLEST EXTENT WITH THE LATEST STANDARDS OF OSHA DIRECTIVES OR ANY OTHER AGENCY HAVING JURISDICTION FOR **EXCAVATION AND TRENCHING PROCEDURES. TI** CONTRACTOR SHALL USE SUPPORT SYSTEMS, SLOPING, BENCHING, AND OTHER MEANS OF PROTECTION, THIS TO INCLUDE BUT NOT LIMITED FOR ACCESS AND EGRESS FROM ALL EXCAVATION AND TRENCHING. CONTRACTOR IS RESPONSIBLE TO COMPLY WITH PERFORMANCE CRITERIA FOR OSHA.
- 13. REFER TO BUILDING ELECTRICAL PLANS FOR SITE LIGHTING ELECTRICAL CIRCUITRY DESIGN AND LAYOUT.
- 14. CONTRACTOR SHALL MAINTAIN A MINIMUM OF 5'-0" COVER ON ALL WATER LINES INGRASS AREAS, AND MIN. 6'-0" COVER PAVEMENT AREAS.
- 15. ALL ABANDONED WATER AND SEWER LINES TO BE ABANDONED PER THE CITY OF ROCHESTER AND MONROE COUNTY PURE WATERS SPECIFICATIONS.
- 16. BUILDING CONTRACTOR IS RESPONSIBLE FOR ALL UTILITY WORK WITHIN FIVE FEET
- 17. CONTRACTOR SHALL FIELD VERIFY ALL PROPOSED & EXISTING PIPE INVERT ELEVATIONS BEFORE ORDERING MANHOLE AND CATCH BASIN STRUCTURES.
- 18. ALL STORM PIPE ENTERING STRUCTURES SHALL BE GROUTED TO ASSURE CONNECTION AT STRUCTURE IS WATERTIGHT.
- 19. ALL STORM STRUCTURES SHALL HAVE A SMOOTH UNIFORM POURED MORTAR INVERT FROM INVERT IN TO INVERT OUT.
- 20. THE UNDERGROUND STRUCTURES AND UTILITIES SHOWN ON THIS MAP HAVE BEEN PLOTTED FROM AVAILABLE SURVEYS AND RECORD MAPS, THEY ARE NOT CERTIFIED TO THE ACCURACY OF THEIR LOCATION AND/OR COMPLETENESS. IT IS THE CONTRACTOR'S RESPONSIBILITY TO VERIFY THE LOCATION AND EXTENT OF ALL UNDERGROUNDSTRUCTURES AND UTILITIES PRIOR TO ANY DIGGING OR CONSTRUCTION ACTIVITIES IN THEIR VICINITY. THE CONTRACTOR SHALL HAVE ALL EXISTING UTILITIES FIELD STAKED BEFORE STARTING WORK BY CALLING 1-800-962-7962 A MINIMUM OF 48 HOURS BEFORE COMMENCEMENT OF WORK TO HAVE ALL EXISTING UTILITIES FIELD STAKED OR MARKED WITHIN THE PROJECT
- 21. A LICENSED PLUMBER WILL BE RESPONSIBLE FOR PROVIDING ALL THE PREPARATION TO TAP THE 8" RWW MAIN. THE RWW WILL PERFORM THE WET TAP. THE TAPPING FEE WILL BE \$500. A DEPOSIT OF \$2,200 TO ABANDON BOTH EXISTING SERVICES WILL BEREQUIRED. IF THE PERMIT OFFICE ALLOWS, THE LICENSED PLUMBER HAS THE OPTION TO ABANDON THE EXISTING SERVICES AND THE RWW WILL REFUND THE DEPOSIT OTHERWISE, THE ROCHESTER WATER BUREAU WILL KEEP THE DEPOSIT AND PERFORM THE ABANDONMENTS. ALL FEES MENTIONED ABOVE WILL BE PAID AT THE PERMIT OFFICE, ALONG WITH THE METER FEES (BASED ON METER SIZES), ROAD CUT FEES AND ROW FEES (BASED ON SQUARE FOOTAGE).
- 22. AS DIRECTED BY MONROE COUNTY PURE WATERS REFER TO MCPW NOTE 7, CONTRACTOR TO DETERMINE IF THE EXISTING LATERAL CAN BE UTILIZIED FOR CONNECTION AND REPAIR IF NECESSARY.



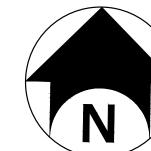

SWBR ARCHITECTS

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fax: 585.232.4652 www.bergmannpc.com

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REVISIONS							
no.	date	by	description				

PROJECT:

COBBS HILL VILLAGE

CLIENT:

ROCHESTER MGMT 249 NORTON VILLAGE LANE ROCHESTER, NY 14609

DRAWING TITLE PHASE I UTILITY PLAN


drawn by P. HILL DRAWING NO. checked proj. mgr. proj. no. 15915.00

SITE PLAN APPLICATION

ISSUE DATE:

04.21.2017

A. HART

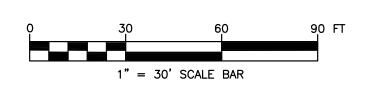

LEGEND

DRAINAGE FLOW ARROW PROPOSED CONTOUR

TC 847.60 TOP OF CURB ELEVATION TOP OF PAVEMENT ELEVATION SPOT ELEVATION

INLET PROTECTION

GRADING NOTES:

- 1. REMOVE AND STOCKPILE TOPSOIL AS DIRECTED BY THE CONSTRUCTION MANANGER.
 REPLACE TOPSOIL TO A MINIMUM 4" DEPTH. ALL DISTURBED AREAS TO BE
 HYDROSEEDED AS DIRECTED BY THE CONSTRUCTION MANAGER.
- CONTRACTOR SHALL BE RESPONSIBLE FOR THE MAINTENANCE AND REMOVAL OF TEMPORARY SEDIMENTATION CONTROLS, INCLUDING SILT SINK AND SILT FENCE. EROSION CONTROL MEASURES SHALL NOT BE REMOVED BEFORE VEGETATION HAS OCCURRED COMPLETELY.
- 3. ALL EROSION CONTROL MEASURES TO BE REPLACED WHENEVER THEY BECOME CLOGGED OR INOPERABLE AND SHALL BE REPLACED AT A MINIMUM OF EVERY 3 MONTHS.
 4. THE CONTRACTOR SHALL BE RESPONSIBLE FOR RESTORATION OF TOPSOIL TO ALL
- I. THE CONTRACTOR SHALL BE RESPONSIBLE FOR RESTORATION OF TOPSOIL TO ALL DISTURBED AREAS. IT IS THE CONTRACTOR'S RESPONSIBILITY TO MAINTAIN EROSION CONTROL MEASURES AT ALL TIMES.
- 5. EROSION CONTROL MEASURES WILL BE IMPLEMENTED IN ACCORDANCE WITH THE NEW YORK STATE GUIDELINES FOR URBAN EROSION SEDIMENT CONTROL MANUAL, NYSDEC, AND THE CITY OF ROCHESTER REQUIREMENTS.
- 6. ALL INLETS TO THE STORM SEWER SHALL HAVE STONE DROP PROTECTION TO CONTROL SILTATION. THE CONTRACTOR SHALL BE RESPONSIBLE FOR MAINTAINING THE BALES UNTIL GROUND COVER IS ESTABLISHED.
- 7. SILT FENCE AND JUTE MESH WILL BE USED ON STEEP SLOPES AND WHEREVER NECESSARY TO CONTROL EROSION AND SILTATION OF EXISTING DRAINAGE SYSTEMS AS ORDERED BY THE ENGINEER.
- 8. THE CONTRACTOR SHALL DESIGNATE A MEMBER OF HIS/HER FIRM TO BE RESPONSIBLE TO MONITOR EROSION CONTROL, EROSION CONTROL STRUCTURES, TREE PROTECTION AND PRESERVATION THROUGHOUT CONSTRUCTION.
- 9. ALL DISTURBED AREAS SHALL BE PROTECTED FROM EROSION EITHER BY MULCH OR TEMPORARY SEEDING.

WASTE/HAZARDOUS MATERIAL PRACTICES:

- 1. WHENEVER POSSIBLE COVERED TRASH CONTAINERS SHOULD BE USED.
- 2. DAILY SITE CLEANUP IS REQUIRED TO REDUCE DEBRIS AND POLLUTANTS IN THE ENVIRONMENT.
- 3. CONTRACTOR SHALL PROVIDE A SAFE STORAGE SPACE FOR ALL PAINTS, STAINS AND SOLVENTS INSIDE A COVERED STORAGE AREA.
- 4. CONTRACTOR SHALL PROVIDE A SAFE STORAGE AREA FOR PESTICIDES AND FERTILIZERS.
- 5. ALL FUELS, OILS AND GREASE MUST BE KEPT IN CONTAINERS AT ALL TIMES.
- 6. THE CONTRACTOR SHALL REFER TO THE STORM WATER POLLUTION PREVENTION REPORT, SECTION VIII, TECHNICAL FIELD GUIDANCE SPILL REPORTING AND INITIAL NOTIFICATION REQUIREMENTS FOR ANY SPILLS OR LEAKS.

STORM WATER POLLUTION PREVENTION PLAN NOTES:

- 1. INSTALL SILT FENCE, DIVERSION SWALES/BERMS, CHECK DAMS AND ALL OTHER EROSION CONTROL MEASURES AS INDICATED ON THE PLAN PRIOR TO THE START OF ANY EXCAVATION WORK. EROSION CONTROL MEASURES WILL BE IMPLEMENTED IN ACCORDANCE WITH THE NEW YORK STATE GUIDELINES FOR URBAN EROSION SEDIMENT CONTROL
- 2. REMOVE AND STOCKPILE TOPSOIL AS DIRECTED BY THE CONSTRUCTION MANAGER REPLACE TOPSOIL TO A MINIMUM 4" DEPTH. ALL DISTURBED AREAS TO BE HYDROSEEDED AS DIRECTED BY THE CONSTRUCTION MANAGER TO PROMOTE VEGETATION AS SOON AS PRACTICABLE.
- 3. IF THE SEASONS PROHIBITS TEMPORARY SEEDING, THE DISTURBED AREAS WILL BE MULCHED WITH STRAW HAY OR EQUIVALENT AND ANCHORED IN ACCORDANCE WITH THE "STANDARDS", NETTING OR LIQUID MULCH BINDER.
- 4. CONTRACTOR SHALL BE RESPONSIBLE FOR THE MAINTENANCE AND REMOVAL OF TEMPORARY SEDIMENTATION CONTROLS. EROSION CONTROL MEASURES SHALL NOT BE REMOVED BEFORE 80% UNIFORM VEGETATION HAS BEEN
- 5. INSTALL INLET PROTECTION, AND RIP RAP APRONS PROGRESSIVELY AS STORM SEWER, AND DISCHARGE POINTS ARE INSTALLED.
- 6. ALL EROSION CONTROL MEASURES ARE TO BE REPLACED WHENEVER THEY BECOME CLOGGED OR INOPERABLE AND SHALL BE REPLACED AT A MINIMUM OF EVERY 3 MONTHS.
- 7. THE CONTRACTOR SHALL BE RESPONSIBLE FOR RESTORATION OF TOPSOIL TO ALL DISTURBED AREAS. IT IS THE CONTRACTOR'S RESPONSIBILITY TO MAINTAIN EROSION CONTROL MEASURES AT ALL TIMES.
- 8. THE CONTRACTOR SHALL DESIGNATE A MEMBER OF HIS/HER FIRM TO BE RESPONSIBLE TO MONITOR EROSION CONTROL, EROSION CONTROL STRUCTURES, TREE PROTECTION AND PRESERVATION THROUGHOUT CONSTRUCTION.
- 9. ALL DISTURBED AREAS SHALL BE FINISH GRADED TO PROMOTE VEGETATION ON ALL EXPOSED AREAS AS SOON AS PRACTICABLE. STABILIZATION PRACTICES (TEMPORARY/PERMANENT SEEDING, MULCHING, GEOTEXTILES, ETC.)MUST BE IMPLEMENTED WITHIN SEVEN (7) DAYS WHERE CONSTRUCTION ACTIVITIES HAVE TEMPORARILY OR PERMANENTLY CEASED, AND NOT EXPECTED TO RESUME WITHIN FOURTEEN (14) DAYS.
- 10. PAVED ROADWAYS MUST BE KEPT CLEAN AT ALL TIMES. ALL CONSTRUCTION DEBRIS AND SEDIMENT SPOILS, DROPPED, WASHED OR TRACKED ONTO PUBLIC RIGHT-OF-WAYS MUST BE REMOVED IMMEDIATELY.
- 11. DUST SHALL BE CONTROLLED BY WATERING.
- 12. ADJOINING PROPERTY SHALL BE PROTECTED FROM EXCAVATION AND FILLING OPERATIONS ON THE PROPOSED SITE.
- 13. PERIMETER AREAS SHALL BE TEMPORARILY STABILIZED WITH SEED AND MULCH PROGRESSIVELY AT MINIMUM AT THE END OF EACH WEEK WITH 100% PERENNIAL RYEGRASS MIX AT A RATE OF 2-4 LBS PER 1000 SF AND MULCH 90-100 lbs/1000 SF OF WEED FREE STRAW.



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REVISIONS
o. date by description

PROJECT:

COBBS HILL VILLAGE

CLIENT:

ROCHESTER MGMT 249 NORTON VILLAGE LANE ROCHESTER, NY 14609

DRAWING TITLE


OVERALL GRADING AND EROSION CONTROL PLAN

DRAWING NO.

drawn by P. HILL
checked A. HART
proj. mgr.
proj. no. 15915.00

SITE PLAN APPLICATION

ISSUE DATE:

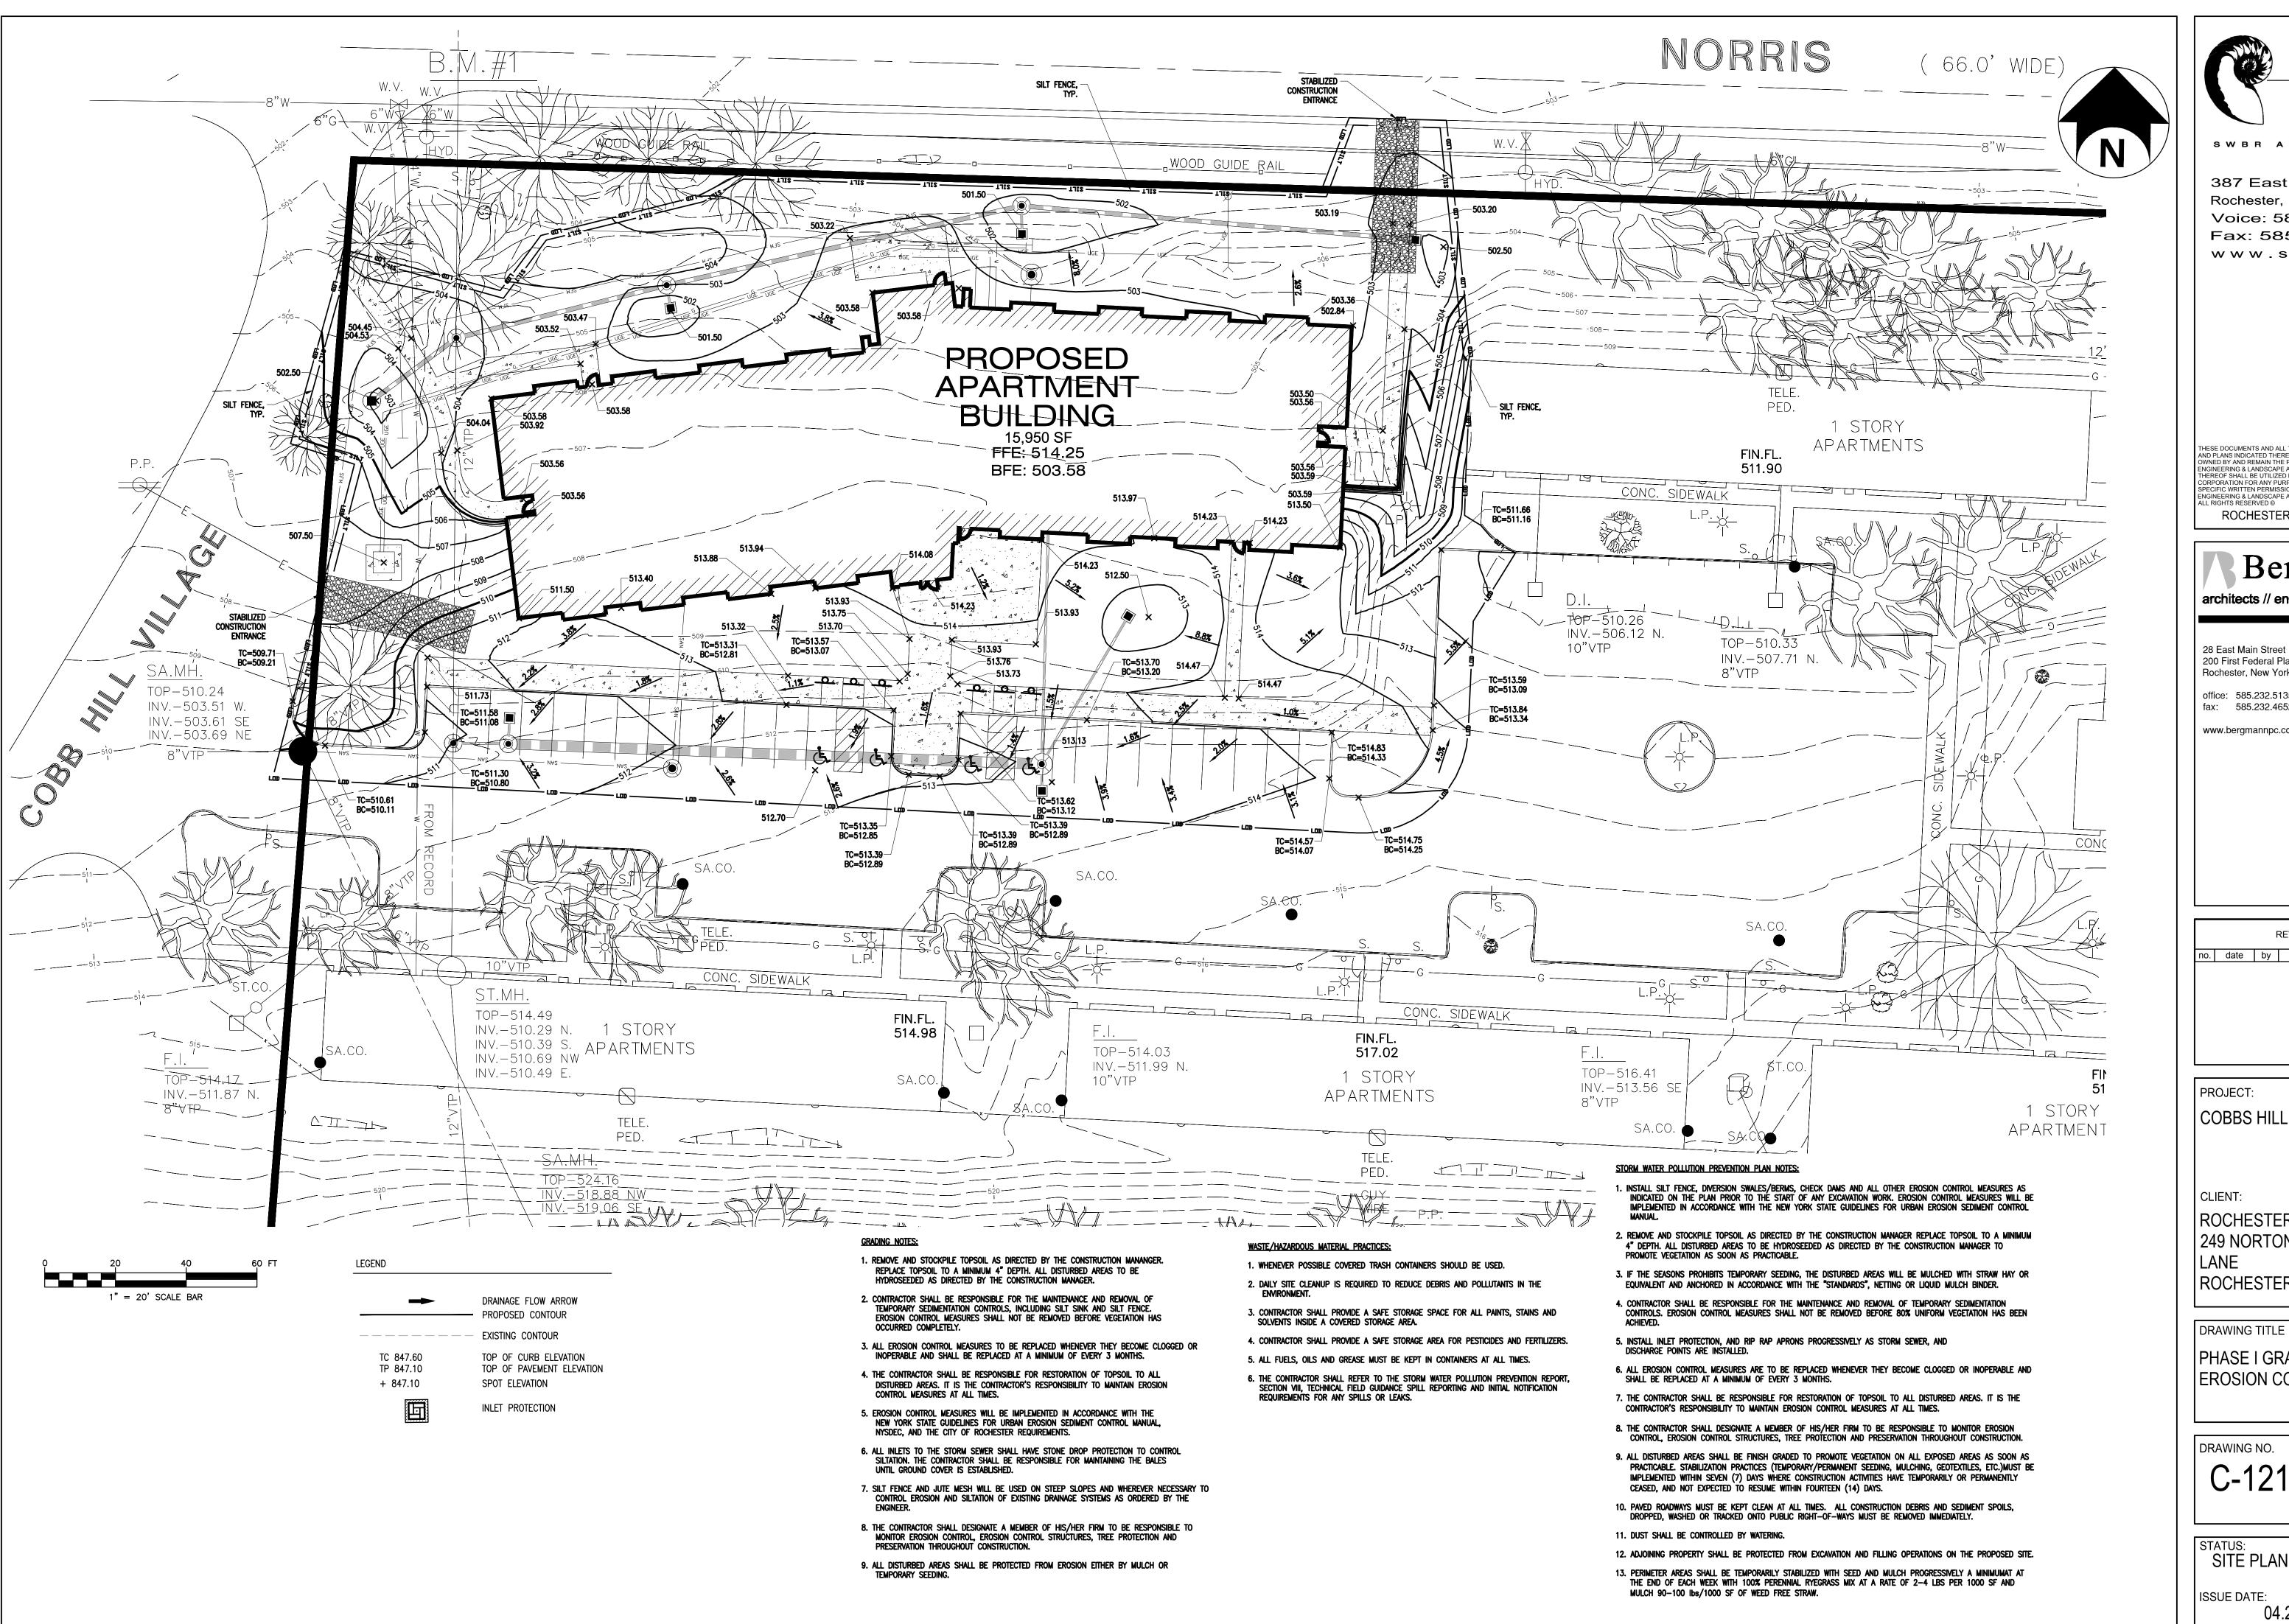



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PROJECT: COBBS HILL VILLAGE

CLIENT: ROCHESTER MGMT 249 NORTON VILLAGE ROCHESTER, NY 14609

DRAWING TITLE


PHASE I GRADING AND EROSION CONTROL PLAN

DRAWING NO.

drawn by P. HILL proj. no. 15915.00

SITE PLAN APPLICATION

ISSUE DATE:

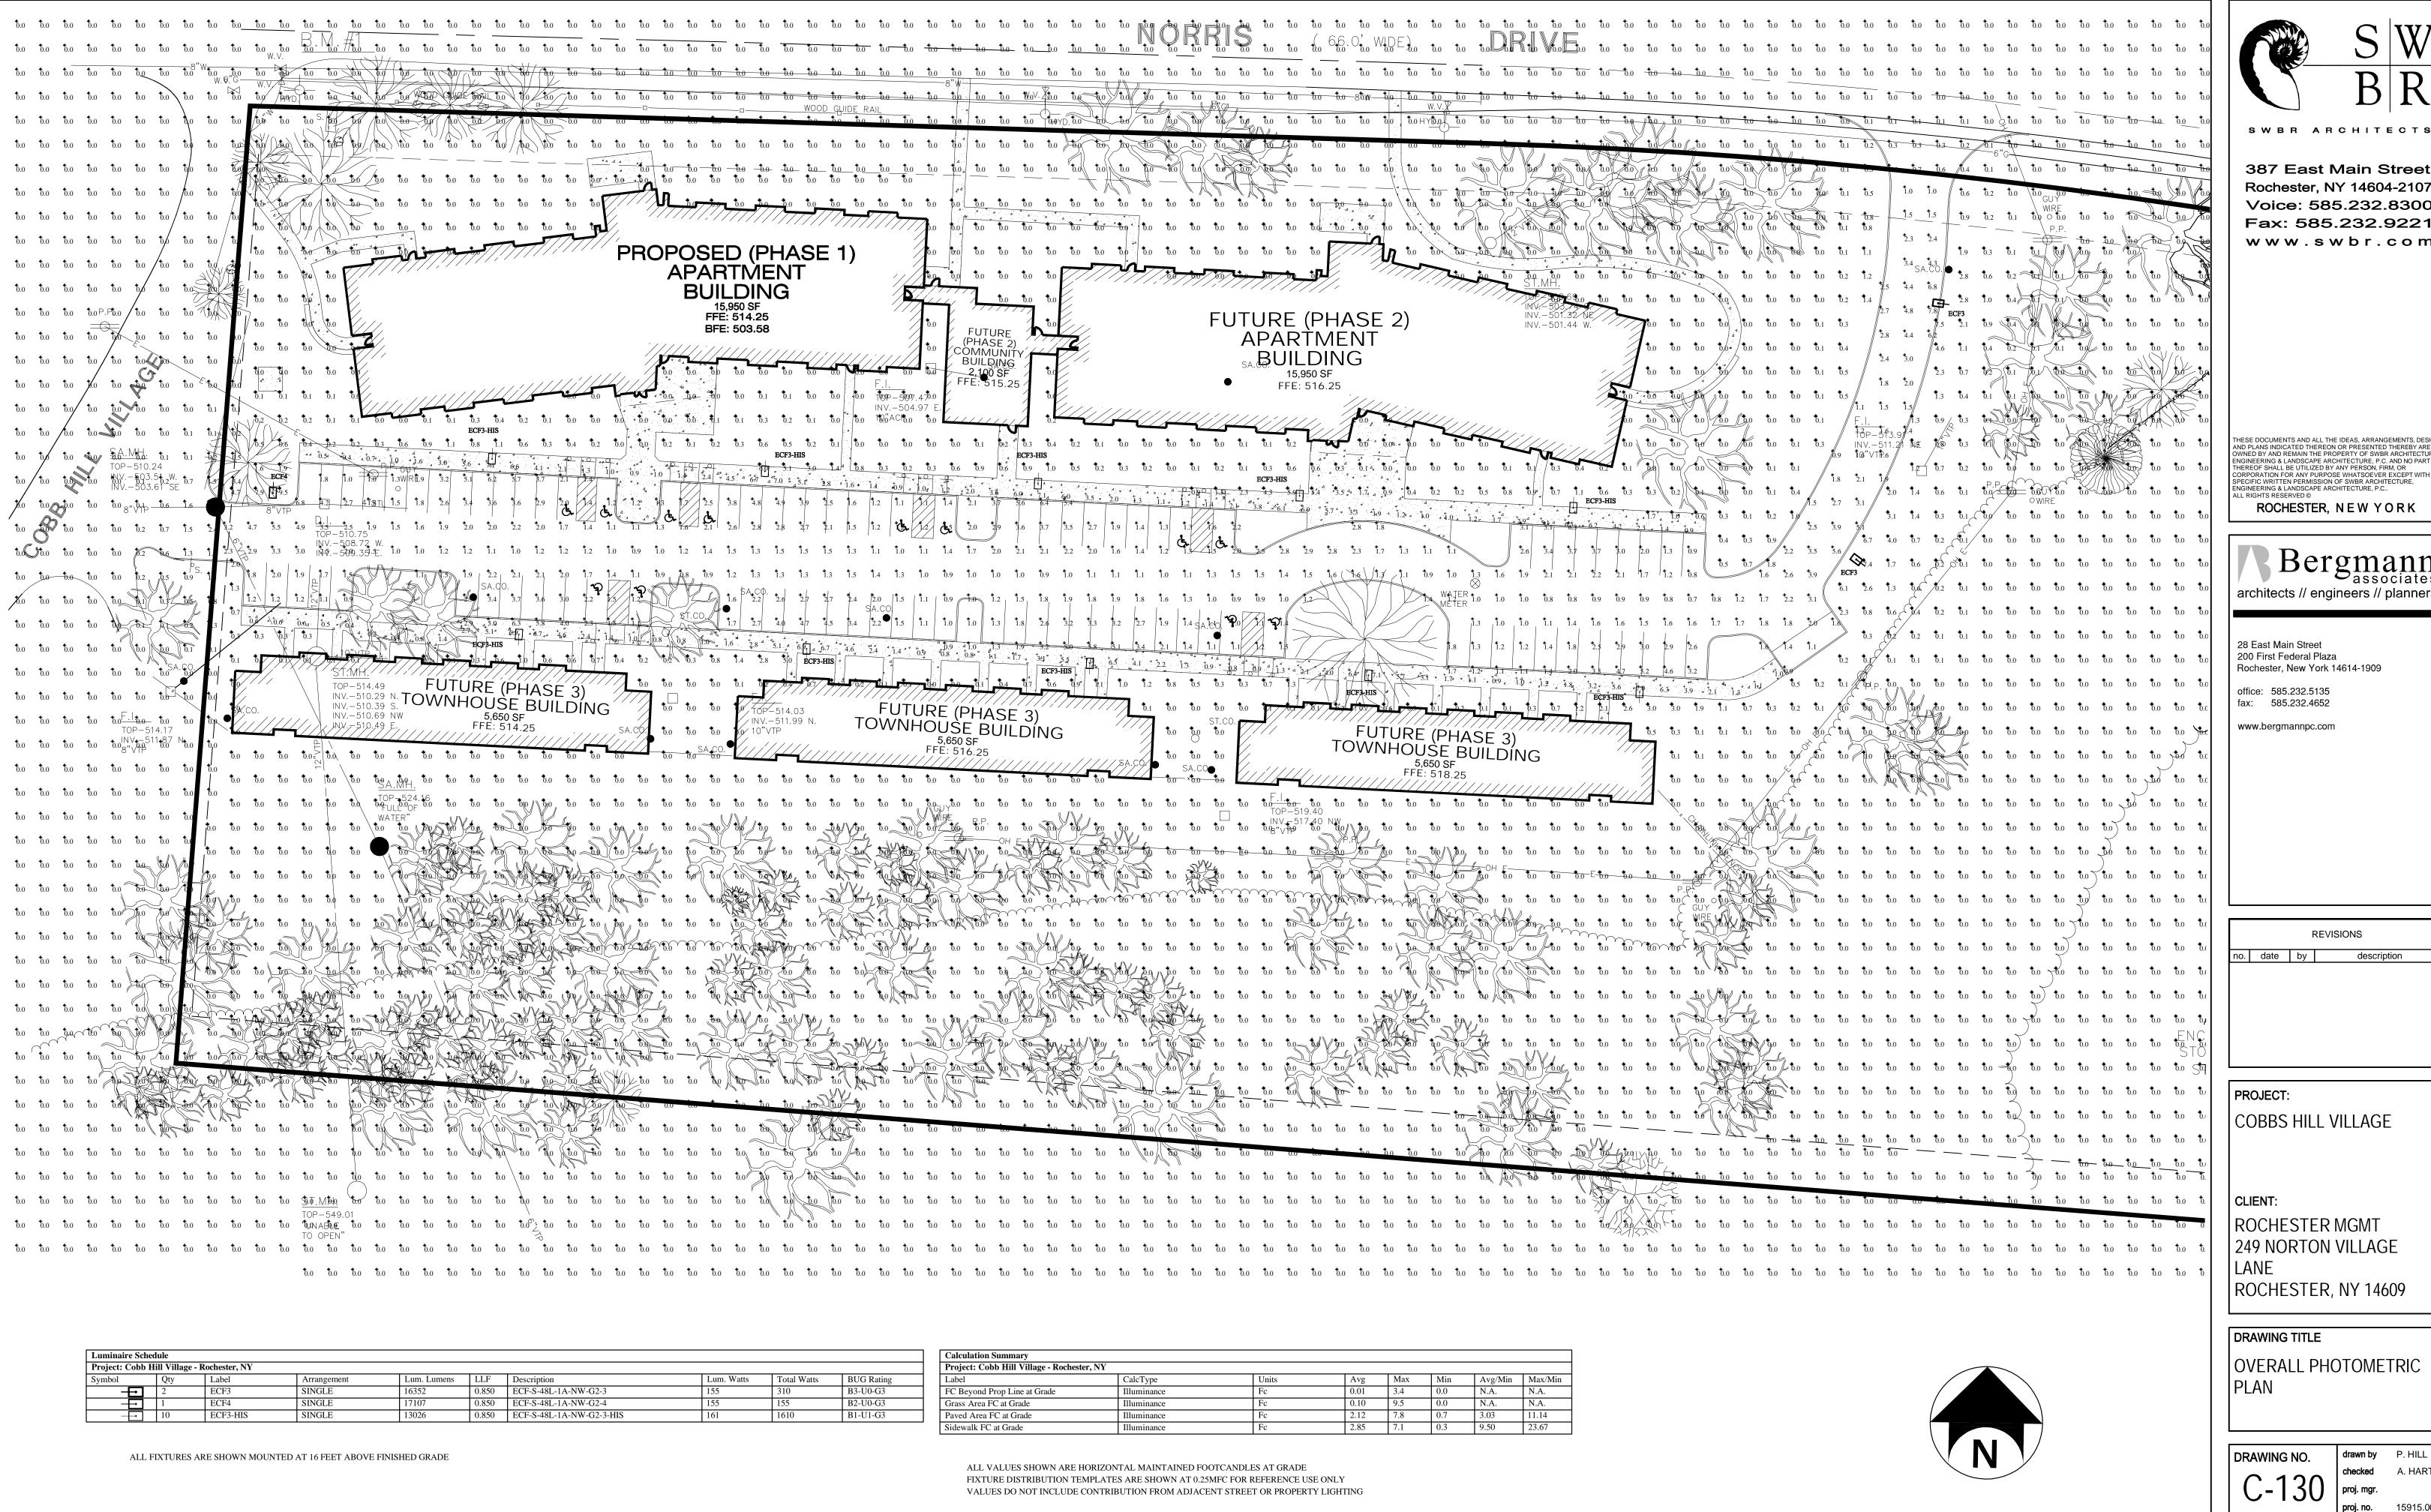



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REVISIONS o. date by description

COBBS HILL VILLAGE

CLIENT: **ROCHESTER MGMT** 249 NORTON VILLAGE

DRAWING TITLE

OVERALL PHOTOMETRIC PLAN

DRAWING NO.

proj. mgr. **proj. no.** 15915.00

SITE PLAN APPLICATION

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1" = 20' SCALE BAR



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REVISIONS no. date by description

PROJECT: COBBS HILL VILLAGE

64 NORRIS DRIVE, ROCHESTER NY

CLIENT:

ROCHESTER MNGT, INC. 249 NORTON VILLAGE LANE ROCHESTER, NY 14609

DRAWING TITLE


OVERALL LAYOUT PLAN

DRAWING NO.

proj. no. 15915

STATUS: SITE PLAN APPLICATION

ISSUE DATE:

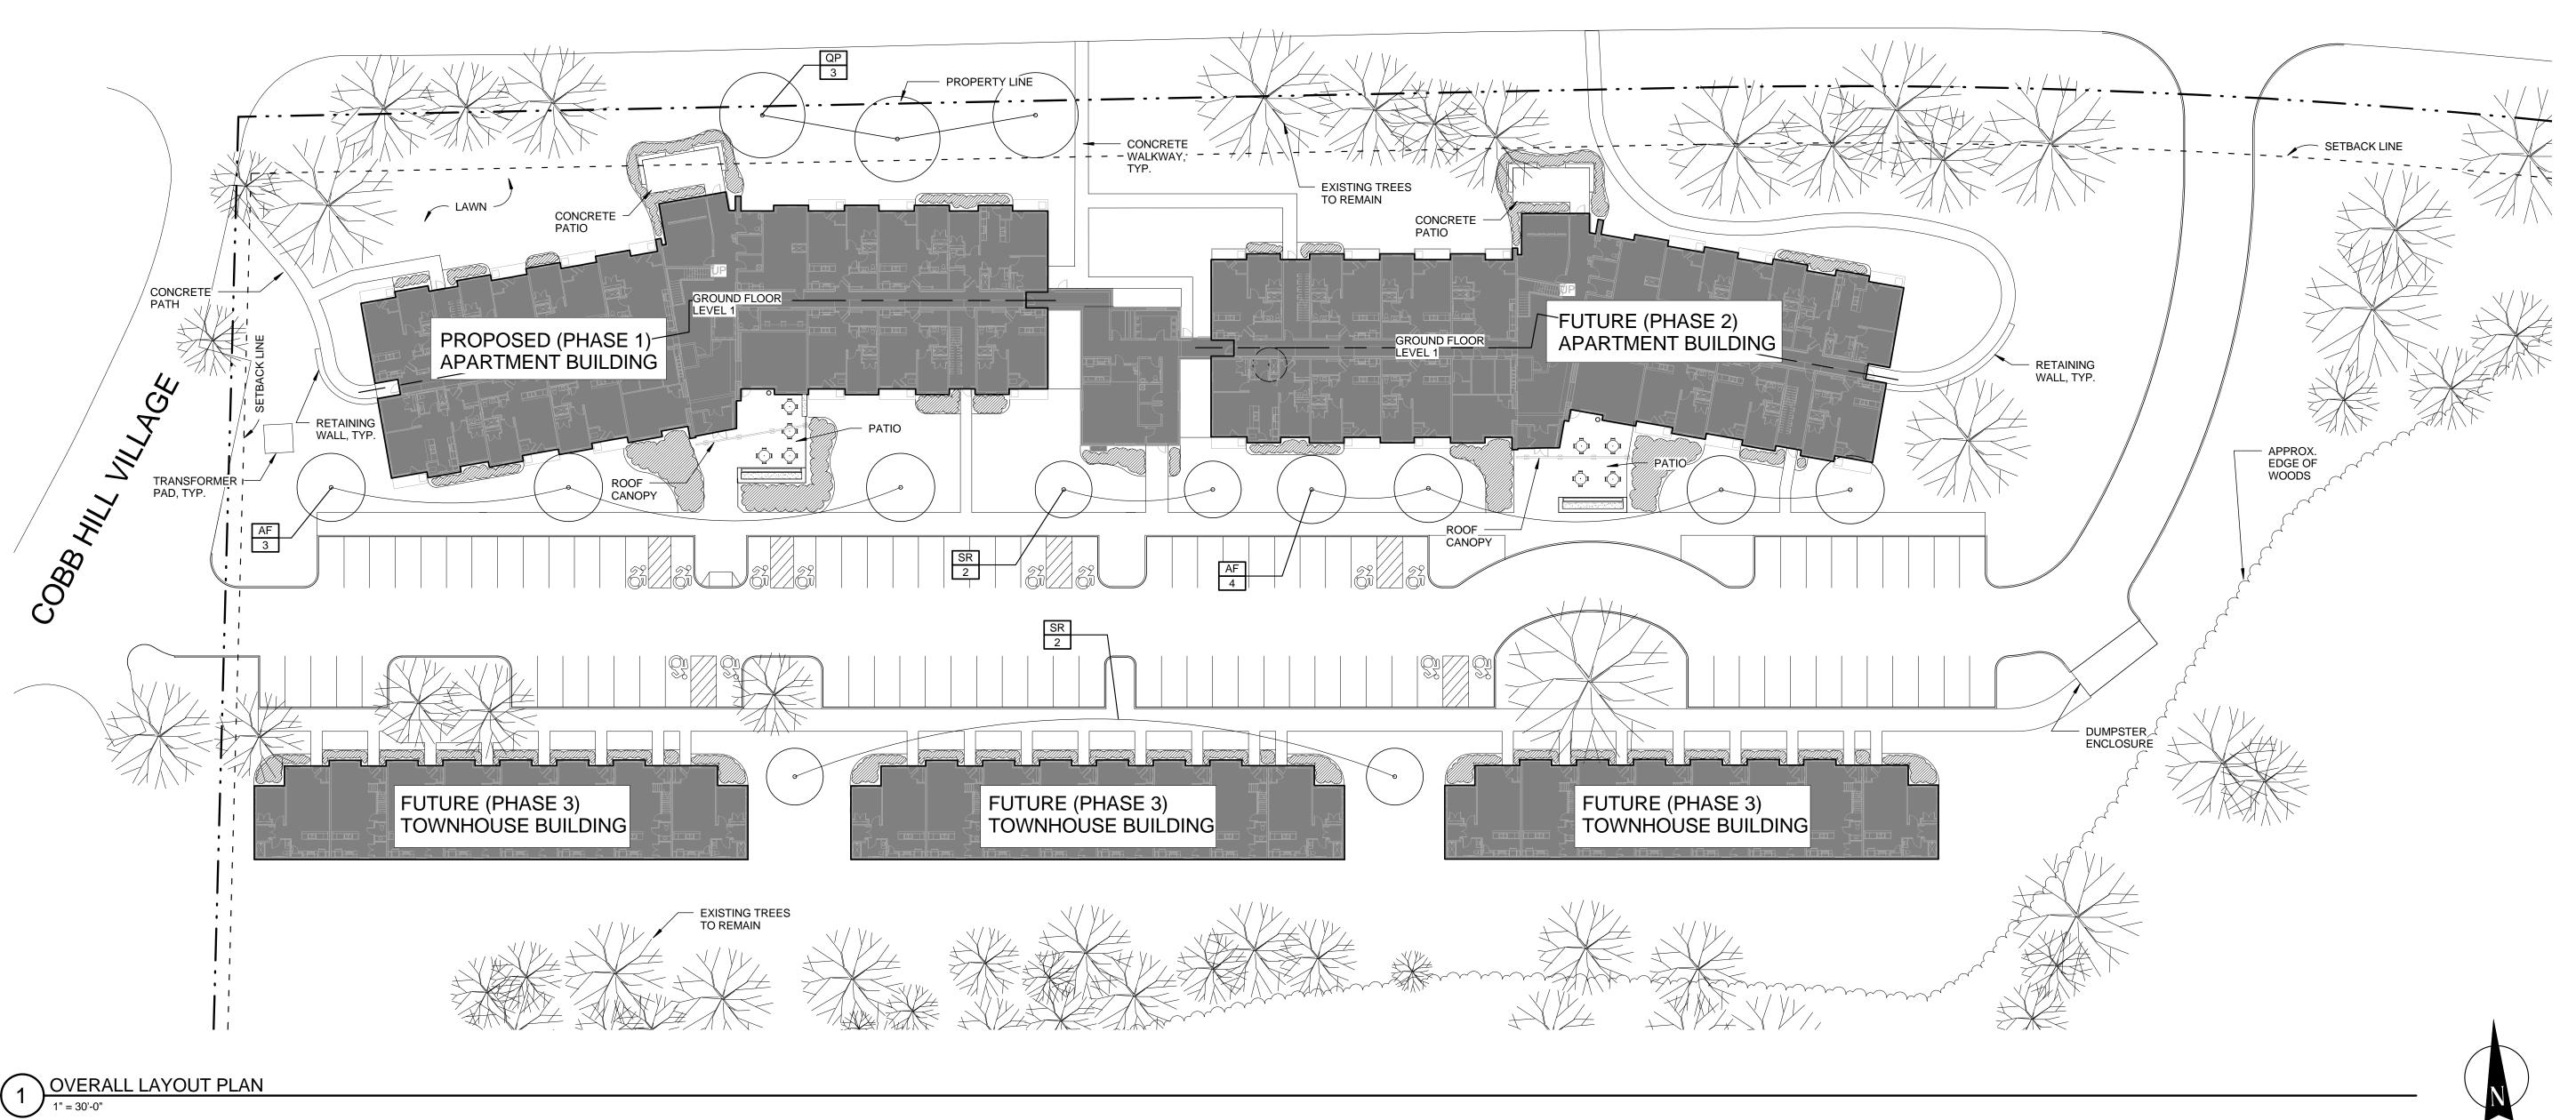

PROPERTY LINE

SITE LEGEND

 $\sim\sim\sim\sim$

SETBACK LINE

EDGE OF WOODS

EXISTING TREE

PROPOSED TREE

PROPOSED PLANTED AREA

ALIGN WITH BUILDING AWB ALIGN WITH CURB

STONE SEAT WALL PLANTER: STONE VENEER SEAT WALL TO MATCH BUILDING WITH RAISED PLANTER

DINETTE AND CHAIRS: **NIC** DINETTE:

ANCHORED, COLOR BLACK

LANDSCAPE FORMS, CHIPMAN, 29" HEIGHT, NON-ANCHORED, COLOR BLACK LANDSCAPE FORMS, CHIPMAN, WITH ARMS, NON-

TRASH RECEPTACLE: **NIC**VICTOR STANLEY S-42, COLOR BLACK, WITH HALF MOON LINERS AND DIVIDER LID CUSTOM WELDED DOME, SURFACE MOUNT

NORRIS DRIVE

PLANTING SCHEDULE **Key Abbreviation** No. Scientic Name Common Name Root Size Notes BB AA Amelanchier arborea 'Autumn Brilliance' Autumn Brilliance Downy Serviceberry 2.5" CG 111 Astilbe chinensis 'Visions in Red' No. 1 Acer x freemanii 'Autumn Blaze' BB Autumn Blaze Red Maple 2.5 - 3" CG BB No. 5 Daphne x burkwoodii 'Carole Mackie' Carol Mackie Daphne Summersweet Clethra CA 27 Clethra alnifolia 'Compacta' CG No. 3 HB CG Hosta 'Blue Mammoth' Blue Mammoth Hosta No. 1 HH Hemerocallis 'Happy Returns' Happy Returns Daylily CG No. 1 HO Hosta 'Patriot' CG 70 Plantain Lily No. 1 HP CG 53 Hydrangea paniculata 'Little Quick Fire' Little Quick Fire Hydrangea No. 5 CG IG Ilex glabra 'Shamrock' No. 5 CG JS Juniperus scopulorum 'Moonglow' 5 - 6' Moonglow Juniper CG LI Lavandula x intermedia 'Phenomenal' Phenomenal Lavender No. 5 PΑ Pennisetum alopecuroides 'Hameln' CG No. 1 Dwarf Fountain Grass QP BB Quercus palustris Pin Oak 2.5 - 3" Spiraea japonica 'Little Princess' CG No. 3 Japanese Spirea SR BB Syringa reticulata 'Ivory Silk' Ivory Silk Japanese Tree Lilac 2.5 - 3" WF Weigela florida 'BOKrasopin' CG Sonic Bloom Weigela No. 5

1. ALL NEW LAWN AREAS SHALL RECEIVE 3" OF APPROVED TOPSOIL AND SHALL BE SEEDED WITH TRIO SUPREME BY PREFERRED SEED AT THE MANUFACTURER'S RECOMMENDED RATE

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PROJECT:

COBBS HILL VILLAGE 64 NORRIS DRIVE, ROCHESTER NY

CLIENT:

ROCHESTER MNGT, INC 249 NORTON VILLAGE LANE ROCHESTER, NY 14609

DRAWING TITLE


OVERALL PLANTING PLAN

DRAWING NO.

proj. no. 15915

STATUS: SITE PLAN APPLICATION

APPROX. EDGE OF WOODS HH 4 - DUMPSTER ENCLOSURE

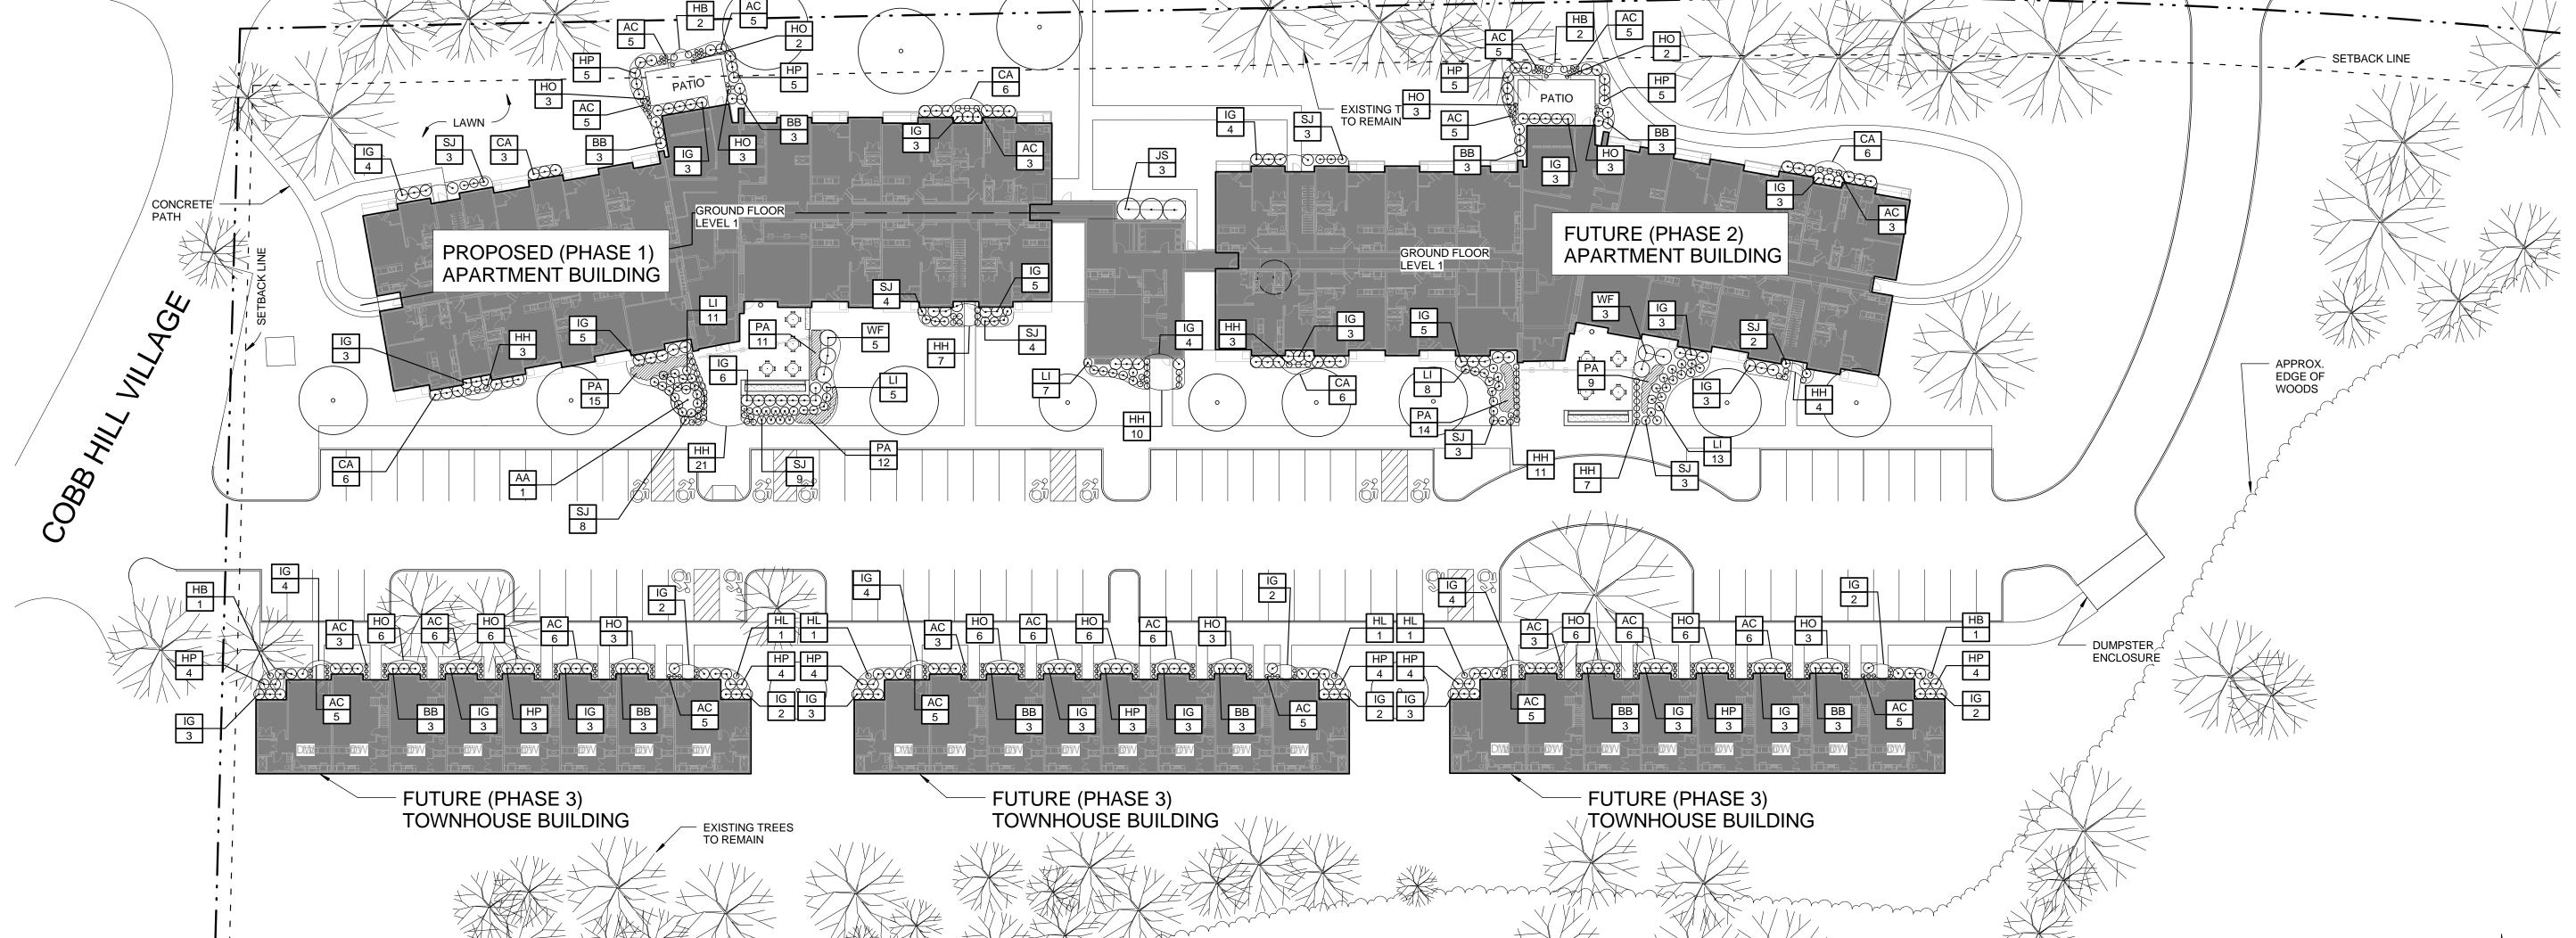


OVERALL LANDSCAPE PLAN

1" = 30'-0"

ISSUE DATE:

NOTES: WHENEVER POSSIBLE. SOCIETY OF ARBORICULTURE. SOCIETY OF ARBORICULTURE \ PLANTING BED SECTION 1 X BALL DIAMETER NOTES: 1. DO NOT HEAVILY PRUNE TREES AND SHRUBS AT PLANTING. PRUNE ONLY CROSSOVER LIMBS, CO-DOMINANT LEADERS, AND BROKEN OR DEAD BRANCHES. SOME INTERIOR TWIGS AND LATERAL BRANCHES MAY BE PRUNED, WHERE THE TRUNK FLARE IS NOT VISIBLE SHALL BE REJECTED. POSSIBLE. OF ARBORICULTURE. SOCIETY OF ARBORICULTURE TREE PIT SECTION

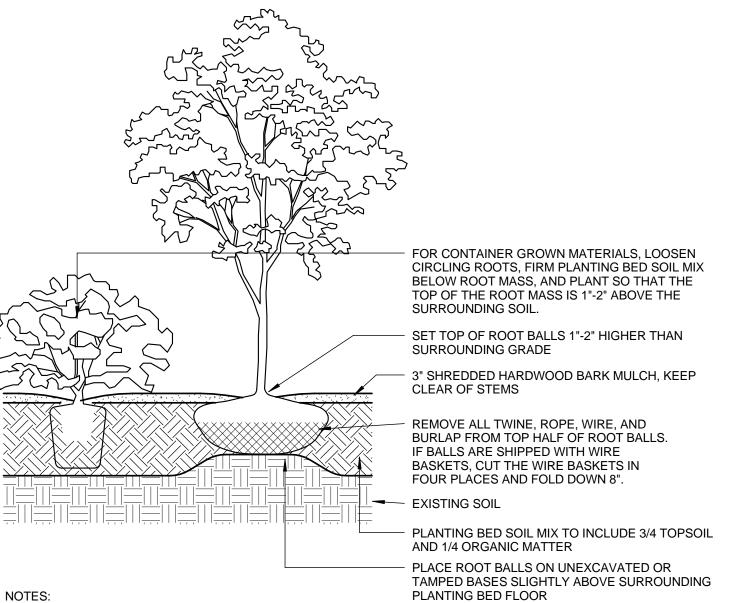

1. DO NOT HEAVILY PRUNE TREES AND SHRUBS AT PLANTING. PRUNE ONLY CROSSOVER LIMBS, CO-DOMINANT LEADERS, AND BROKEN OR DEAD BRANCHES. SOME INTERIOR TWIGS AND LATERAL BRANCHES MAY BE PRUNED, HOWEVER, DO NOT REMOVE THE TERMINAL BUDS OF BRANCHES THAT EXTEND TO THE EDGE OF THE CROWN.

2. BALLED AND BURLAPPED MATERIAL MUST BE PLANTED SUCH THAT THE STEM FLARE IS VISIBLE AT THE TOP OF THE ROOT BALL. WHERE STEM FLARES ARE NOT VISIBLE, THE PLANT MATERIAL SHALL BE REJECTED.


3. STAKE TREES ONLY UPON THE APPROVAL OF THE LANDSCAPE ARCHITECT.

4. WRAP TREE TRUNKS ONLY UPON THE APPROVAL OF THE LANDSCAPE ARCHITECT.

5. MARK THE NORTH SIDE OF TREES AT THE NURSERY, AND ROTATE TREES TO FACE NORTH AT THE SITE

6. TAMP SOIL AROUND ROOT BALLS FIRMLY WITH FOOT PRESSURE SO THAT ROOT BALLS DO NOT SHIFT. THIS DETAIL IS BASED ON A STANDARD DETAIL AND RECOMMENDATIONS PREPARED BY THE INTERNATIONAL

7. THIS DETAIL IS BASED ON A STANDARD DETAIL, AND RECOMMENDATIONS PREPARED BY THE INTERNATIONAL

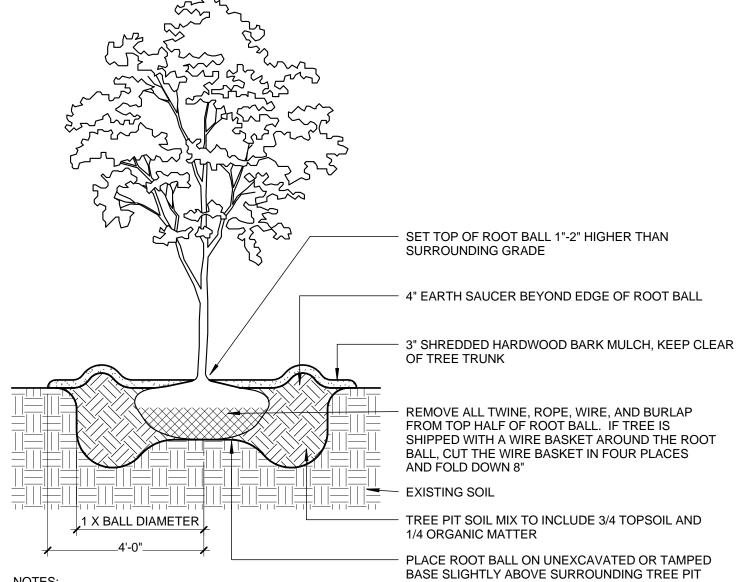

HOWEVER, DO NOT REMOVE THE TERMINAL BUDS OF BRANCHES THAT EXTEND TO THE EDGE OF THE CROWN. 2. TREES MUST BE PLANTED SUCH THAT THE TRUNK FLARE IS VISIBLE AT THE TOP OF THE ROOT BALL. TREES

3. STAKE TREES ONLY UPON THE APPROVAL OF THE LANDSCAPE ARCHITECT.

4. WRAP TREE TRUNKS ONLY UPON THE APPROVAL OF THE LANDSCAPE ARCHITECT.

5. MARK THE NORTH SIDE OF TREES AT THE NURSERY, AND ROTATE TREES TO FACE NORTH AT THE SITE WHENEVER

6. TAMP SOIL AROUND ROOT BALLS FIRMLY WITH FOOT PRESSURE SO THAT ROOT BALLS DO NOT SHIFT. THIS DETAIL IS BASED ON A STANDARD DETAIL AND RECOMMENDATIONS PREPARED BY THE INTERNATIONAL SOCIETY

7. THIS DETAIL IS BASED ON A STANDARD DETAIL, AND RECOMMENDATIONS PREPARED BY THE INTERNATIONAL

SWBR ARCHITECTS

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PROJECT:

COBBS HILL VILLAGE 64 NORRIS DRIVE, ROCHESTER NY

ROCHESTER MNGT, INC. 249 NORTON VILLAGE LANE ROCHESTER, NY 14609

DRAWING TITLE

DRAWING NO.

proj. no. 15915

SITE PLAN APPLICATION

ISSUE DATE:

COBBS HILL VILLAGE

645 NORRIS DRIVE ROCHESTER, NY

CLIENT: ROCHESTER MANAGEMENT, INC.

SWBR PROJECT #: 15915.00 SITE PLAN APPLICATION



ARCHITECT, LANDSCAPE ARCHITECT & STRUCTURAL

OWNER:

ROCHESTER MANAGMENT, INC SWBR ARCHITECTURE, 249 NORTON VILLAGE LANE ROCHESTER, NY 14609 PHONE:(585) 467-2442 FAX: (585) 544-0243

ENGINEERING & LANDSCAPE ARCHITECTURE, P.C. 387 EAST MAIN STREET ROCHESTER, NEW YORK 14604 PHONE: (585) 232-8300 FAX: (585) 232-9221

ENERGY CONSULTANT:

SUSTAINABLE COMFORT 28 ADAMS ST UNIT 304 WORCESTER, MA 01604 PHONE: (413) 262-7390

CIVIL ENGINEER: BERGMANN ASSOCIATES

ENGINEER:

28 EAST MAIN STREET 200 FIRST FEDERAL PLAZA ROCHESTER, NY 14614 PHONE: (585) 232-5135 FAX: (585) 325-8307

CONSTRUCTION MGR:

LECESSE CONSTRUCTION SERVICES, LLC 75 THRUWAY PARK DRIVE ROCHESTER, NY 14586 PHONE: (585) 334-4490 FAX: (585) 334-4925

MEP ENGINEER:

LIST OF ARCHITECTURAL/STRUCTURAL ABBREVIATIONS

M/E ENGINEERING, P.C. 150 NORTH CHESTNUT STREET ROCHESTER, NY 14604 PHONE: (585) 288-5590 FAX 288-0233

• • • • • • • • • • • • • • • • • • • •	
CIVIL EX-1 C-080 C-081 C-100 C-101 C-110 C-111 C-120 C-121 C-130	EXISTING CONDITIONS OVERALL DEMOLITION PLAN PHASE 1 DEMOLITION PLAN OVERALL SITE PLAN PHASE 1 SITE PLAN OVERALL UTILITY PLAN PHASE 1 UTILITY PLAN OVERALL GRADING AND EROSION CONTROL PLAN PHASE 1 GRADING AND EROSION CONTROL PLAN OVERALL PHOTOMETRIC PLAN
LANDSCAPE L-101 L-102 L-103	OVERALL LAYOUT PLAN OVERALL PLANTING PLAN DETAILS
ARCHITECTU AA-100 AA-101 AA-102 AA-103 AA-201	BUILDING A- GROUND FLOOR PLAN BUILDING A- FIRST FLOOR PLAN BUILDING A- SECOND FLOOR PLAN
AB-100 AB-101 AB-102 AB-103 AB-201	BUILDING B- GROUND FLOOR PLAN BUILDING B- FIRST FLOOR PLAN BUILDING B- SECOND FLOOR PLAN BUILDING B- ROOF PLAN BUILDING B- EXTERIOR ELEVATIONS
AC-101 AC-102 AC-103 AC-201	BUILDING C- FIRST FLOOR PLAN BUILDING C- SECOND FLOOR PLAN BUILDING C- ROOF PLAN BUILDING C- EXTERIOR ELEVATIONS


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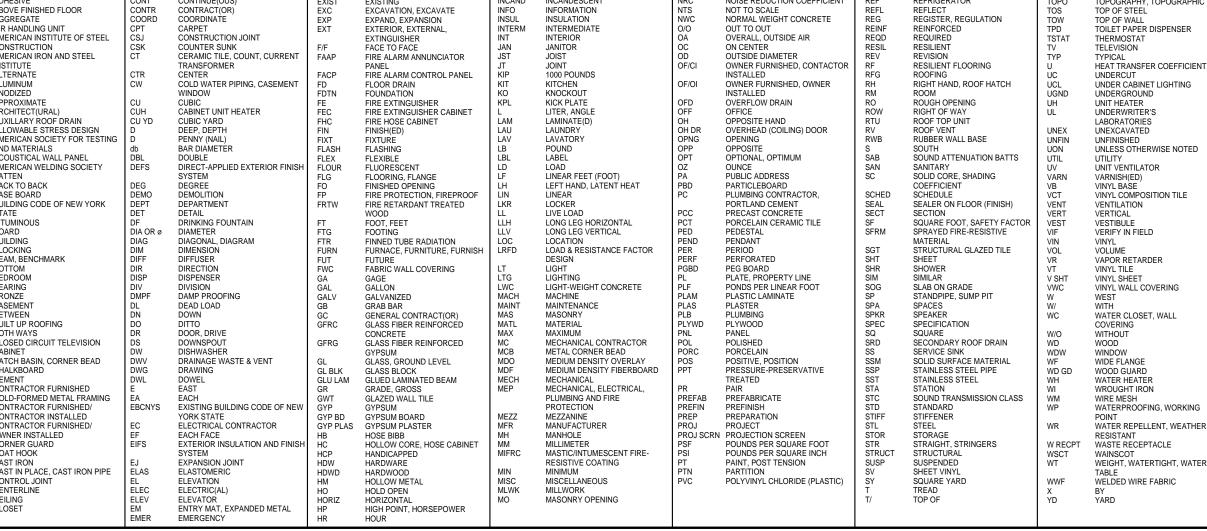
ELEVATION NO. DRAWING NO. **DETAIL SECTION CUT** DEMOLITION KEY NOTE CEILING TYPE AND HEIGHT VISUAL/HEARING ACCOMMODATING


MATERIAL SYMBOLS

DRAWING SYMBOLS

	UNDISTURBED EARTH		STEEL-LARGE-SCALE (Other metals as noted)	BATT INSULATION
	GRAVEL OR CRUSHED STONE		STEEL-SMALL-SCALE (Other metals as noted)	RIGID INSULATION
	STONE	M	WOOD FRAMING (CONTINUOUS)	WOOD BLOCKING(INTERMITTEN
, 4	CONCRETE		FINISH WOOD	
	CONCRETE MASONRY UNIT		PLYWOOD	
	BRICK		GYPSUM, SAND, MORTAR	



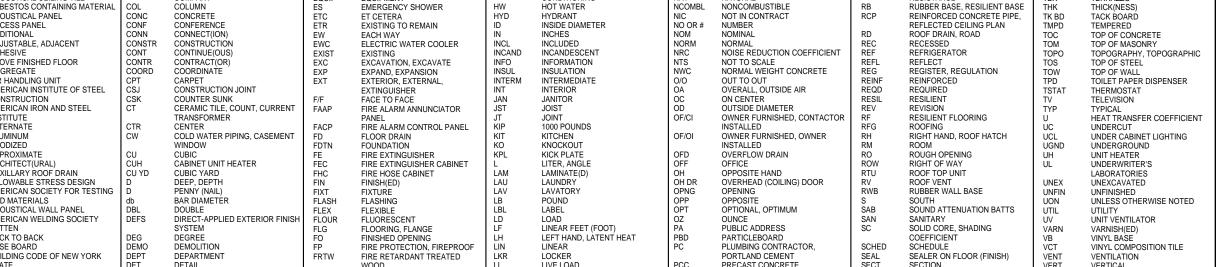

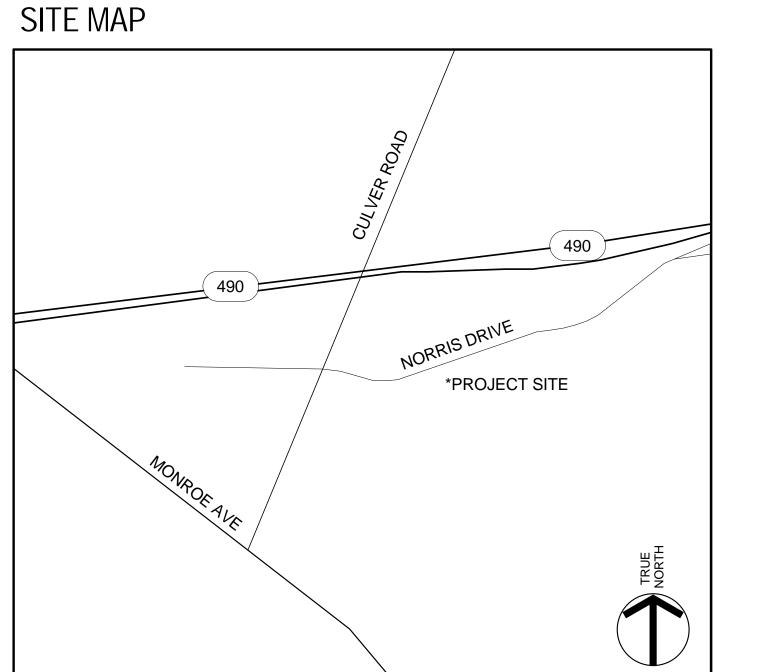


REVISIONS

COBBS HILL VILLAGE 645 NORRIS DRIVE ROCHESTER, NY 14610

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TITLE SHEET/ PROJECT

STATUS: SITE PLAN APPLICATION 04.21.2017

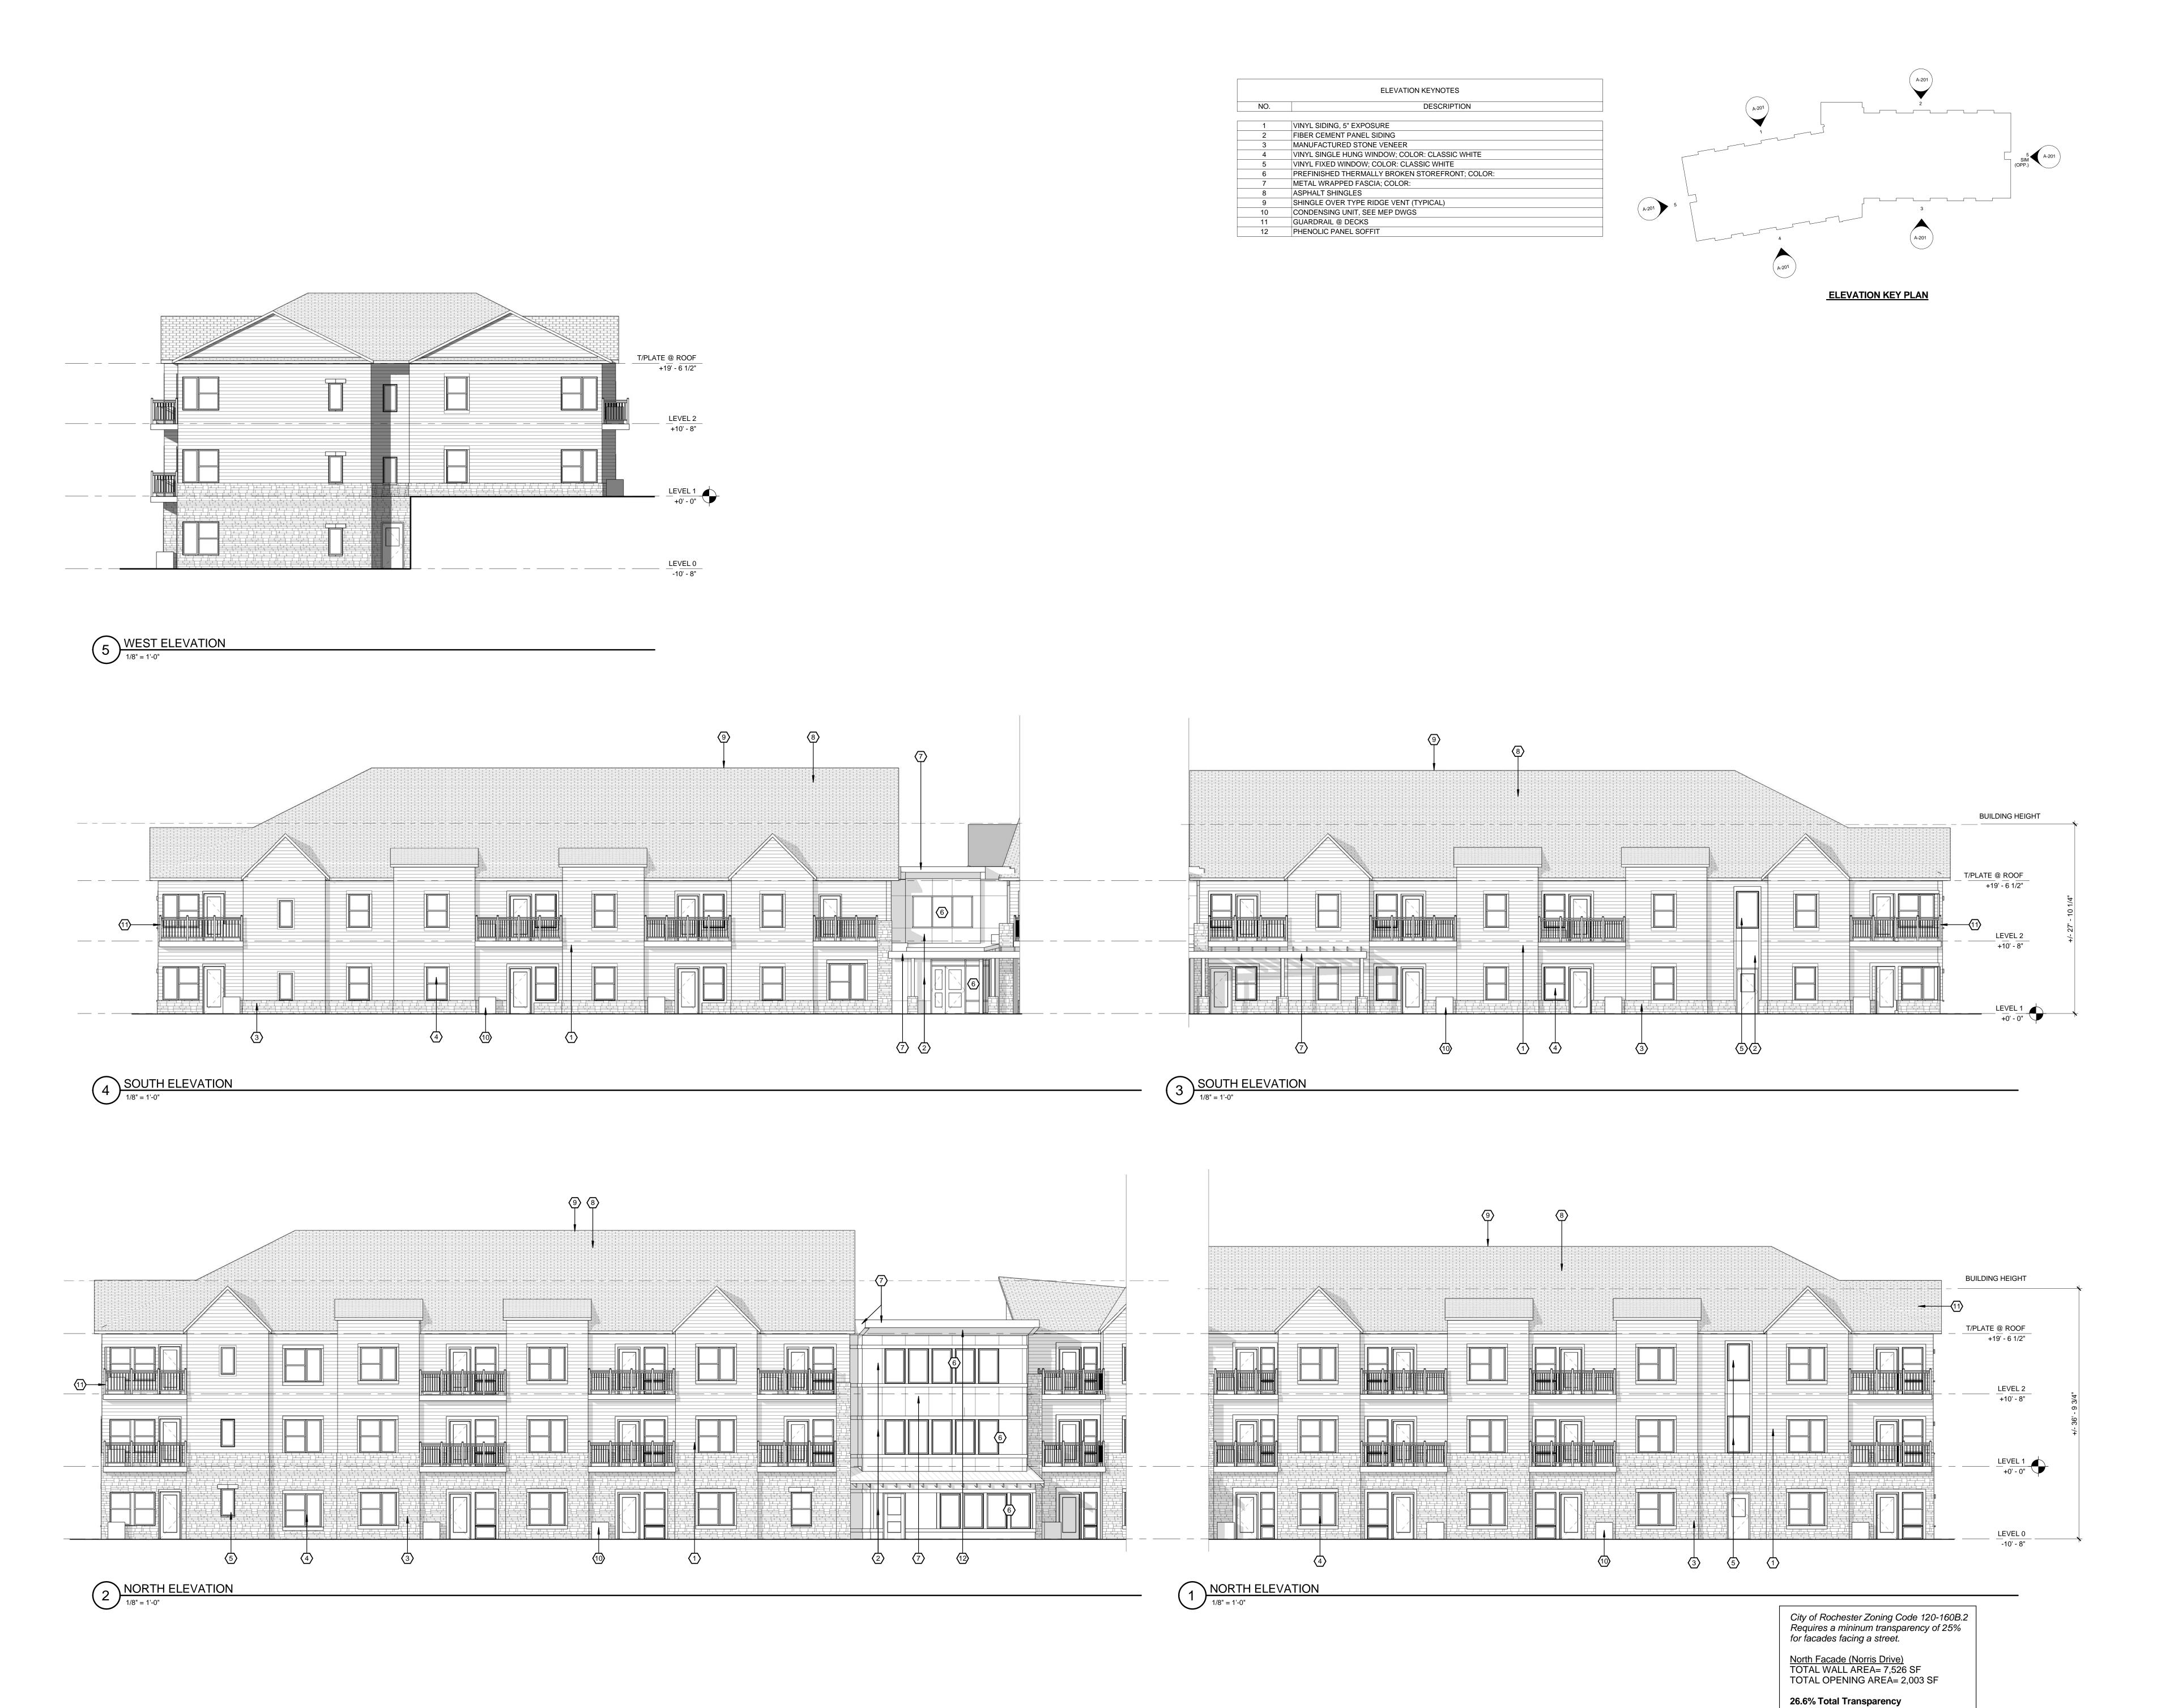

SWBR ARCHITECTS

387 East Main Street Rochester, NY 14604-2107 Voice: 585.232.8300 Fax: 585.232.9221 www.swbr.com

ROCHESTER, NEWYORK

no. date by description

PROJECT:
COBBS HILL VILLAGE
645 NORRIS DRIVE
ROCHESTER,NY 14610

CLIENT:
ROCHESTER MGMT, INC.
249 NORTON VILLAGE
LANE
ROCHESTER, NY 14609

DRAWING TITLE
BUILDING A- EXTERIOR
ELEVATIONS

DRAWING NO.

AA-201

drawn by EPS checked DG proj. mgr. EJG proj. no. 15915.0

STATUS:
SITE PLAN APPLICATION

ISSUE DATE: 04.21.2017



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BUILDING B- EXTERIOR


STATUS: SITE PLAN APPLICATION ISSUE DATE: 04.21.2017

ELEVATION KEYNOTES DESCRIPTION 1 VINYL SIDING, 5" EXPOSURE 3 MANUFACTURED STONE VENEER
4 VINYL SINGLE HUNG WINDOW; COLOR: CLASSIC WHITE 7 METAL WRAPPED FASCIA; COLOR: 8 ASPHALT SHINGLES 9 SHINGLE OVER TYPE RIDGE VENT (TYPICAL)



WEST ELEVATION- BUILDING C

1/8" = 1'-0"

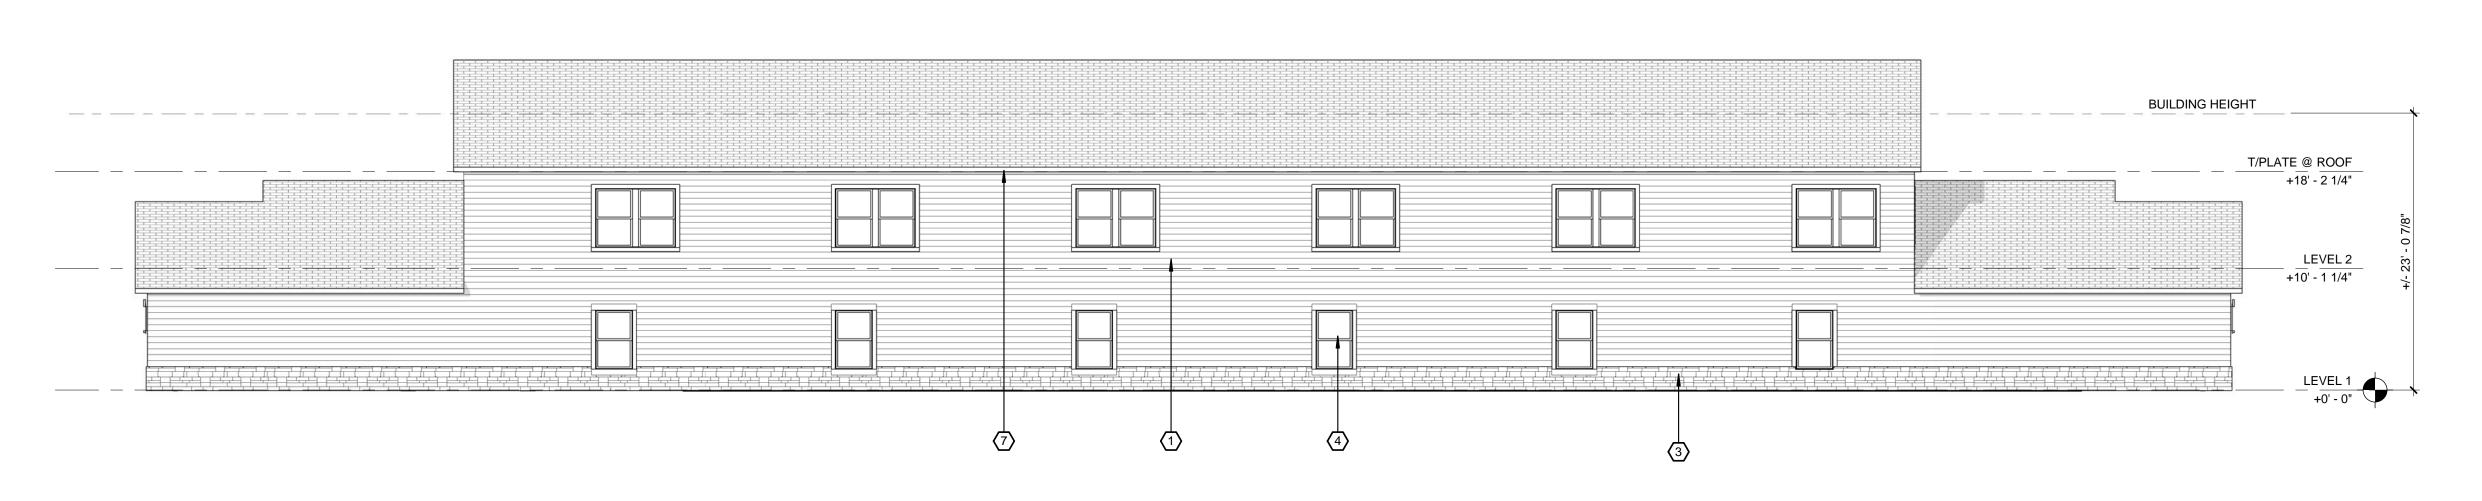

T/PLATE @ ROOF +18' - 2 1/4" LEVEL 2 +10' - 1 1/4"



NORTH ELEVATION

1/8" = 1'-0"

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no. date by

COBBS HILL VILLAGE 645 NORRIS DRIVE ROCHESTER,NY 14610

CLIENT: ROCHESTER MGMT, INC. 249 NORTON VILLAGE ROCHESTER, NY 14609

DRAWING TITLE BUILDING C- EXTERIOR ELEVATIONS

STATUS: SITE PLAN APPLICATION ISSUE DATE:











