


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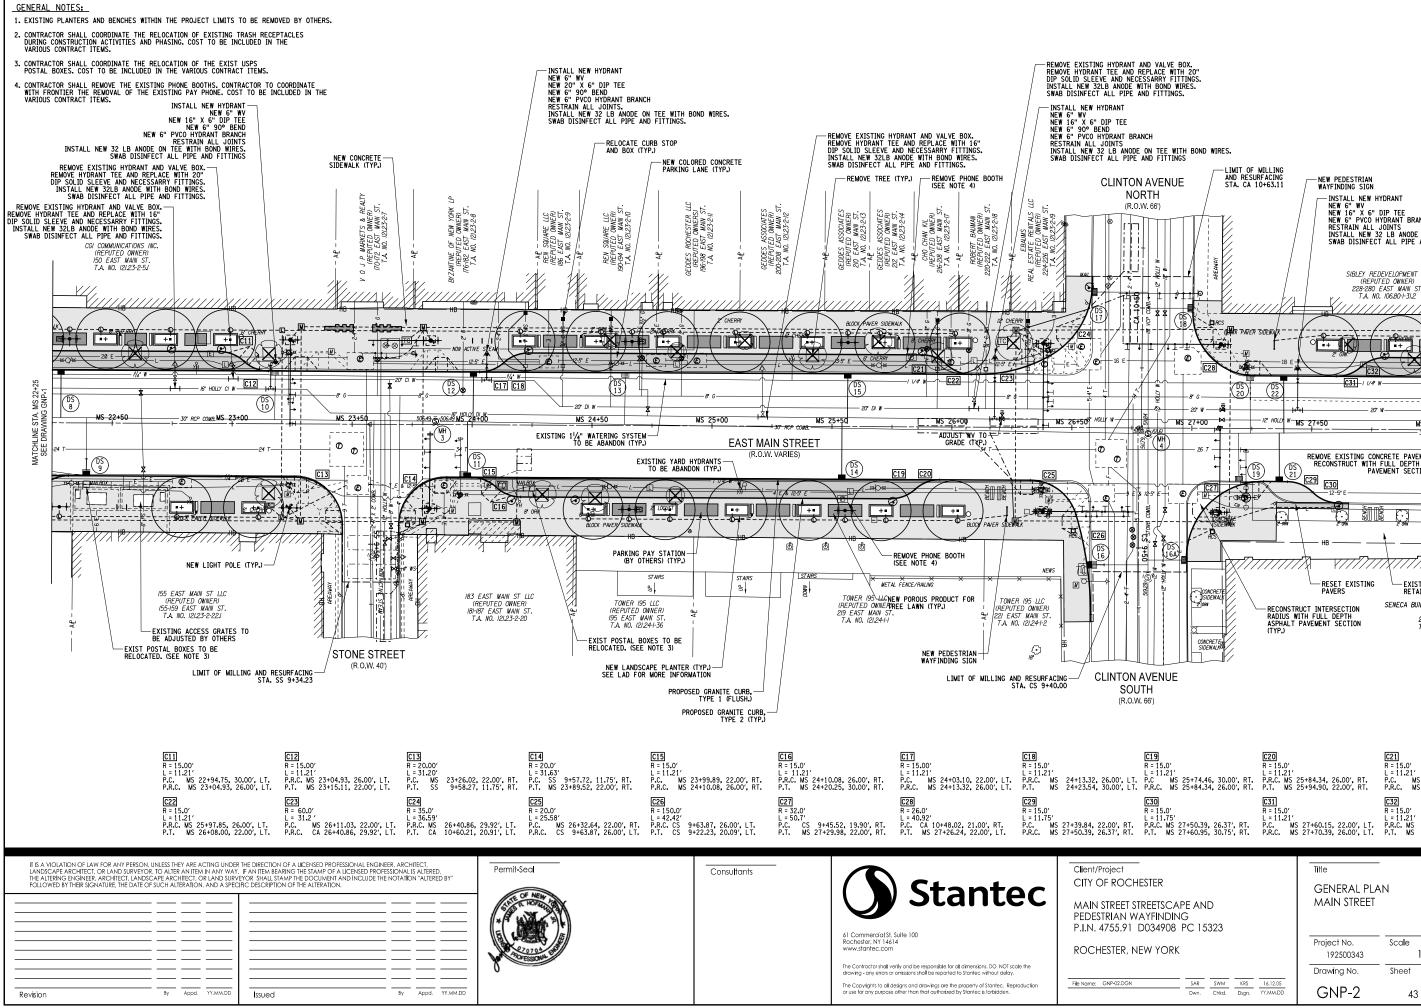
	BEGIN MILLING AND RESURFACIN STA. 20+12.0		(R.O.W. 66')	
SYSTE	STA. 20+12.0 SOP ASSOCIATES LLC IREPUTED OWNER IZ4 EAST MAN ST. T.A. NO. 12123-2-42 EXISTING WATERING EM SERVICE AT TAP HB HB HB HB HB HB HB HB HB HB			
PROFESSIONAL IS ALTERED PERMIT-SEG	Consultants	61 Commercial St. Sulle 101 Rochester, NY 14614 www.stantec.com The Contractor shall verify and b draving - any ences or amissions The Copyrights to all designs and	R = 20.00' R = 4 = 10.78' R = 4 P.C. SA 9+47.45, 19.57', RT. P.R./ P.R.C. SS 9+57.71, 22.41', RT. P.R./ F = 15.0' R = 1 P.R.C. MS 20+70.07, 26.00', RT. P.R./ P.R.C. MS 20+80.25, 30.00', RT. P.R./ MS 20+80.25, 30.00', RT. P.R./ Stantacture P.R./ MS 20+80.25, 30.00', RT. P.R./ Stantacture P.R./ MS 20+80.25, 30.00', RT. P.R./ MS 20+80.25, 30.20', 7.5', 7.5', 7.5', 7.5', 7.5', 7.5', 7.5',	40.0' 42.1' .C. SA 9+5
	SYST	STA. 20-120 SPR ASCHOLOGY PE A CP MAKE TO PE A CP MAKE	Site 2012/2014 Site 2012/2014 Site 2012/2014 Site 2012/2014 Site 2012/2014 Site 2012/2014 Site 2014 Site 2014 Sit	

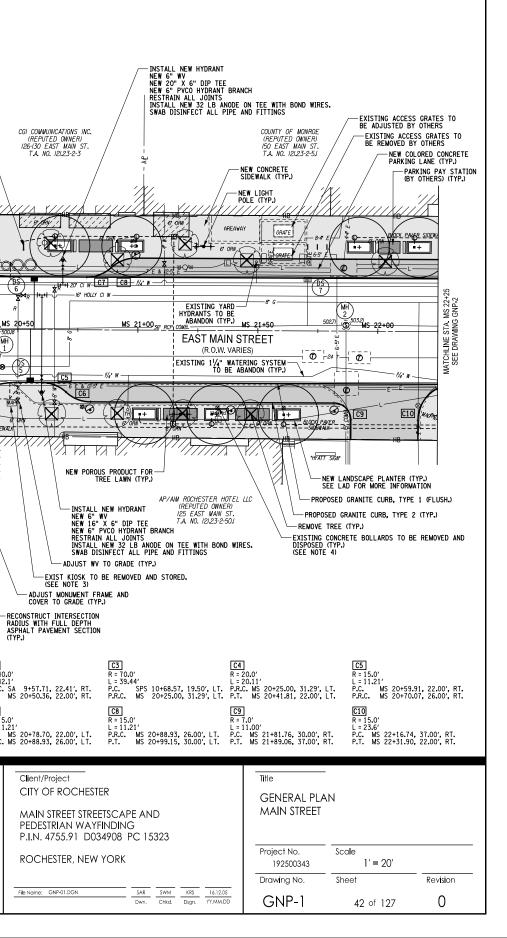




NEW PEDESTRIAN WAYFINDING SIGN-

ST. PAUL STREET (R.O.W. 66')




LIMIT OF MILLING AND RESURFACING STA. CA 10+63.11 NEW PEDESTRIAN WAYFINDING SIGN CLINTON AVENUE NORTH INSTALL NEW HYDRANT NEW 6" WV NEW 16" X 6" DIP TEE NEW 6" PYCO HYDRANT BRANCH RESITRAIN ALL JOINTS INSTALL NEW 32 LB ANODE ON TEE WITH BOND WIRES. SWAB DISINFECT ALL PIPE AND FITTINGS (R.O.W. 66') SIBLEY REDEVELOPMENT LP (REPUTED OWNER) 228-280 EAST MAIN ST. T.A. NO. 106.80-1-31.2 2 DRC: האות האותה האותה •+ **K**) (**•**+ 3 • +) Ð MS 28+ GNP-3 - 12" HOLLY W MS 27+50 MS 28+00 MATCHLINE STA. N SEE DRAWING REMOVE EXISTING CONCRETE PAVEMENT AND RECONSTRUCT WITH FULL DEPTH ASPHALT PAVEMENT SECTION (TYP.) H DS DS Ē V///// /////// -RESET EXISTING PAVERS -EXISTING TO BE RETAINED SENECA BUILDING OF MONROE COUNTY LLC (REPUTED OWNER) 245 EAST MAIN ST. T.A. NO. 12124-1-28.3 -RECONSTRUCT INTERSECTION RADIUS WITH FULL DEPTH ASPHALT PAVEMENT SECTION (TYP.) CONCRETE SIDEWALK C20 R = 15.0' L = 11.21' P.R.C. MS 25+84.34, 26.00', RT. P.T. MS 25+94.90, 22.00', RT. C19 R = 15.0' L = 11.21' R = 15.0' L = 11.21' P.C MS 25+74.46, 30.00', RT. P.R.C. MS 25+84.34, 26.00', RT. P.C. MS 25+87.67, 30.00', LT. P.R.C. MS 25+97.80, 26.00', LT. 27+70.39, 26.00', LT. 27+80.65, 30.00', LT. Title GENERAL PLAN MAIN STREET MAIN STREET STREETSCAPE AND P.I.N. 4755.91 D034908 PC 15323 Project No. Scale 192500343 1' = 20' Sheet Drawina No. Revision
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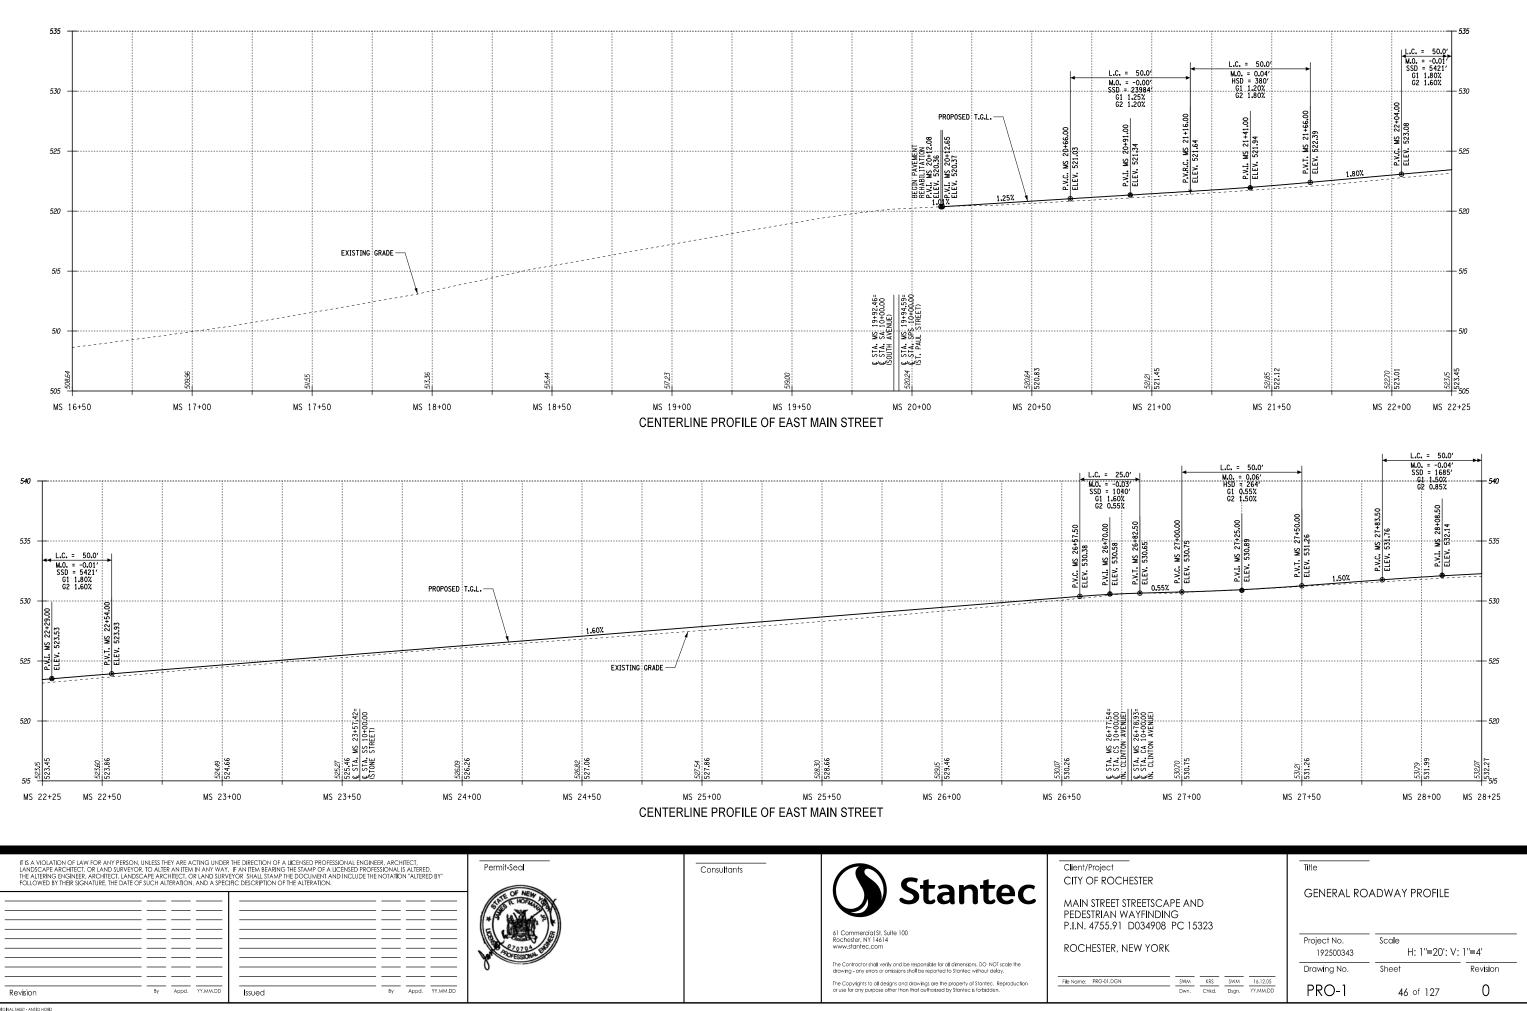



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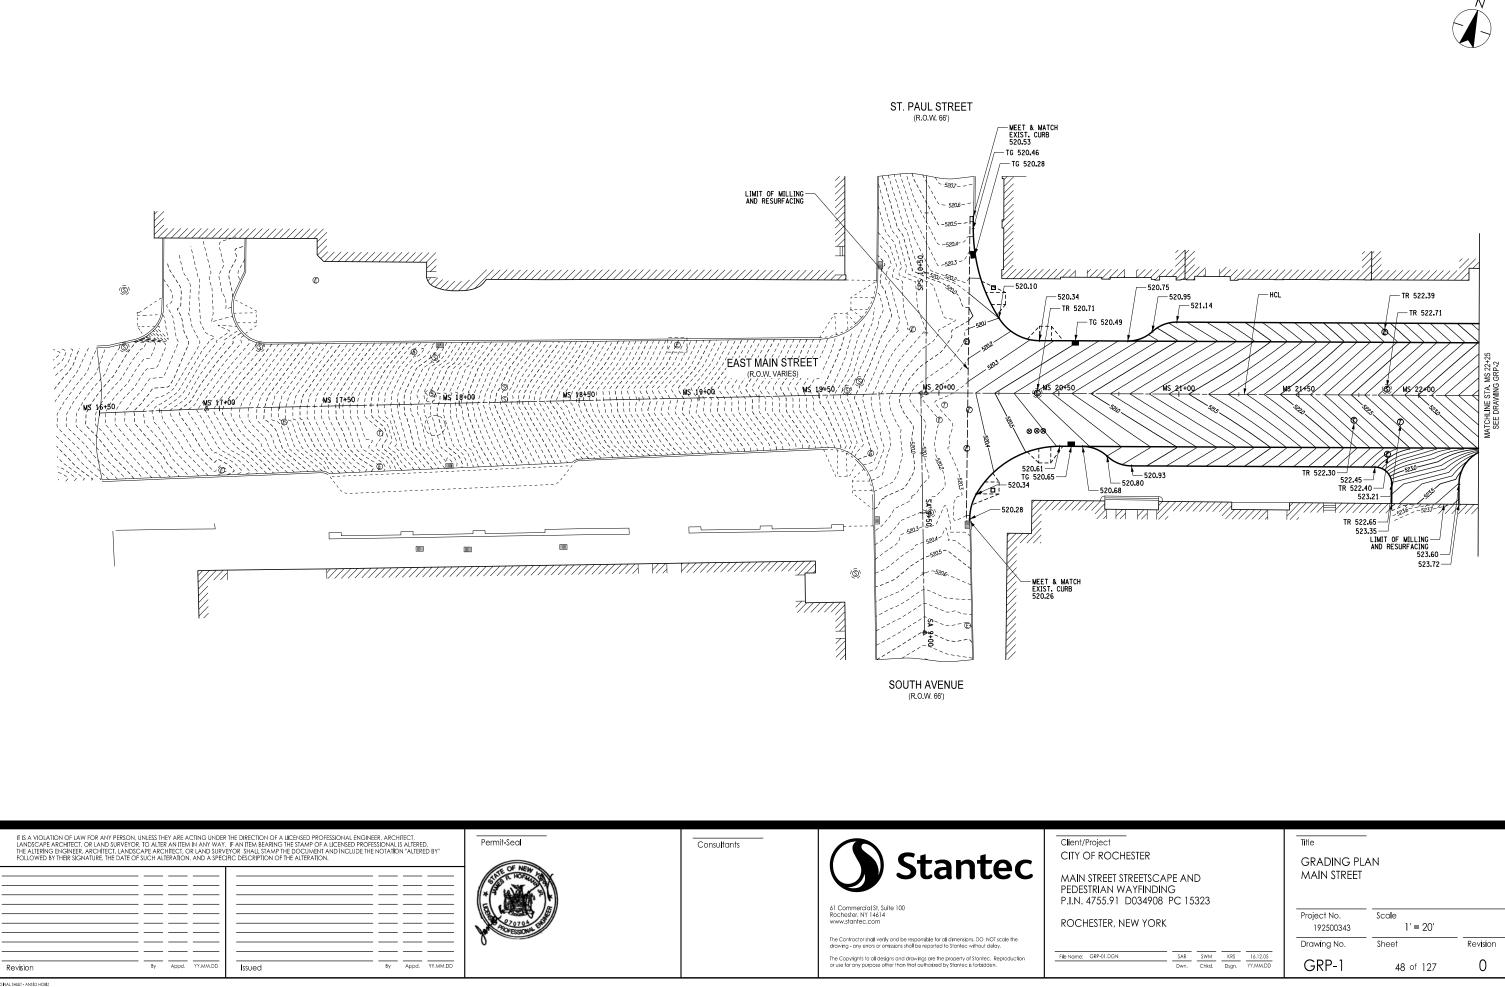
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esign/Drawing/F	LANDSCAPE ARCHITECT, OR LAND SURVEYO	R, TO ALTER AN ITEM IN ANY WAY	R THE DIRECTION OF A LICENSED PROFESSIONAL ENC . IF AN ITEM BEARING THE STAMP OF A LICENSED PR EVOR SHALL STAMP THE DOCUMENT AND INCLUDE JFIC DESCRIPTION OF THE ALTERATION.	OFESSIONAL IS ALTERED.	Permit-Seal	Consultants	Stantoc	Client/Proj CITY OF
Design File: U:\192500343\Transportation\D Date/Time: 11/29/2016 6:29:18 PM Plotted Bv: statither	Revision	By Appd. YY.MM.DD		By Appd. YY.MM.DD			Al Commercial SI, Suite 100 Rochester, NY 14614 www.stantec.com The Contractor shall verify and be responsible for all dimensions. DO NOT scale the drawing - any errors or amissions shall be reported to Stantee without delay. The Copyrights to all designs and clawings are the property of Stantec. Reproduction or use for any purpose other than that authorized by Stantec's forbidden.	MAIN STI PEDESTR P.I.N. 473 ROCHES
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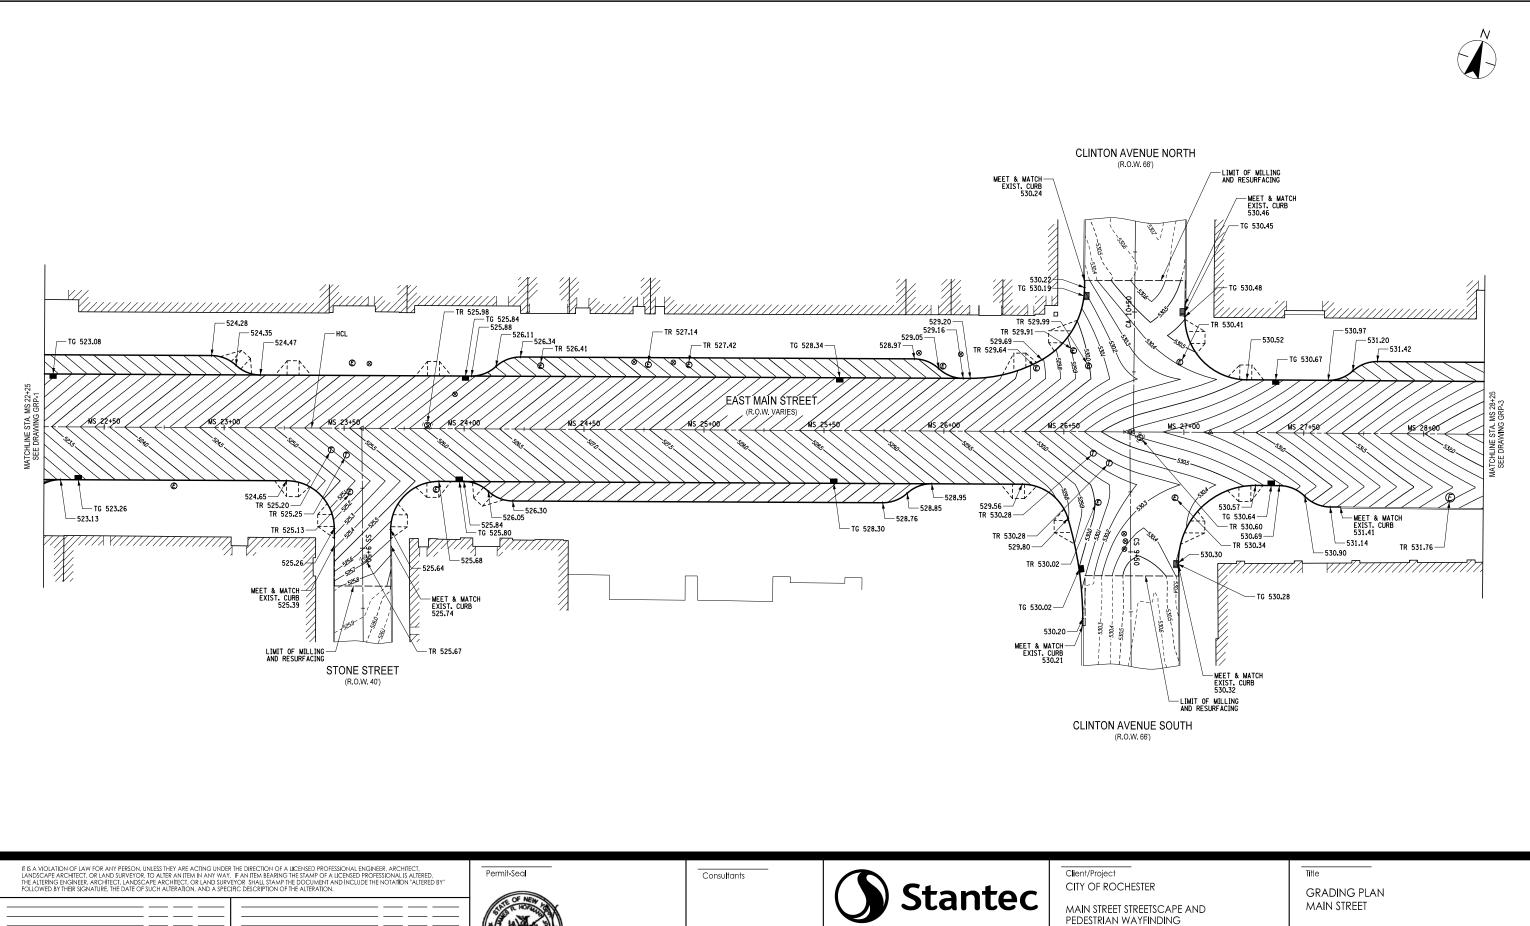

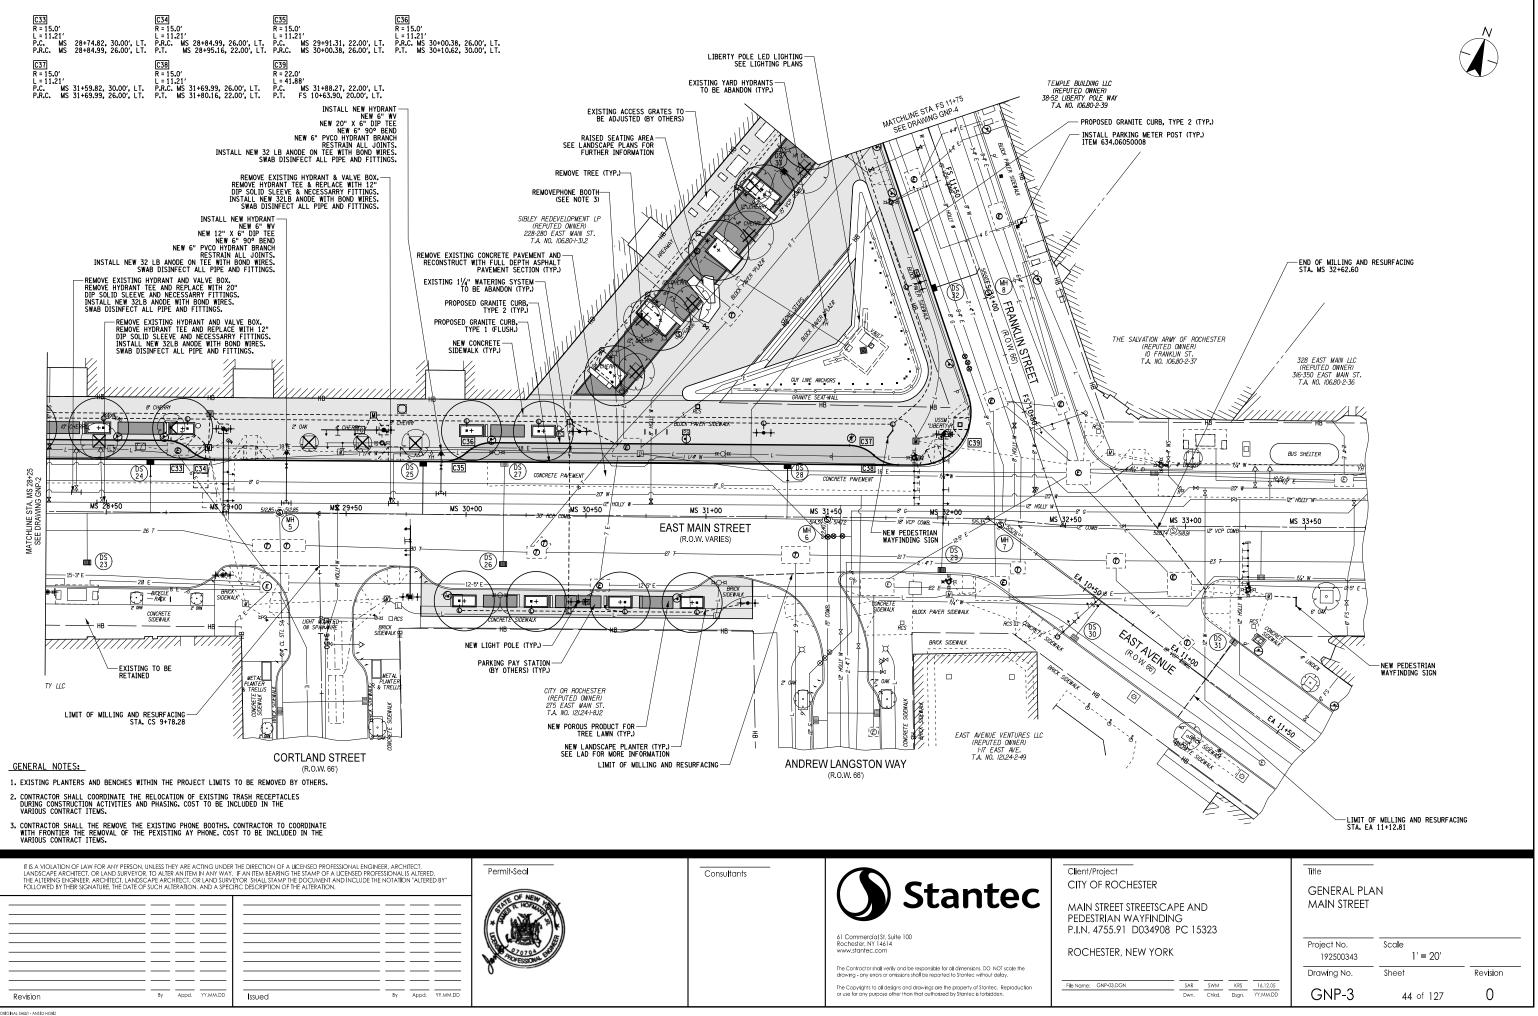
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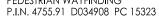
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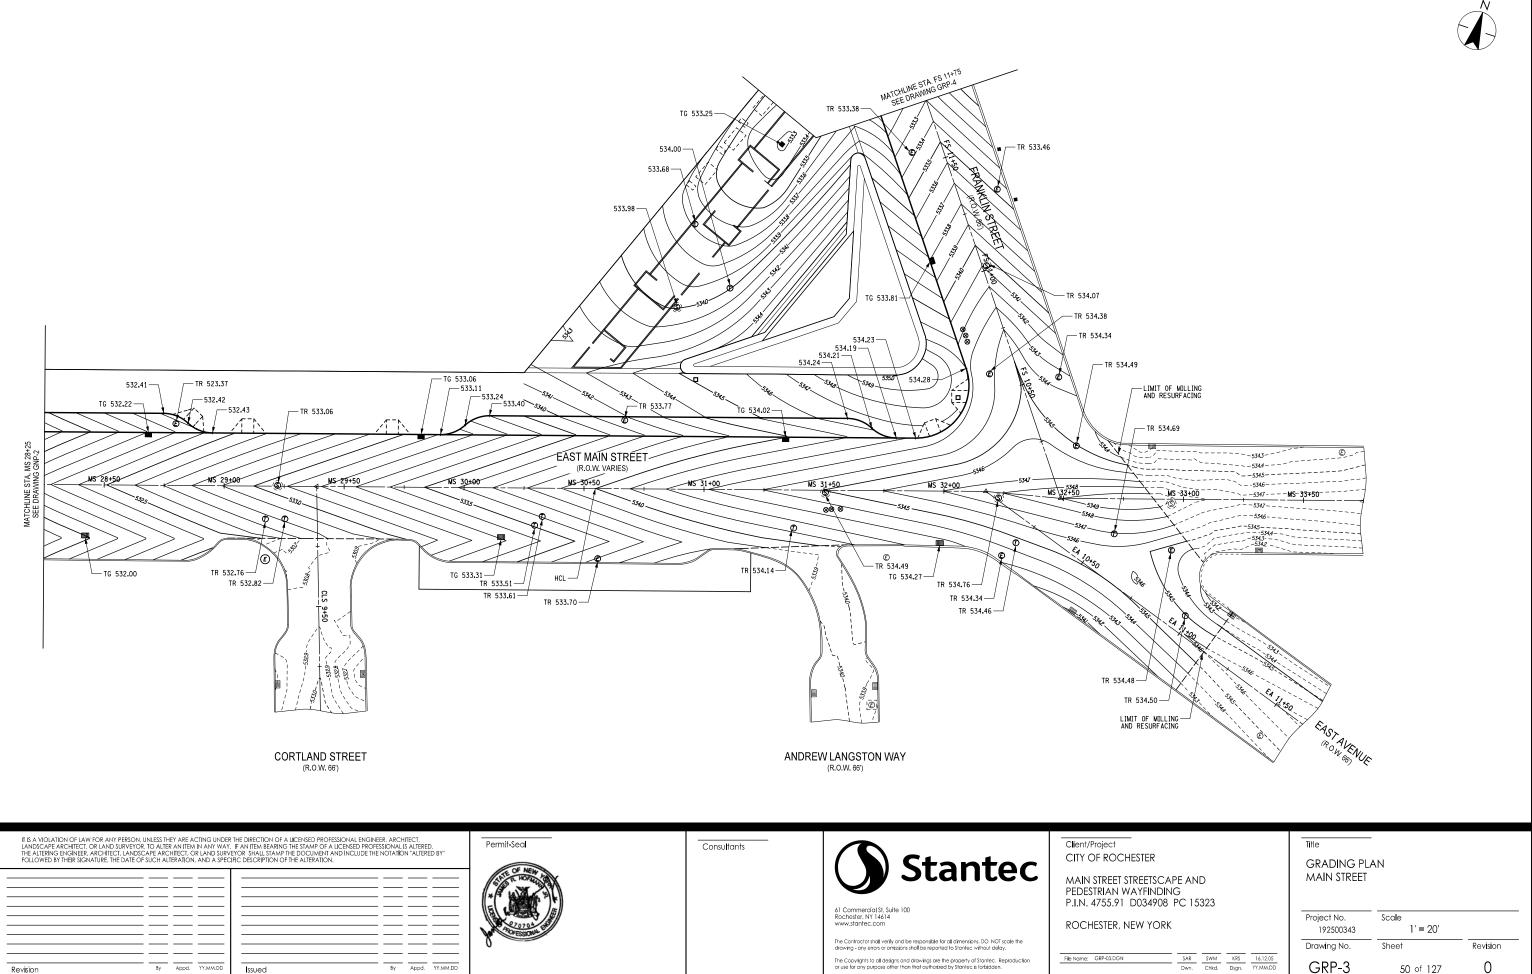


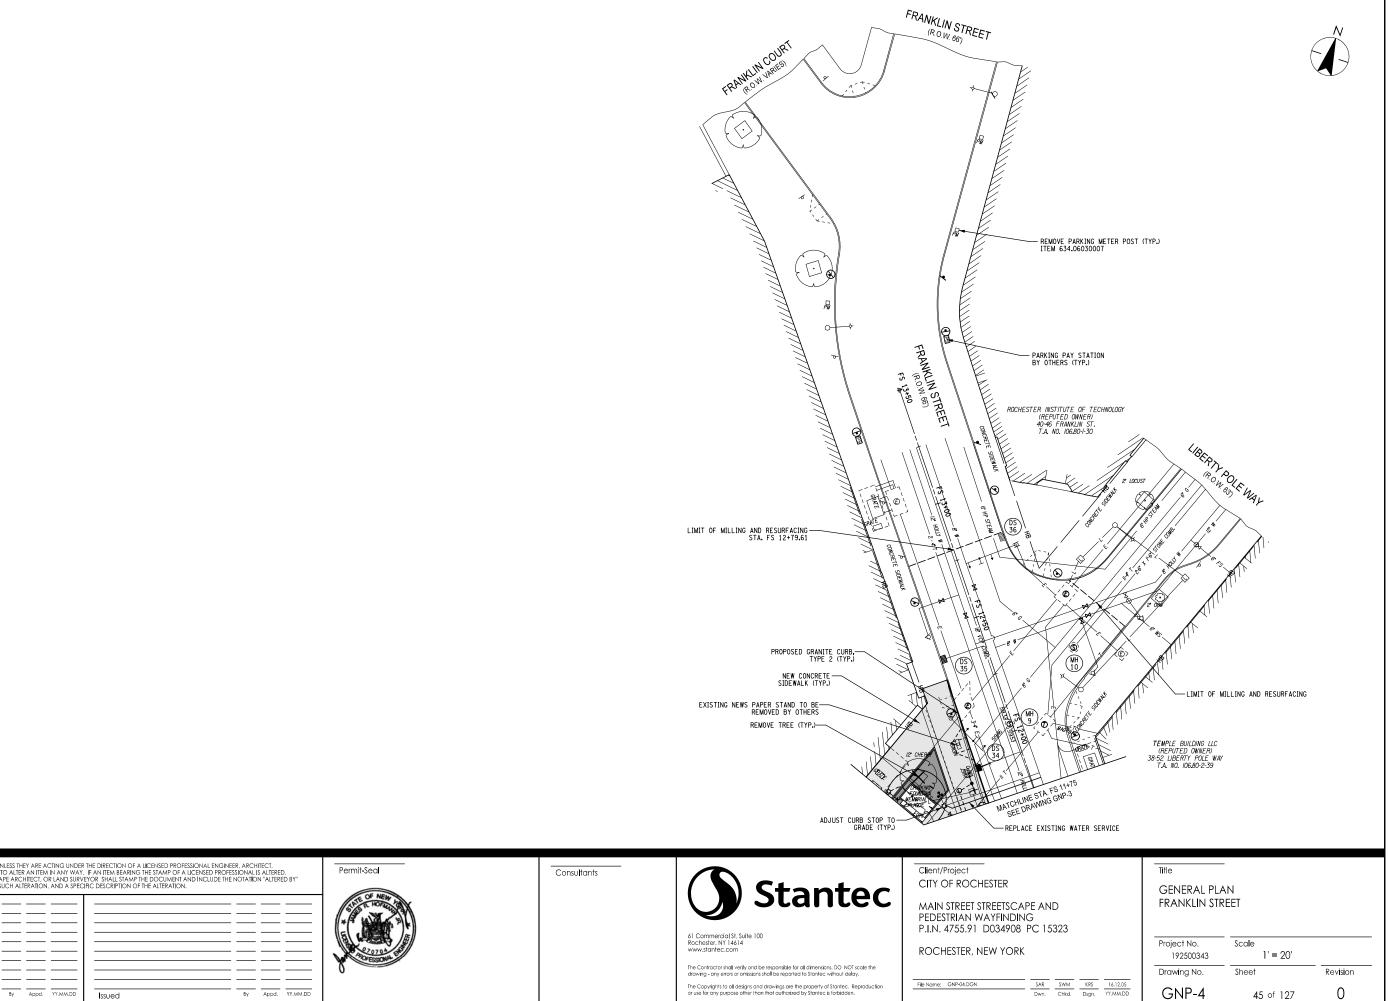


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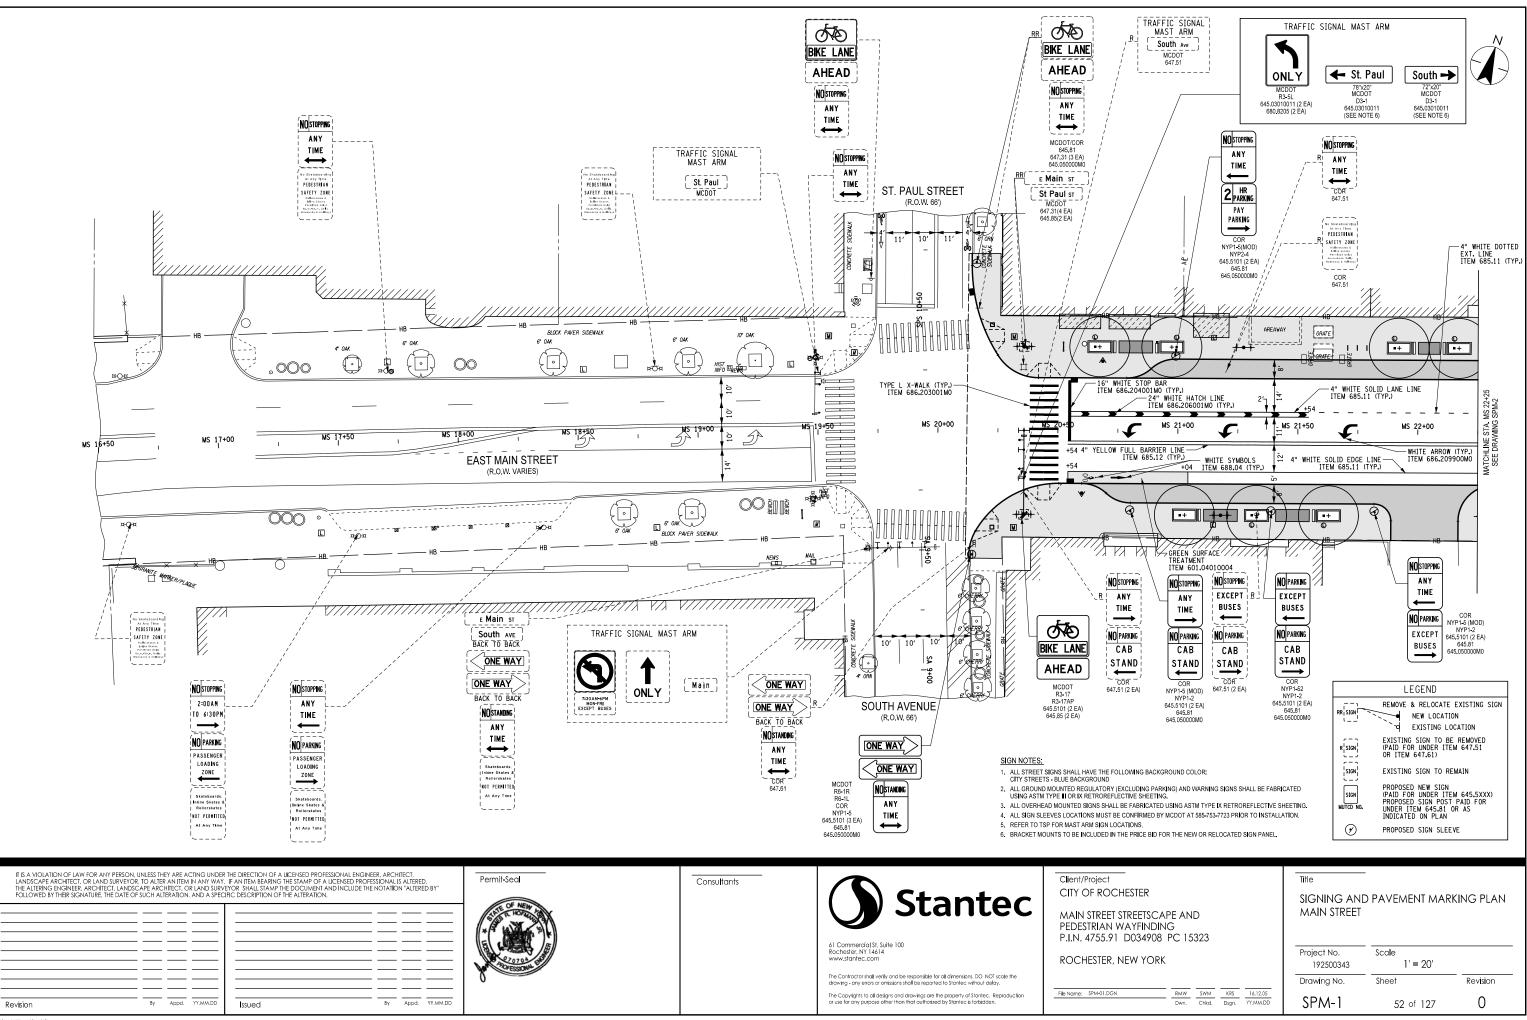
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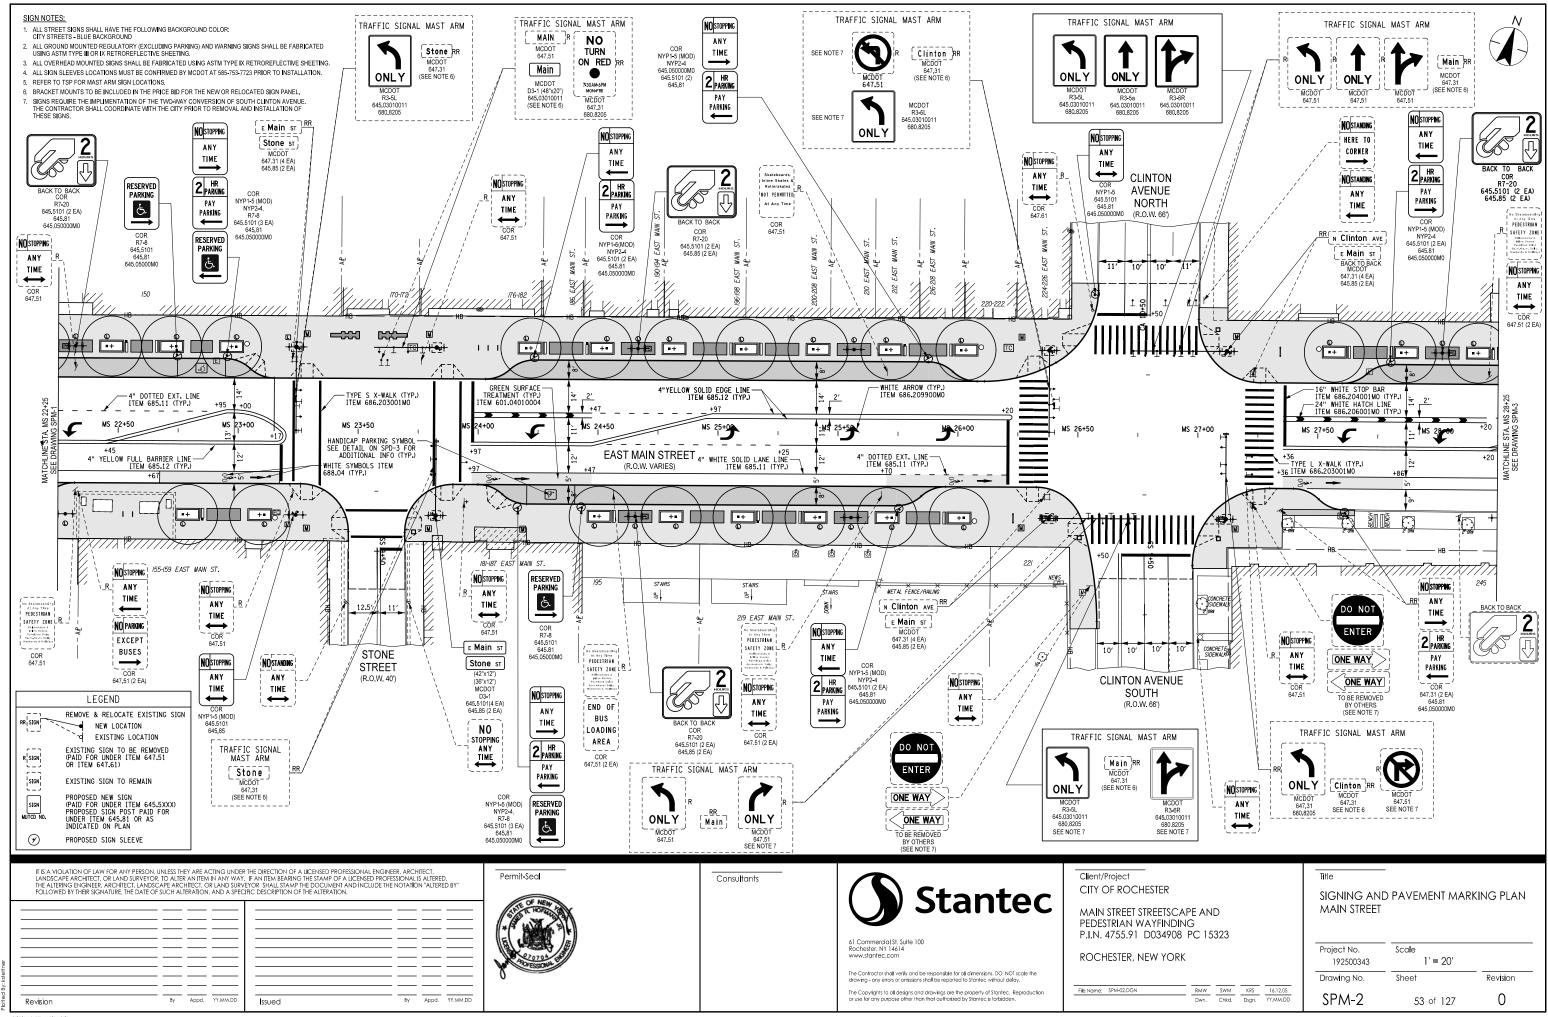
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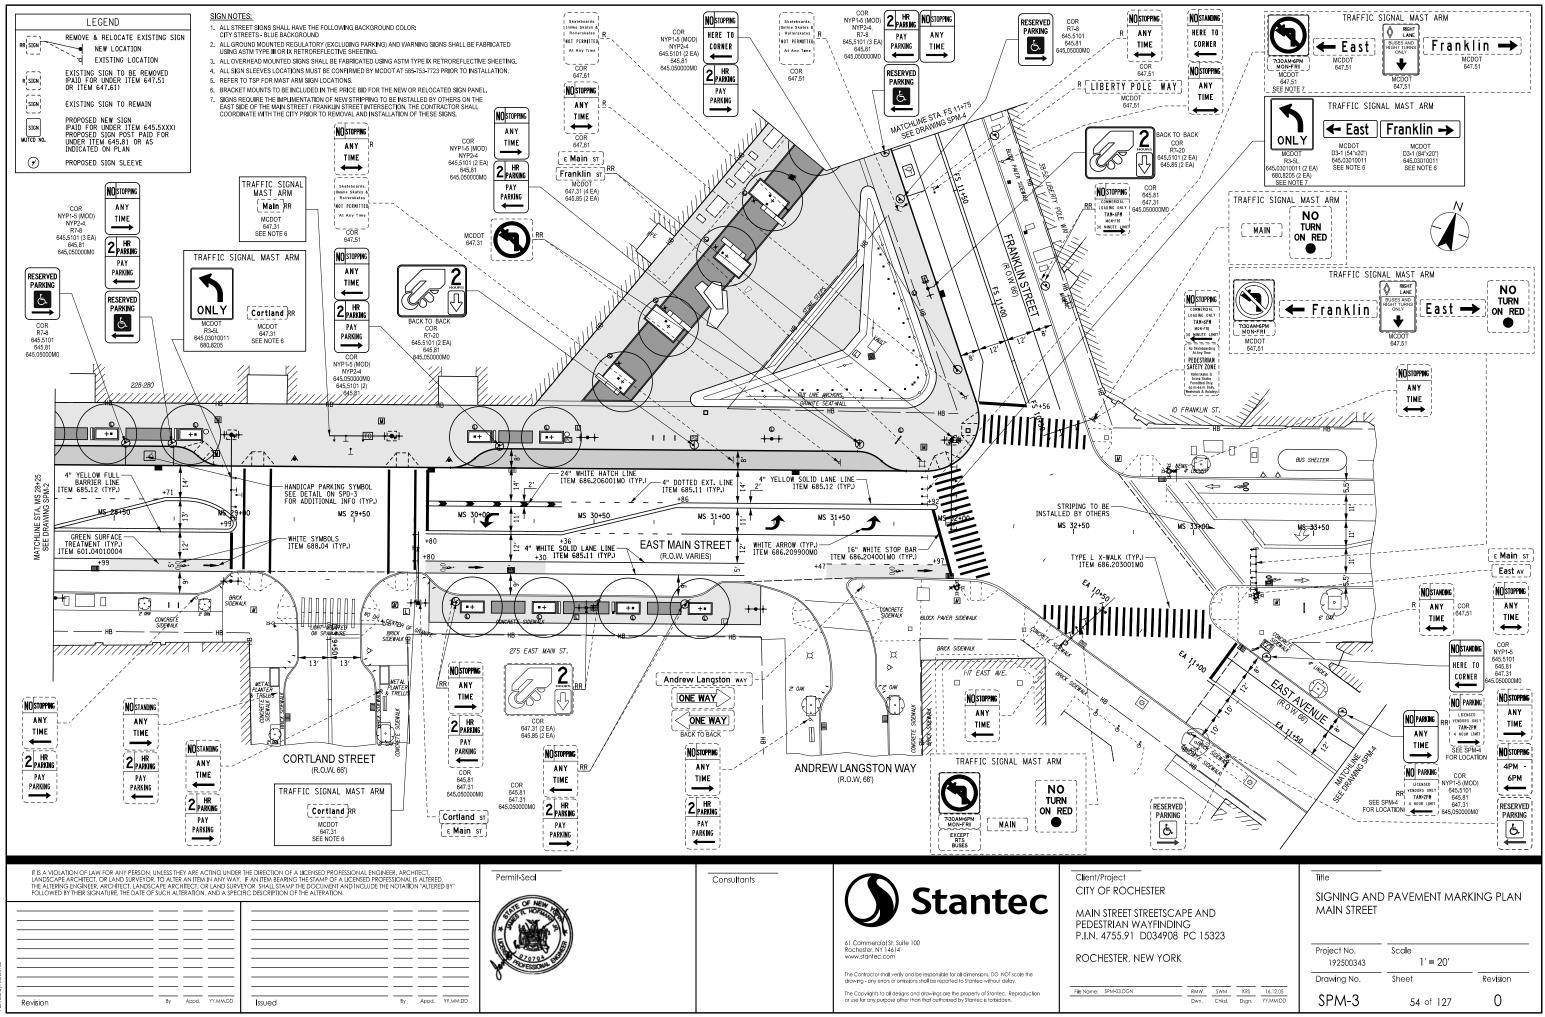
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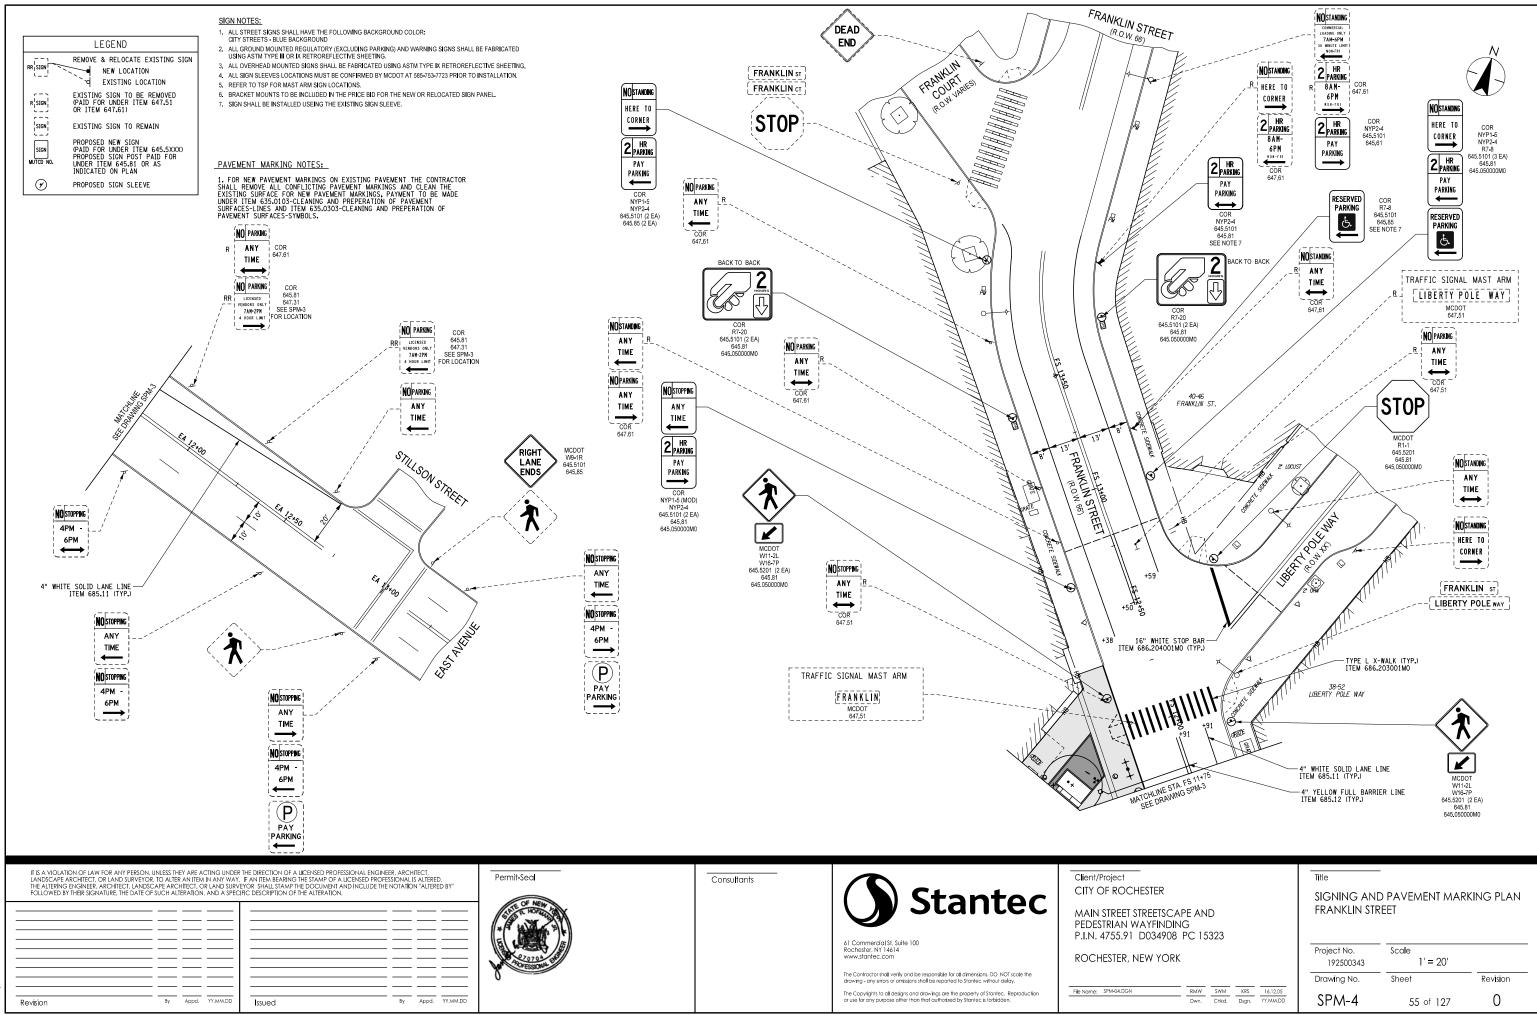
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s: U:\192500343\Transportation\D s: 11/29/2016 6:29:26 PM r: kstettner					Al Commercial SI, Suite 100 Rochester, NY 14614 www.stantec.com The Contractor shall verify and be responsible for all dimensions. DO NOT scale the dowing - any errors or omissions shall be reported to Stantee without delay.	MAIN STREET S PEDESTRIAN W P.I.N. 4755.91 ROCHESTER, N
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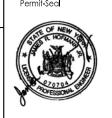


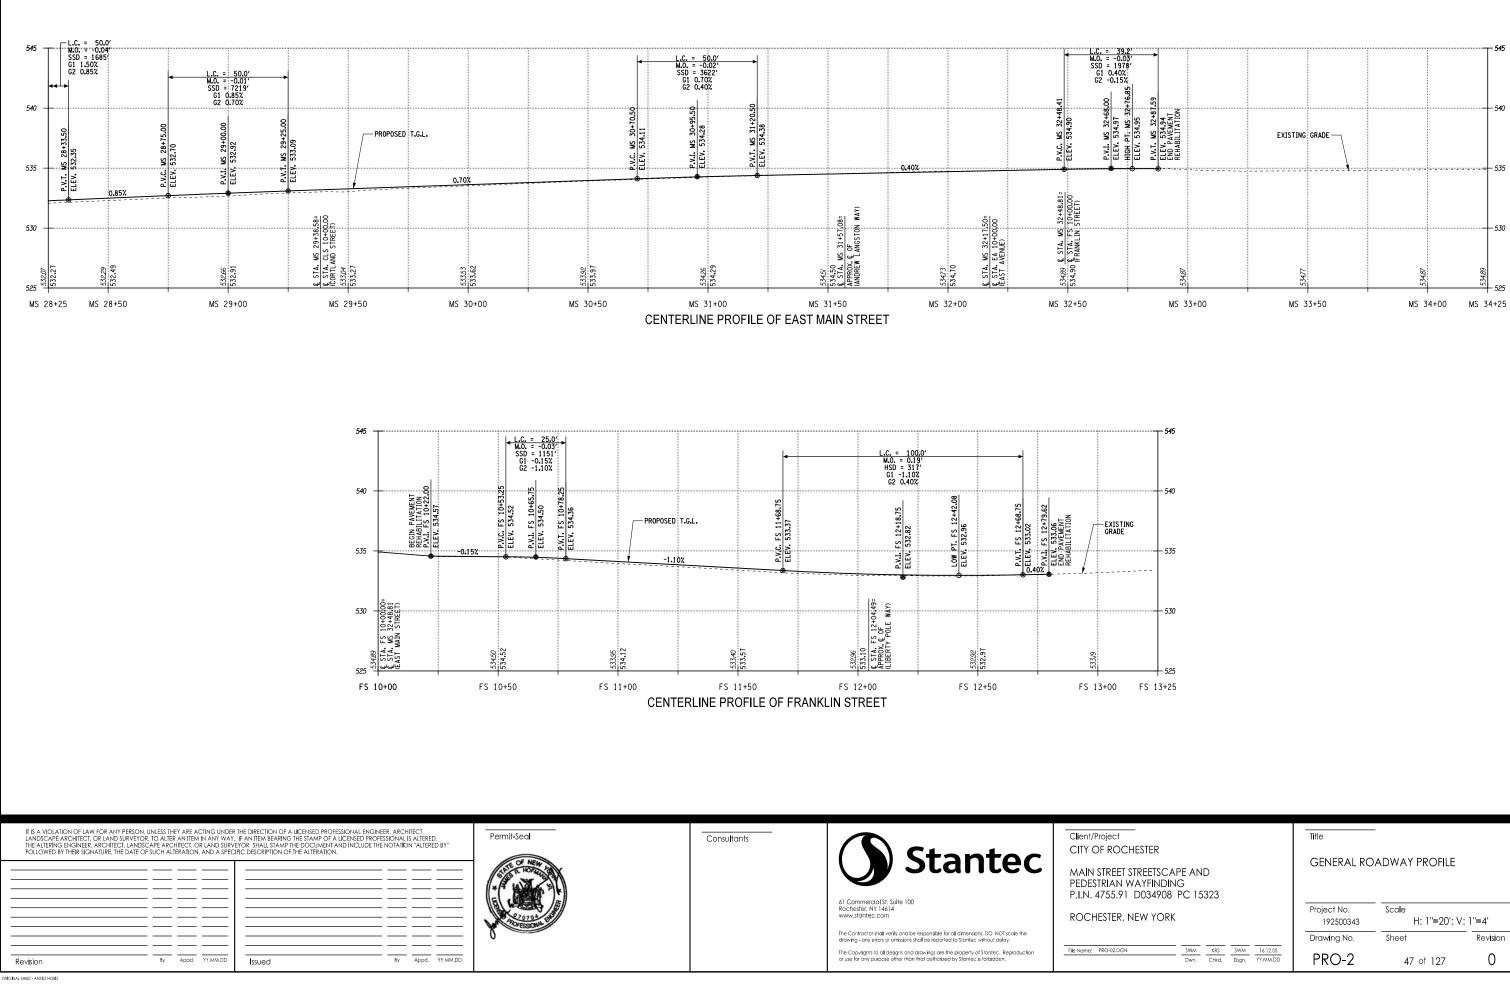

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TEM 645.81		TYPE A SIGN POS	эт												EACH		
TEM 645.85			SIGN SUPPORT SYS	TEM (BAND MC											EACH		
TEM 647.31			PANEL, SIGN PANEL	,	,	=)									EACH		
TEM 647.51			POSE SIGN PANEL,			,									EACH		
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TEM 647.61			POSE SIGNS, GROU		TYPE A SIGN	SUPPORTS AN		JNS SIZE T (UN	IDER 30 SF)						EACH		
TEM 680.8205		SIGN TYPE	ASSEMBLY, TYPE E		GN PANEL			1			MOUNTING	TVDE				CATE	—
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HESTER

MAIN STREET STREETSCAPE AND PEDESTRIAN WAYFINDING P.I.N. 4755.91 D034908 PC 15323

ROCHESTER, NEW YORK

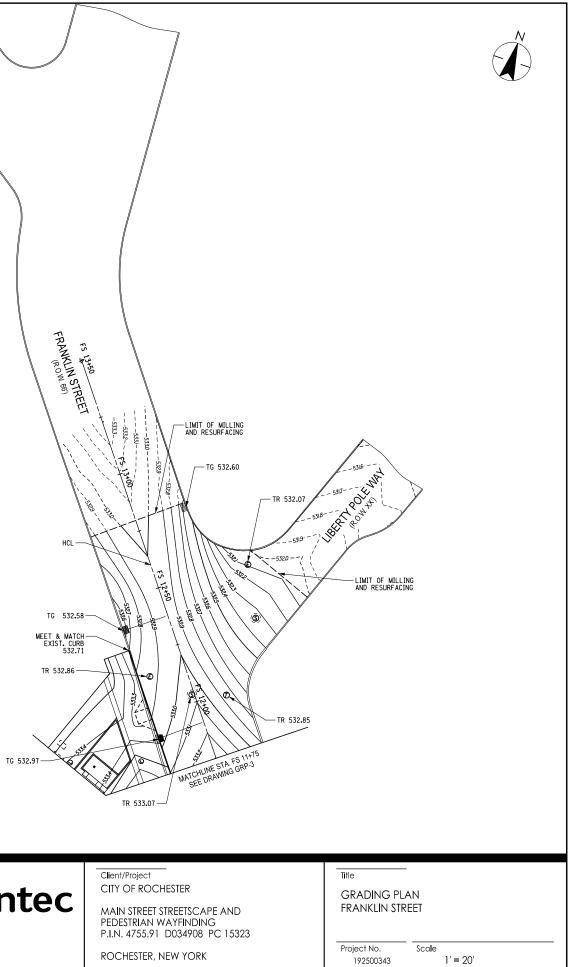File Name: SPT-01.DGN

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TEM 645.030100	011	HIGH-VISIBILITY O	VERHEAD-MOUNTED	SIGN PANEL	S										SQUARE FOO	отт		
TEM 645.5101		GROUND-MOUNTE	D SIGN PANELS WI	THOUT Z-BARS	6										SQUARE FOO	т		
TEM 645.5201		GROUND-MOUNTE	D SIGN PANELS WI	THOUT Z-BARS	6 HIGH VISIBIL	ITY SHEETING									SQUARE FOOT			
TEM 645.050000	0MO	SIGN SLEEVE											EACH					
TEM 645.81		TYPE A SIGN POST											EACH					
TEM 645.85		POLE MOUNTED SIGN SUPPORT SYSTEM (BAND MOUNTED)											EACH					
TEM 647.31		RELOCATE SIGN PANEL, SIGN PANEL ASSEMBLY 1 (UNDER 30 SF)											EACH					
TEM 647.51		REMOVE AND DIS	POSE SIGN PANEL,	SIGN PANEL	ASSEMBLY 1	(UNDER 30 SF)									EACH			
TEM 647.61		REMOVE AND DIS	POSE SIGNS, GROU	IND MOUNTED	TYPE A SIGN	SUPPORTS AN		ONS SIZE 1 (UN	DER 30 SF)						EACH			
TEM 680.8205		OVERHEAD SIGN	ASSEMBLY, TYPE E												EACH			
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MS 24+43	RT	R7-8			1.5				1		1						+	
MS 24+57	RT	R5-X																
MS 24+57	RT	R5-X																
MS 24+65	RT	R7-20			6								2					
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HESTER

MAIN STREET STREETSCAPE AND PEDESTRIAN WAYFINDING P.I.N. 4755.91 D034908 PC 15323

ROCHESTER, NEW YORK

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ITEM 645.030100	011	HIGH-VISIBILITY O	VERHEAD-MOUNTED	O SIGN PANEL	S										SQUARE FOO	т	
ITEM 645.5101		GROUND-MOUNTE	D SIGN PANELS WI	THOUT Z-BARS	3										SQUARE FOO	т	
TEM 645.5201			D SIGN PANELS WI			TY SHEETING									SQUARE FOOT		
TEM 645.050000	OMO	SIGN SLEEVE													EACH		
TEM 645.81		TYPE A SIGN POS	т												EACH		
TEM 645.85				TEM (BAND MC											EACH		
TEM 647.31		POLE MOUNTED SIGN SUPPORT SYSTEM (BAND MOUNTED) RELOCATE SIGN PANEL, SIGN PANEL ASSEMBLY 1 (UNDER 30 SF)									EACH						
TEM 647.51		RELOCATE SIGN PANEL, SIGN PANEL ASSEMBLY T (UNDER 30 SF) REMOVE AND DISPOSE SIGN PANEL, SIGN PANEL ASSEMBLY 1 (UNDER 30 SF)															
										EACH							
TEM 647.61										EACH							
TEM 680.8205			ASSEMBLY, TYPE E					r				T/DE			EACH		T
		SIGN TYPE		SI	GN PANEL					 	MOUNTING			1	RELC	CATE	_
ITE	EM	MUTCD NUMBER	ITEM 645.03010011	ITEM 6	45.5101	ITEM 64	45.5201	ITEM 645.0	050000MO	ITEM 6	645.81	ITEM	645.85	ITEM 680.8205	ITEM	647.31	ITEM
FUNDING	G SHARE		MCDOT	MCDOT	COR	MCDOT	COR	MCDOT	COR	MCDOT	COR	MCDOT	COR	MCDOT	MCDOT	COR	MCDOT
STATION	/ OFFSET		-								MAINS	STREET					
MS 26+88	LT	R3-5L	7.5											1			1
MS 26+88	LT	R3-5a	7.5											1			1
MS 26+88 MS 26+88	LT LT	R3-6R D3-1	7.5											1	1		1
MS 20+00 MS 27+12	RT	D3-1										2		<u> </u>	4		+
MS 27+12	RT	R3-5L												1	1		+
MS 27+12	LT	D3-1													1		1
MS 27+12	RT	R3-1															1
MS 27+23	RT	NYP1-5(MOD)															
MS 27+62	RT	NYP1-5(MOD)							1		1					1	
MS 27+62 MS 27+80	RT	NYP2-4			1.5									<u> </u>		1	
MS 27+80 MS 27+80	LT LT	NYP1-5 (MOD) NYP2-4			1.5				1		1			+			+
MS 28+01	LT	R7-20			6								2	1			+
MS 28+21	LT	R5-X															_
MS 28+21	LT	NYP1-5 (MOD)															
MS 28+54	LT	R7-8			1.5				1		1						
MS 28+74	LT	NYP1-5 (MOD)			1.5 1.5	ļ			4								
MS 28+54 MS 28+74	LT LT	NYP2-4 R7-8			1.5	<u>}</u>			1		1			<u> </u>			
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MS 28+99	LT	D3-1													1		1
MS 29+43	LT	D3-1													1		
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MS 29+91 MS 30+10	RT	NYP2-4			1.5											1	
MS 30+10 MS 30+10	LT LT	NYP1-5 (MOD) NYP2-4	-		1.5				1		1			1			+
MS 30+47	RT	R7-20											2	1		2	1
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MS 30+88	RT	NYP2-4														1	
MS 30+91	LT	R7-20			6				1		1						
MS 31+08 MS 31+08	LT	NYP1-5 (MOD)															+
MS 31+08 MS 31+52	LT LT	R5-X R3-2												<u> </u>	1		+
MS 31+52 MS 31+60	LT	NYP1-5 (MOD)			1.5									+	<u> </u>		+
MS 31+60	LT	NYP2-4			1.5				1		1			1			1
MS 31+87	LT	D3-1										2			4		2
MS 31+87	LT	R3-2															1
SUBT	I OTAL		30	0	27	0	0	0	9	0	9	4	4	5	15	8	7
		1	1 50					U U	3		3						<u> </u>

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REMOVAL									
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	_	S	GNING AND	PAVEMENT TABLES	\$
CAPE ANI DING D8 PC 15					
RK		Pr	oject No. 192500343	Scale N.T.S.	
		Dr	awing No.	Sheet	Revision
RMW Dwn.		6.12.05 MM.DD	SPT-3	58 of 127	0

Client/Project CITY OF ROCHESTER

MAIN STREET STREETSCAPE AND PEDESTRIAN WAYFINDING P.I.N. 4755.91 D034908 PC 15323

ROCHESTER, NEW YORK

File Name: \$PT-03.DGN

								REGUL	ATORY A		ING SIGN	IS						
ITEM 645.030100	011	HIGH-VISIBILITY O	VERHEAD-MOUNTED	O SIGN PANEL	S										SQUARE FOO			
ITEM 645.5101		GROUND-MOUNTE	D SIGN PANELS WI	THOUT Z-BARS	6										SQUARE FOO	т		
ITEM 645.5201		GROUND-MOUNTE	D SIGN PANELS WI	THOUT Z-BARS	6 HIGH VISIBILI	ITY SHEETING									SQUARE FOOT			
ITEM 645.050000	OMO	SIGN SLEEVE													EACH			
ITEM 645.81		TYPE A SIGN POS	т												EACH			
ITEM 645.85			IGN SUPPORT SYS	TEM (BAND M											EACH			
ITEM 647.31			PANEL, SIGN PANEL			=)									EACH			
ITEM 647.51			POSE SIGN PANEL,		,	,									EACH			
ITEM 647.61						,									EACH			
ITEM 680.8205		REMOVE AND DISPOSE SIGNS, GROUND MOUNTED TYPE A SIGN SUPPORTS AND FOUNDATIONS SIZE 1 (UNDER 30 SF) OVERHEAD SIGN ASSEMBLY, TYPE E																
TTEIN 000.0205			ASSEMBLT, ITPE E					r							EACH		Τ	
		SIGN TYPE		51	GN PANEL	1				1	MOUNTING				RELC	CATE		
ITE	EM	MUTCD NUMBER	ITEM 645.03010011	ITEM 6	45.5101	ITEM 64	45.5201	ITEM 645.	050000MO	ITEM	645.81	ITEM	645.85	ITEM 680.8205	ITEM	647.31	47.31 ITEM	
FUNDING	G SHARE		MCDOT	MCDOT	COR	MCDOT	COR	MCDOT	COR	MCDOT	COR	мсдот	COR	MCDOT	MCDOT	COR	MCDOT	
STATION	/ OFFSET		•			•					MAINS	STREET		1			4	
												1					Τ	
MS 31+87	LT	NYR7-4P															1	
MS 31+87	LT	R3-11b (MOD)															1	
MS 31+99	LT	R3-5L X 2	15											2			<u> </u>	
MS 31+99 MS 33+25	LT	D3-1	19.2														<u> </u>	
MS 33+25 MS 33+25	RT RT	R3-2 (MOD) R3-11b (MOD)															1	
FS 10+67	LT	NYP1-5 (MOD)															<u> </u>	
FS 10+78	LT	NYP1-5 (MOD)	<u> </u>		1.5			l	1		1						+	
FS 10+78	LT	NYP2-4			1.5												<u> </u>	
FS 11+02	RT	NYP1-5 (MOD)							1		1					1		
FS 11+15	LT	R7-20			6								2					
FS 11+50	LT	R5-X																
FS 11+50 FS 11+50	LT	NYP1-5 (MOD)															1	
FS 11+51	LT LT	D3-1 R7-8			1.5				1		1						+ '	
FS 11+63	LT	R5-X															+	
FS 11+71	LT	NYP1-5 (MOD)			1.5													
FS 11+71	LT	NYP2-4			1.5				1		1							
FS 11+71	LT	R7-8			1.5													
FS 11+85	LT	NYP1-5 (MOD)								<u> </u>							<u> </u>	
FS 11+90 FS 11+90	RT	W11-2L				6.25 3.75		1		1							 	
FS 11+90 FS 12+03	RT LT	W16-7P D3-1			<u> </u>	3.75								-			1	
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FS 12+15	LT	W11-2L				6.25				4	1						<u> </u>	
FS 12+15	LT	W16-7P				3.75		- 1		- 1								
FS 12+56	RT	R1-1				6.3		1		1								
FS 12+64	LT	NYP1-5 (MOD)			1.5				1		- 1						<u> </u>	
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FS 12+73 FS 12+84	LT	D3-1 NYP1-5 (MOD)															+ '	
FS 12+91	RT	NYP1-5 (MOD)			1.5			<u> </u>									+	
FS 12+91	RT	NYP2-4			1.5				1		- 1						1	
FS 13+07	LT	NYP1-5 (MOD)																
FS 13+19	RT	NYP1-5 (MOD)																
FS 13+68	LT	NYP1-5 (MOD)															L	
FS 13+82 FS 13+82	LT	NYP1-5			1.5			L					1					
FS 13+82 FS 13+86	LT RT	NYP2-4 NYP2-4			1.5						1		1				+	
	171	INTE2-4			1.0						<u> </u>						+	
SUBT	OTAL		34.2	0	25.5	26.3	0	3	6	3	7	0	4	2	0	1	7	
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Permit-Seal

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By Appd. YY.MM.DD

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Revision ORIGINAL SHEET - ANSID HORIZ

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	SIGNING AND PAVEMENT TABLES								
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	Project No.	Scale							
	192500343	N.T.S.							
	Drawing No.	Sheet	Revision						
16.12.05 YY.MM.DD	SPT-4	59 of 127	0						

MAIN STREET STREETSCAI PEDESTRIAN WAYFINDIN P.I.N. 4755.91 D034908	G	-			
ROCHESTER, NEW YORK					Project No. 192500343
					Drawing No.
File Name: \$PT-04.DGN	RMW Dwn.	SWM Chkd.	KRS Dsgn.	16.12.05 YY.MM.DD	SPT-4

Client/Project CITY OF ROCHESTER


								REGUL	ATORY A	ND PARKI	NG SIGN	S								
TEM 645.030100	11	HIGH-VISIBILITY O	VERHEAD-MOUNTED	SIGN PANELS	6										SQUARE FOO	ЭТ				
TEM 645.5101		GROUND-MOUNTE	D SIGN PANELS WI	THOUT Z-BARS											SQUARE FOO	от				
TEM 645.5201		GROUND-MOUNTE	D SIGN PANELS WI	THOUT Z-BARS	HIGH VISIBILI	TY SHEETING									SQUARE FOO	от				
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TEM 645.81		TYPE A SIGN POS	т												EACH					
TEM 645.85		POLE MOUNTED S	GIGN SUPPORT SYS	TEM (BAND MC	UNTED)										EACH					
TEM 647.31			ANEL, SIGN PANEL	· ·	,	;)									EACH					
TEM 647.51			POSE SIGN PANEL,		•	,									EACH					
TEM 647.61			POSE SIGNS, GROU		`	,		ONS SIZE 1 (UN	DER 30 SE)						EACH					
TEM 680.8205			ASSEMBLY, TYPE E						521100 01)						EACH					
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ITE	M	MUTCD NUMBER	ITEM 645.03010011	ITEM 64	45.5101	ITEM 6	45.5201	ITEM 645.	050000MO	ITEM 6	645.81	ITEM 6	645.85	ITEM 680.8205	ITEM	647.31	ITEM	647.51	ITEM 6	647.61
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FUNDING	SHARE		MCDOT	MCDOT	COR	MCDOT	COR	MCDOT	COR	MCDOT	COR	MCDOT	COR	MCDOT	MCDOT	COR	MCDOT	COR	MCDOT	COR
STATION /	OFFSET										MAIN S	STREET								
FS 13+88	RT	NYP1-5 (MOD)																		1
FS 13+89	RT	NYP2-4																		
EA 11+19	LT	NYP1-5 (MOD)																		1
EA 11+23	LT	NYP1-5			1.5				1		1									
EA 11+23	LT	NYP1-5 (MOD)														1				
EA 11+63 EA 11+63	LT	NYP1-5 (MOD)			1.5				1		1					1				
EA 11+63 EA 11+86	LT	NYP1-5 (MOD)														<u> </u>				1
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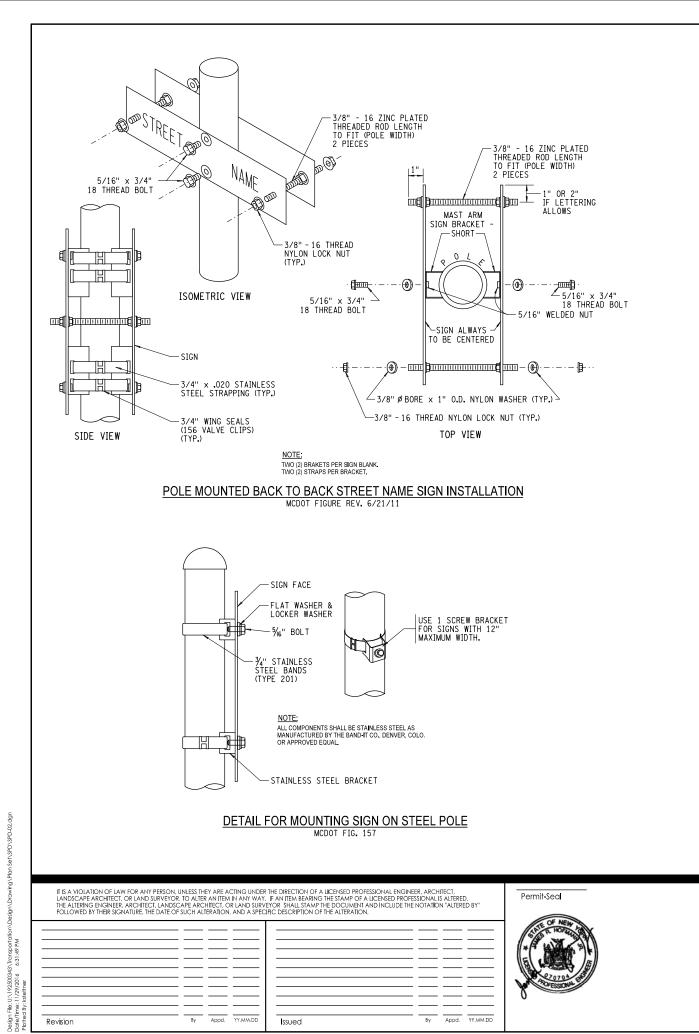
NOTES:

1. REFER TO NOTES ON TSP-11 REGARDING INSTALLATION OF OVERHEAD SIGNS

Md

ı∖Design\Drawing\Plar	IT IS A VIOLATION OF LAW FOR ANY PERSON, UNLESS THEY ARE ACTING UNDER THE DIRECTION OF A LICENSED PROFESSIONAL ENGINEER. ARCHITECT, LANDSCAPE ARCHITECT, OR LIAND SURVEYOR, TO ALTER AN ITEM IN ANY WAY, IF AN ITEM BEARING THE STAMP OF A LICENSED PROFESSIONAL IS ALTERED. THE ALTERING ENGINEER, ARCHITECT, LANDSCAPE ARCHITECT, OR LAND SURVEYOR SHALL STAMP THE DOCUMENT AND INCLUDE THE NOTATION "ALTERED BY" FOLLOWED BY THEIR SIGNATURE, THE DATE OF SUCH ALTERATION, AND A SPECIFIC DESCRIPTION OF THE ALTERATION.	Permit-Seal	Consultants	Stantec	Client/Project CITY OF ROCHESTER	Title SIGNING AND PAVEMENT TAB	sles
2500343\Transportation /2016 6:31:27 PM mer				61 Commercial S1, Suite 100 Rochester, NY 14614 www.stantec.com	MAIN STREET STREETSCAPE AND PEDESTRIAN WAYFINDING P.I.N. 4755.91 D034908 PC 15323 ROCHESTER, NEW YORK	Project No. Scale 192500343 N.T.S.	
Design File: U:\19 Date/Time: 11/25 Plotted By: kstett	Revision By Appd. YY,MM,DD Issued By Appd. YY,MM,DD	0		The Contractor shall verify and be responsible for all dimensions. DO NOT scale the drawing - any errors or omissions shall be reported to Stantec without delay. The Copyrights to all designs and drawings are the property of Stantec. Reproduction or use for any purpose other than that authorized by Stantec is forbidden.	File Name: SPI-05.DGN RMW SWM KRS 16.12.05 Dwn. Chikd. Dsgn. YY.MM.DD	Drawing No. Sheet SPT-5 60 of 127	Revision 0



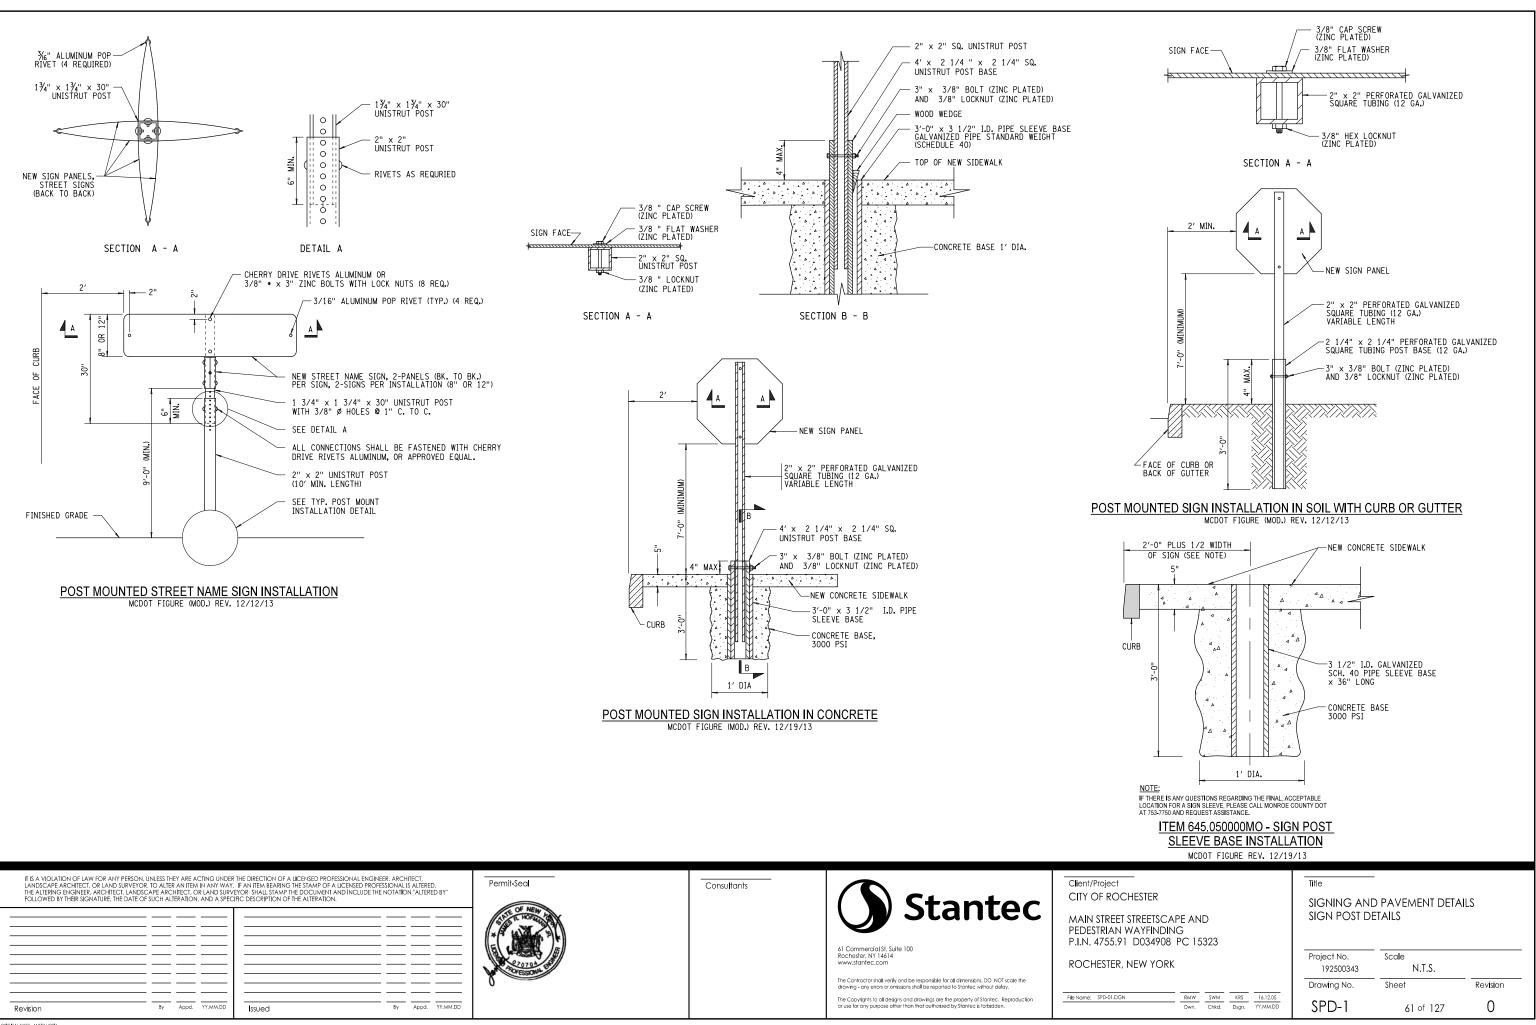


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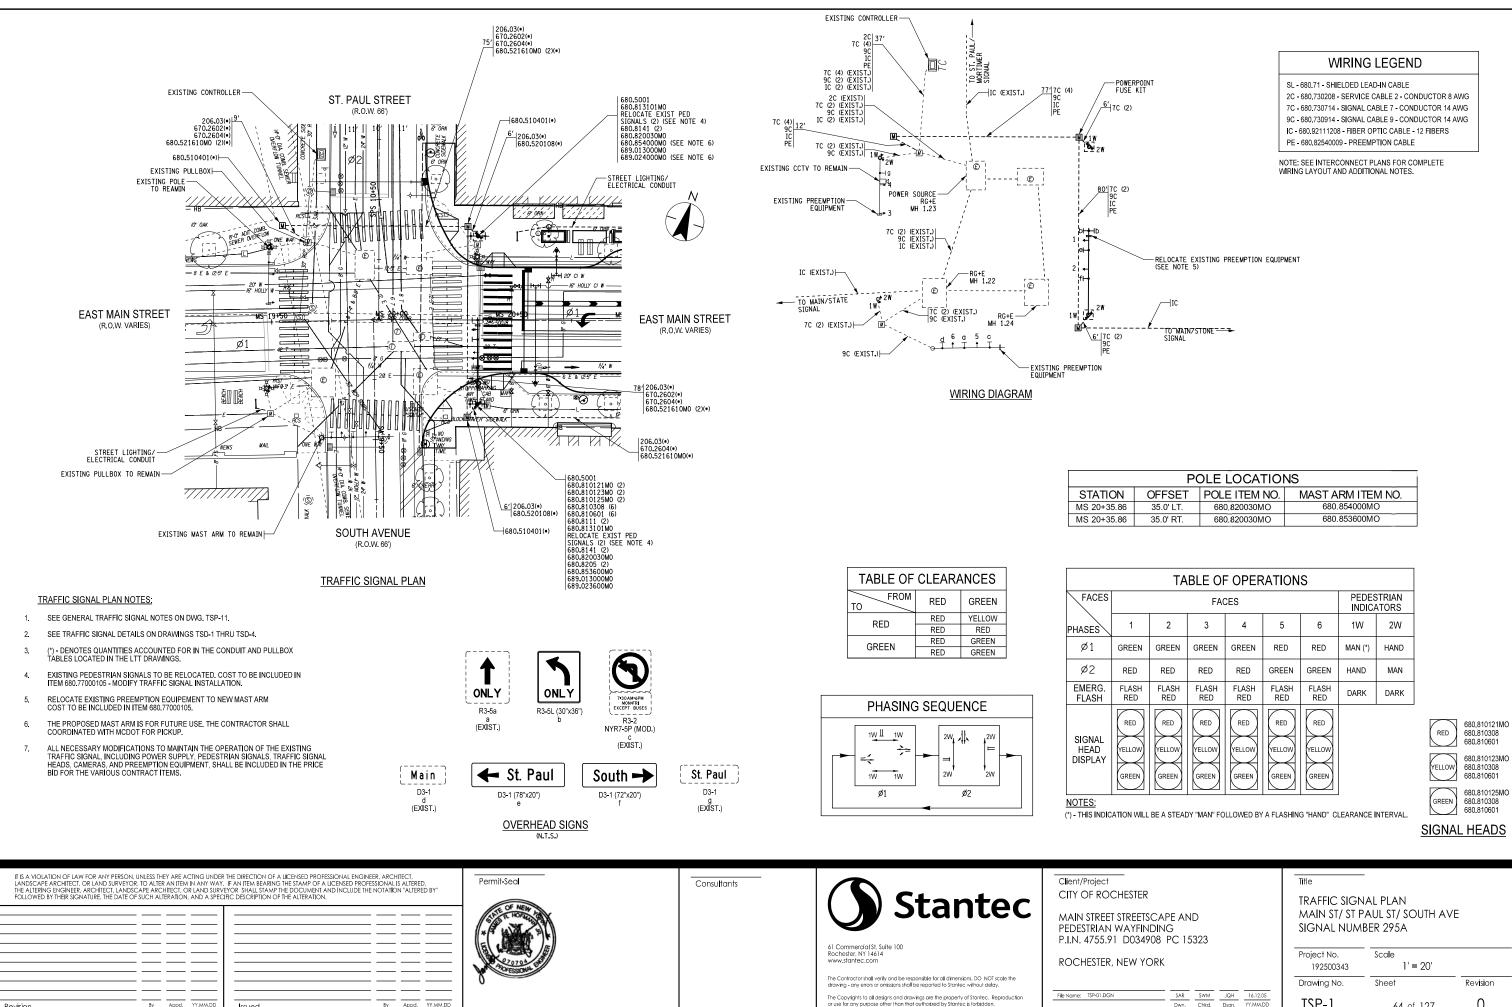
Consultants

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Client/Project	Title					
CITY OF ROCHESTER	SIGNING AND PAVEMENT DETAILS					
MAIN STREET STREETSCAPE AND PEDESTRIAN WAYFINDING P.I.N. 4755.91 D034908 PC 15323	SIGN POST DETAILS					
ROCHESTER, NEW YORK	Project No. 192500343	Scale N.T.S.				
	Drawing No.	Sheet	Revision			
File Name: SPD-02.DGN RNW SWM KRS 16.12.05 Dwn. Chkd. Dsgn. YY.MM.DD	SPD-2	62 of 127	0			





By Appd. YY.MM.DD

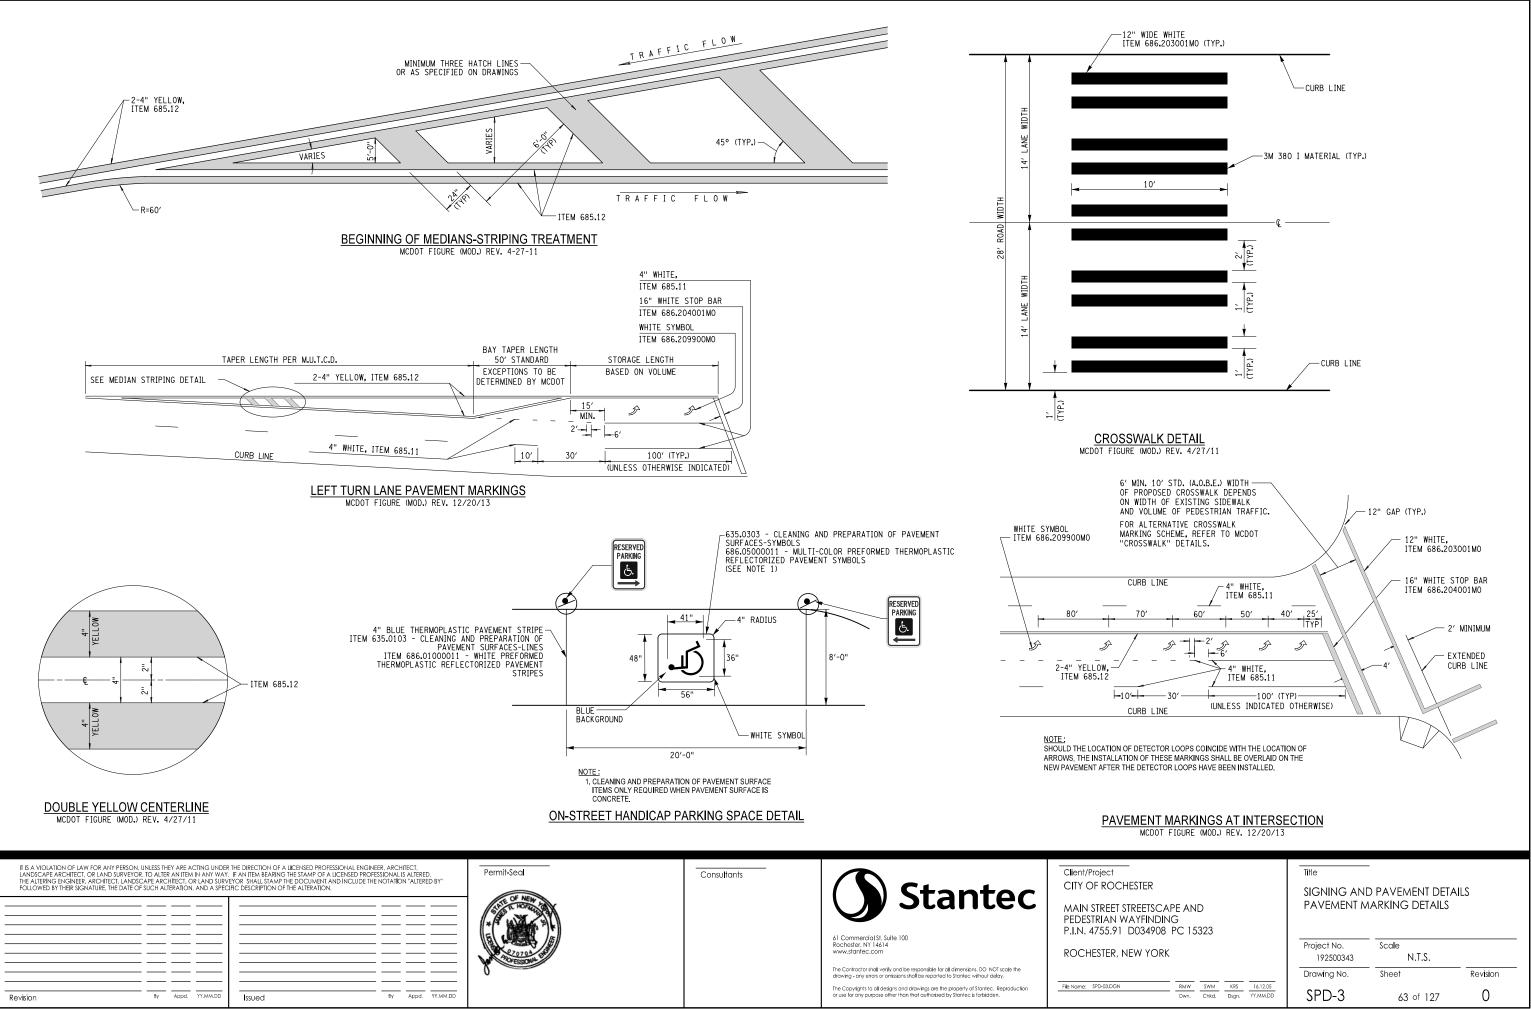Revision

ORIGINAL SHEET - ANSID HORI

By Appd. YY.MM.DD


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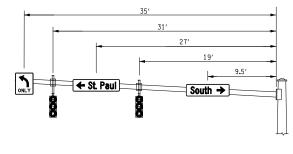
	POLE LOCATIONS								
DN	N OFFSET POLE ITEM NO. MAST ARM ITEM NO.								
5.86	35.0' LT.	680.820030MO	680.854000MO						
5.86	.86 35.0' RT. 680.820030MO 680.853600MO								

	TABLE OF OPERATIONS								
		TRIAN							
1	2	3	4	5	6	1W	2W		
GREEN	GREEN	GREEN	GREEN	RED	RED	MAN (*)	HAND		
RED	RED	RED	RED	GREEN	GREEN	HAND	MAN		
FLASH RED	FLASH RED	FLASH RED	FLASH RED	FLASH RED	FLASH RED	DARK	DARK		
RED YELLOW GREEN	RED YELLOW GREEN	RED YELLOW GREEN	RED YELLOW GREEN	RED YELLOW GREEN	RED YELLOW GREEN				

RED	680.8101 680.8103 680.8106
YELLOW	680.8101 680.8103 680.8106
GREEN	680.8101 680.8103

-	Title	-			
HESTER	TRAFFIC SIGN	IAL PLAN			
IREETSCAPE AND /AYFINDING D034908 PC 15323	MAIN ST/ ST PAUL ST/ SOUTH AVE SIGNAL NUMBER 295A				
IEW YORK	Project No. 192500343	Scale 1' = 20'			
	Drawing No.	Sheet	Revision		
SAR SWM JQH 16.12.05 Dwn. Chkd. Dsgn. YY.MM.DD	TSP-1	64 of 127	0		



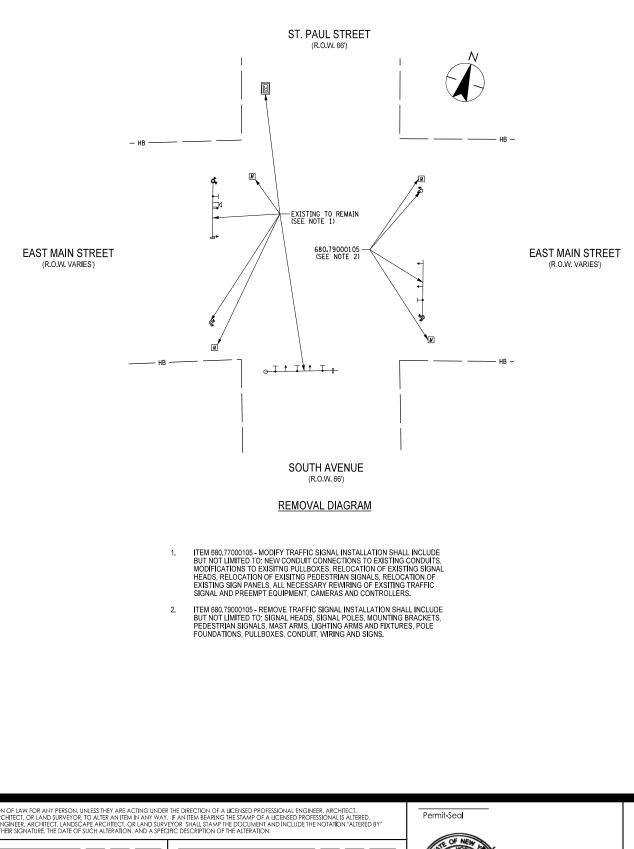



ITEM NO.	DESCRIPTION	UNIT	QUANTITY
206.03	CONDUIT EXCAVATION AND BACKFILL INCL. RESTORATION	LF	*
619.1613	MAINTAIN TRAFFIC SIGNAL EQUIPMENT (REQUIREMENT C)	INTM	9
680.5001	POLE EXCAVATION AND CONCRETE FOUNDATION	CY	10
680.510401	PULLBOX-CIRCULAR, 30 INCH DIAMETER, REINFORCED CONCRETE	EA	*
680.520106	CONDUIT, METAL STEEL, ZINC COATED, 2"	LF	*
680.520108	CONDUIT, METAL STEEL, ZINC COATED, 3"	LF	*
680.520110	CONDUIT, METAL STEEL, ZINC COATED, 4"	LF	*
680.521610MO	CONDUIT, PVC SCHEDULE 80, 4" DIAMETER	LF	*
680.730208	SIGNAL CABLE, 2 CONDUCTORS, 08 AWG	LF	160
680.730714	SIGNAL CABLE 7 CONDUCTORS, 14 AWG	LF	878
680.730914	SIGNAL CABLE 9 CONDUCTORS, 14 AWG	LF	309
680.77000105	MODIFY TRAFFIC SIGNAL EQUIPMENT	ELOC	1
680.79000105	REMOVE TRAFFIC SIGNAL EQUIPMENT	ELOC	1
680.810121MO	LED TRAFFIC SIGNAL MODULE - 12" DIA., RED BALL	EA	2
680.810123MO	LED TRAFFIC SIGNAL MODULE - 12" DIA., YELLOW BALL	EA	2
680.810125MO	LED TRAFFIC SIGNAL MODULE - 12" DIA., GREEN BALL	EA	2
680.810308	INSTALL BALL/ ARROW LED TRAFFIC SIGNAL MODULE	EA	6
680.810601	TRAFFIC SIGNAL SECTION - POLYCARBONATE, TYPE I, 12 INCH	EA	6
680.8111	TRAFFIC SIGNAL BRACKET ASSEMBLY - 1 WAY	EA	2
680.813101MO	AUDIBLE/TACTILE PEDESTRIAN SIGNAL DEVICE	EA	2
680.8141	PEDESTRIAN SIGNAL BRACKET MOUNT ASSEMBLY	EA	4
680.820030MO	TRAFFIC SIGNAL POLE MAST ARM COMBINATION ANCHOR BASE (30')	EA	2
680.8205	OVERHEAD SIGN ASSEMBLY, TYPE E	EA	2
680.82540009	PREEMPT SYSTEM - DETECTOR CABLE - SHIELDED,3 CONDUCTOR WITH STRANDED GROUND. AWG #20	LF	308
680.853600MO	TRAFFIC SIGNAL MAST ARM, 36 FEET ARM LENGTH	EA	1
680.854000MO	TRAFFIC SIGNAL MAST ARM, 40 FEET ARM LENGTH	EA	1
680.92111208	FIBER OPTIC CABLE - 12 FIBERS	LF	**
689.013000MO	POWDER COAT 30' TRAFFIC SIGNAL POLE	EA	2
689.023600MO	POWDER COATING 36' TRAFFIC SIGNAL MAST ARM	EA	1
689.024000MO	POWDER COATING 40' TRAFFIC SIGNAL MAST ARM	EA	1

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			61 Commercial SI. Suite 100 Rochester, NY 14614 www.stanlec.com	MAIN STREET STREETSC/ PEDESTRIAN WAYFINDI P.I.N. 4755.91 D034908 ROCHESTER, NEW YOR
	State of the second sec		The Contractor shall verify and be responsible for all dimensions, DO NOT scale the drawing - any errors or omissions shall be reported to Stantec without delay.	
Revision By Appd. TY.MM.DD Issued By Appd. TY.MM.DD			The Copyrights to all designs and drawings are the property of Stantec. Reproduction or use for any purpose other than that authorized by Stantec is forbidden.	File Name: TSP-02.DGN

SOUTH-MAIN E MAST ARM (36') NOT TO SCALE

	Title	-	
CAPE AND ING 8 PC 15323	traffic sign main st/ st. signal num	PAUL ST/ SOUTH A	VЕ
RK	Project No. 192500343	Scale 1' = 20'	
	Drawing No.	Sheet	Revision
SAR SWM JQH 16.12.05 Dwn. Chkd. Dsgn. YY.MM.DD	TSP-2	65 of 127	0

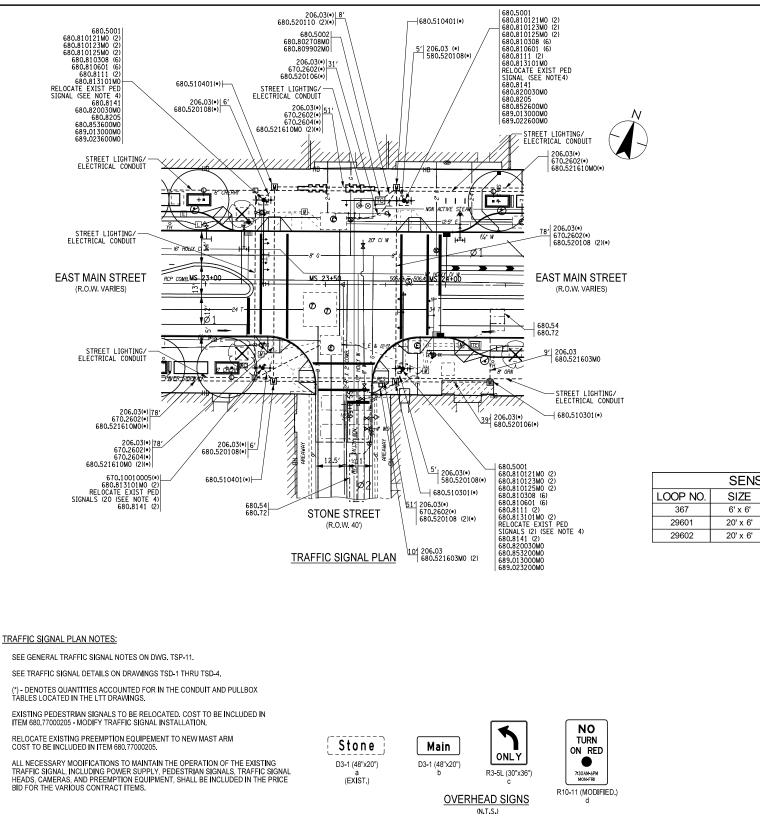

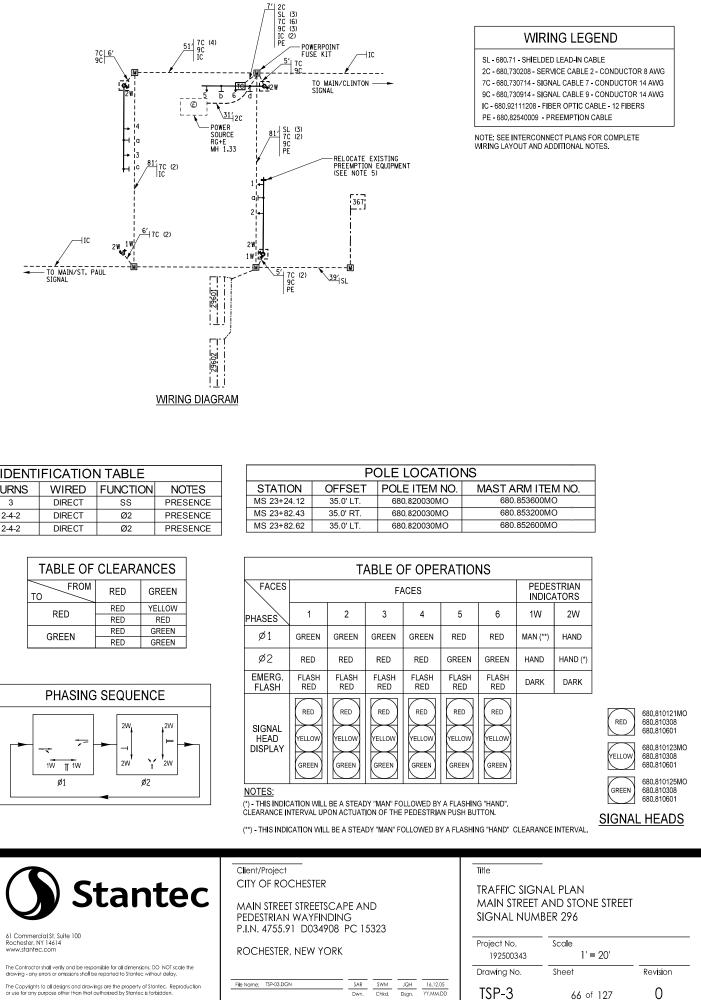

		SENSOR IDENTIFICATION TABLE							
STA		NOTES	FUNCTION	WIRED	TURNS	SIZE	LOOP NO.		
MS 23		PRESENCE	SS	DIRECT	3	6' x 6'	367		
MS 23		PRESENCE	Ø2	DIRECT	2-4-2	20' x 6'	29601		
MS 23	l	PRESENCE	Ø2	DIRECT	2-4-2	20' x 6'	29602		

TABLE OF	TABLE OF CLEARANCES							
FROM TO	RED	GREEN						
RED	RED	YELLOW						
RED	RED	RED						
GREEN	RED	GREEN						
GREEN	RED	GREEN						

FACES
PHASES
Ø1
Ø2
EMERC




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ORIGINAL SHEET - ANSID HORI

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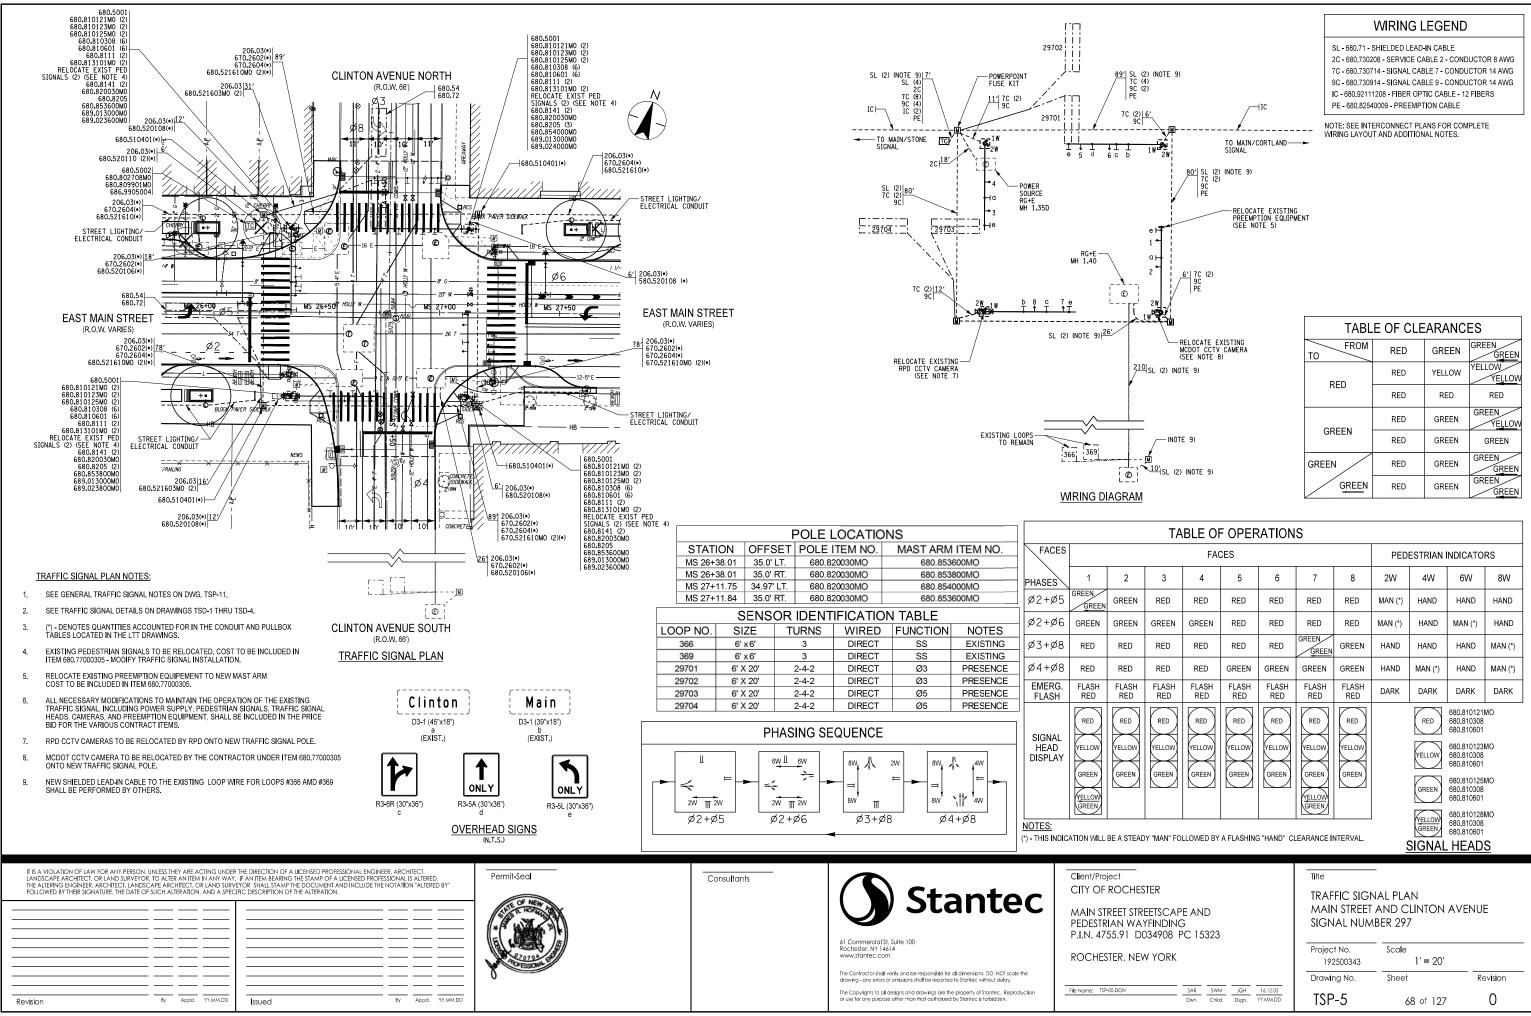
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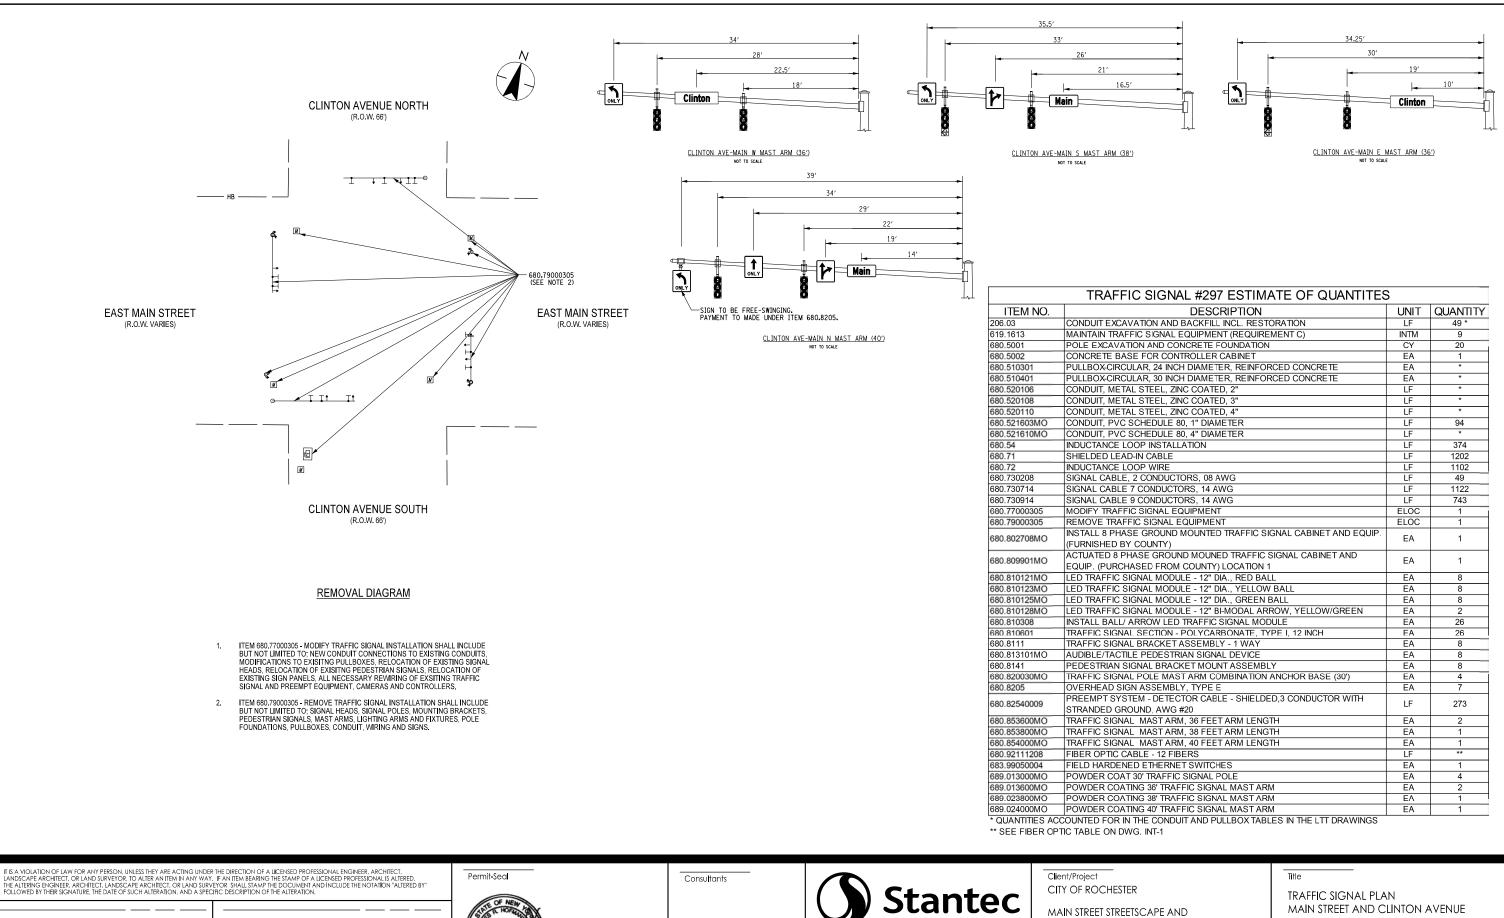
N19250034 Date/T Date/T

FIC SIGNAL EQUIPMENT (REQUIREMENT C)INTM9ON AND CONCRETE FOUNDATIONCY15E FOR CONTROLLER CABINETEA1LAR, 24 INCH DIAMETER, REINFORCED CONCRETEEA*LAR, 30 INCH DIAMETER, REINFORCED CONCRETEEA*LAR, 30 INCH DIAMETER, REINFORCED CONCRETEEA*L STEEL, ZINC COATED, 2"LF*L STEEL, ZINC COATED, 4"LF*STEEL, ZINC COATED, 4"LF*CHEDULE 80, 1" DIAMETERLF30CHEDULE 80, 4" DIAMETERLF368OP INSTALLATIONLF213-IN CABLELF368OP WIRELF642 CONDUCTORS, 08 AWGLF647 CONDUCTORS, 14 AWGLF7970 CONDUCTORS, 14 AWGLF4132 SIGNAL EQUIPMENTELOC1C SIGNAL EQUIPMENTELOC1C SIGNAL EQUIPMENTELOC1C SIGNAL EQUIPMENTELOC1C SIGNAL EQUIPMENTEA1ASE GROUND MOUNED TRAFFIC SIGNAL CABINET AND EQUIP. COUNTY)EA1ASE GROUND MOUNED TRAFFIC SIGNAL CABINET ANDEA1SNAL MODULE - 12" DIA., RED BALLEA6SNAL MODULE - 12" DIA., GREEN BALLEA6SNAL MODULE - 12"	C SIGNAL #296 ESTIMATE OF QUANTITES						
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LAR, 24 INCH DIAMETER, REINFORCED CONCRETEEALAR, 30 INCH DIAMETER, REINFORCED CONCRETEEAL STEEL, ZINC COATED, 2"LFL STEEL, ZINC COATED, 4"LFSTEEL, ZINC COATED, 4"LFSCHEDULE 80, 4" DIAMETERLFSCHEDULE 80, 4" DIAMETERLFOP INSTALLATIONLFPIN STALLATIONLFSTODUCTORS, 08 AWGLFCONDUCTORS, 14 AWGLFCONDUCTORS, 14 AWGLFCONDUCTORS, 14 AWGLFCOUNDUTORS, 14 AWGLFCOUNTY)ELOCASE GROUND MOUNED TRAFFIC SIGNAL CABINET AND EQUIP. COUNTY)EAASE OROUND MOUNED TRAFFIC SIGNAL CABINET AND ASE GROUND MOUNED TRAFFIC SIGNAL CABINET AND SASE GROUND MOUNED TRAFFIC SIGNAL CABINET AND ASE GROUND MOUNED TRAFFIC SIGNAL CABINET AND ASE GROUND MOULE - 12" DIA., RED BALLFRAASNAL MODULE - 12" DIA., GREEN BALLEAASE GROUND MOULE TRAFFIC SIGNAL MODULEEASASEMBLY - 1 WAYEASECTION - POLYCARBONATE, TYPE I, 12 INCHEASECTION - POLYCARBONATE, TYPE I, 12 INCHEASERACKET MOUNT ASSEMBLYEASASE MBLY, TYPE EEASEACKET MOUNT ASSEMBLYEASASE MBLY, TYPE EEASASE MBLY, TYPE EEASASE ARM, 26 FET ARM LENGTHEAIMAST ARM, 36 FEET ARM LE	E FOR CONTROLLER CABINET	EA	1				
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ASE GROUND MOUNED TRAFFIC SIGNAL CABINET AND SED FROM COUNTY) LOCATION 2EA1SNAL MODULE - 12" DIA., RED BALLEA6SNAL MODULE - 12" DIA., RED BALLEA6SNAL MODULE - 12" DIA., GREEN BALLEA6RROW LED TRAFFIC SIGNAL MODULEEA6RROW LED TRAFFIC SIGNAL MODULEEA18. SECTION - POLYCARBONATE, TYPE I, 12 INCHEA6BRACKET ASSEMBLY - 1 WAYEA6SPAL BRACKET MOUNT ASSEMBLYEA6SNAL BRACKET MOUNT ASSEMBLYEA6ONAL BRACKET MOUNT ASSEMBLYEA6INAL BRACKET MOUNT ASSEMBLYEA1IND, AWG #20IF170IND, AWG #20IF170INAST ARM, 26 FEET ARM LENGTHEA1IMAST ARM, 36 FEET ARM LENGTHEA1IMAST ARM, 36 FEET ARM LENGTHEA1INAST ARM, 36 FEET ARM LENGTHEA1INAST ARM, 36 FEET ARM LENGTHEA1ING 30' TRAFFIC SIGNAL POLEEA3NG 32' TRAFFIC SIGNAL POLEEA1NG 32' TRAFFIC SIGNAL MAST ARMEA1	E GROUND MOUNTED TRAFFIC SIGNAL CABINET AND EQUIP.	EA	1				
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SNAL MODULE - 12" DIA., GREEN BALL EA 6 RROW LED TRAFFIC SIGNAL MODULE EA 18 SECTION - POLYCARBONATE, TYPE I, 12 INCH EA 18 BRACKET ASSEMBLY - 1 WAY EA 6 DEPEDESTRIAN SIGNAL DEVICE EA 6 SNAL BRACKET MOUNT ASSEMBLY EA 6 ONLE MAST ARM COMBINATION ANCHOR BASE (30') EA 6 POLE MAST ARM COMBINATION ANCHOR BASE (30') EA 3 N ASSEMBLY, TYPE E EA 2 EM - DETECTOR CABLE - SHIELDED,3 CONDUCTOR WITH UND, AWG #20 LF 170 MAST ARM, 26 FEET ARM LENGTH EA 1 MAST ARM, 32 FEET ARM LENGTH EA 1 MAST ARM, 36 FEET ARM LENGTH EA 1 MAST ARM, 37 FEET ARM LENGTH EA 1 MAST ARM, 36 FEET ARM LENGTH EA 1 MAST ARM, 37 FEET ARM LENGTH EA 1 MAST ARM, 37 FEET ARM LENGTH EA 1			-				
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EM - DETECTOR CABLE - SHIELDED,3 CONDUCTOR WITH UND, AWG #20LF170100, AWG #20EA1101, AWG #20EA1102, AWG #20EA1103, AWG #20EA1104, AWG #20EA1105, AWG #20EA1104, AWG #20EA1105, AWG #20EA1105, AWG #20EA3105, AWG #20EA3105, AWG #20EA1105, AWG #20EA1105, AWG #20EA1105, AWG #20EA1			-				
UND, AWG #20 LF 1/0 . MAST ARM, 26 FEET ARM LENGTH EA 1 . MAST ARM, 32 FEET ARM LENGTH EA 1 . MAST ARM, 36 FEET ARM LENGTH EA 1 . MAST ARM, 36 FEET ARM LENGTH EA 1 . MAST ARM, 36 FEET ARM LENGTH EA 1 . MAST ARM, 36 FEET ARM LENGTH EA 1 . MAST ARM, 36 FEET ARM LENGTH EA 1 . MAST ARM, 36 FEET ARM LENGTH EA 1 . MAST ARM, 36 FEET ARM LENGTH EA 3 . MAST ARM, 36 FEET ARM LENGTH EA 1 . MAST ARM, 36 FEET ARM LENGTH EA 3 . MAST ARM EA 1		EA	2				
UND, AWG #20 EA . MAST ARM, 26 FEET ARM LENGTH EA . MAST ARM, 32 FEET ARM LENGTH EA . MAST ARM, 36 FEET ARM LENGTH EA . MAST ARM EA		IF	170				
MAST ARM, 32 FEET ARM LENGTH EA 1 . MAST ARM, 36 FEET ARM LENGTH EA 1 BLE - 12 FIBERS LF ** 30' TRAFFIC SIGNAL POLE EA 3 NG 26' TRAFFIC TRAFFIC SIGNAL POLE EA 1 NG 32' TRAFFIC SIGNAL MAST ARM EA 1	DUND, AWG #20		110				
MAST ARM, 32 FEET ARM LENGTH EA 1 . MAST ARM, 36 FEET ARM LENGTH EA 1 BLE - 12 FIBERS LF ** 30' TRAFFIC SIGNAL POLE EA 3 NG 26' TRAFFIC TRAFFIC SIGNAL POLE EA 1 NG 32' TRAFFIC SIGNAL MAST ARM EA 1	_ MAST ARM, 26 FEET ARM LENGTH		1				
BLE - 12 FIBERS LF ** 30' TRAFFIC SIGNAL POLE EA 3 NG 26' TRAFFIC TRAFFIC SIGNAL POLE EA 1 NG 32' TRAFFIC SIGNAL MAST ARM EA 1	_ MAST ARM, 32 FEET ARM LENGTH						
BLE - 12 FIBERS LF ** 30' TRAFFIC SIGNAL POLE EA 3 NG 26' TRAFFIC TRAFFIC SIGNAL POLE EA 1 NG 32' TRAFFIC SIGNAL MAST ARM EA 1	_ MAST ARM, 36 FEET ARM LENGTH						
NG 26' TRAFFIC TRAFFIC SIGNAL POLE EA 1 NG 32' TRAFFIC SIGNAL MAST ARM EA 1	BLE - 12 FIBERS	LF	**				
NG 32' TRAFFIC SIGNAL MAST ARM EA 1	30' TRAFFIC SIGNAL POLE	EA	3				
	NG 26' TRAFFIC TRAFFIC SIGNAL POLE	EA	1				
NG 36' TRAFFIC SIGNAL MAST ARM EA 1	NG 32' TRAFFIC SIGNAL MAST ARM	EA	1				
	NG 36' TRAFFIC SIGNAL MAST ARM	EA	1				

SCAPE AND NDING 908 PC 15323	Title TRAFFIC SIGN. MAIN STREET A SIGNAL NUME	and stone street	
ORK	Project No. 192500343 Drawing No.	Scale 1' = 20'	Revision
SAR SWM JQH 16.12.05 Dwn. Chkd. Dsgn. YY.MM.DD	TSP-4	67 of 127	

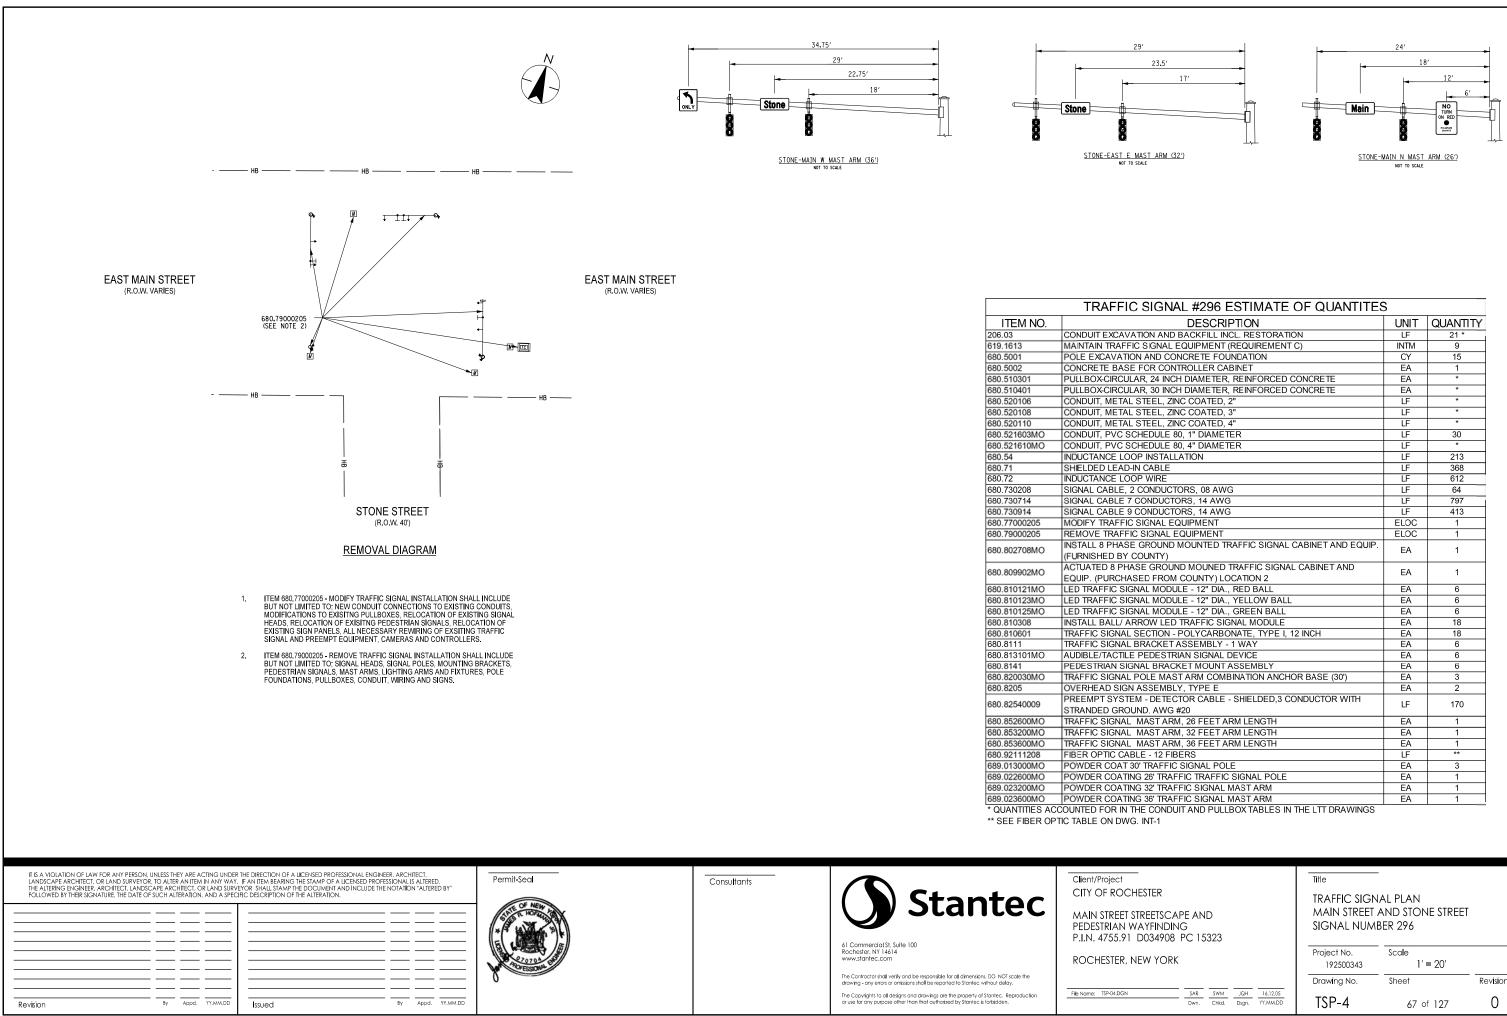

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Drawing No.	Sheet	Revision
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Design Date/T

Revision ORIGINAL SHEET - ANSID HORIZ By Appd. YY.MM.DD

Issued

By Appd. YY.MM.DD

AFFIC SIGNAL #297 ESTIMATE OF QUANTITES					
DESCRIPTION	UNIT	QUANTITY			
EXCAVATION AND BACKFILL INCL. RESTORATION	LF	49 *			
TRAFFIC SIGNAL EQUIPMENT (REQUIREMENT C)	INTM	9			
CAVATION AND CONCRETE FOUNDATION	CY	20			
TE BASE FOR CONTROLLER CABINET	EA	1			
CIRCULAR, 24 INCH DIAMETER, REINFORCED CONCRETE	EA	*			
CIRCULAR, 30 INCH DIAMETER, REINFORCED CONCRETE	EA	*			
, METAL STEEL, ZINC COATED, 2"	LF	*			
, METAL STEEL, ZINC COATED, 3"	LF	*			
, METAL STEEL, ZINC COATED, 4"	LF	*			
, PVC SCHEDULE 80, 1" DIAMETER	LF	94			
, PVC SCHEDULE 80, 4" DIAMETER	LF	*			
NCE LOOP INSTALLATION	LF	374			
D LEAD-IN CABLE	LF	1202			
NCE LOOP WIRE	LF	1102			
CABLE, 2 CONDUCTORS, 08 AWG	LF	49			
CABLE 7 CONDUCTORS, 14 AWG	LF	1122			
CABLE 9 CONDUCTORS, 14 AWG	LF	743			
TRAFFIC SIGNAL EQUIPMENT	ELOC	1			
TRAFFIC SIGNAL EQUIPMENT	ELOC	1			
8 PHASE GROUND MOUNTED TRAFFIC SIGNAL CABINET AND EQUIP. IED BY COUNTY)	EA	1			
D 8 PHASE GROUND MOUNED TRAFFIC SIGNAL CABINET AND PURCHASED FROM COUNTY) LOCATION 1	EA	1			
FIC SIGNAL MODULE - 12" DIA., RED BALL	EA	8			
FFIC SIGNAL MODULE - 12" DIA., KED BALL	EA	8			
FIC SIGNAL MODULE - 12" DIA., TELLOW BALL	EA	8			
FIC SIGNAL MODULE - 12" DIA., GREEN BALL FFIC SIGNAL MODULE - 12" BI-MODAL ARROW, YELLOW/GREEN	EA	2			
BALL/ ARROW LED TRAFFIC SIGNAL MODULE	EA	2			
SIGNAL SECTION - POLYCARBONATE, TYPE I, 12 INCH	EA	20			
SIGNAL BRACKET ASSEMBLY - 1 WAY	EA	8			
TACTILE PEDESTRIAN SIGNAL DEVICE	EA	8			
RIAN SIGNAL BRACKET MOUNT ASSEMBLY	EA	8			
SIGNAL POLE MAST ARM COMBINATION ANCHOR BASE (30')	EA	4			
AD SIGN ASSEMBLY, TYPE E	EA	7			
T SYSTEM - DETECTOR CABLE - SHIELDED,3 CONDUCTOR WITH ED GROUND, AWG #20	LF	273			
SIGNAL MAST ARM, 36 FEET ARM LENGTH	EA	2			
SIGNAL MASTARM, 30 FEETARM LENGTH	EA	1			
SIGNAL MAST ARM, 38 FEET ARM LENGTH	EA	1			
PTIC CABLE - 12 FIBERS	LF	**			
RDENED ETHERNET SWITCHES	EA	1			
RDENED ETHERNET SWITCHES R COAT 30' TRAFFIC SIGNAL POLE	EA	4			
COAT 30' TRAFFIC SIGNAL POLE		4			
COATING 36' TRAFFIC SIGNAL MAST ARM	EA EA	2			
COATING 40' TRAFFIC SIGNAL MAST ARM	EA	1			
FOR IN THE CONDULT AND PULLBOX TABLES IN THE LTT DRAWINGS					

PEDESTRIAN WAYFINDING P.I.N. 4755.91 D034908 PC 15323


SAR SWM JQH 16.12.05 Dwn, Chkd, Dsgn, YY.MM.DD

ROCHESTER, NEW YORK

File Name: TSP-06.DGN


SIGNAL NUMBER 297

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_									
	POLE LOCATIONS								
	STATION	STATION OFFSET POLE ITEM NO. MAST ARM ITEM N							
	MS 28+98.71	35.0' LT.	680.820030MO	680.853600MO					
Е	MS 29+65.46	34.98' LT.	680.820030MO	680.852600MO					
Е	MS 29+76.96	34.50' RT.	680.820030MO	680.853000MO					

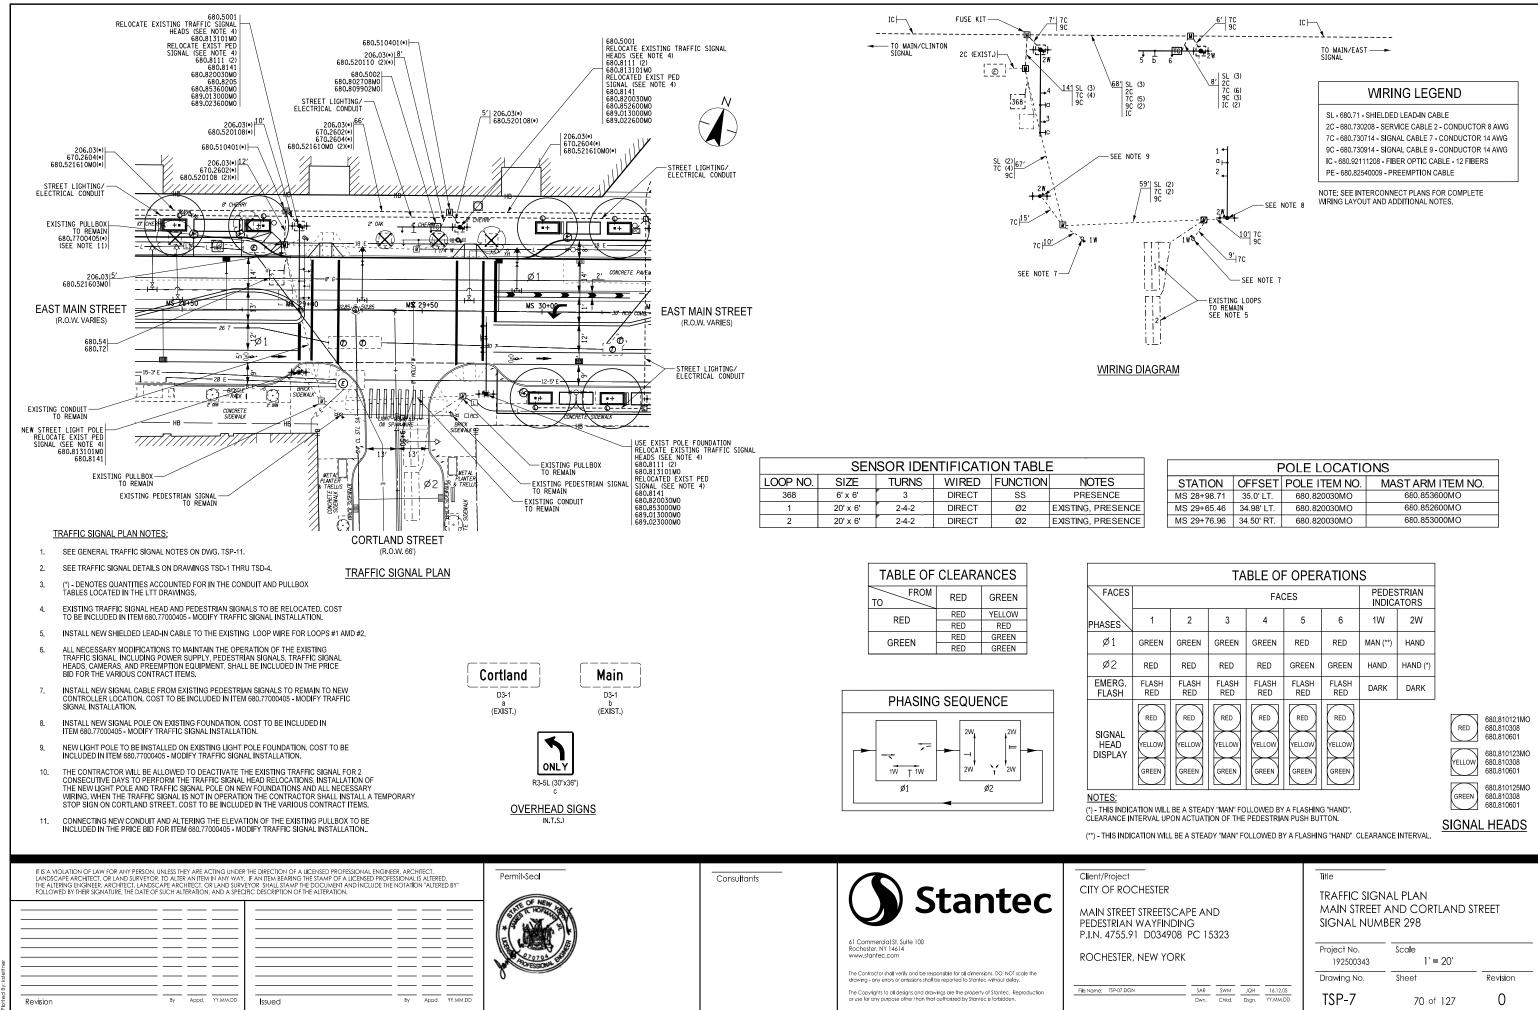TABLE OF OPERATIONS									
			FAG	CES			STRIAN ATORS		
1	2	3	4	5	6	1W	2W		
GREEN	GREEN	GREEN	GREEN	RED	RED	MAN (**)	HAND		
RED	RED	RED	RED	GREEN	GREEN	HAND	HAND (*)		
FLASH RED	FLASH RED	FLASH RED	FLASH RED	FLASH RED	FLASH RED	DARK	DARK		
NTERVAL UF	RED RED								
Title TRAFFIC SIGNAL PLAN TSTREETSCAPE AND WAYFINDING TO D034908 PC 15323									
, NEW Y	ORK				Project No. 1925003		Scale 1' =	= 20'	
N	SAR		JQH 16.12.0	- 1	Draw i ng Ne	э	Sheet		Revision
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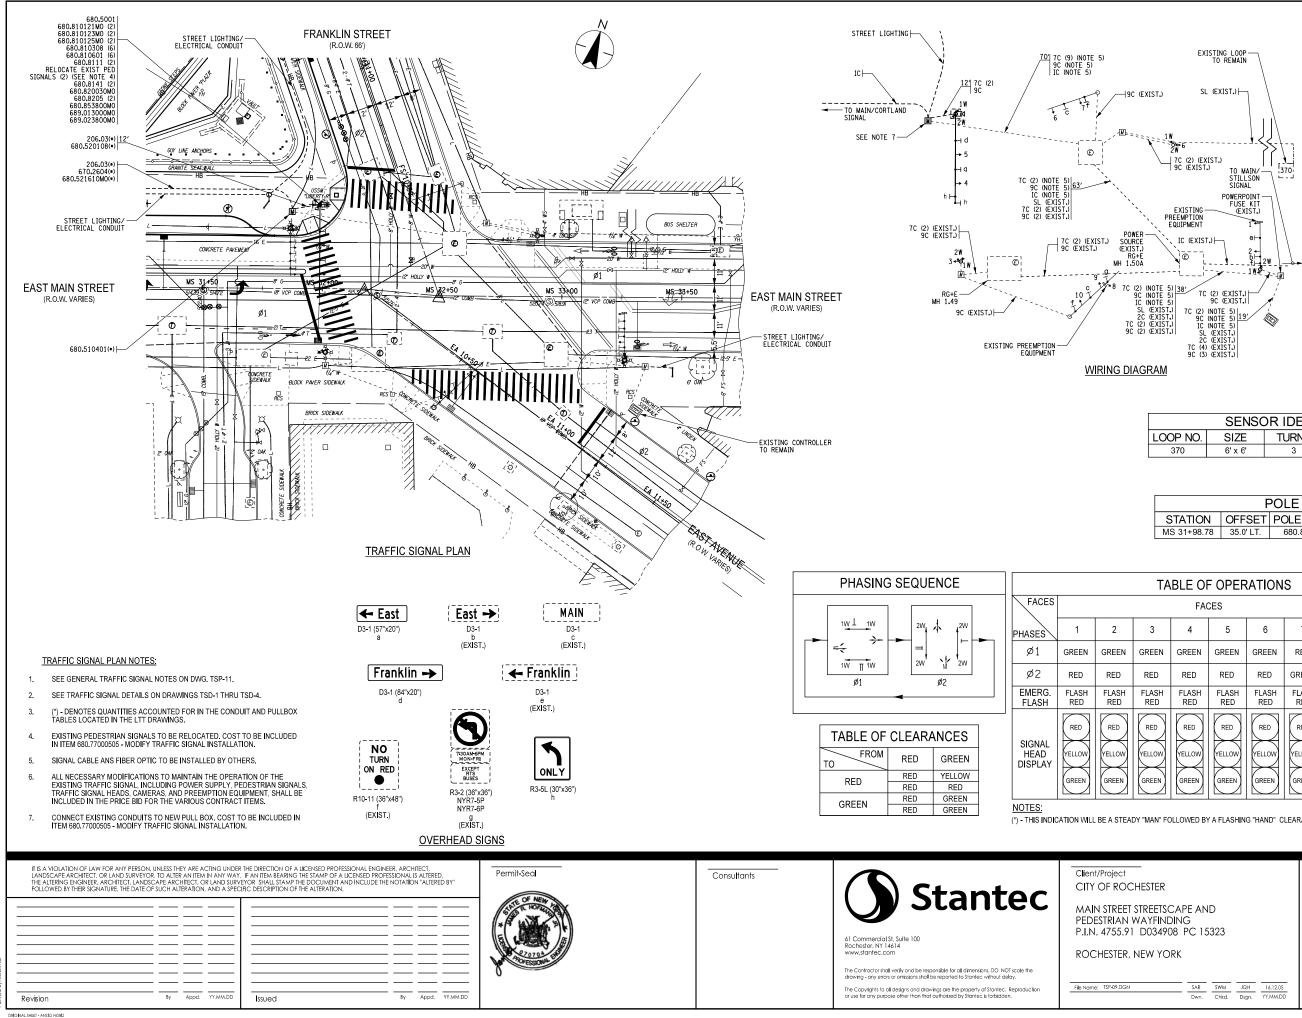


N19250034

Design Date/T

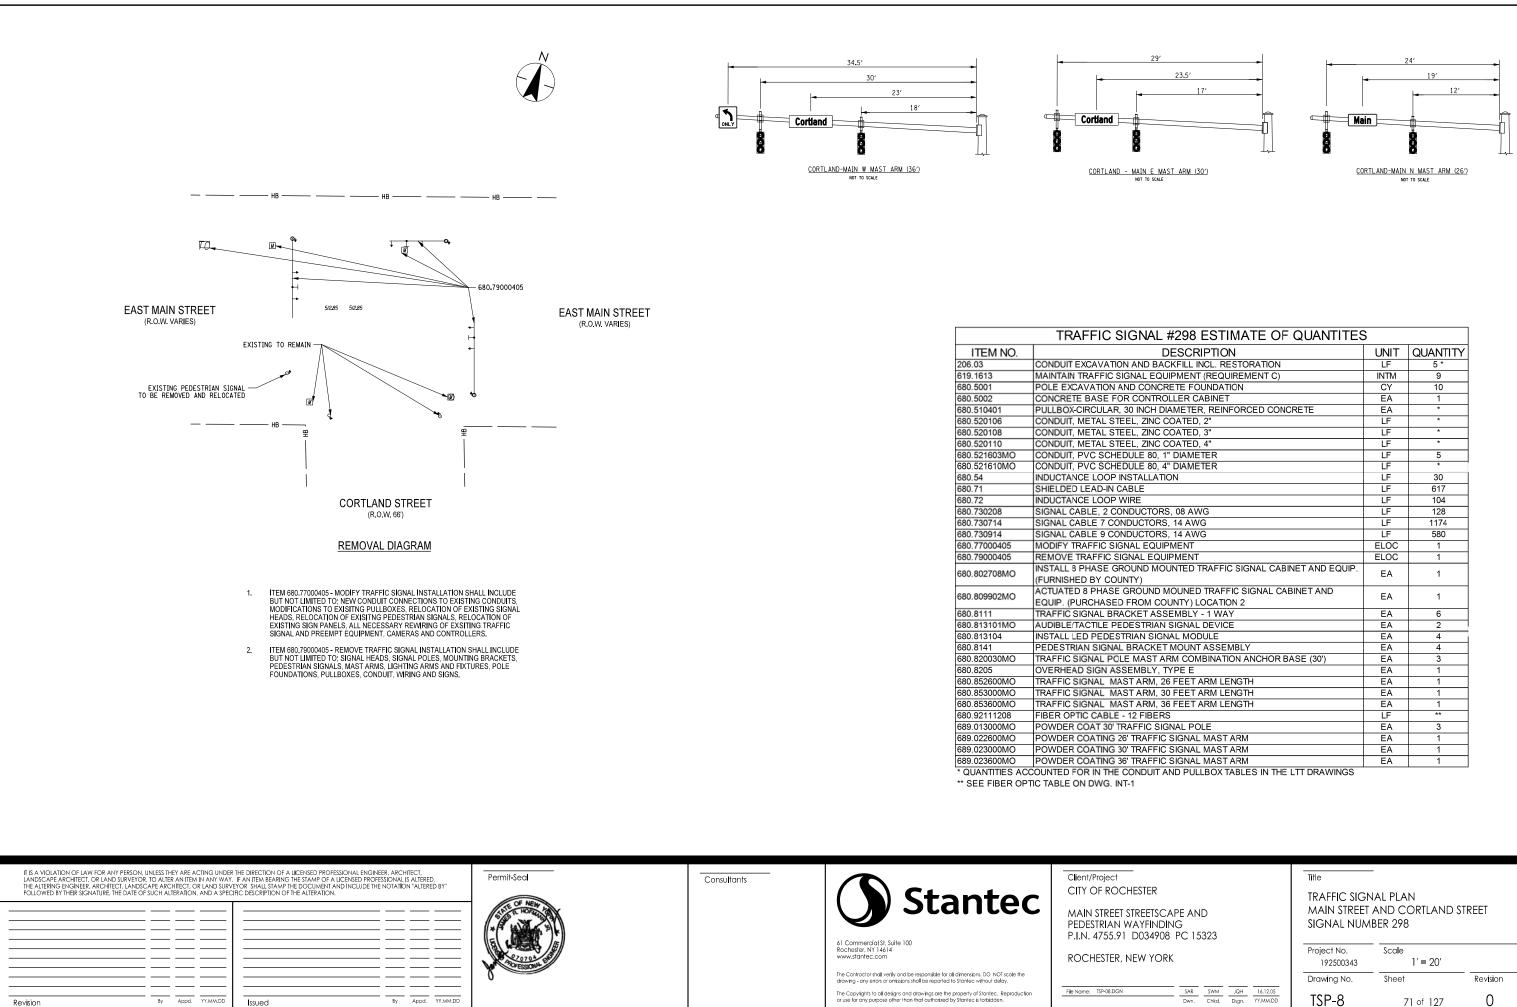IGNAL #298 ESTIMATE OF QUANTITES							
DESCRIPTION	UNIT	QUANTITY					
N AND BACKFILL INCL. RESTORATION	LF	5 *					
GNAL EQUIPMENT (REQUIREMENT C)	INTM	9					
ND CONCRETE FOUNDATION	CY	10					
R CONTROLLER CABINET	EA	1					
30 INCH DIAMETER, REINFORCED CONCRETE	EA	*					
EL, ZINC COATED, 2"	LF	*					
EL, ZINC COATED, 3"	LF	*					
EL, ZINC COATED, 4"	LF	*					
DULE 80, 1" DIAMETER	LF	5					
DULE 80, 4" DIAMETER	LF	*					
ISTALLATION	LF	30					
ABLE	LF	617					
VIRE	LF	104					
NDUCTORS, 08 AWG	LF	128					
IDUCTORS, 14 AWG	LF	1174					
IDUCTORS, 14 AWG	LF	580					
NAL EQUIPMENT	ELOC	1					
GNAL EQUIPMENT	ELOC	1					
OUND MOUNTED TRAFFIC SIGNAL CABINET AND EQUIP.	EA	1					
NTY)	EA						
GROUND MOUNED TRAFFIC SIGNAL CABINET AND	EA	1					
FROM COUNTY) LOCATION 2	EA						
CKET ASSEMBLY - 1 WAY	EA	6					
DESTRIAN SIGNAL DEVICE	EA	2					
RIAN SIGNAL MODULE	EA	4					
BRACKET MOUNT ASSEMBLY	EA	4					
E MAST ARM COMBINATION ANCHOR BASE (30')	EA	3					
SEMBLY, TYPE E	EA	1					
ST ARM, 26 FEET ARM LENGTH	EA	1					
ST ARM, 30 FEET ARM LENGTH	EA	1					
ST ARM, 36 FEET ARM LENGTH	EA	1					
- 12 FIBERS	LF	**					
RAFFIC SIGNAL POLE	EA	3					
6' TRAFFIC SIGNAL MAST ARM	EA	1					
D' TRAFFIC SIGNAL MAST ARM	EA	1					
6' TRAFFIC SIGNAL MAST ARM	EA	1					
CONDUIT AND DUILI BOY TABLES IN THE LTT DRAWINGS		•					

-	Title	-		
HESTER	TRAFFIC SIGN	IAL PLAN		
STREETSCAPE AND WAYFINDING D034908 PC 15323	MAIN STREET AND CORTLAND STREET SIGNAL NUMBER 298			
NEW YORK	Project No. 192500343	Scale 1' = 20'		
	Drawing No.	Sheet	Revision	
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WIRING LEGEND

- SL 680.71 SHIELDED LEAD-IN CABLE
- 2C 680.730208 SERVICE CABLE 2 CONDUCTOR 8 AWG 7C - 680.730714 - SIGNAL CABLE 7 - CONDUCTOR 14 AWG 9C - 680.730914 - SIGNAL CABLE 9 - CONDUCTOR 14 AWG
- IC 680.92111208 FIBER OPTIC CABLE 12 FIBERS PE - 680.82540009 - PREEMPTION CABLE


NOTE: SEE INTERCONNECT PLANS FOR COMPLETE WIRING LAYOUT AND ADDITIONAL NOTES.

SENSOR IDENTIFICATION TABLE						
LOOP NO. SIZE TURNS WIRED FUNCTION NOTES					NOTES	
370	6' x 6'	3	DIRECT	SS	EXISTING	

POLE LOCATIONS					
STATION OFFSET POLE ITEM NO.			MAST ARM ITEM NO.		
MS 31+98.78	35.0' LT.	680.820030MO	680.853800MO		

	TABLE OF OPERATIONS										
	FACES									STRIAN ATORS	
	3	4	5	6	7	8	9	10	1W	2W	
	GREEN	GREEN	GREEN	GREEN	RED	RED	RED	RED	MAN (*)	HAND	
	RED	RED	RED	RED	GREEN	RED	GREEN	GREEN	HAND	MAN	
	FLASH RED	FLASH RED	FLASH RED	FLASH RED	FLASH RED	FLASH RED	FLASH RED	FLASH RED	DARK	DARK	
RED YELLOW RED GREEN RE											
	DY "MAN" FOLLOWED BY A FLASHING "HAND" CLEARANCE INTERVAL.							<u>SIGN</u>	AL HEA	<u>DS</u>	

-	Title	-	
IESTER	TRAFFIC SIGN	IAL PLAN	
TREETSCAPE AND /AYFINDING D034908 PC 15323	MAIN STREET AND EAST AVENUE SIGNAL NUMBER 299		
IEW YORK	Project No. 192500343	Scale 1' = 20'	
	Drawing No.	Sheet	Revision
SAR SWM JQH 16.12.05 Dwn. Chkd. Dsgn. YY.MM.DD	TSP-9	72 of 127	0

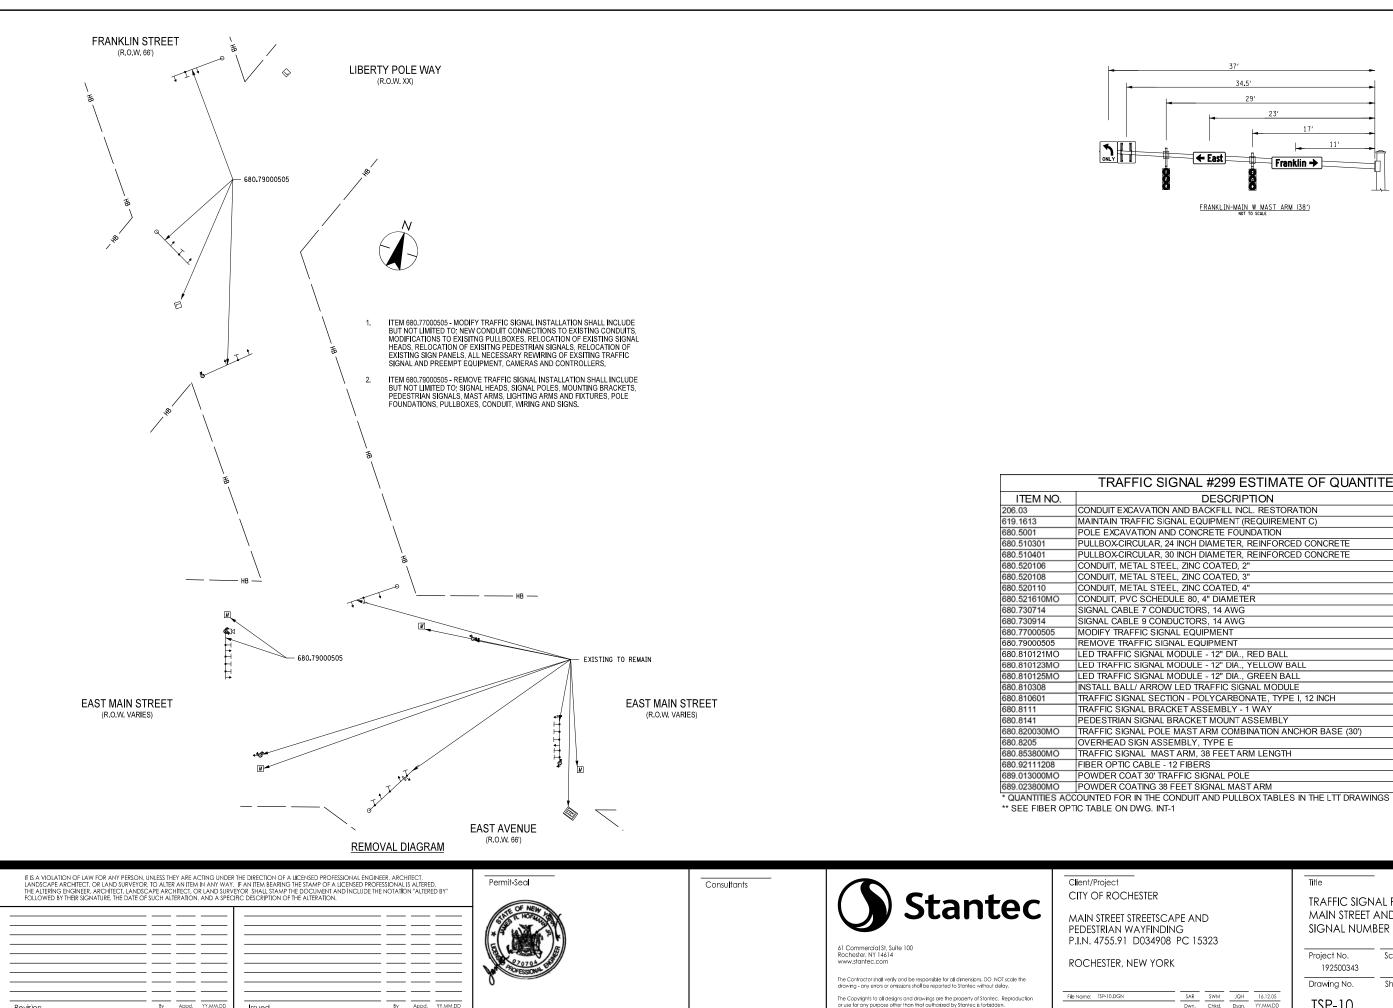

By Appd. YY.MM.DD

Date/T Date/T

Revision ORIGINAL SHEET - ANSID HORIZ By Appd. YY.MM.DD

Issued

FFIC SIGNAL #299 ESTIMATE OF QUANTITES					
DESCRIPTION	UNIT	QUANTITY			
XCAVATION AND BACKFILL INCL. RESTORATION	LF	*			
RAFFIC SIGNAL EQUIPMENT (REQUIREMENT C)	INTM	9			
VATION AND CONCRETE FOUNDATION	CY	5			
IRCULAR, 24 INCH DIAMETER, REINFORCED CONCRETE	EA	*			
IRCULAR, 30 INCH DIAMETER, REINFORCED CONCRETE	EA	*			
/IETAL STEEL, ZINC COATED, 2"	LF	*			
/IETAL STEEL, ZINC COATED, 3"	LF	*			
/IETAL STEEL, ZINC COATED, 4"	LF	*			
VC SCHEDULE 80, 4" DIAMETER	LF	*			
BLE 7 CONDUCTORS, 14 AWG	LF	524			
BLE 9 CONDUCTORS, 14 AWG	LF	306			
AFFIC SIGNAL EQUIPMENT	ELOC	1			
RAFFIC SIGNAL EQUIPMENT	ELOC	1			
IC SIGNAL MODULE - 12" DIA., RED BALL	EA	2			
IC SIGNAL MODULE - 12" DIA., YELLOW BALL	EA	2			
IC SIGNAL MODULE - 12" DIA., GREEN BALL	EA	2			
ALL/ ARROW LED TRAFFIC SIGNAL MODULE	EA	6			
GNAL SECTION - POLYCARBONATE, TYPE I, 12 INCH	EA	6			
GNAL BRACKET ASSEMBLY - 1 WAY	EA	2			
N SIGNAL BRACKET MOUNT ASSEMBLY	EA	2			
GNAL POLE MAST ARM COMBINATION ANCHOR BASE (30')	EA	1			
) SIGN ASSEMBLY, TYPE E	EA	2			
GNAL MAST ARM, 38 FEET ARM LENGTH	EA	1			
IC CABLE - 12 FIBERS	LF	**			
COAT 30' TRAFFIC SIGNAL POLE	EA	1			
COATING 38 FEET SIGNAL MAST ARM	EA	1			

_			
CHESTER	TRAFFIC SIGN	IAL PLAN	
STREETSCAPE AND WAYFINDING 1 D034908 PC 15323	MAIN STREET AND EAST AVENUE SIGNAL NUMBER 299		
NEW YORK	Project No. 192500343	Scale 1' = 20'	
	Drawing No.	Sheet	Revision
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GENERAL TRAFFIC SIGNAL NOTES (APPLICABLE TO ALL TSP DRAWINGS)

- ALL TRAFFIC SIGNAL RELATED WORK SHALL BE ACCOMPLISHED IN ACCORDANCE WITH MONROE COUNTY DEPARTMENT OF 1. TRANSPORTATION - STANDARD SPECIFICATIONS AND DETAILS, UNLESS OTHERWISE AMENDED IN THE CONTRACT DOCUMENTS.
- THE CONTRACTOR SHALL CONTACT MONROE COUNTY DEPARTMENT OF TRANSPORTATION (ERNIE FATTORE AT 753-7772) A 2. MINIMUM OF 2 WEEKS PRIOR TO COMMENCEMENT OF THE TRAFFIC SIGNAL WORK.
- THE START DATE FOR ITEM 619.1613, MAINTAIN TRAFFIC SIGNAL EQUIPMENT, BY THE CONTRACTOR WILL BE DETERMINED 3. BY THE PROJECT MANAGER AND THE MONROE COUNTY DEPARTMENT OF TRANSPORTATION.
- THE CONTRACTOR SHALL COORDINATE WITH THE MONROE COUNTY DEPARTMENT OF TRANSPORTATION TO ESTABLISH 4 PHASING AND TIMING OF THE TRAFFIC SIGNALS.
- THE CONTRACTOR SHALL COORDINATE THE TRAFFIC SIGNAL POWER POINT LOCATIONS WITH ROCHESTER GAS & ELECTRIC 5. AND MONROE COUNTY DEPARTMENT OF TRANSPORTATION.
- THE CONTRACTOR SHALL BE RESPONSIBLE FOR PAYMENT OF ALL ROCHESTER GAS & ELECTRIC FEES ASSOCIATED WITH TRAFFIC SIGNAL WORK INCLUDING, BUT NOT LIMITED TO, POWER PLANTS, PULLBOX BREAK-INS, AND METER INSTALLATIONS. 6.
- MONROE COUNTY DEPARTMENT OF TRANSPORTATION WILL SPOT ALL TRAFFIC SIGNAL POLES, SIGNAL HEAD AND OVERHEAD 7. SIGN LOCATIONS
- THE ELEVATIONS OF POLE BASES SHALL BE IN ACCORDANCE WITH MONROE COUNTY STANDARD SHEETS. 8.
- THE CONTRACTOR SHALL PROVIDE A FUSE KIT AT THE PULLBOX NEAREST TO THE CONTROLLER CABINET, THE COST TO BE INCLUDED IN THE VARIOUS TRAFFIC SIGNAL ITEMS. 9.
- 10. THE CONTRACTOR SHALL RESTORE EXISTING DRIVEWAY AND SIDEWALK AREAS WITH TEMPORARY PAVEMENT.
- 11 ALL OVERHEAD SIGNS SHALL BE FABRICATED USING ASTM TYPE IX SHEETING.
- EXISTING FIBER OPTIC INTERCONNECT CABLE SHALL BE PRESERVED WHERE SHOWN ON THE WIRING DIAGRAMS. SEE INTERCONNECT PLANS FOR ADDITIONAL INFORMATION. 12.
- 13. FIBER OPTIC CABLE SHALL BE INSTALLED WITH 5' OF SLACK PER PULLBOX AND 50' OF SLACK PER CONTROLLER CABINET.
- ALL FIBER SPLICES SHALL BE PERFORMED BY MCDOT. THE CONTRACTOR SHALL CONTACT MONROE COUNTY DEPARTMENT OF TRANSPORTATION (ERNIE FATTORE AT 753-7772) TO COORDINATE FIBER SPLICING. NO ADDITIONAL PAYMENT WILL BE MADE FOR ANY DELAYS ASSOCIATED WITH SPLICING OPERATIONS. 14.
- ALL EXISTING FIRE PREEMPTION EQUIPMENT SHALL BE MAINTAINED AND/OR RELOCATED AS REQUIRED. THIS WORK SHALL BE BE INCLUDED UNDER ITEM 680.77000X05, AND SHALL INCLUDE ANUY NECESSARY WIRING AND MOUNTING BRACKETS. 15.
- THE CONTRACTOR SHALL COORDINATE WITH THE ROCHESTER POLICE DEPARTMENT FOR THE RELOCATION OFEXISTING POLICE CAMERAS. THE ROCHESTER POLICE DEPARTMENT SHALL REMOVE THE EXISTING POLICE CAMERA FROM THE EXISTING TRAFFIC SIGNAL POLE AND REINSTALL ON THE NEW TRAFFIC SIGNAL POLE AS INDICATED IN THE CONTRACT DRAWINGS. 16.
- STREET NAME TRAFFIC SIGNS SHALL BE MOUNTED TO THE TRAFFIC SIGNAL MAST ARM USING A BRACKET TYPE MOUNT AS SHOWN ON TSD-1. THE COST OF THE BRACKET MOUNT IS TO BE INCLUDED IN THE PRICE BID FOR THE SIGN. 17.
- THE CONTRACTOR SHALL MAINTAIN, IN PROPER OPERATION, EXISTING AND NEWLY INSTALLED TRAFFIC SIGNAL EQUIPMENT, PAYMENT WILL BE MADE UNDER ITEM 680.1813 MAINTAIN TRAFFIC SIGNAL EQUIPMENT, WORK TO BE PERFORMED UNDER, BUT IS NOT LIMITED TO: THE INSTALLATION AND CONNECTION OF TEMPORARY OVERHEAD SIGNAL CABLES, AS NEEDED, TO MAINTAIN CONTINUOUS TRAFFIC SIGNAL OPERATION WHILE UNDERGROUND CONDUT LINES ARE OUT OF SERVICE: AND COVERING, ADJUSTMENT, RELOCATION AND REMOVAL OF TRAFFIC SIGNAL HEADS (AND PEDESTRIAN HEADS) AS REQUIRED FOR EACH PHASE OF TRAFFIC SIGNAL OPERATIONS. 18.
- ALL SIGNAL POLES, PEDESTRIAN POLES AND MAST ARMS ARE TO BE FURNISHED WITH A BLACK FACTORY APPLIED POWDER COATED FINISH. THE CONTRACTOR SHALL PROVIDE A SAMPLE OF THE FINISH COLOR TO THE PROJECT MANAGER PRIOR TO ORDERING THE REQUIRED POLES AND MAST ARMS. PAYMENT SHALL BE MADE UNDER THE APPROPRIATE POWDER COATING ITEMS. 19.
- ALL COMBINATION MAST ARM TRAFFIC SIGNAL POLES, ITEM 680.820030MO WILL REQUIRE A STREET LIGHTING ARM, TO BE INSTALLED AS SHOWN ON THE PLANS AND DETAILS. SEE THE TRAFFIC SIGNAL DETAILS, LIGHTING DETAILS AND LIGHTING PLANS FOR FURTHER 20. NFORMATION.
- ALL EXISTING SIGNAL EQUIPMENT TO BE REMOVED SHALL BE RETURNED TO THE MONROE COUNTY DEPARTMENT OF TRANSPORTATION. 21. CONTRACTOR TO COORDINATE WITH ERNIE FATTORE AT 753-772 TO DETERMINE THE DISPOSITION OF ALL REMOVED SIGNAL EQUIPMENT. MINIMUM OF 2 WEEKS PRIOR TO COMMENCEMENT OF THE TRAFFIC SIGNAL WORK.

TRAFFIC SIGNAL LOOP F						
LOOP NO.	SIZE	TURNS	WIRED	FUNCTION	680.54	
MAIN ST @ STO	ONE ST					
367	6' x 6'	3	DIRECT	SS	38	
29601	20' x 6'	2-4-2	DIRECT	Ø2	76	
29602	20' x 6'	2-4-2	DIRECT	Ø2	99	
MAIN ST @ CLII	NTON	·				
29701	20' x 6'	2-4-2	DIRECT	Ø3	88	
29702	20' x 6'	2-4-2	DIRECT	Ø3	94	
29703	20' x 6'	2-4-2	DIRECT	Ø5	92	
29704	20' x 6'	2-4-2	DIRECT	Ø5	100	
366	6' x 6'	3	DIRECT	SS	-	
369	6° X 6°	3	DIRECT	SS	-	
MAIN ST @ COI	RTLAND ST					
368	6' x 6'	3	DIRECT	SS	30	
1	20' x 6'	2-4-2	DIRECT	Ø2	-	
2	20' x 6'	2-4-2	DIRECT	Ø2	-	


PAYMENT WILL BE MADE UNDER:


ITEM NO. 680.54 INDUCTANCE LOOP INSTALLATION ITEM NO. 680.71 SHIELDED LEAD-IN CABLE ITEM NO. 680.72 INDUCTANCE LOOP WIRE

IT IS A VIOLATION OF LAW FOR ANY PERSON, UNLESS THEY ARE ACTING UNDER THE DIRECTION OF A LICENSED PROFESSIONAL ENGINEER, ARCHITECT, LANDSCAPE ARCHITECT, OR LAND SURVEYOR, TO ALTER AN ITEM IN ANY WAY. IF AN ITEM BEARING THE STAMP OF A LICENSED PROFESSIONAL IS ALTERED, THE ALTERING ENGINEER, ARCHITECT, LANDSCAPE ARCHITECT, OR LAND SURVEYOR SHALL STAMP THE DOCUMENT AND INCLUDE THE NOTATION "ALTERED BY" FOLLOWED BY THEIR SIGNATURE, THE DATE OF SUCH ALTERATION, AND A SPECIFIC DESCRIPTION OF THE ALTERATION.	Permit-Seal	Consultants	Stantoc	Client/Project CITY OF ROCHESTER	Title TRAFFIC SIGNAL NOTES
			Al Commercial SI, Suite 100 Rochester, NY 14614 www.stantec.com	MAIN STREET STREETSCAPE AND PEDESTRIAN WAYFINDING P.I.N. 4755.91 D034908 PC 15323 ROCHESTER, NEW YORK	AND TRAFFIC SIGNAL LOOP TABLE Project No. 1/2500343 1' = 20'
Revision By Appd. YY.MM.DD Issued By Appd. YY.MM.DD	A. COERCON		The Contractor shall verify and be responsible for all dimensions. DO NOT scale the drawing - any errors or omissions shall be reported to Stantec without delay. The Copyrights to all designs and drawings are the property of Stantec. Reproduction or use for any purpose other than that outhorized by Stantec is forbidden.	File Name: TSP-11.DGN SAR SWM JQH 16.12.05 Dwn. Chkd. Dsgn. YY.MW.DD	Traving No. Sheet Revision TSP-11 74 of 127 0


EPLAC	EMENT TAE	BLE						
54 (LF)	680.71 (LF)	680.72 (LF)	NOTES					
38	152	126						
76	108	216						
99	108	270						
38	20	258						
94	20	288						
92	107	272						
00	107	284						
-	472	-	NEW SHIELDED LEAD-IN CABLE ONLY					
-	472	-	NEW SHIELDED LEAD-IN CABLE ONLY					
30	115	104						
-	251	-	NEW SHIELDED LEAD-IN CABLE ONLY					
-	251	-	NEW SHIELDED LEAD-IN CABLE ONLY					

LINEAR FEET LINEAR FEET LINEAR FEET

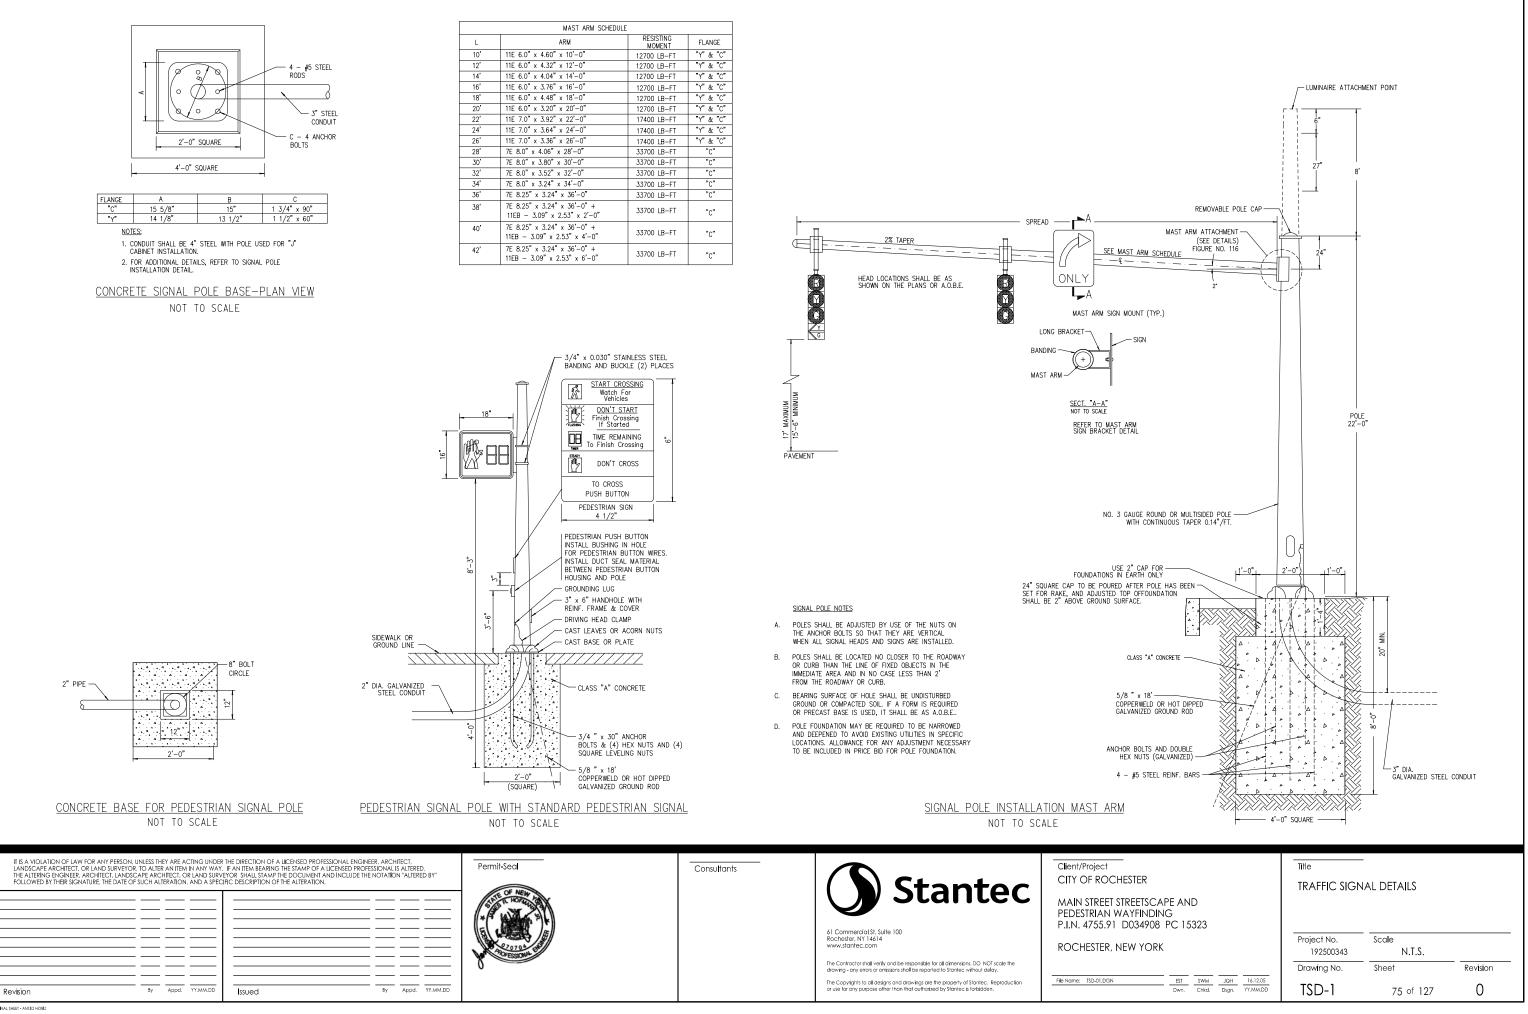

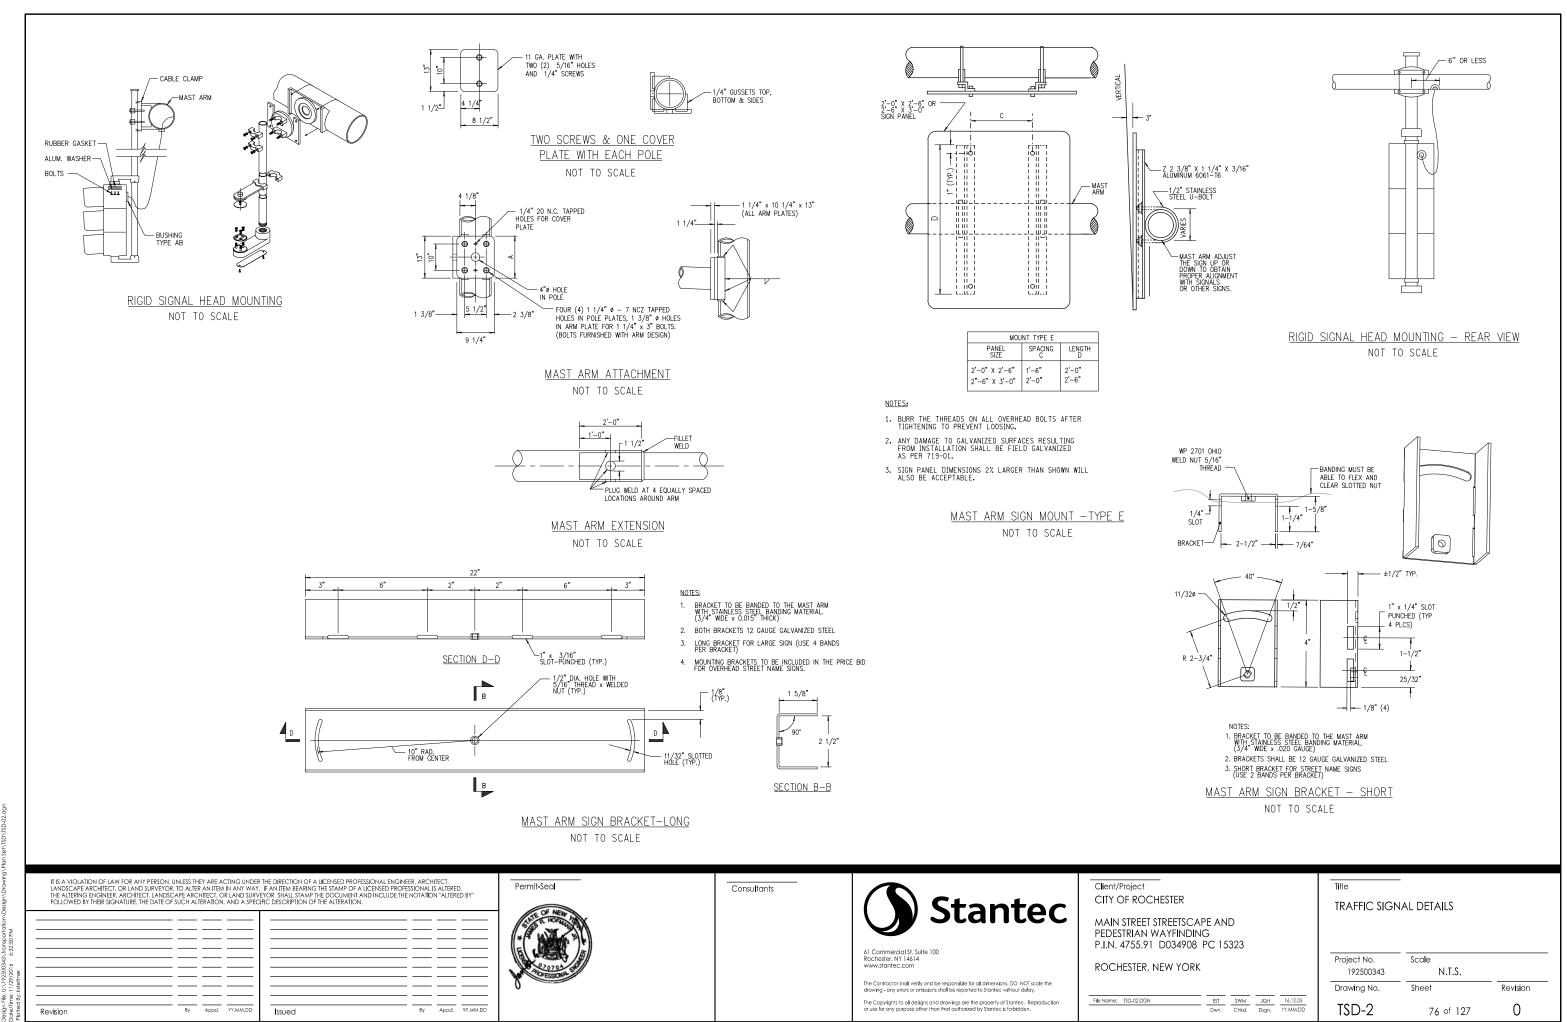

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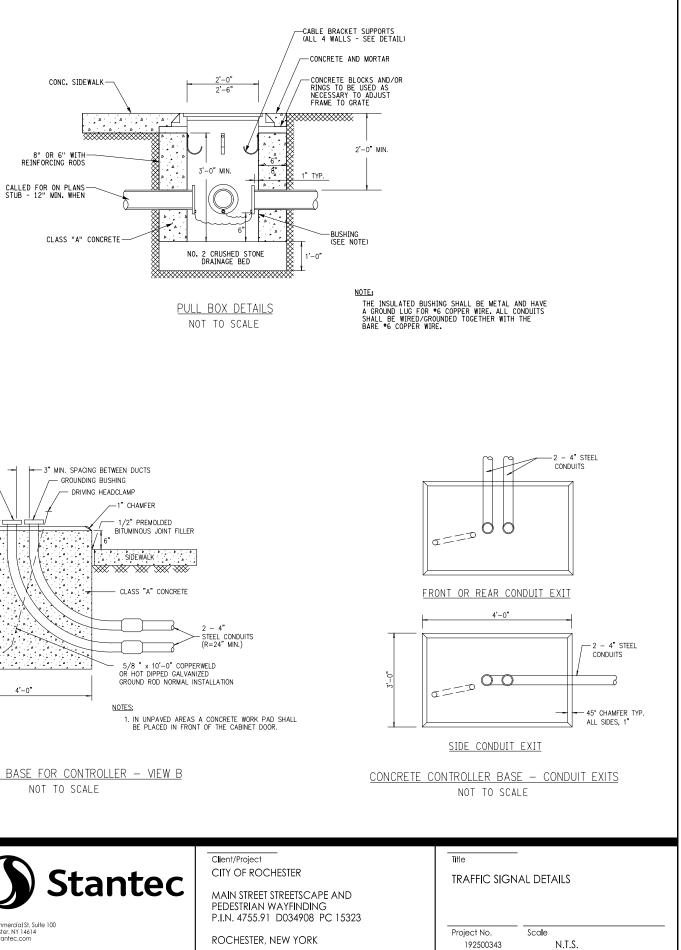
1.	DETAILS SHOWN ARE TYPICAL ONLY AND NOT INTENDED TO INDICATE THE PRODUCTS OF ANY SPECIFIC MANUFACTURER.
2.	SIGNAL HEAD ARRANGEMENTS ARE SHOWN FOR EXAMPLE ONLY. NUMBER OF DIRECTIONS THE HEAD FACES, NUMBER OF SECTIONS SIZE OF FACES, SIGNAL INDICATIONS AND ARRANGEMENT OF FACES WILL BE SPECIFIED ON THE PLANS.
3.	SIGNAL HEADS ARE TO BE NORMALLY FURNISHED WITH A CONVENTIONAL WIRE OUTLET BODY DISCONNECT HANGERS, IF REQUIRED WILL BE SPECIFIED ON THE PLANS.
4.	ELBOWS, PIPE CROSSES, WIRE OUTLET AND OTHER FITTINGS SHALL BE EQUIPPED WITH SET SCREWS.
5.	UNUSED HOLES SHALL BE CAPPED.
6.	SIGNAL HEADS SHALL BE ASSEMBLED TO BALANCE AND HANG VERTICALLY.
7.	THREADS ON FITTINGS ARE NATIONAL PIPE STRAIGHT THREADS.
8.	STANDARD OPEN VISORS SHALL BE INSTALLED UNLESS SPECIFIED OTHERWISE ON THE PLANS.
9.	THE CONTRACTOR IS CAUTIONED THAT THE LOCATIONS OF UTILITIES SHOWN ON THE CONTRACT PLANS ARE NOT GUARANTEED, NOR IS THERE ANY GUARANTEE THAT ALL SUCH LINES WITHIN THE CONTRACT LIMITS HAVE BEEN SHOWN ON THE PLANS. IT WILL BE THE CONTRACTOR'S RESPONSIBILITY TO SATISFY HIMSELF AS TO THE EXACT CONDITIONS, AND AT THEIR OWN EXPENSE, TO PROTECT AND SUPPORT ALL UTILITES ENCOUNTERED IN HIS EXCAVATING AND TRENCHING OPERATIONS.
10.	THE CONTRACTOR SHALL BE RESPONSIBLE FOR ANY DAMAGE TO THESE LINES CAUSED BY HIS OPERATIONS AND IF NATURE OF THE DAMAGE IS SUCH AS TO ENDANGER THE SATISFACTORY OPERATIONS OF THESE UTILITIES AND NECESSARY REPAIRS ARE NOT IMMEDIATELY MADE BY THE CONTRACTOR, THE WORK MAY BE PERFORMED BY THE RESPECTIVE OWNING COMPANIES AND THE COST THEREOF CHARGED TO THE CONTRACTOR.

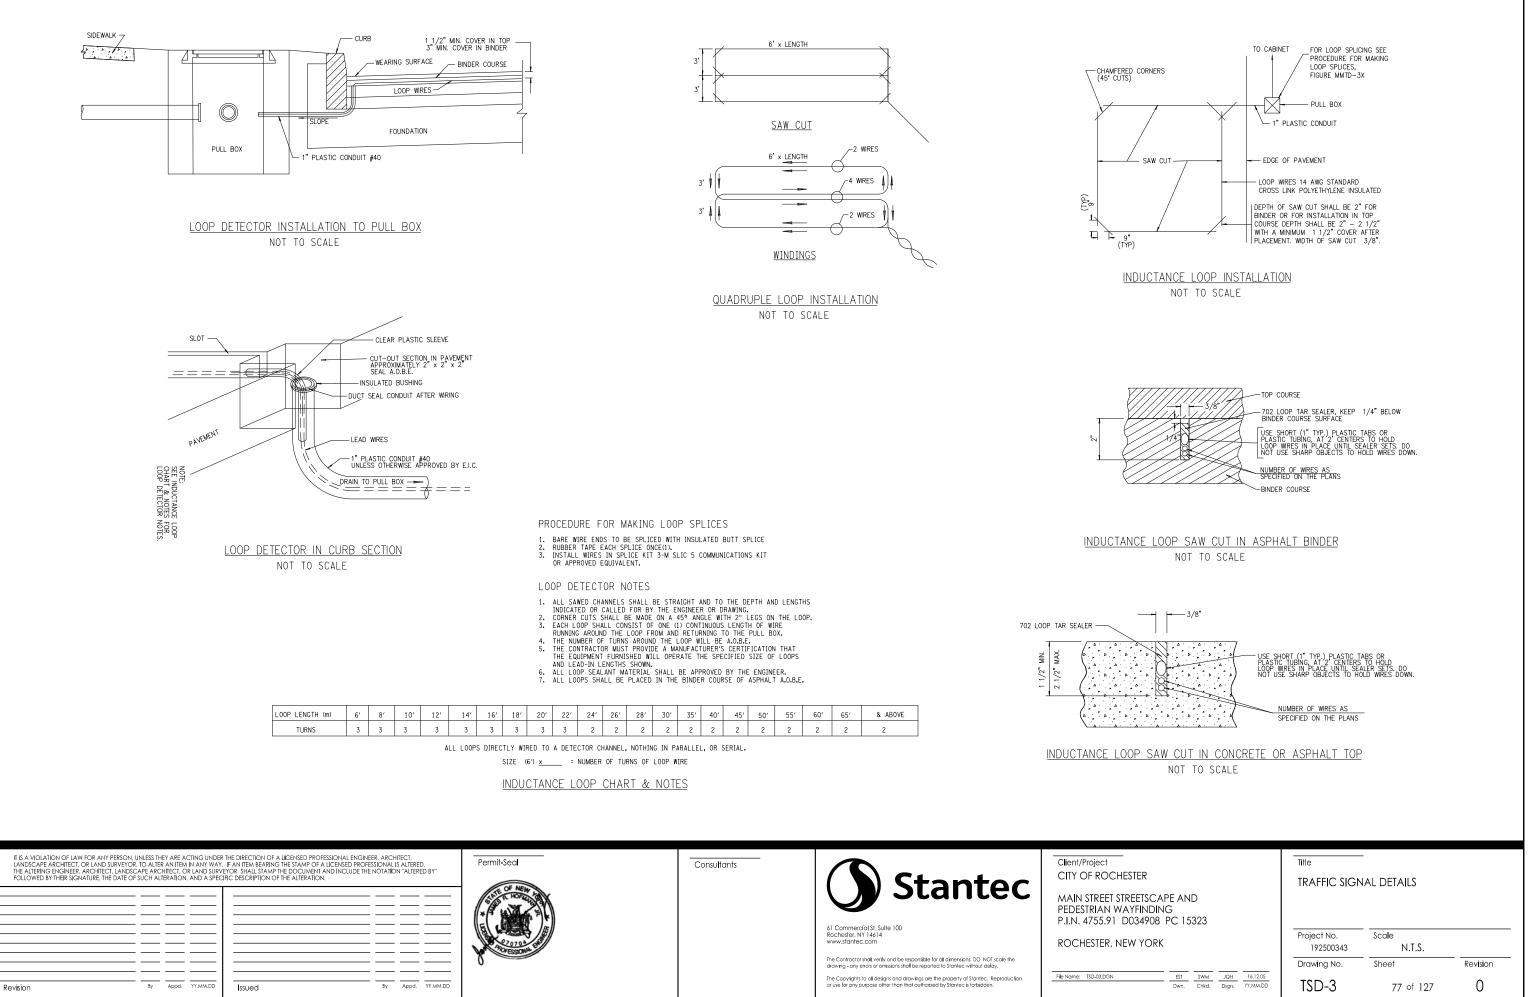
TRAFFIC SIGNAL NOTES

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EXISTING GROUND BACKFILL WITH EXCAVATED - CONDUIT 2'-0" OR A.O.B.E. EXCAVATION IN EARTH





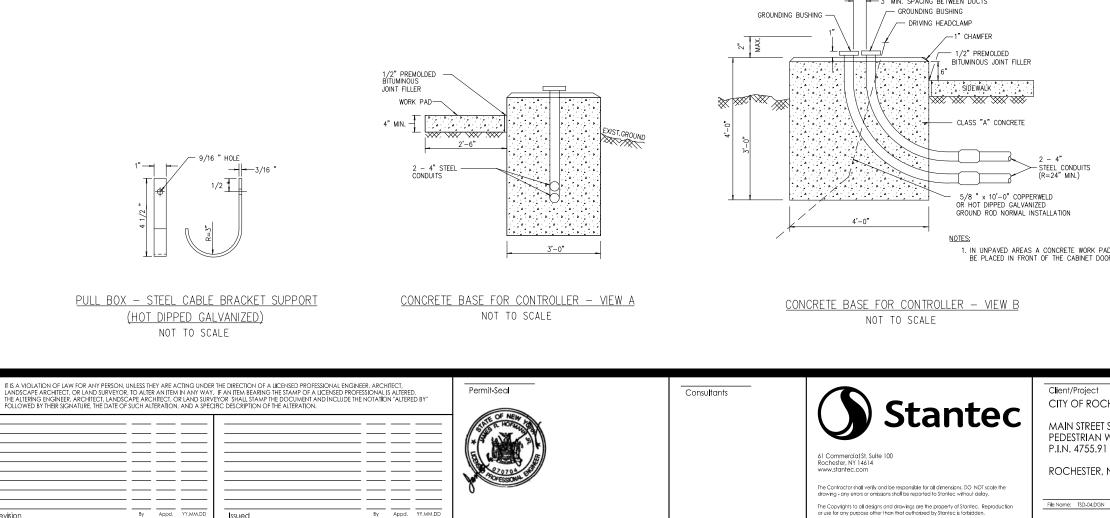

N19250034 Design Date/T

				Drawing No.
EST	SWM	JQH	16.12.05	
Dwn.	Chkd.	Dsgn.	YY.MM.DD	ISD-4

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