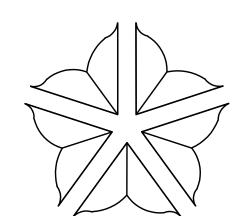


LOCATION PLAN

SCALE: NTS





# City of Rochester

# Department of Environmental Services

# RUNDEL LIBRARY TERRACE PHASE IV STRUCTURAL IMPROVEMENTS ROCHESTER, NY

JULY 2018
CITY PROJECT NO. 16032
CONTRACT 1 - GENERAL CONSTRUCTION
CONTRACT 2 - MECHANICAL & PLUMBING
CONTRACT 3 - ELECTRICAL

NORMAN H. JONES

COMMISSIONER, CITY OF ROCHESTER

DEPARTMENT OF ENVIRONMENTAL SERVICES

KAMAL L. CRUES, P.E.

CITY ENGINEER

CITY OF ROCHESTER

SUSAN L. MATZAT, P.E.
LABELLA ASSOCIATES, D.P.C.

Associates, P.C

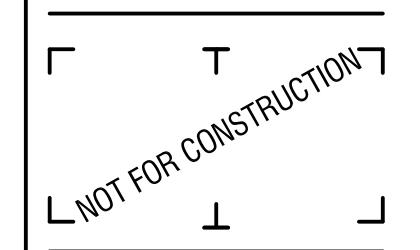
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ROCHESTER, NY 14614
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Bayer Landscape Architecture, PLLC

19 North Main Street Honeoye Falls, New York 14472 585-582-2000 bayerla.com



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CITY OF ROCHESTER
414 ANDREWS STREET

ROCHESTER, NY 14604

RUNDEL LIBRARY PHASE

115 SOUTH AVE. ROCHESTER, NY 14604

NO:	DATE:	DESCRIPTION:
Revisions		
PROJECT NU	MBER:	2170391
DRAWN BY:		MML
REVIEWED B	Y:	JMG
ISSUED FOR:		PRELIMINARY DESIG

DRAWING NAME:

COVER SHEET & LOCATION PLAN

DRAWING NUMBER

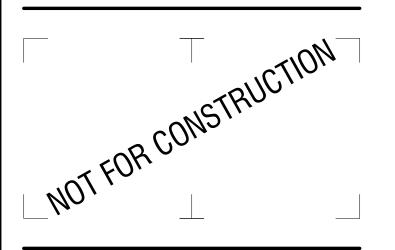
G-000

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### **CITY OF ROCHESTER**

414 ANDREWS ST. ROCHESTER, NY 14604

**RUNDEL LIBRARY PHASE IV** 

115 SOUTH AVE. ROCHESTER, NY 14604

NO: DATE: DESCRIPTION:

Revisions

PROJECT NUMBER:

2170391

DRAWN BY: MML

REVIEWED BY: JMG

ISSUED FOR:

35% PRELIMINARY DESIGN

DATE:

DRAWING NAME:

PROJECT INFORMATION & DRAWING INDEX

DRAWING NUMBER:

G-001



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NOTE:

1. BASEMAPPING IS IN PRELIMINARY
CONDITION AND NOT TO BE CONSIDERED
AN ACCURATE DEPICTION OF EXISTING
CONDITIONS.

RUNDEL LIBRARY PHASE IV 115 SOUTH AVENUE ROCHESTER, NY 14604

NO:	DATE:	DESCRIPTION:
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PROJECT N	IUMBER:	2170391
DRAWN BY	· .	S.R.M.
REVIEWED	BY:	R.C.B.
SSUED FO		RELIMINARY DESIGN
DATE:		JULY 2018

**ROADWAY PLAN** 

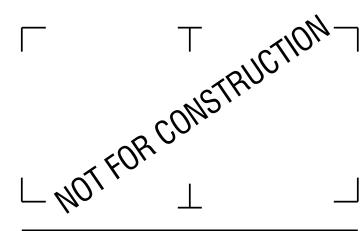
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PL-1



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DRAWN BY: S.R.M.
REVIEWED BY: R.C.B.

ISSUED FOR:
35% PRELIMINARY DESIGN

DATE:

JULY 2018

DRAWING NAME:

PEDESTRIAN
DETOUR AND
LIBRARY ACCESS PHASE 1

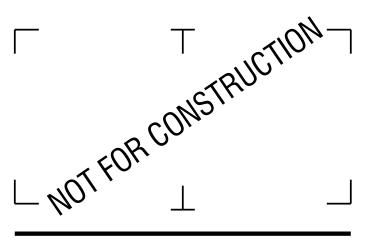
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DATE:		JULY 2018

PEDESTRIAN
DETOUR AND
LIBRARY ACCESS PHASE 2

.....

WZTC-2

### **ABBREVIATIONS:**

AND APPROX. APPROXIMATE ASPH. ASPHALT A.S.T.M. AMERICAN SOCIETY OF TESTING AND MATERIALS C.B. CATCH BASIN C.L. / E CENTER LINE CLR. CLEAR CONC. CONCRETE C.O. CLEAN OUT DRAIN INLET D.I. ELECTRIC LINE E.J. EXPANSION JOINT ELEV. ELEVATION EQ. EQUAL GAS LINE G.V. GAS VALVE H.H. HAND HOLE + H.P. HIGH POINT HYDRANT HYD. INVERT ELEVATION ISOLATION JOINT LT.P. LIGHT POLE / FIXTURE + L.P. LOW POINT M.H. MANHOLE MIN. MINIMUM MAX. MAXIMUM

M.W. MONITORING WELL N.Y.S.D.O.T. NEW YORK STATE DEPARTMENT OF TRANSPORTATION P.B. PULL BOX

P.L. / P. PROPERTY LINE P.O.B. POINT OF BEGINNING P.O.C. POINT OF CURVATURE P.O.T. POINT OF TANGENT P.P. POWER POLE PT. POINT P.V.C. POLYVINYL CHLORIDE R / RAD. RADIUS RGE ROCHESTER GAS & ELECTRIC S / SAN. SANITARY SEWER

STORM SEWER / DRAIN

TC / BC TOP / BOTTOM OF CURB SOIL TEST HOLE TR / BR TOP / BOTTOM OF RAMP TYPICAL W / WAT. WATER LINE / SERVICE W.V. WATER VALVE WITH

STANDARD

TELEPHONE

D / STM.

STD.

### **GENERAL CITY NOTES:**

- 1. ALL FACILITIES TO BE CONSTRUCTED OR INSTALLED SHALL COMPLY WITH ALL THE LATEST REVISIONS AND APPLICABLE SECTIONS OF CITY OF ROCHESTER
- 2. CONTRACTOR IS CAUTIONED TO NOTIFY CENTRAL STAKEOUT AT 1-800-962-7962 FOR LOCATION OF ANY UNDERGROUND UTILITIES BEFORE UNDERTAKING ANY CONSTRUCTION IN THIS AREA. R.P.W.D.
- 3. ALL FILL AREAS SHALL BE COMPACTED TO 95% OF ORIGINAL DENSITY PER MODIFIED PROTECTOR TEST. THIS SHALL BE CERTIFIED TO THE CITY OR ITS REPRESENTATIVE BY A LICENSED TESTING COMPANY.
- 4. ALL IMPROVEMENTS SHALL BE CONSTRUCTED IN ACCORDANCE WITH THE APPROVED PLANS OR OTHER APPLICABLE REGULATIONS.
- 5. THE CONTRACTOR SHALL BE RESPONSIBLE FOR ALL SILTATION AND EROSION CONTROL MEASURES DURING THE ENTIRE PERIOD OF CONSTRUCTION AND UNTIL SUBSTANTIAL GROUND COVER HAS BEEN ESTABLISHED. IT IS RECOGNIZED THAT THESE CONTROLS MAY INTERFERE WITH CONSTRUCTION. IN THIS EVENT, ALTERNATE MEASURES AND/OR FACILITIES SHALL BE APPROVED BY THE CITY OR ITS REPRESENTATIVE.
- 6. THE CONTRACTOR SHALL TAKE PRECAUTIONARY MEASURES TO PROTECT UTILITY LINES SHOWN ON THE APPROVED DRAWINGS AND OTHER LINES NOT SHOWN HEREIN OR OF RECORD.
- 7. THE CONTRACTOR IS RESPONSIBLE FOR OBTAINING ALL NECESSARY PERMITS FOR ALL IMPROVEMENTS SHOWN ON THE APPROVED PLANS. 8. HIGHWAY DRAINAGE SHALL BE MAINTAINED AT ALL TIMES.
- 9. UPON COMPLETION OF THE PROJECT, AS-BUILT PLANS OF THE COMPLETED UTILITIES SHALL BE FURNISHED ON REPRODUCIBLE MATERIAL TO THE CITY, C.R.P.W. AND THE OWNER.

### **GENERAL NOTES:**

- 1. THE HORIZONTAL AND VERTICAL LOCATION INFORMATION OF THE SITE EXISTING CONDITIONS WITHIN THIS DRAWING SET HAS BEEN OBTAINED FROM A CONSTRUCTION DOCUMENT SET ENTITLED RUNDEL PUBLIC LIBRARY, PREPARED BY PRUDENT ENGINEERING, DATED FEBRUARY 2017.
- . THE CONTRACTOR SHALL BE RESPONSIBLE FOR FIELD VERIFICATION OF ALL EXISTING AND PROPOSED HORIZONTAL AND VERTICAL LOCATION INFORMATION SHOWN ON THESE PLANS FOR BOTH BIDDING AND CONSTRUCTION PURPOSES. ANY DISCREPANCIES SHALL BE REPORTED IMMEDIATELY TO THE OWNER'S REPRESENTATIVE.
- 3. THE CONTRACTOR SHALL HAVE ALL UTILITIES AND INFRASTRUCTURE FIELD LOCATED AND MARKED BY THE RESPONSIBLE PUBLIC OR PRIVATE AGENCY PRIOR TO THE START OF CONSTRUCTION, AND SHALL MAINTAIN ALL LOCATION STAKES AND MARKINGS THROUGHOUT THE CONSTRUCTION PROCESS. 4. PRIOR TO THE START OF CONSTRUCTION, THE CONTRACTOR SHALL FIELD VERIFY
- THE LOCATION, PIPE SIZES AND INVERT ELEVATIONS, OF ANY EXISTING SEWERS TO BE AFFECTED BY THE PROJECT. 5. PROVIDE THE OWNER'S REPRESENTATIVE WITH AT LEAST SEVEN DAYS NOTICE

FOR ANY REQUIRED INTERRUPTION OF A UTILITY SERVICE. WRITTEN PERMISSION

- FROM THE OWNER'S REPRESENTATIVE IS REQUIRED BEFORE THE UTILITY SERVICE CAN BE INTERRUPTED. A TEMPORARY SERVICE MAY BE REQUIRED BY THE OWNER. 6. THE CONTRACTOR SHALL BE RESPONSIBLE FOR ANY DAMAGE TO PAVEMENT CURBS, PLANTINGS, UTILITIES AND ANY OTHER EXISTING SITE FEATURES PROPOSED TO REMAIN, AS CAUSED BY CONSTRUCTION OR OTHER RELATED
- OPERATIONS. ALL SUCH DAMAGE SHALL BE REPLACED IN-KIND AT THE CONTRACTOR'S EXPENSE.
- 7. THE CONTRACTOR SHALL NOT DISTURB ANY AREAS OUTSIDE THE PROJECT LIMITS. 8. THE CONTRACTOR SHALL PRESERVE AND PROTECT ALL EXISTING TREES, SHRUBS AND GROUNDCOVERS WITHIN AND ADJACENT TO THE PROJECT SITE EXCEPT FOR THOSE SPECIFICALLY IDENTIFIED ON THESE PLANS AND APPROVED FOR REMOVAL IN THE FIELD BY THE OWNER'S REPRESENTATIVE. SEE TREE PROTECTION DETAIL.
- 9. THE CONTRACTOR SHALL BE RESPONSIBLE FOR MAINTAINING THE CONSTRUCTION SITE IN A SAFE AND ORDERLY CONDITION THROUGHOUT THE CONSTRUCTION PERIOD. THE CONTRACTOR SHALL PAY PARTICULAR ATTENTION TO PEDESTRIAN SAFETY ISSUES. THE CONTRACTOR SHALL TAKE ALL NECESSARY PRECAUTIONS, INCLUDING, BUT NOT LIMONITE TO, BARRIERS AND OTHER DEVICES AS NECESSARY TO KEEP PEDESTRIANS SAFE FROM CONSTRUCTION OPERATIONS AND OUT OF THE

CONSTRUCTION ZONE.

SILT, ETC..

- 10. THE CONTRACTOR SHALL MAINTAIN THE PROJECT SITE IN A NEAT AND ORDERLY STATE AND TAKE THE NECESSARY STEPS TO MINIMIZE THE MIGRATION OF DUST AND DEBRIS FROM THE PROJECT SITE, INCLUDING MEASURES AS REQUIRED BY THE SITE MANAGEMENT PLAN. CONSTRUCTION TRAVEL ROUTES AND ALL AREAS ADJACENT TO THE CONSTRUCTION SITE SHALL BE CHECKED DAILY AND CLEANED, AS NECESSARY, TO REMOVE ANY ACCUMULATION OF MUD, DUST OR OTHER CONSTRUCTION DEBRIS.
- 11. PRIOR TO THE COMPLETION OF THIS PROJECT, THE CONTRACTOR SHALL CHECK AND CLEAN ALL MANHOLES, CATCH BASINS, DRAIN INLETS, AND OTHER SITE DRAINAGE SYSTEM COMPONENTS WITHIN THE PROJECT LIMITS AND IN THE DRAINAGE PATH OF THE PROJECT SITE SO THAT THEY ARE FREE FROM ALL DEBRIS,
- 12. THE CONTRACTOR SHALL BE REQUIRED FOR OBTAINING ANY REQUIRED MUNICIPAL AND/OR LOCAL REGULATORY CONSTRUCTION PERMITS AND/OR INSPECTIONS.
- 13. THE CONTRACTOR IS ADVISED TO CAREFULLY REVIEW ALL OF THE ADDITIONAL PROJECT REQUIREMENTS CONTAINED WITHIN THE PROJECT MANUAL, CITY OF ROCHESTER STANDARD CONSTRUCTION CONTRACT DOCUMENTS, AND THIS DRAWING SET.

### MATERIAL AND LAYOUT NOTES:

- PROPOSED SITE FEATURES SHALL BE STAKED OUT BY A NYS LICENSED LAND SURVEYOR IN ACCORDANCE WITH THE LAYOUT AND GRADING PLANS AND SHALL BE REVIEWED WITH THE OWNER'S REPRESENTATIVE AND LANDSCAPE ARCHITECT PRIOR TO THE START OF CONSTRUCTION. WHERE POSSIBLE, LAYOUT STAKES SHALL REMAIN IN PLACE THROUGHOUT THE CONSTRUCTION PROCESS, REPLACE AS REQUIRED.
- 2. CONTRACTOR SHALL FIELD VERIFY ALL LAYOUT DIMENSIONS. CONTRACTOR SHALL ADHERE TO WRITTEN DIMENSIONS ON ALL PLANS. ANY DISCREPANCIES SHALL BE REPORTED IMMEDIATELY TO THE LANDSCAPE ARCHITECT FOR DECISION.
- 3. ADHERE TO WRITTEN DIMENSIONS. DO NOT SCALE THIS DRAWING OR CONSTRUCTION DETAILS.
- 4. THE CONTRACTOR SHALL REFER ANY QUESTIONS REGARDING MATERIALS, FINISHES, LABOR, AND/OR PRODUCTS NOT SPECIFIED IN CONSTRUCTION DOCUMENTS TO THE LANDSCAPE ARCHITECT PRIOR TO ORDERING
- 5. ALL ANGLES ARE 90 DEGREES UNLESS OTHERWISE NOTED.

APPLICABLE BUILDING CODES AND STANDARDS.

MATERIALS OR STARTING WORK.

OTHERWISE NOTED.

- 6. WHERE INCHES ARE NOT INDICATED, DIMENSIONS ARE IN INCREMENTS OF AN EVEN FOOT.
- 7. FIELD MEASUREMENTS: TAKE ACCURATE FIELD MEASUREMENTS BEFORE PREPARATION OF SHOP DRAWINGS AND FABRICATION.
- 8. IT IS THE CONTRACTOR'S RESPONSIBILITY TO ENSURE THAT THE FEATURES SHOWN IN THIS DRAWING SET ARE INSTALLED IN ACCORDANCE WITH ALL
- 9. ALL DIMENSIONS TO OR FROM CURB LINES ARE MEASURED FROM THE EXPOSED FACE OF CURB OR FACE OF CURB ABUTTING PAVING, UNLESS
- 10. REFER TO CONSTRUCTION DETAILS FOR ADDITIONAL LAYOUT INFORMATION.
- 11. DIMENSIONS INDICATED ON PLANS ARE FOR HORIZONTAL CONTROL AND ARE ACCURATE IF MEASURED ON A LEVEL LINE. MEASURE HORIZONTAL CONTROL DIMENSIONS ON A LEVEL LINE NOT PARALLEL WITH GROUND SLOPE.
- 12. PROVIDE SOURCES OF PROPOSED MATERIALS, ACCORDING TO SPECIFICATIONS, FOR REVIEW AND APPROVAL BY LANDSCAPE ARCHITECT.

### GRADING AND DRAINAGE NOTES:

- 1. ALL PROPOSED ELEVATIONS SHOWN ARE FINISHED GRADE ELEVATIONS, UNLESS OTHERWISE NOTED.
- 2. THE CONTRACTOR SHALL ESTABLISH FINISH GRADE STAKES IN ACCORDANCE WITH THIS PLAN (AND IN CONJUNCTION WITH THE LAYOUT PLAN) AND SHALL BE REVIEWED WITH THE OWNER'S REPRESENTATIVE PRIOR TO THE START OF CONSTRUCTION. MAINTAIN GRADE STAKES THROUGHOUT THE CONSTRUCTION PROCESS.
- 3. ANY DISCREPANCIES IN PROPOSED ELEVATIONS NOTED BY THE CONTRACTOR DURING THE CONSTRUCTION PROCESS SHALL BE REPORTED IMMEDIATELY TO THE OWNER'S REPRESENTATIVE FOR DECISION.
- 4. THE CONTRACTOR SHALL BE RESPONSIBLE FOR CREATING POSITIVE DRAINAGE IN ALL AREAS AND MAKE CERTAIN ALL WATER (DRAINAGE) IS DIRECTED AWAY FROM BUILDINGS AND STRUCTURES. ALL NEWLY GRADED GROUND SURFACES SHALL BE FINISHED TO UNIFORM GRADES AND SLOPED IN SUCH A MANNER AS TO DRAIN PROPERLY AND BE FREE OF DEPRESSIONS THAT CAUSE AREAS OF STANDING WATER. THE CONTRACTOR SHALL REPORT ANY CONFLICTS WITH THIS REQUIREMENT TO THE OWNER'S REPRESENTATIVE FOR RESOLUTION PRIOR TO FINAL GRADING OPERATIONS.
- 5. WHERE PROPOSED GRADE MEETS EXISTING, BLEND GRADES TO PROVIDE A SMOOTH TRANSITION. PERFORM GRADING WITHIN CONTRACT LIMITS OF WORK, INCLUDING ADJACENT TRANSITION AREAS, TO NEW ELEVATIONS, LEVELS, PROFILES, AND CONTOURS INDICATED.
- 6. PROVIDE SUBGRADE SURFACES PARALLEL TO FINISHED SURFACE GRADES. MAINTAIN LEVELS, PROFILES AND CONTOURS OF SUBGRADES.
- 7. ALL GRADING OPERATIONS WITHIN THE DRIP LINE OF EXISTING TREES TO REMAIN SHALL BE COMPLETED BY HAND AND WITH EXTREME CARE TO AVOID DAMAGE TO TREE ROOTS.
- 8. THE CONTRACTOR SHALL TAKE ALL PRECAUTIONS NECESSARY TO PREVENT DISTURBANCE OF, OR DAMAGE TO, EXISTING PLANTS TO REMAIN. PLACE VEGETATION PROTECTION FENCING AROUND ALL PLANTS ON AREAS OF PLANTING AS IDENTIFIED IN THE SITE PREPARATION DRAWINGS.
- 9. ALL FILL AND BACKFILL MATERIALS MUST BE THOROUGHLY COMPACTED AS THEY ARE PLACED. REFER TO THE TECHNICAL SPECIFICATIONS FOR DETAILED INFORMATION, INCLUDING COMPACTION INFORMATION INCLUDING THE MAXIMUM LOOSE DEPTH LAYER THICKNESS ALLOWABLE, AND THE PERCENTAGE OF MAXIMUM DRY DENSITY REQUIREMENTS FOR THE FILLING AND BACKFILLING OPERATIONS.
- 10. REFER TO THE TECHNICAL SPECIFICATIONS FOR ADDITIONAL REQUIREMENTS RELEVANT TO DRAINAGE, GRADING AND OTHER EARTHWORK OPERATIONS.
- 11. ADJUST THE HEIGHT OF ALL UTILITY FRAMES, GRATES, VALVES, HYDRANTS, AND ANY OTHER UTILITY STRUCTURE OR COMPONENTS AS REQUIRED TO ACHIEVE THE PROPER RELATIONSHIP TO THE PROPOSED FINISHED GRADES
- 12. UTILITY INSTALLATIONS MUST COMPLY WITH ALL NATIONAL, STATE AND LOCAL BUILDING CODES.
- 13. THE CONTRACTOR SHALL BE RESPONSIBLE FOR THE COST OFF ALL CUT AND FILL OPERATIONS AND MATERIALS NECESSARY TO ACHIEVE THE ELEVATIONS SPECIFIED ON THIS PLAN, INCLUDING THE OFF SITE DISPOSAL OF ANY EXCESS MATERIAL IN A LEGAL MANNER.
- 14. THE CONTRACTOR SHALL CLEAN AND FLUSH CULVERTS, PIPING, CATCH BASINS, MANHOLES, OR ANY OTHER STORM DRAINAGE SYSTEM COMPONENTS WITHIN THE PROJECT AREA, PRIOR TO COMPLETION OF
- 15. DO NOT WORK WITH WET, MUDDY SOIL. PLACE SOIL DURING DRY WEATHER.
- 16. PROTECT FINISH GRADED AREAS FROM TRAFFIC AND EROSION. KEEP FREE OF TRASH AND DEBRIS. REPAIR AND RE-ESTABLISH GRADES IN SETTLED, ERODED AND DAMAGED AREAS. WHERE COMPLETED AREAS ARE DISTURBED BY CONSTRUCTION OPERATIONS OR ADVERSE WEATHER. SCARIFY, RE-SHAPE AND COMPACT TO REQUIRED DENSITY, AS PER TECHNICAL SPECIFICATIONS

### PLANTING NOTES:

- 1. REFER TO SPECIFICATION DIVISION 32 FOR ADDITIONAL PLANTING REQUIREMENTS.
- 2. CONTRACTOR SHALL VERIFY ACTUAL GRADE ELEVATIONS, SERVICE AND UTILITY LOCATIONS, AND DIMENSIONS OF PLANTINGS AND CONSTRUCTION CONTIGUOUS WITH NEW PLANTINGS BY FIELD MEASUREMENTS BEFORE PROCEEDING WITH PLANTING WORK.
- 3. PLANT TREES, SHRUBS, AND OTHER PLANTS AFTER FINISH GRADES ARE ESTABLISHED AND BEFORE PLANTING TURF AREAS UNLESS OTHERWISE
- 4. ALL BED CONFIGURATIONS AND PLANT POSITIONS SHALL BE APPROVED BY THE LANDSCAPE ARCHITECT PRIOR TO PLANTING.
- 5. CONTRACTOR IS REQUIRED TO LAY-OUT INDIVIDUAL TREE AND SHRUB LOCATIONS AND PLANTING AREAS FOR APPROVAL BY THE LANDSCAPE ARCHITECT PRIOR TO INSTALLATION OF PLANTING. CONTRACTOR SHALL ADJUST THE PLANT LOCATIONS IF DEEMED NECESSARY BY THE LANDSCAPE ARCHITECT.
- 6. ALL "STANDARD LAWN AREAS" AND "SPECIALIZED LAWN AREAS" SHALL RECEIVE THE SOIL TYPE AND SOIL DEPTH SPECIFIED, AND SHALL BE FINE GRADED AND SEEDED. (SEE SPECIFICATIONS FOR SEED AND SOIL REQUIREMENTS)
- 7. ALL PLANTS MUST MEET OR EXCEED THE STANDARDS OUTLINED IN THE CURRENT EDITION OF ANSI Z260.1, THE AMERICAN STANDARD FOR NURSERY
- 8. THE CONTRACTOR SHALL SUBMIT A COMPLETE PLANT LIST (PURCHASE ORDER) TO THE LANDSCAPE ARCHITECT FOR REVIEW AND APPROVAL PRIOR TO PURCHASING THE PLANT MATERIAL. NO PLANT MATERIAL SHALL BE DELIVERED TO THE SITE PRIOR TO THE INSPECTION AND APPROVAL OF THE PLANTS AT THE CONTRACTOR'S PLACE OF BUSINESS.
- 9. CONTRACTOR SHALL PROTECT PLANTS FROM DAMAGE DUE TO LANDSCAPE OPERATIONS AND OPERATIONS OF OTHER CONTRACTORS AND TRADES. MAINTAIN PROTECTION AND WATERING DURING INSTALLATION AND MAINTENANCE PERIODS. TREAT, REPAIR, OR REPLACE DAMAGED PLANTINGS TO THE SATISFACTION OF THE LANDSCAPE ARCHITECT.
- 10. TOPSOIL AND ORGANIC MATERIAL SOURCES MUST BE APPROVED BY THE LANDSCAPE ARCHITECT. SEE TECHNICAL SPECIFICATIONS FOR ADDITIONAL REQUIREMENTS AND APPROVALS.
- 11. CONTRACTOR SHALL NOTIFY THE OWNER'S REPRESENTATIVE AND LANDSCAPE ARCHITECT IF UNEXPECTED ROCK OR OBSTRUCTIONS DETRIMENTAL TO TREES OR SHRUBS ARE ENCOUNTERED IN EXCAVATIONS.
- 12. ALL PLANTS SHALL BE GUARANTEED FOR A PERIOD OF TWO YEARS FROM THE DATE OF ACCEPTANCE BY THE OWNER. - REFER TO SPECIFICATIONS
- 13. ALL PLANTING BEDS SHALL RECEIVE A 3" DEPTH OF AGED DOUBLE GROUND, SHREDDED HARDWOOD BARK MULCH. SUBMIT SAMPLE TO LANDSCAPE ARCHITECT FOR APPROVAL.

FOR ADDITIONAL REQUIREMENTS.

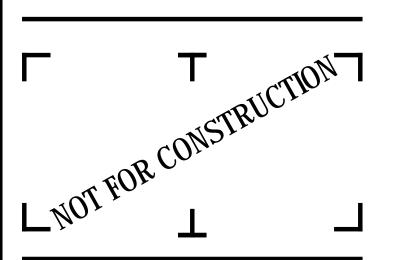
PLANT, SOIL, MULCH AND INSTALLATION REQUIREMENTS.



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### Bayer Landscape Architecture, PLLC

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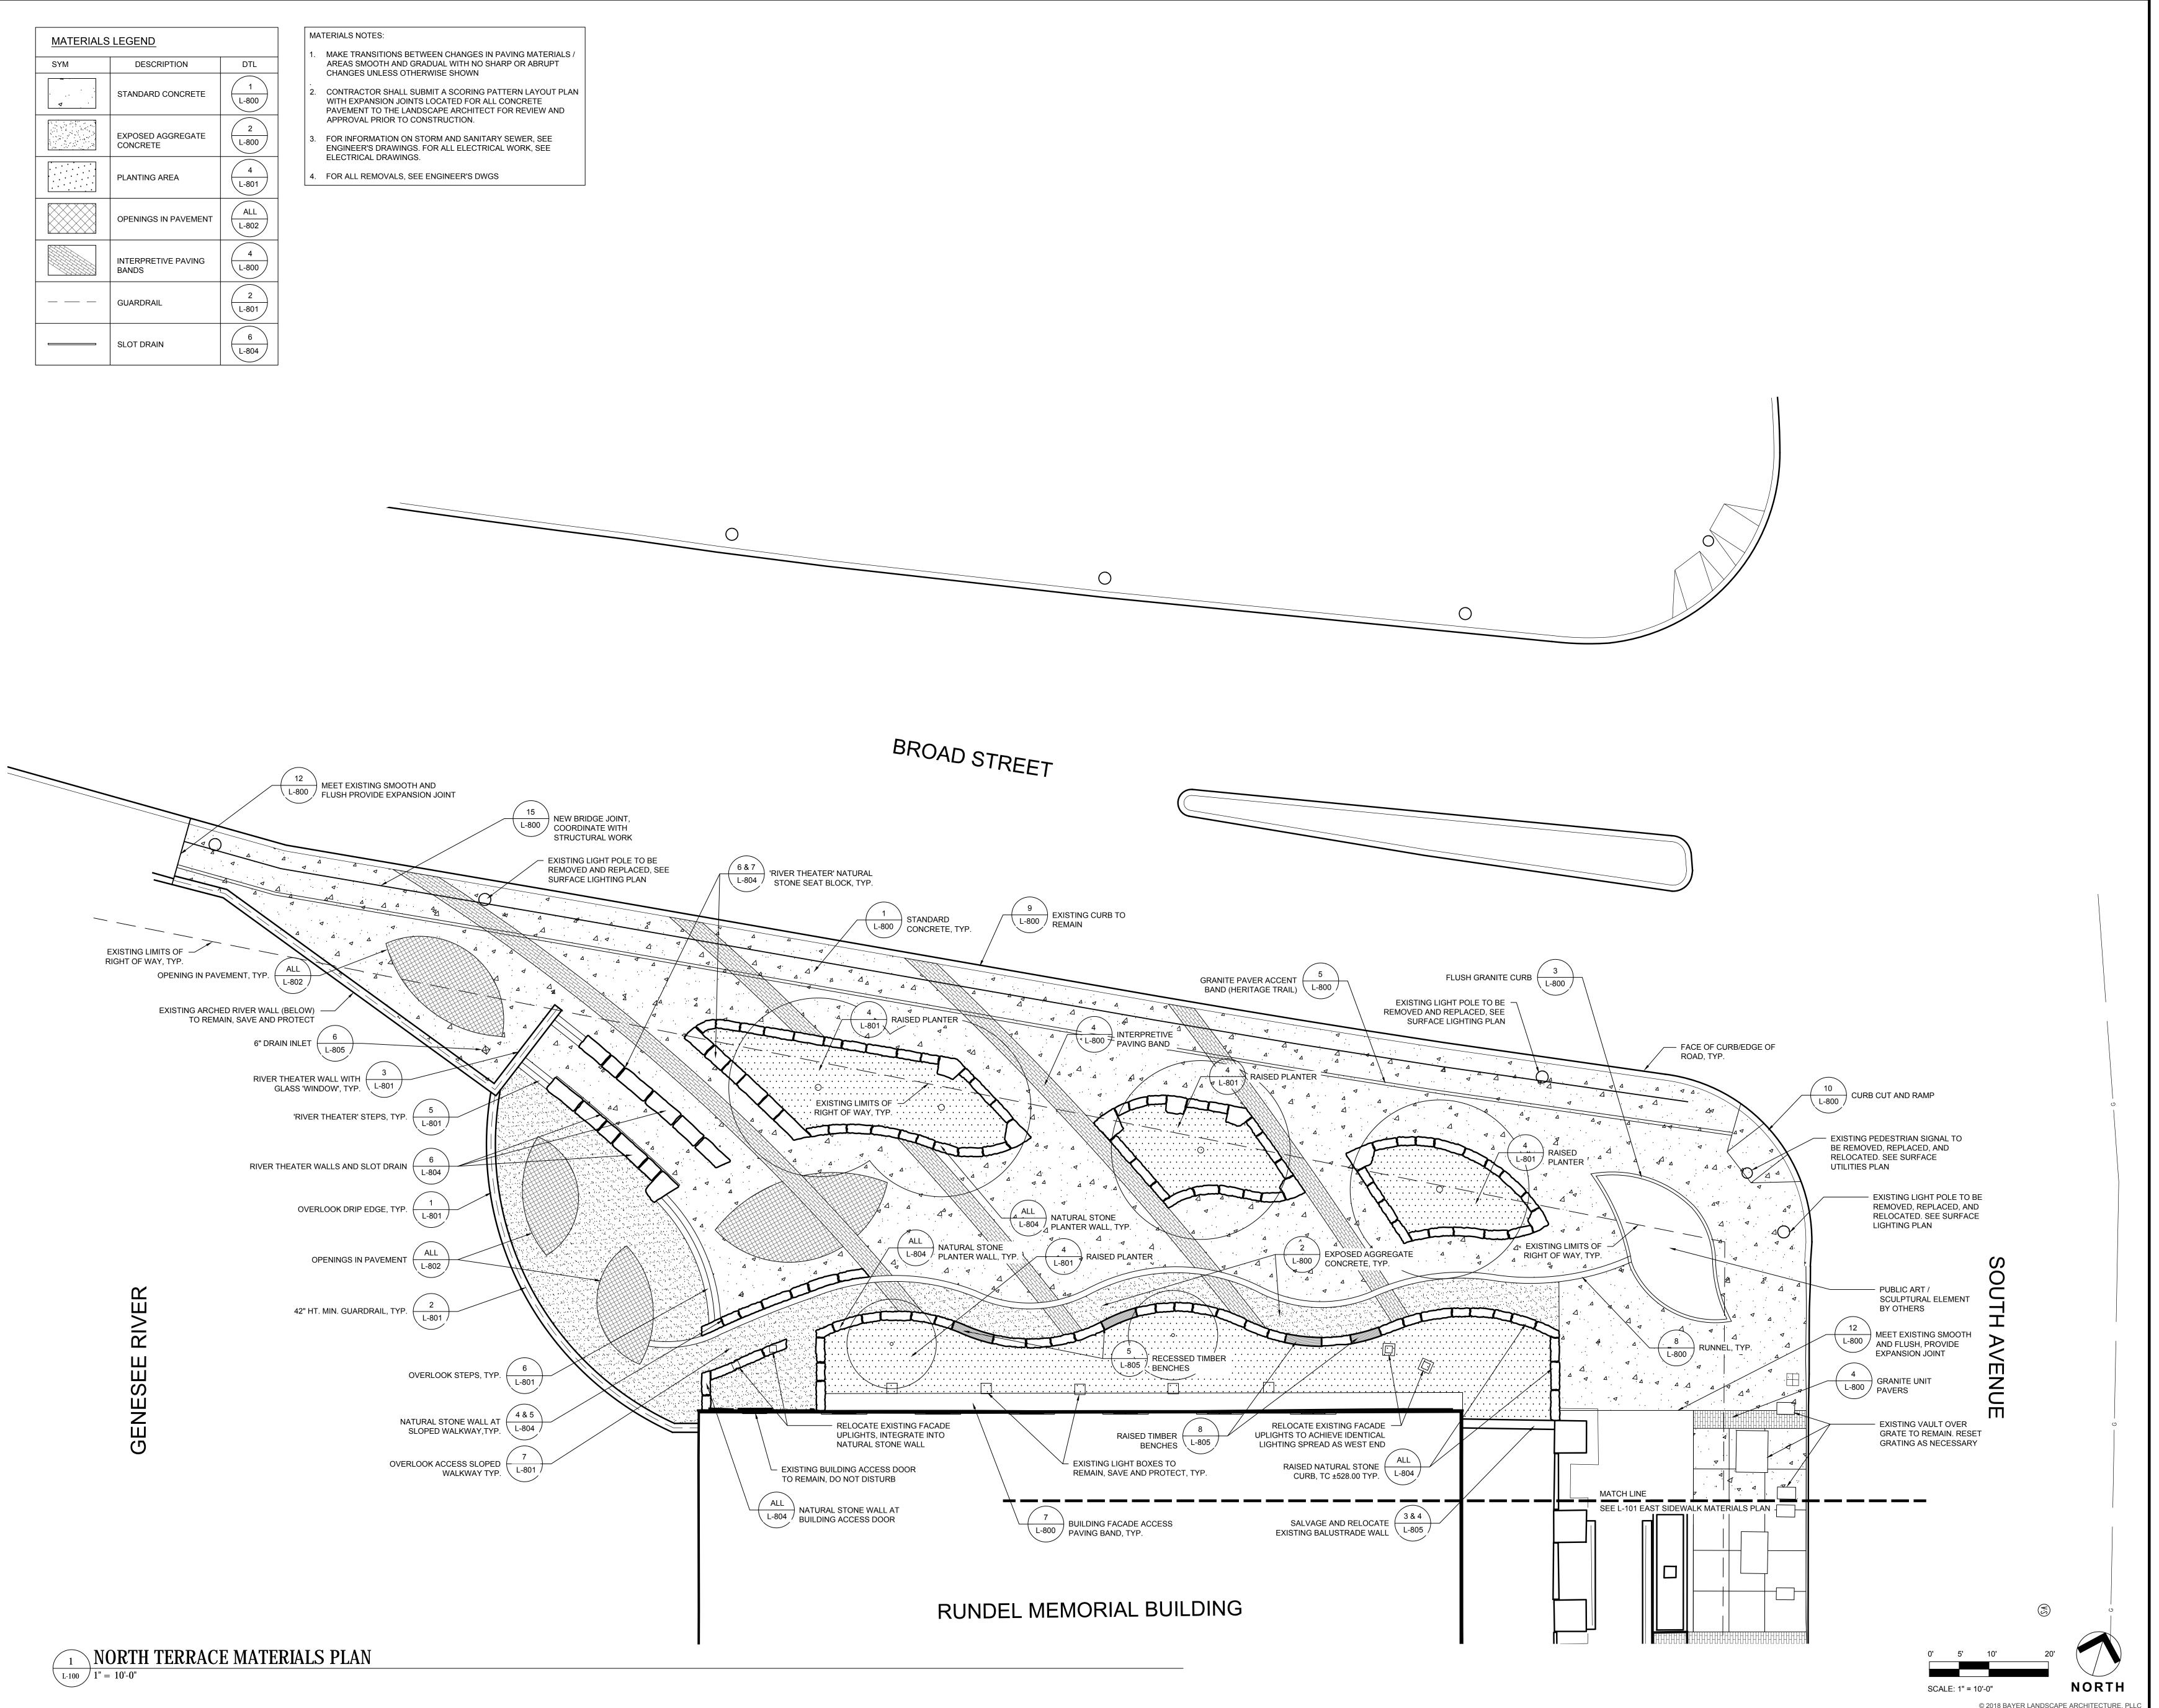
414 ANDREWS STREET ROCHESTER, NY 14604

RUNDEL LIBRARY PHASE IV

115 SOUTH AVE. ROCHESTER, NY 14604

NO: DATE: PROJECT NUMBER: 2170391 DRAWN BY: REVIEWED BY: 35% PRELIMINARY DESIGN

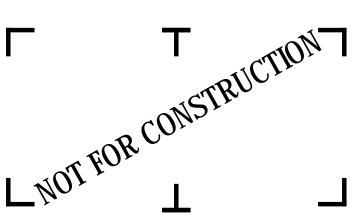
> **NORTH TERRACE GENERAL NOTES**, ABBREVIATIONS, AND LEGEND





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CITY OF ROCHESTER

414 ANDREWS STREET
ROCHESTER, NY 14604

RUNDEL LIBRARY PHASE IV

ROCHESTER, NY 14604

NO: DATE: DESCRIPTION:

Revisions

PROJECT NUMBER:

2170391

DRAWN BY: JJR / DPZ

REVIEWED BY: MHB

ISSUED FOR:

35% PRELIMINARY DESIGN

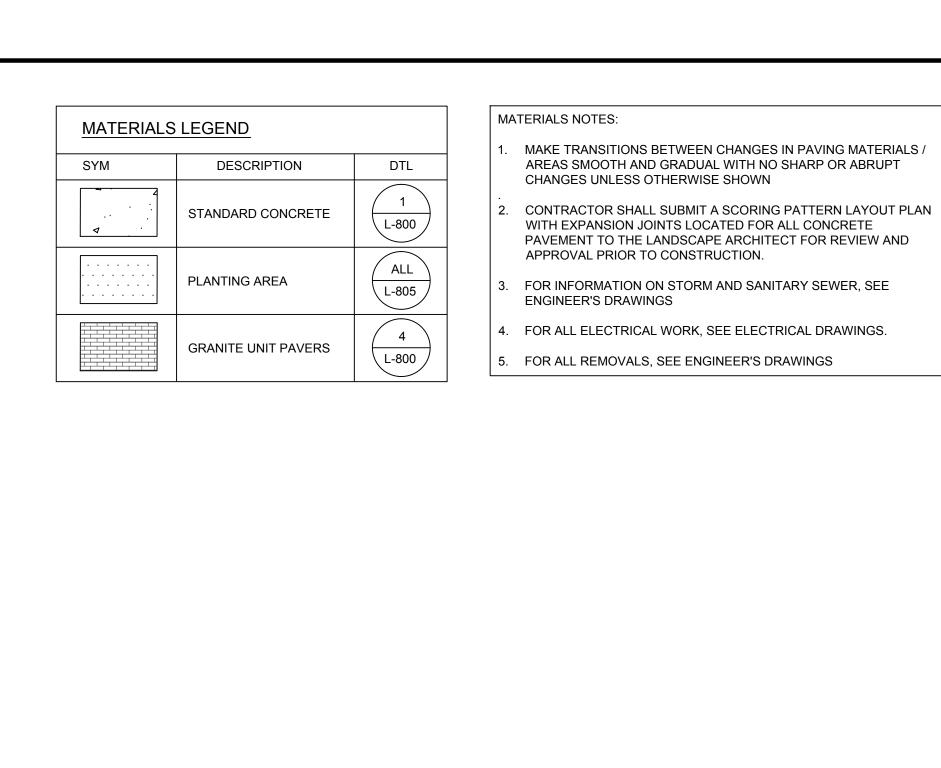
DATE:

JULY 2018

NORTH TERRACE MATERIALS PLAN

DRAWING NUMBER:

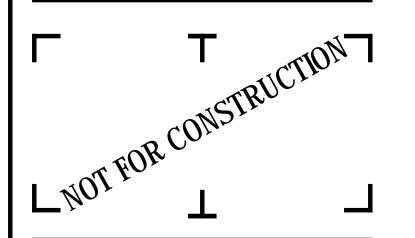
DRAWING NAME:





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CITY OF ROCHESTER
414 ANDREWS STREET
ROCHESTER, NY 14604

RUNDEL LIBRARY PHASE IV 115 SOUTH AVE.

ROCHESTER, NY 14604

NO: DATE: DESCRIPTION:

Revisions

PROJECT NUMBER:

2170391

DRAWN BY: JJR / DPZ

REVIEWED BY: MHB

ISSUED FOR:

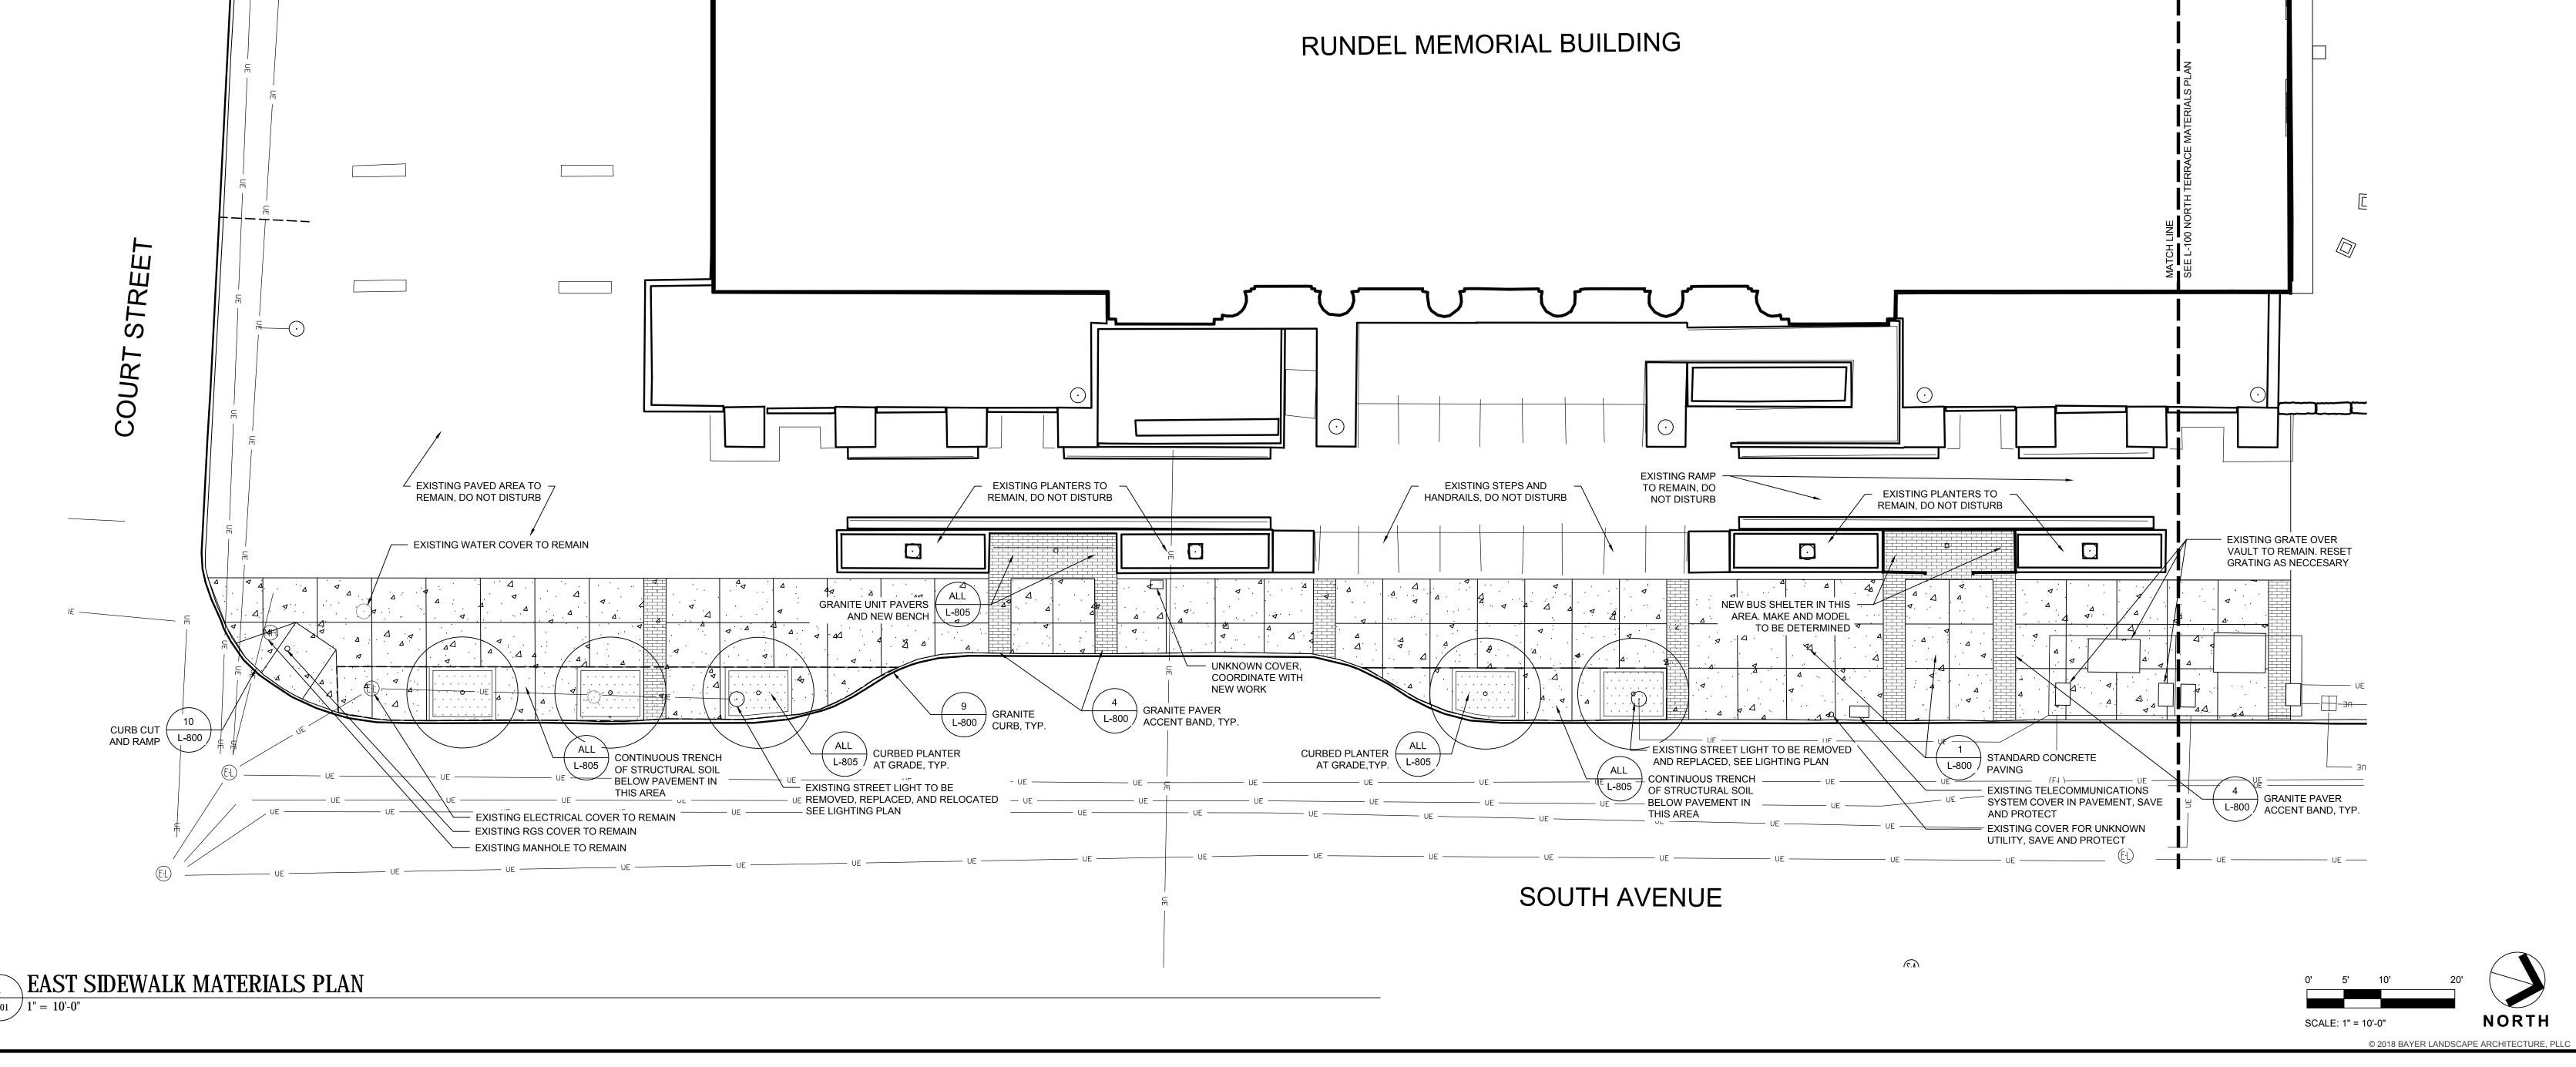
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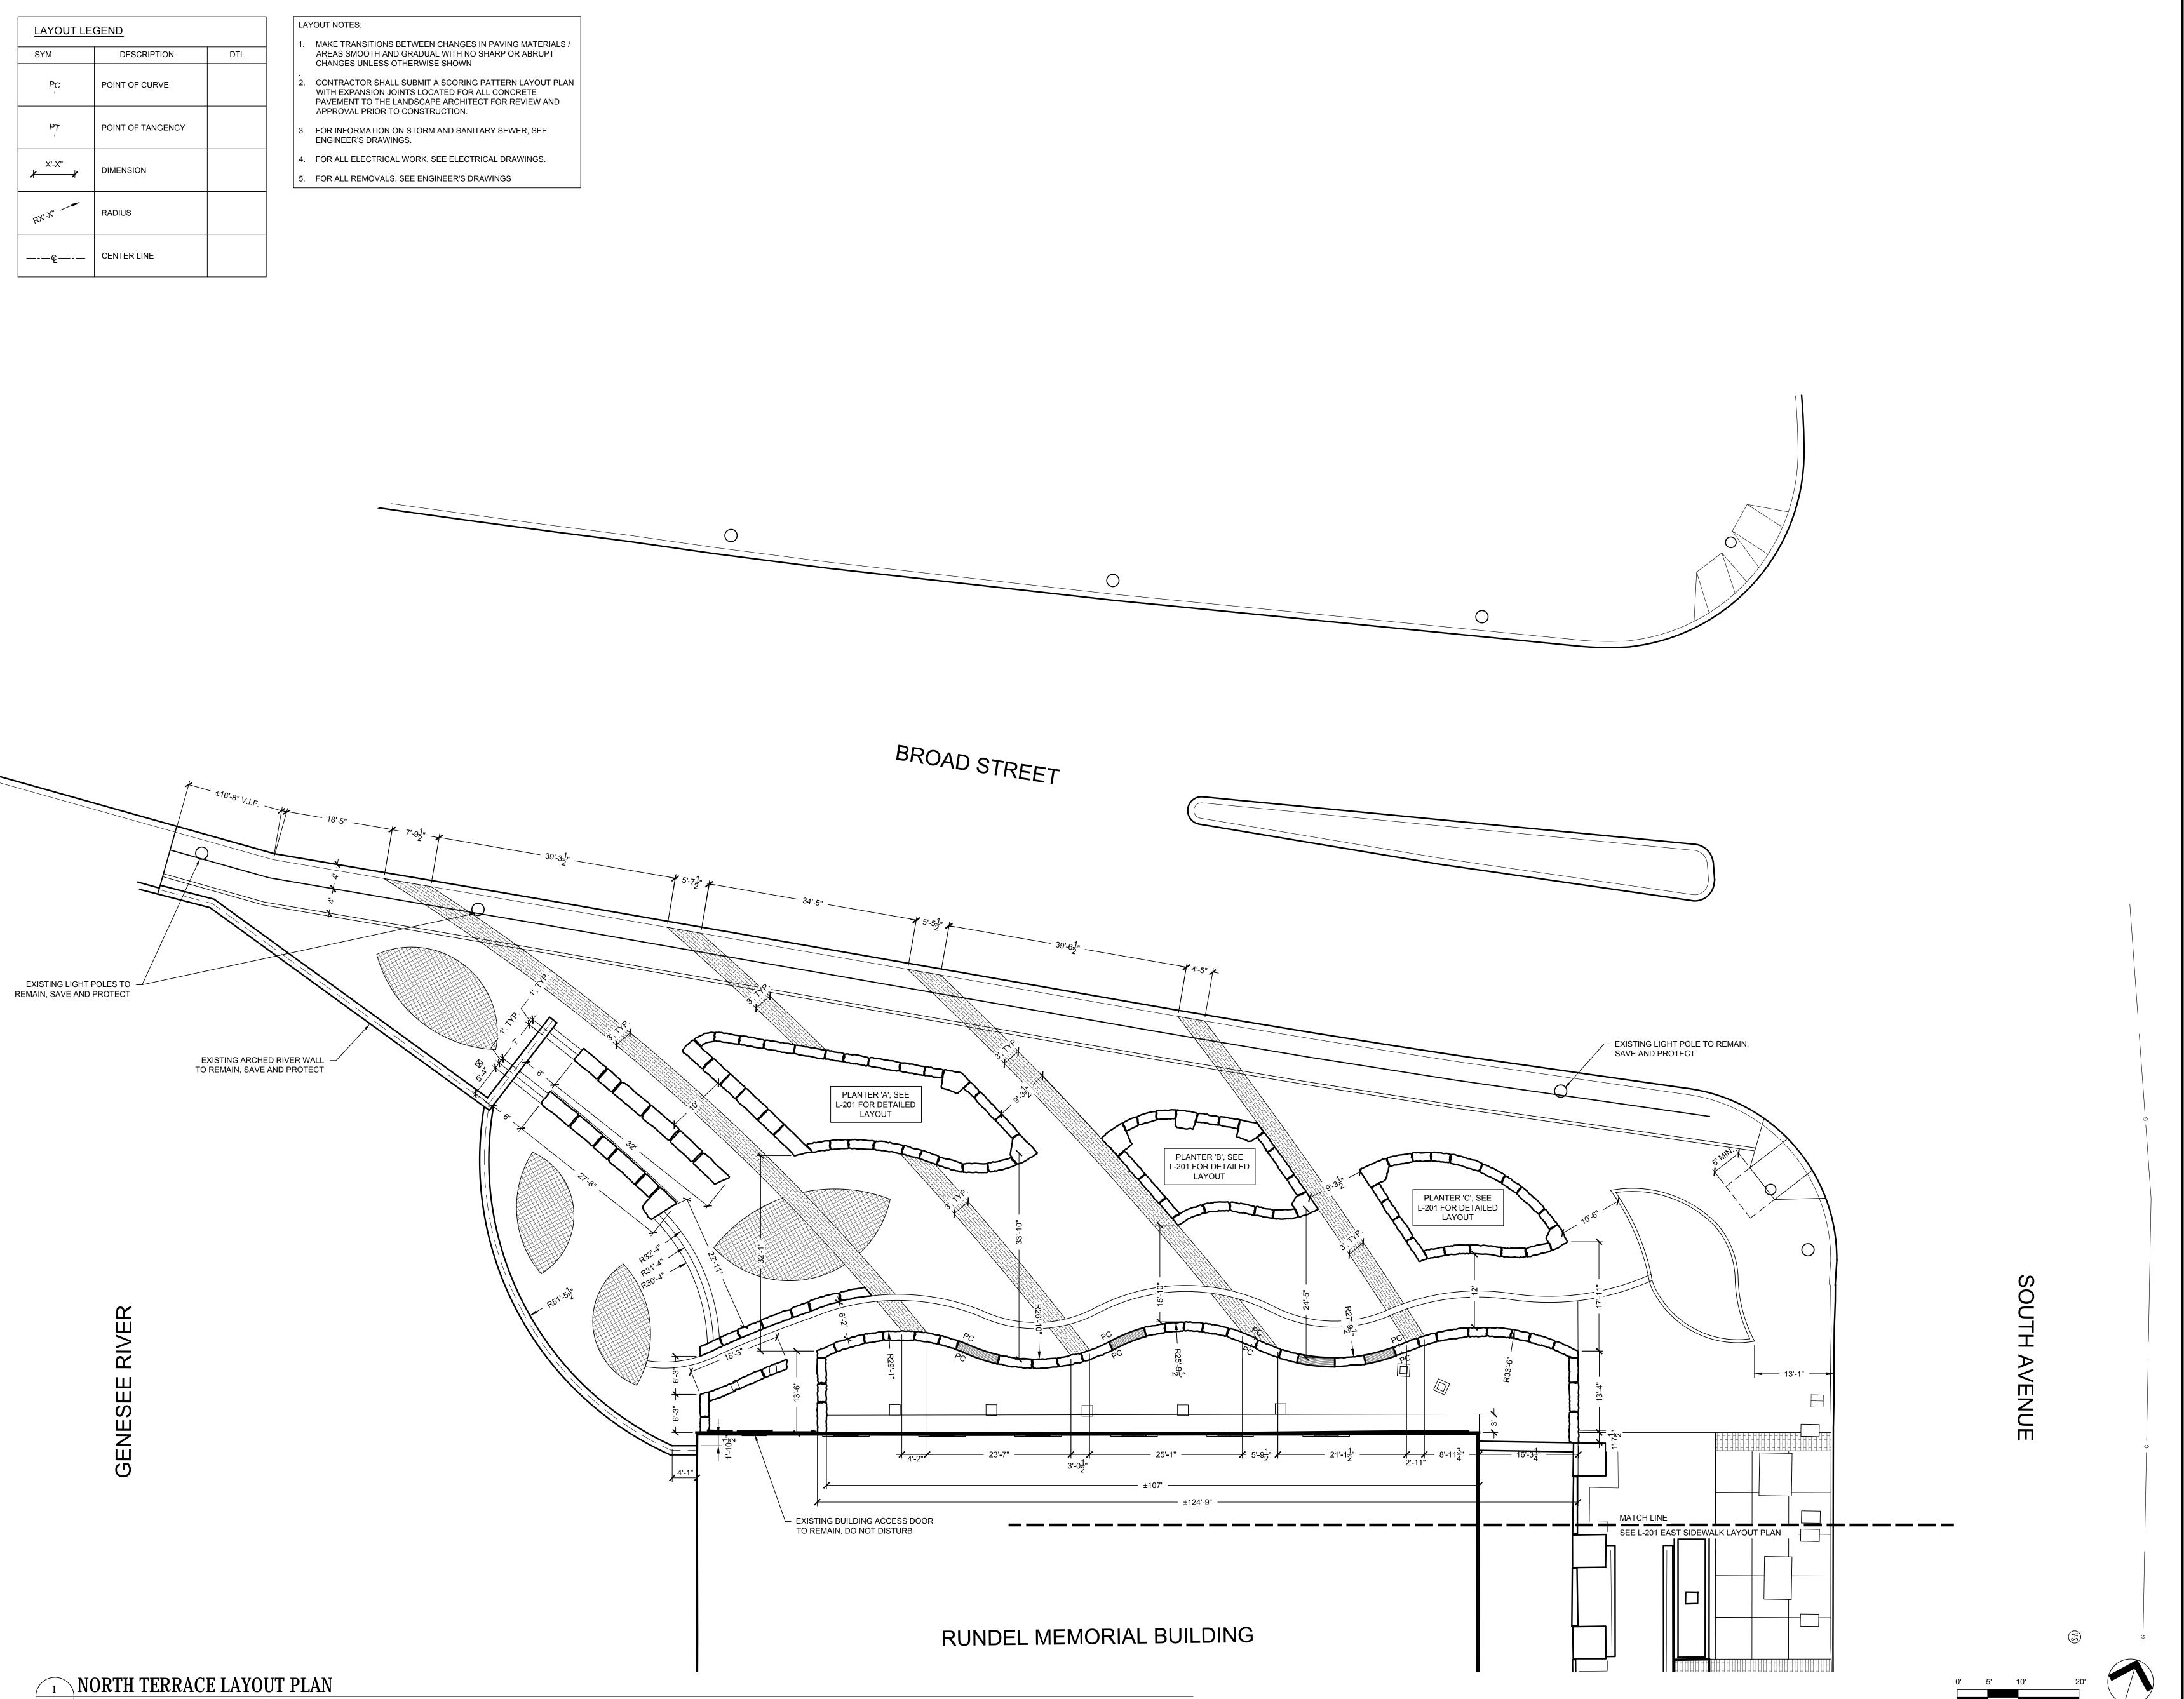
35% PRELIMINARY DESIG

DRAWING NAME:

EAST SIDEWALK
MATERIALS PLAN

DRAWING NUMBER:

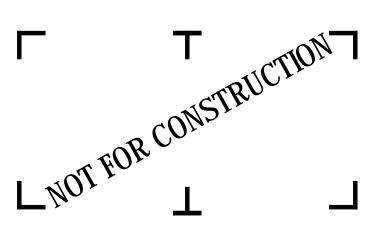






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414 ANDREWS STREET
ROCHESTER, NY 14604

RUNDEL LIBRARY PHASE IV 115 SOUTH AVE.

ROCHESTER, NY 14604

NO: DATE: DESCRIPTION:

Revisions

PROJECT NUMBER:

2170391

DRAWN BY: JJR / DPZ

REVIEWED BY: MHB

ISSUED FOR:

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DATE: JULY 2018

DRAWING NAME:

NORTH TERRACE LAYOUT PLAN

DRAWING NUMBER:

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LAYOUT LE	<u>GEND</u>	
SYM	DESCRIPTION	DTL
PC 1	POINT OF CURVE	
PT I	POINT OF TANGENCY	
X'-X"	DIMENSION	
RX-X"	RADIUS	
<u>-</u>	CENTER LINE	
ALIGN	ALIGN	

# LAYOUT NOTES:

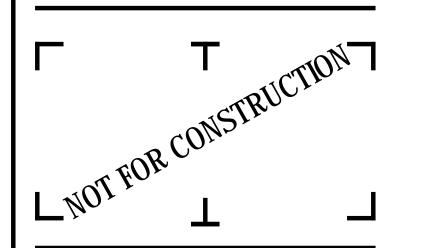
- MAKE TRANSITIONS BETWEEN CHANGES IN PAVING MATERIALS / AREAS SMOOTH AND GRADUAL WITH NO SHARP OR ABRUPT CHANGES UNLESS OTHERWISE SHOWN
- CONTRACTOR SHALL SUBMIT A SCORING PATTERN LAYOUT PLAN WITH EXPANSION JOINTS LOCATED FOR ALL CONCRETE PAVEMENT TO THE LANDSCAPE ARCHITECT FOR REVIEW AND APPROVAL PRIOR TO CONSTRUCTION.
- FOR INFORMATION ON STORM AND SANITARY SEWER, SEE ENGINEER'S DRAWINGS.
- 5. FOR ALL REMOVALS, SEE ENGINEER'S DRAWINGS

4. FOR ALL ELECTRICAL WORK, SEE ELECTRICAL DRAWINGS.

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RUNDEL LIBRARY PHASE IV 115 SOUTH AVE.

ROCHESTER, NY 14604

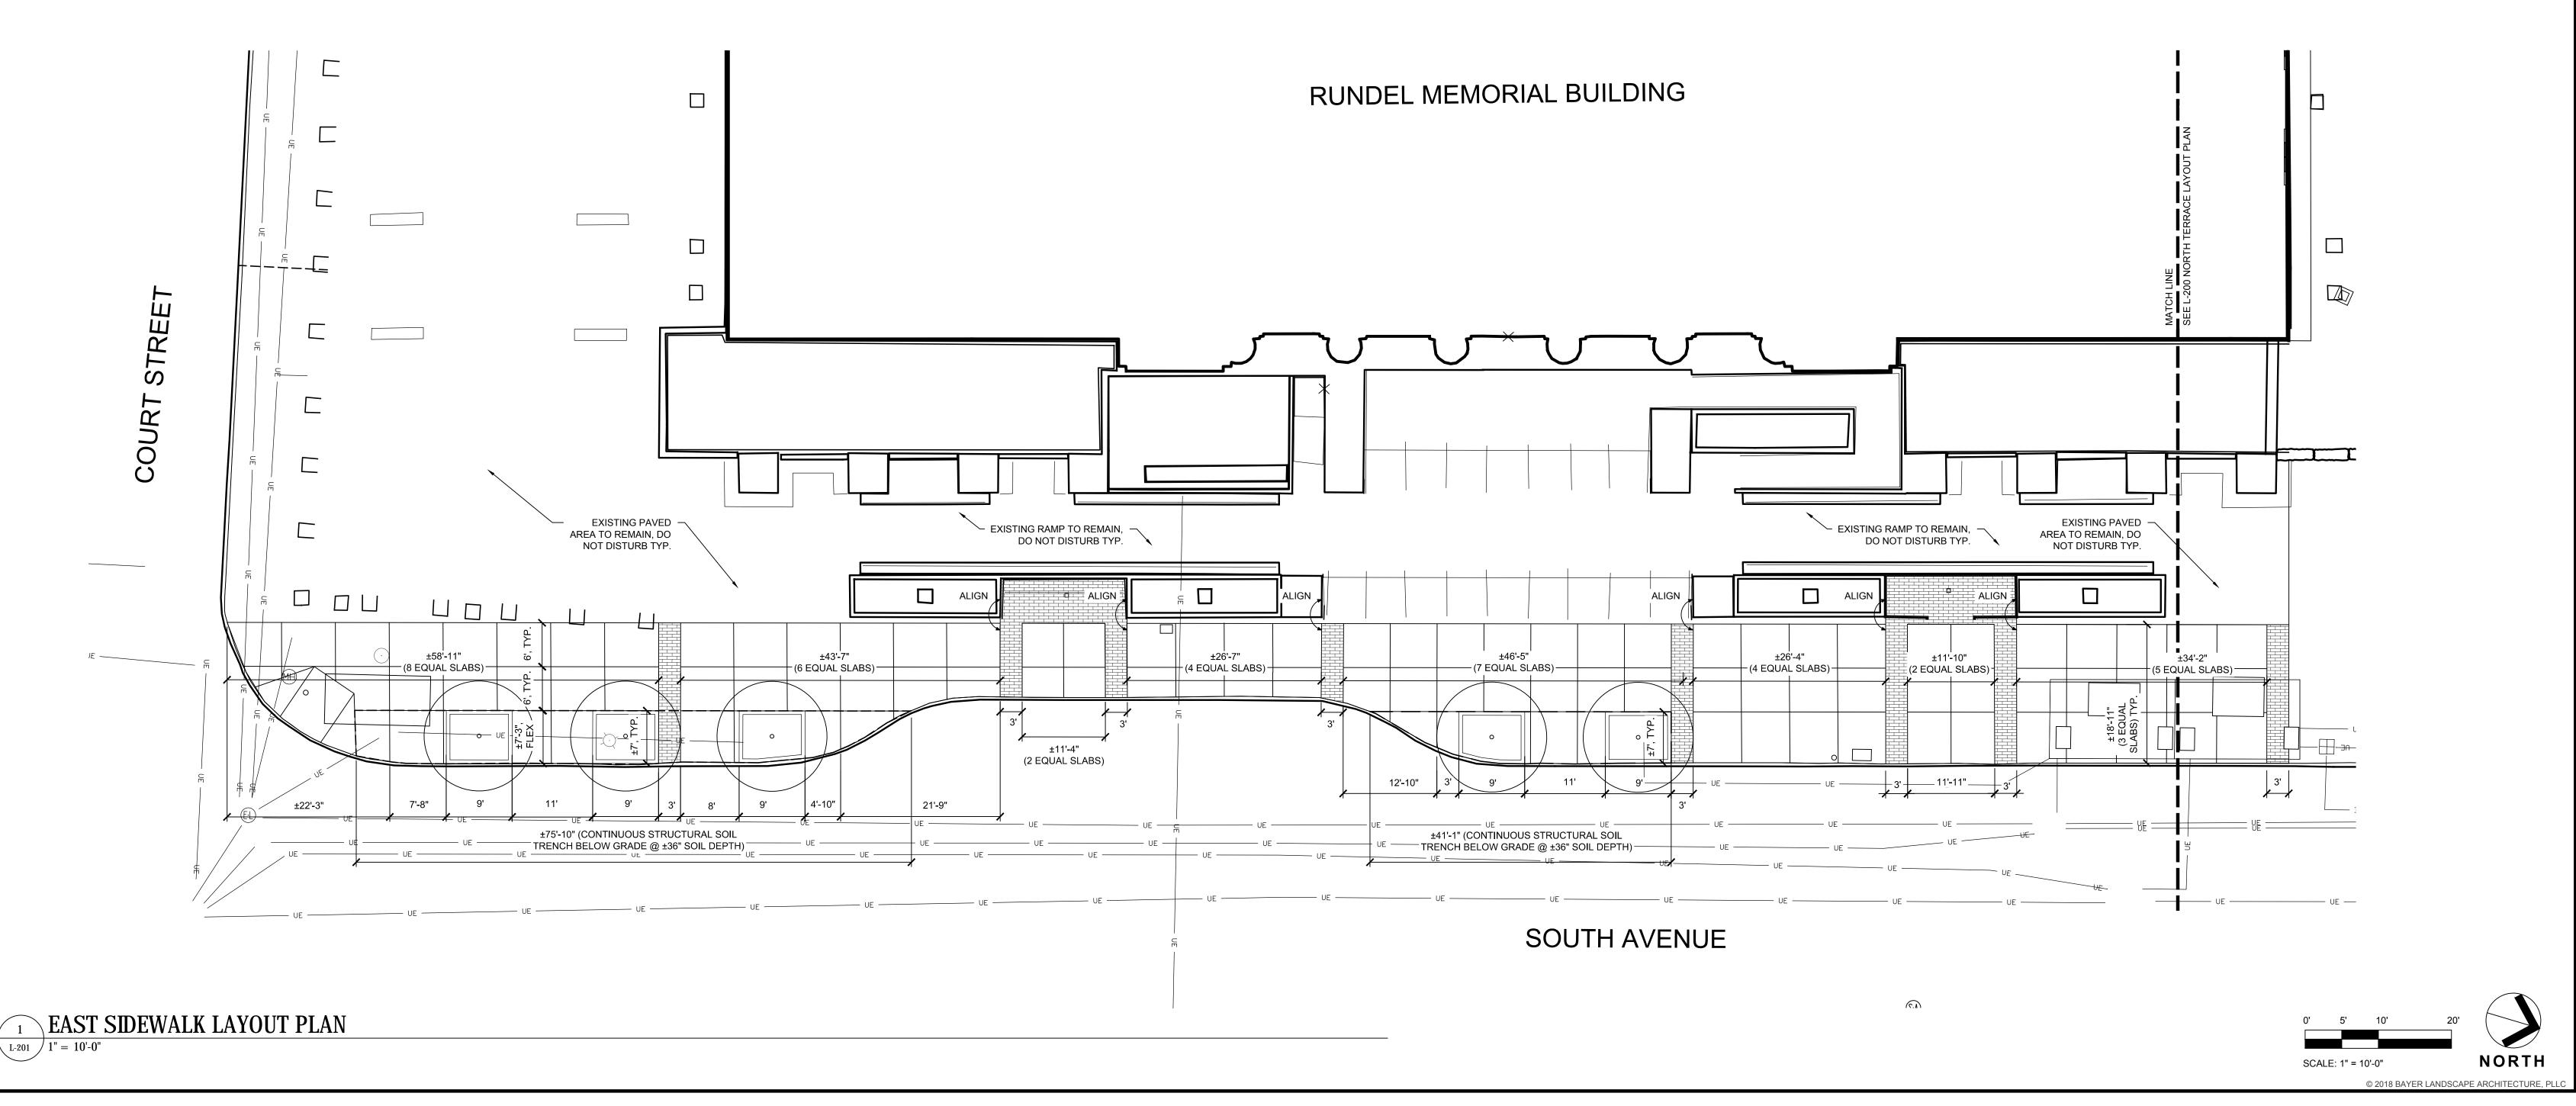
NO: DATE: PROJECT NUMBER: 2170391 DRAWN BY: JJR / DPZ

35% PRELIMINARY DESIGN

DRAWING NAME:

**EAST SIDEWALK LAYOUT PLAN** 

DRAWING NUMBER:

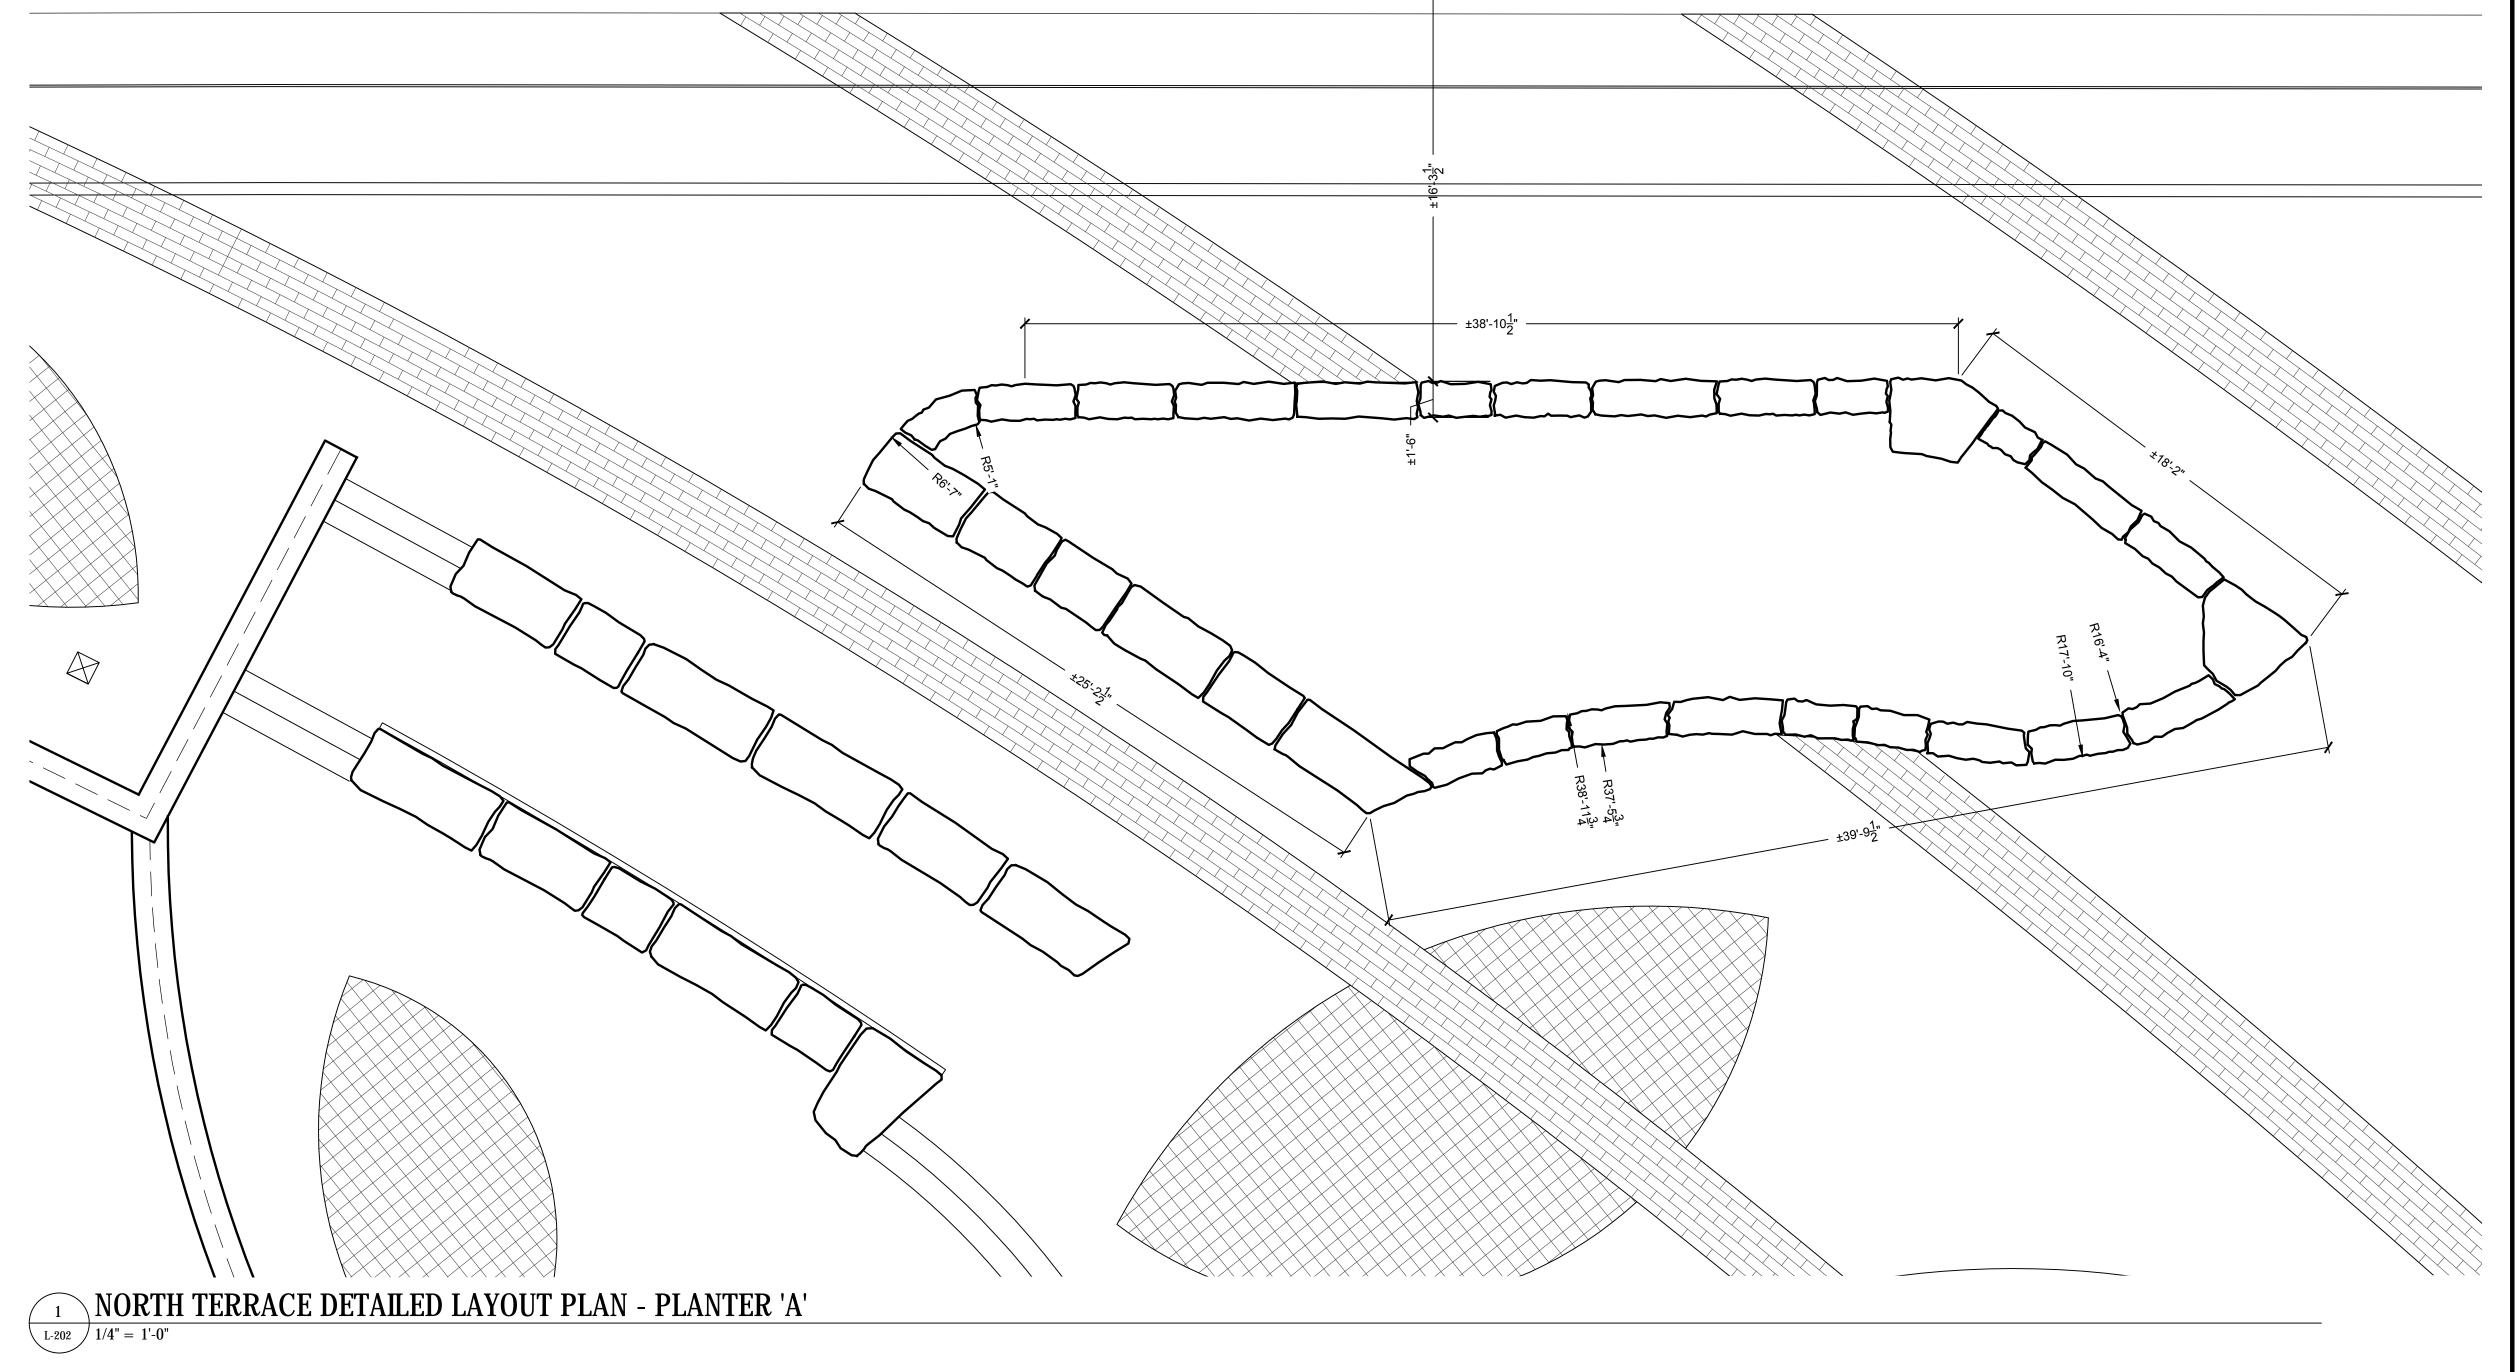


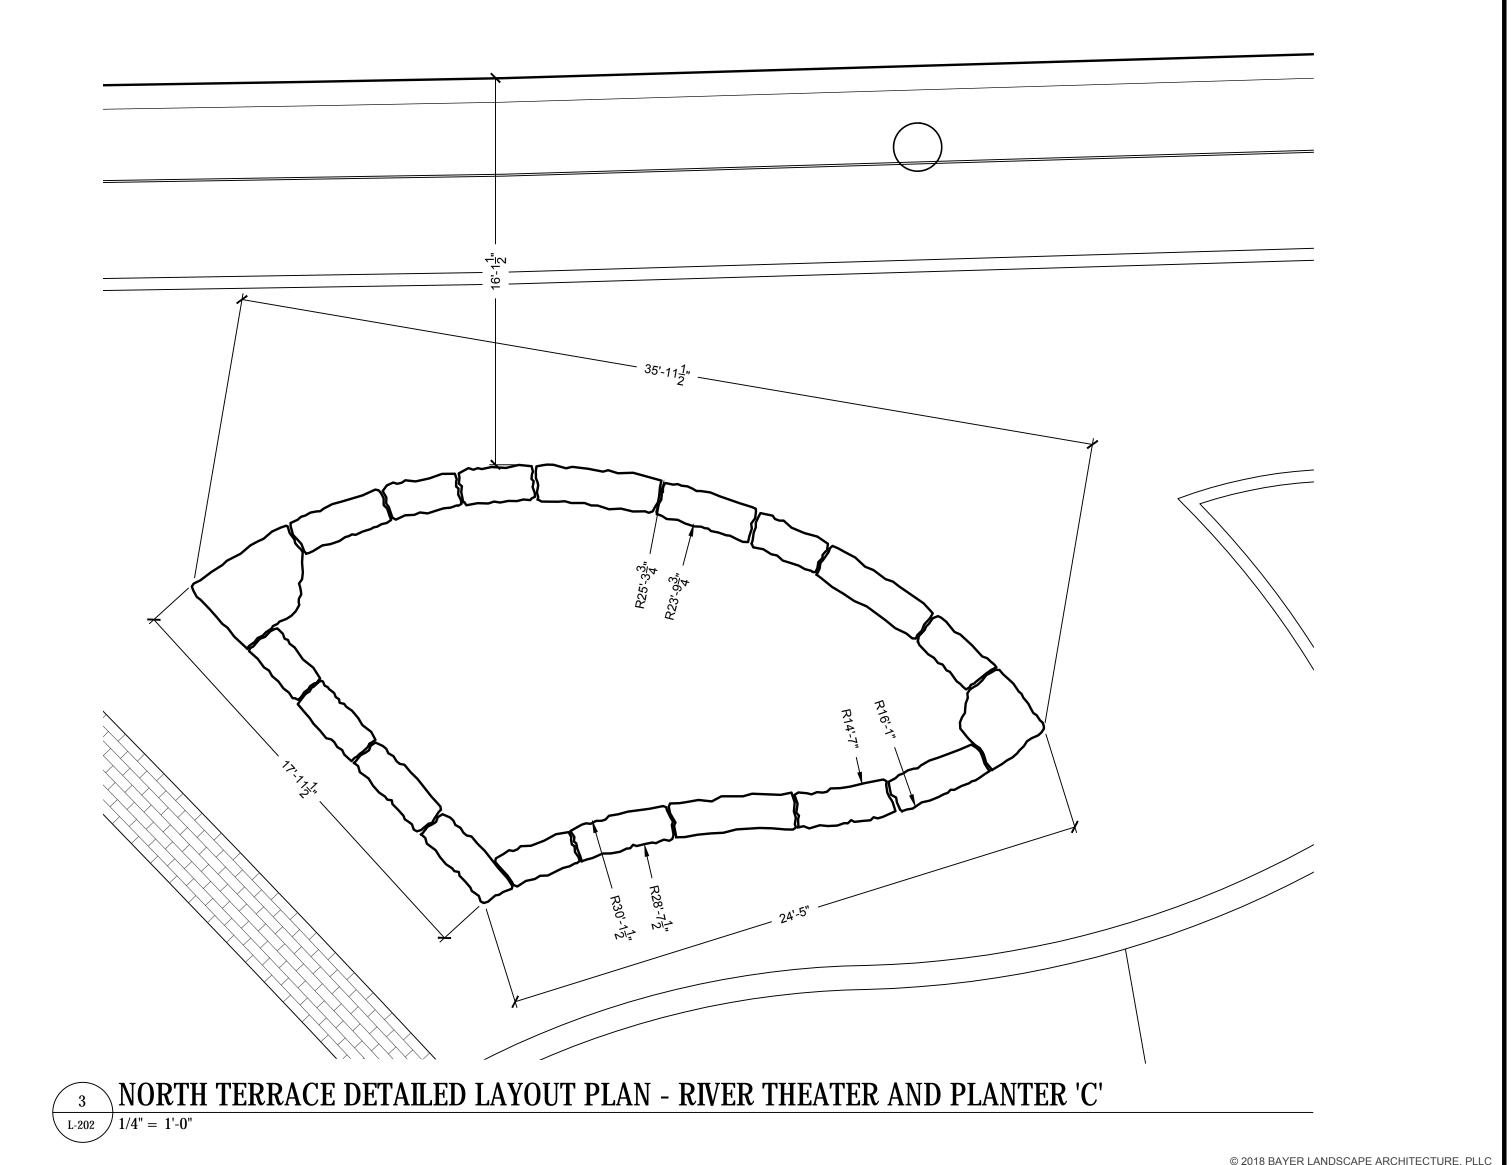
LAYOUT LE	<u>EGEND</u>	
SYM	DESCRIPTION	DTL
PC	POINT OF CURVE	
PT '	POINT OF TANGENCY	
X'-X"	DIMENSION	
RX-X"	RADIUS	
<u>-</u>	CENTER LINE	

### LAYOUT NOTES:

MAKE TRANSITIONS BETWEEN CHANGES IN PAVING MATERIALS / AREAS SMOOTH AND GRADUAL WITH NO SHARP OR ABRUPT CHANGES UNLESS OTHERWISE SHOWN

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- 5. FOR ALL REMOVALS, SEE ENGINEER'S DRAWINGS.



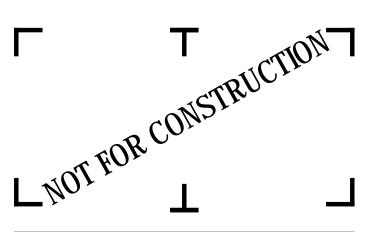




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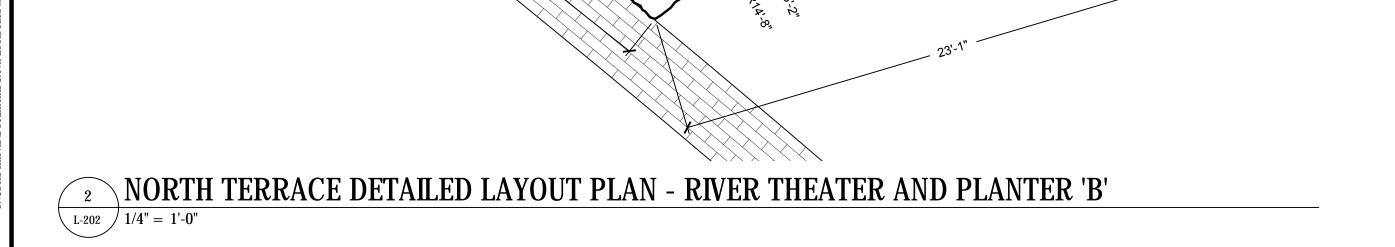
# CITY OF ROCHESTER 414 ANDREWS STREET ROCHESTER, NY 14604

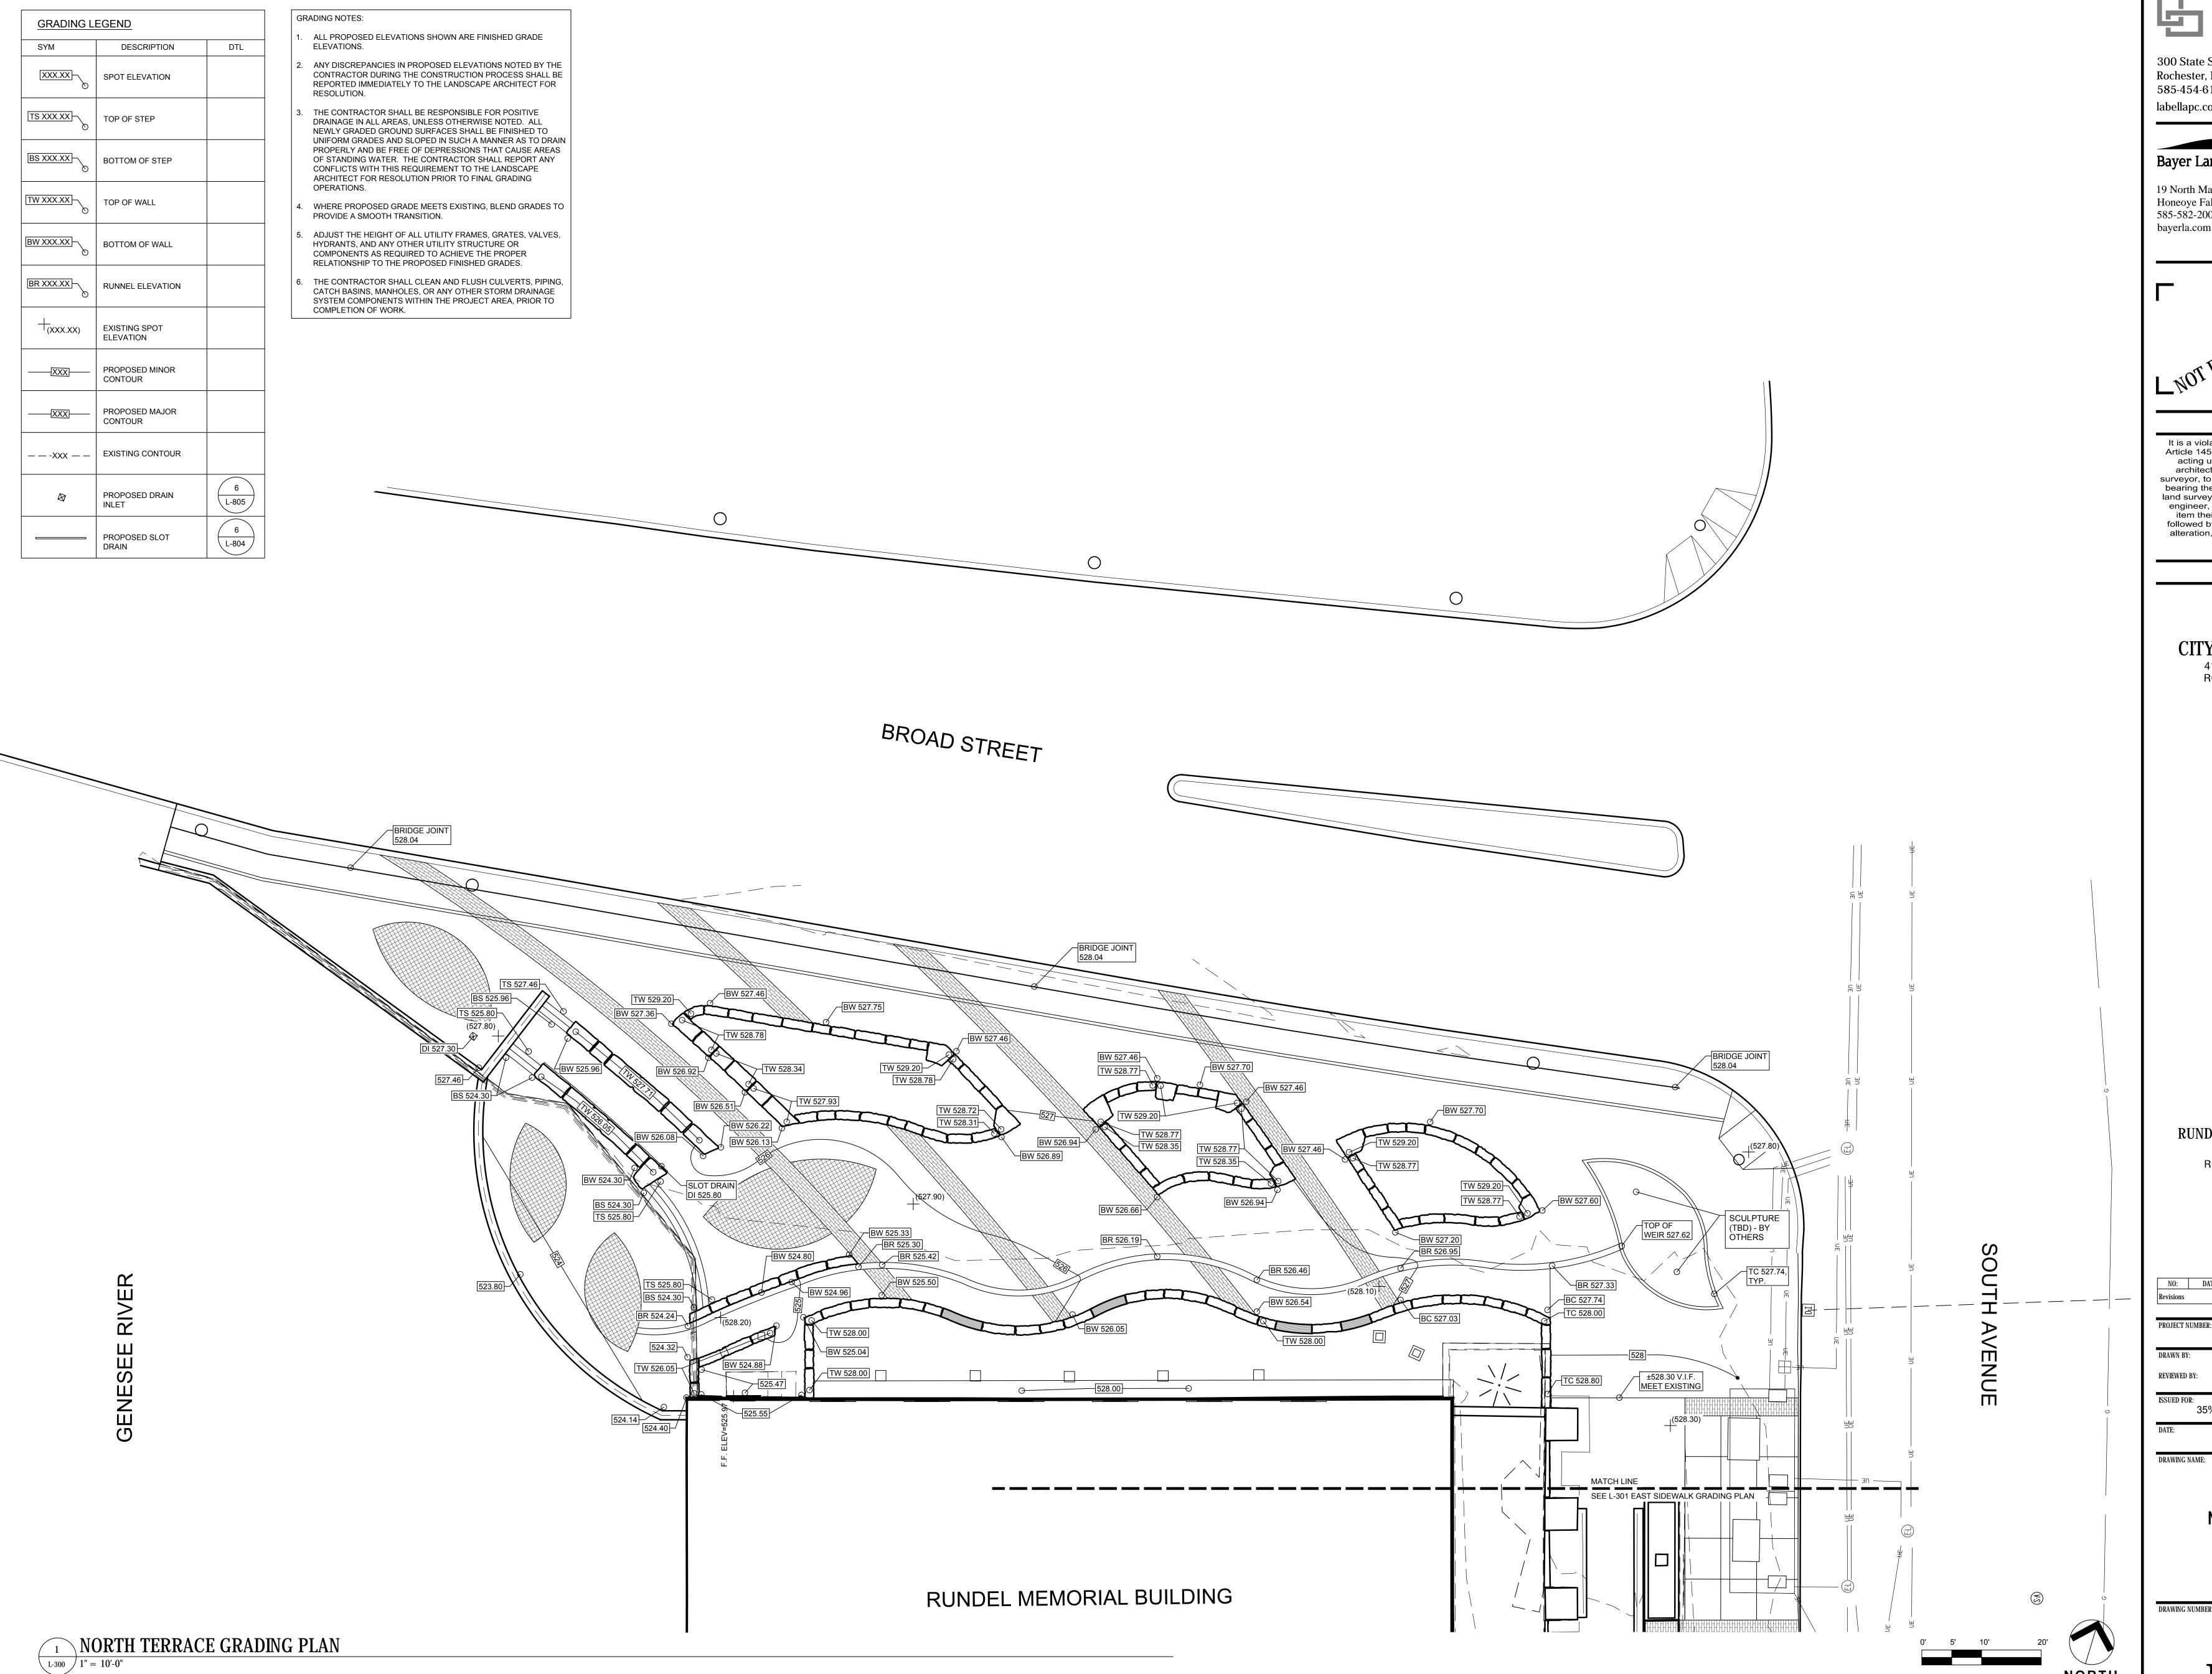
RUNDEL LIBRARY PHASE IV 115 SOUTH AVE. ROCHESTER, NY 14604

NO:	DATE:	DESCRIPTION:
Revisions		
PROJECT N	UMBER:	2170391
DRAWN BY:		JJR / DPZ
REVIEWED 1	BY:	МНВ
ISSUED FOR		RELIMINARY DESIGN
DATE:		JULY 2018

NORTH TERRACE
DETAILED LAYOUT PLANS

DRAWING NUMBER:

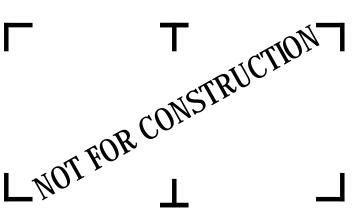






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RUNDEL LIBRARY PHASE IV 115 SOUTH AVE.

ROCHESTER, NY 14604

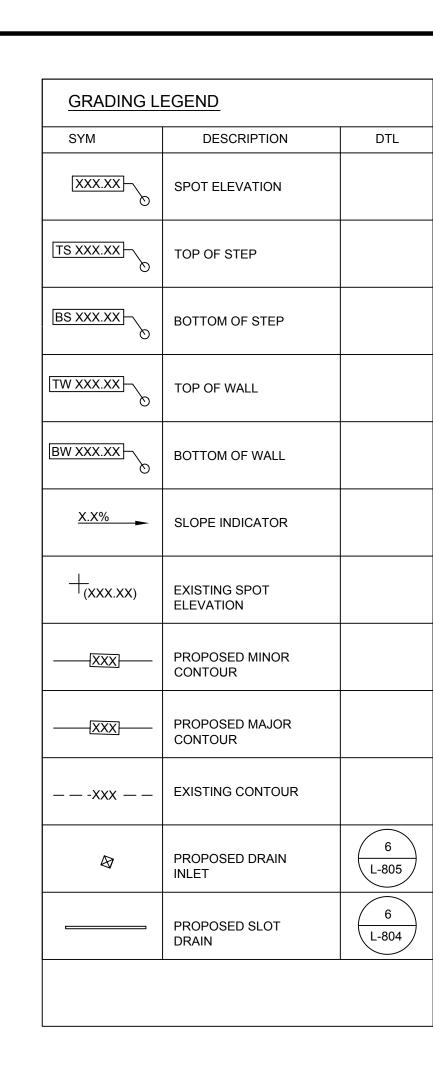
2170391 35% PRELIMINARY DESIGN

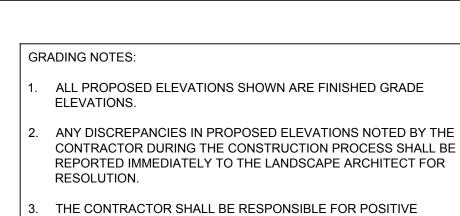
**NORTH TERRACE** 

**GRADING PLAN** 

DRAWING NUMBER:

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- DRAINAGE IN ALL AREAS, UNLESS OTHERWISE NOTED. ALL NEWLY GRADED GROUND SURFACES SHALL BE FINISHED TO UNIFORM GRADES AND SLOPED IN SUCH A MANNER AS TO DRAIN PROPERLY AND BE FREE OF DEPRESSIONS THAT CAUSE AREAS OF STANDING WATER. THE CONTRACTOR SHALL REPORT ANY CONFLICTS WITH THIS REQUIREMENT TO THE LANDSCAPE ARCHITECT FOR RESOLUTION PRIOR TO FINAL GRADING
- WHERE PROPOSED GRADE MEETS EXISTING, BLEND GRADES TO PROVIDE A SMOOTH TRANSITION.

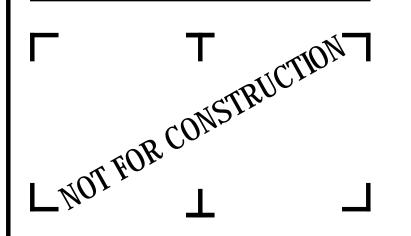
OPERATIONS.

- ADJUST THE HEIGHT OF ALL UTILITY FRAMES, GRATES, VALVES, HYDRANTS, AND ANY OTHER UTILITY STRUCTURE OR COMPONENTS AS REQUIRED TO ACHIEVE THE PROPER RELATIONSHIP TO THE PROPOSED FINISHED GRADES.
- THE CONTRACTOR SHALL CLEAN AND FLUSH CULVERTS, PIPING, CATCH BASINS, MANHOLES, OR ANY OTHER STORM DRAINAGE SYSTEM COMPONENTS WITHIN THE PROJECT AREA, PRIOR TO COMPLETION OF WORK.

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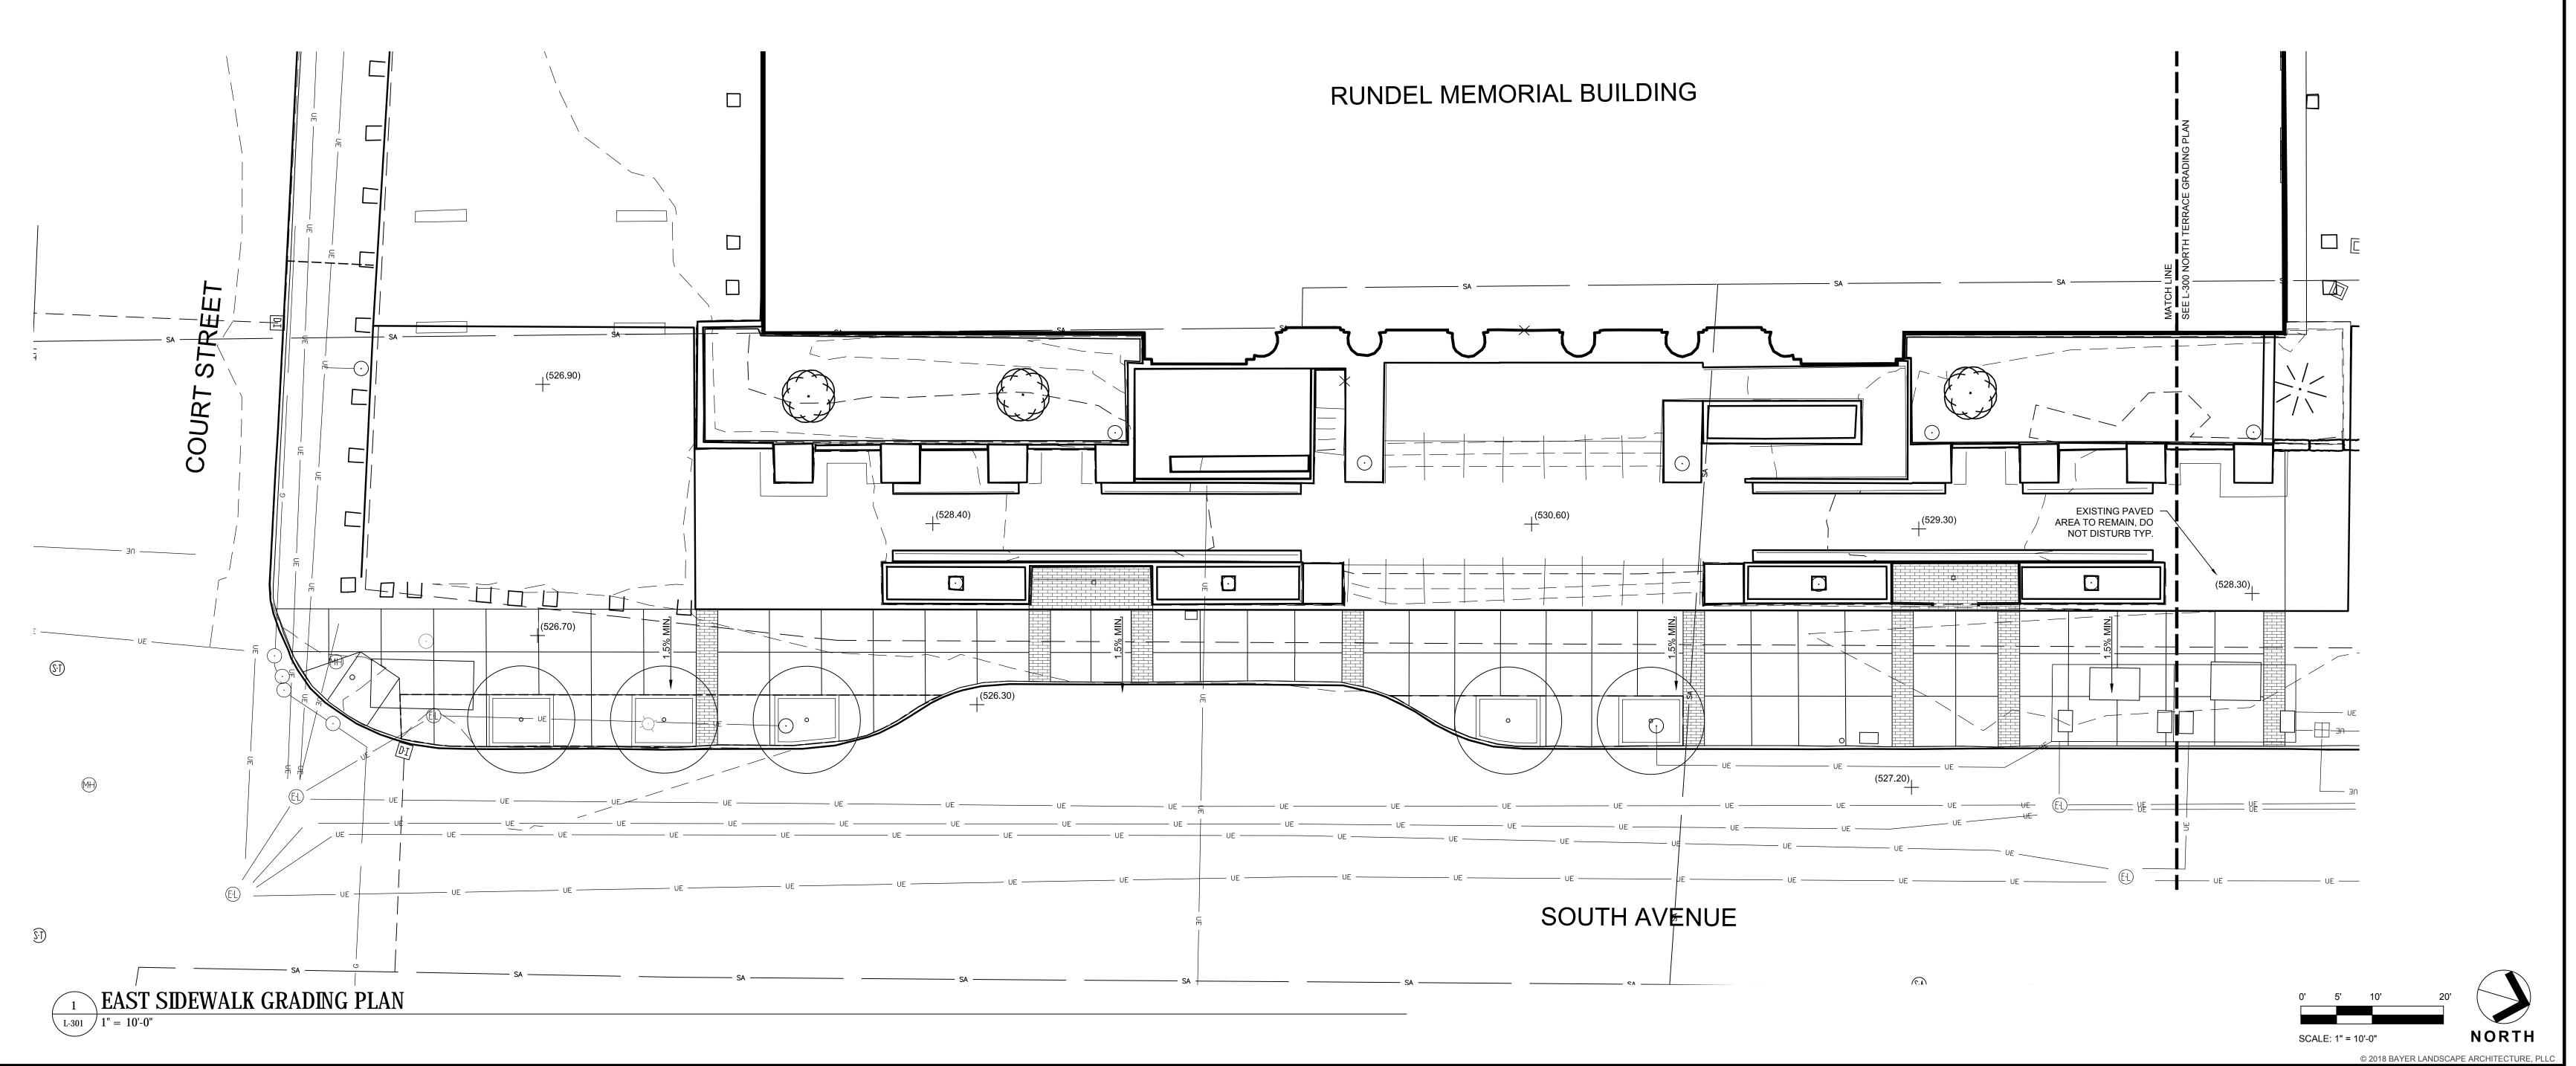
RUNDEL LIBRARY PHASE IV 115 SOUTH AVE. ROCHESTER, NY 14604

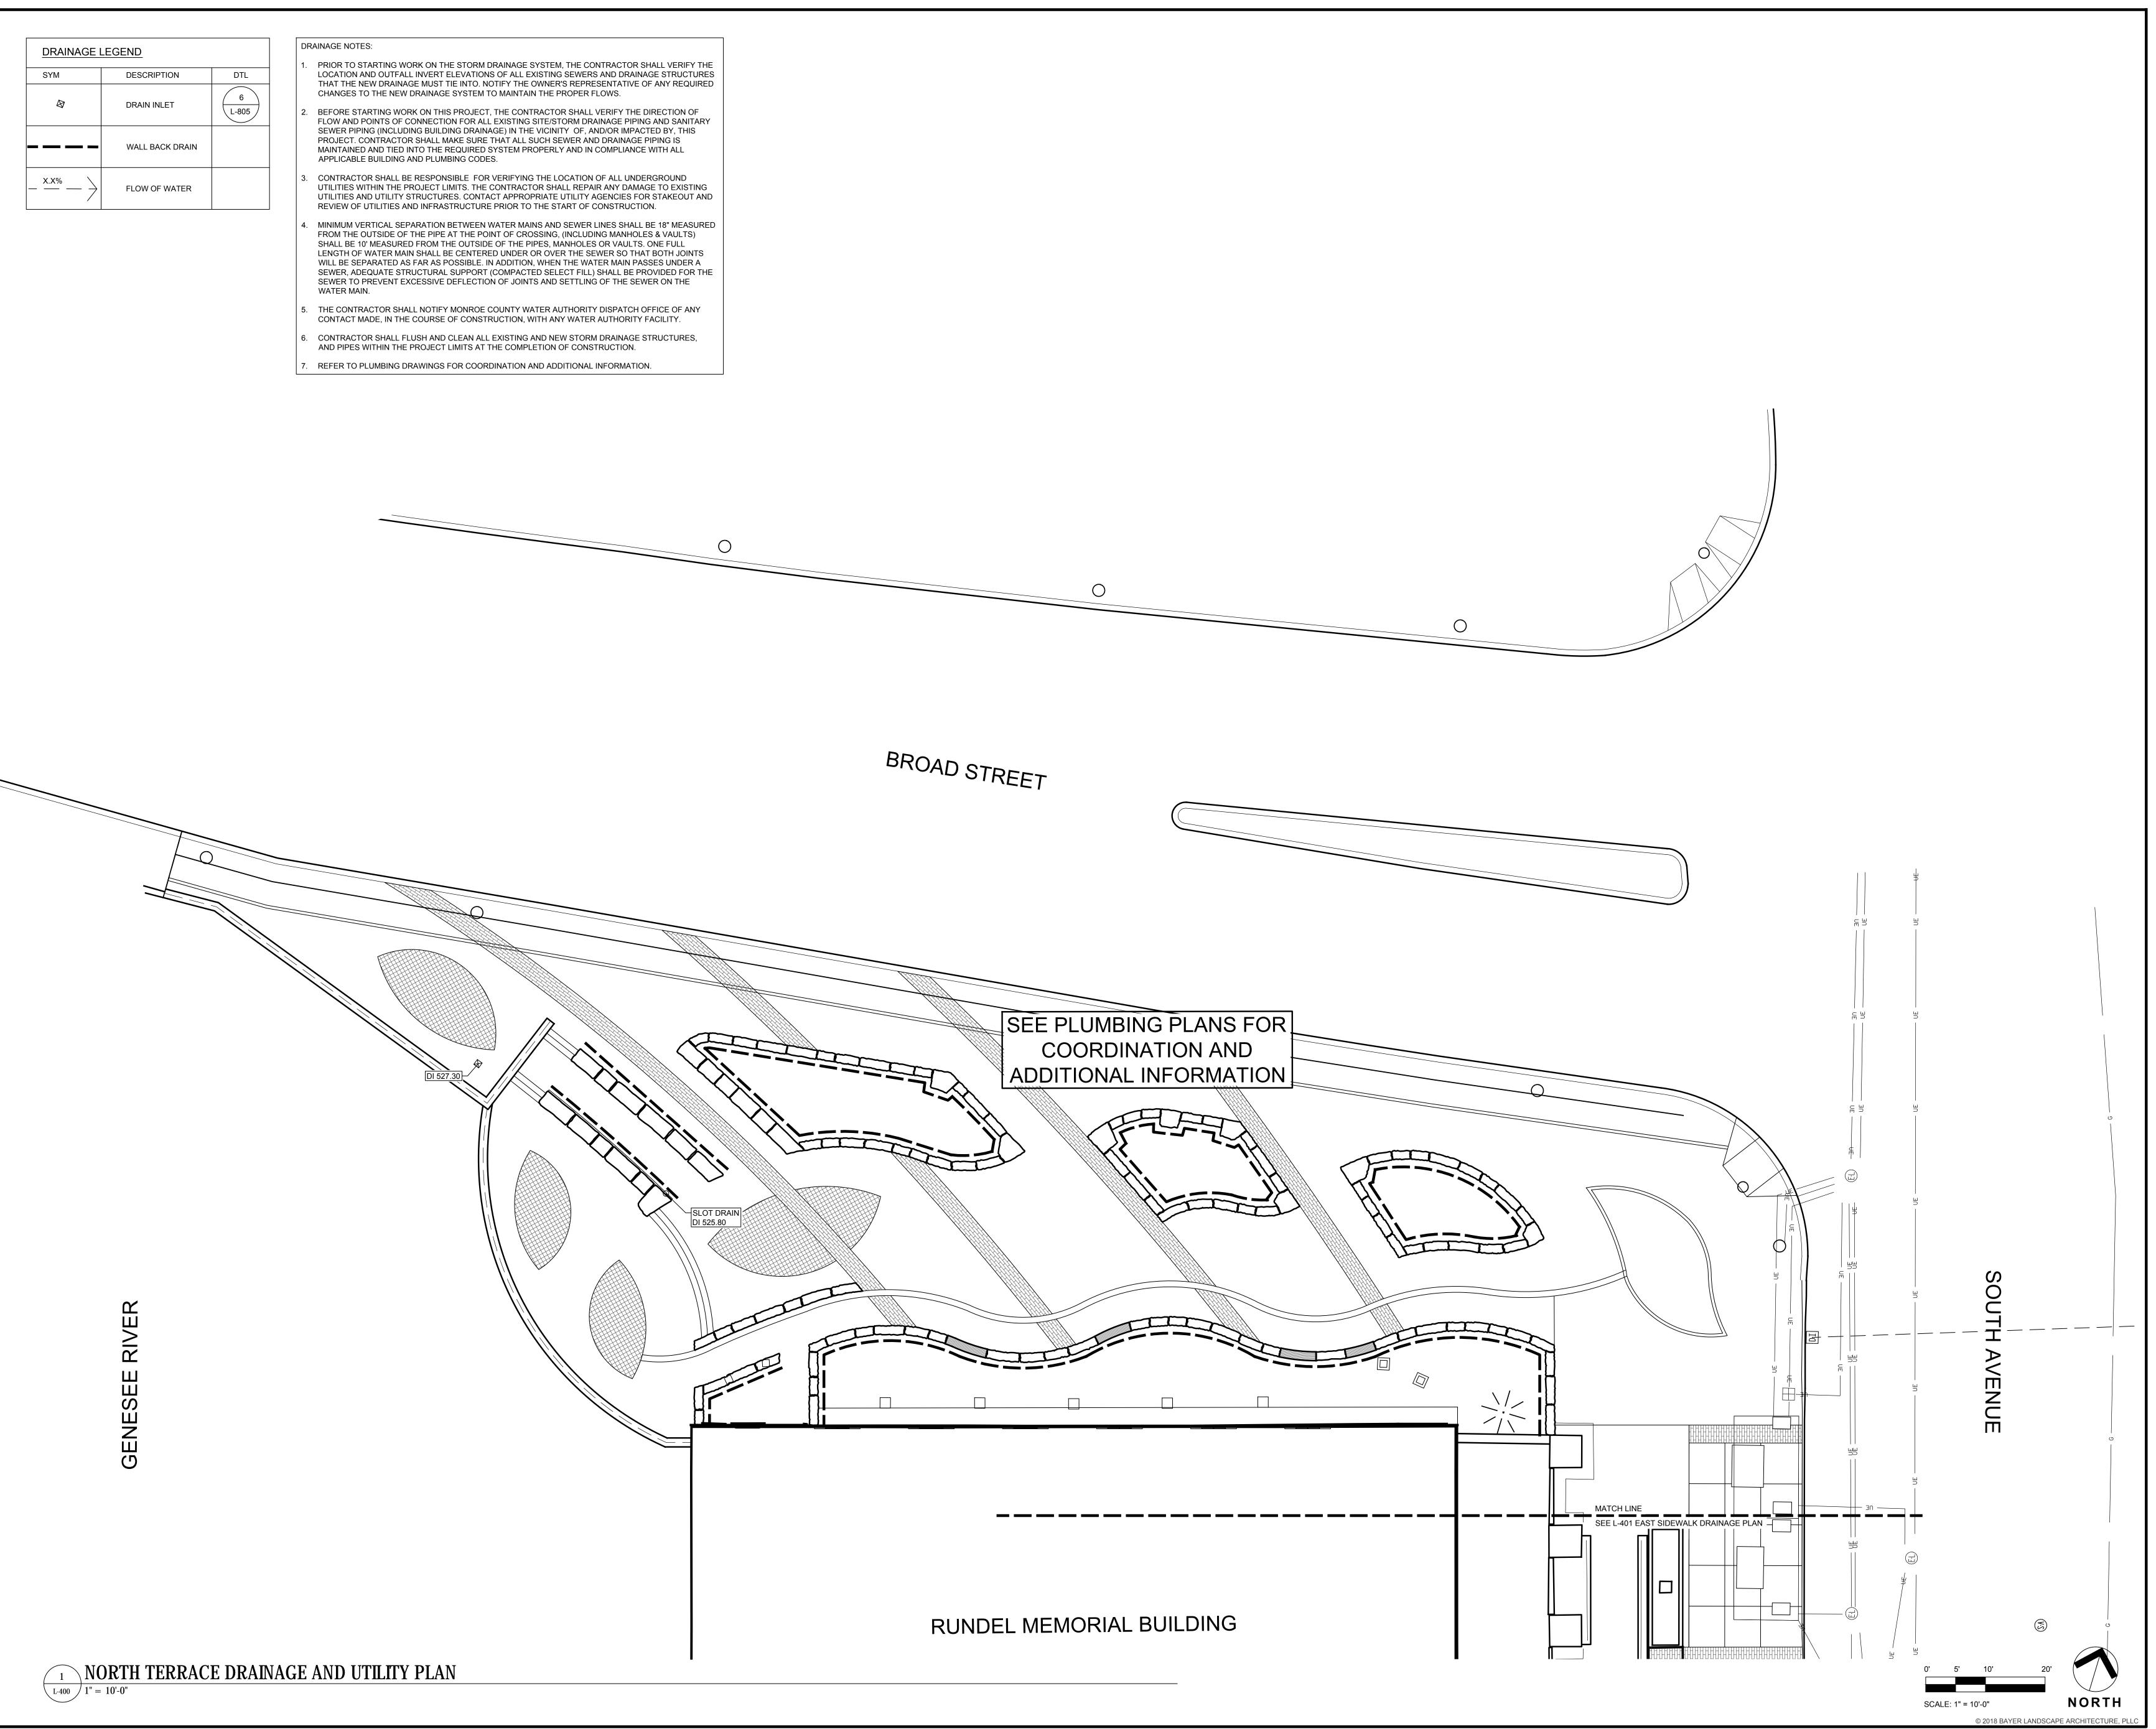
2170391 35% PRELIMINARY DESIGN

DRAWING NAME:

**EAST SIDEWALK GRADING PLAN** 

DRAWING NUMBER:

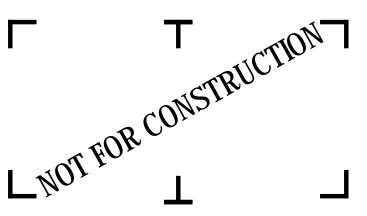






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CITY OF ROCHESTER
414 ANDREWS STREET
ROCHESTER, NY 14604

RUNDEL LIBRARY PHASE IV 115 SOUTH AVE. ROCHESTER, NY 14604

NO: DATE: DESCRIPTION:

Revisions

PROJECT NUMBER:

2170391

DRAWN BY: JJR / DPZ

REVIEWED BY: MHB

ISSUED FOR:

35% PRELIMINARY DESIGN

DATE:

JULY 2018

NORTH TERRACE DRAINAGE PLAN

DRAWING NUMBER:

DRAINAGE I	LEGEND	
SYM	DESCRIPTION	DTL
Ø	DRAIN INLET	6 L-805
	WALL BACK DRAIN	
_ X.X% >	FLOW OF WATER	

### DRAINAGE NOTES:

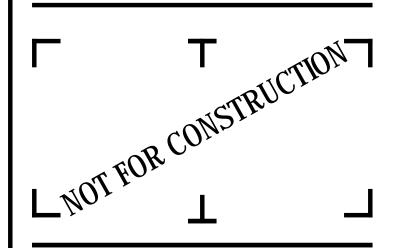
- PRIOR TO STARTING WORK ON THE STORM DRAINAGE SYSTEM, THE CONTRACTOR SHALL VERIFY THE LOCATION AND OUTFALL INVERT ELEVATIONS OF ALL EXISTING SEWERS AND DRAINAGE STRUCTURES THAT THE NEW DRAINAGE MUST TIE INTO. NOTIFY THE OWNER'S REPRESENTATIVE OF ANY REQUIRED CHANGES TO THE NEW DRAINAGE SYSTEM TO MAINTAIN THE PROPER FLOWS.
- BEFORE STARTING WORK ON THIS PROJECT, THE CONTRACTOR SHALL VERIFY THE DIRECTION OF FLOW AND POINTS OF CONNECTION FOR ALL EXISTING SITE/STORM DRAINAGE PIPING AND SANITARY SEWER PIPING (INCLUDING BUILDING DRAINAGE) IN THE VICINITY OF, AND/OR IMPACTED BY, THIS PROJECT. CONTRACTOR SHALL MAKE SURE THAT ALL SUCH SEWER AND DRAINAGE PIPING IS MAINTAINED AND TIED INTO THE REQUIRED SYSTEM PROPERLY AND IN COMPLIANCE WITH ALL APPLICABLE BUILDING AND PLUMBING CODES.
- 3. CONTRACTOR SHALL BE RESPONSIBLE FOR VERIFYING THE LOCATION OF ALL UNDERGROUND UTILITIES WITHIN THE PROJECT LIMITS. THE CONTRACTOR SHALL REPAIR ANY DAMAGE TO EXISTING UTILITIES AND UTILITY STRUCTURES. CONTACT APPROPRIATE UTILITY AGENCIES FOR STAKEOUT AND REVIEW OF UTILITIES AND INFRASTRUCTURE PRIOR TO THE START OF CONSTRUCTION.
- 4. MINIMUM VERTICAL SEPARATION BETWEEN WATER MAINS AND SEWER LINES SHALL BE 18" MEASURED FROM THE OUTSIDE OF THE PIPE AT THE POINT OF CROSSING, (INCLUDING MANHOLES & VAULTS) SHALL BE 10' MEASURED FROM THE OUTSIDE OF THE PIPES, MANHOLES OR VAULTS. ONE FULL LENGTH OF WATER MAIN SHALL BE CENTERED UNDER OR OVER THE SEWER SO THAT BOTH JOINTS WILL BE SEPARATED AS FAR AS POSSIBLE. IN ADDITION, WHEN THE WATER MAIN PASSES UNDER A SEWER, ADEQUATE STRUCTURAL SUPPORT (COMPACTED SELECT FILL) SHALL BE PROVIDED FOR THE SEWER TO PREVENT EXCESSIVE DEFLECTION OF JOINTS AND SETTLING OF THE SEWER ON THE WATER MAIN.
- 5. THE CONTRACTOR SHALL NOTIFY MONROE COUNTY WATER AUTHORITY DISPATCH OFFICE OF ANY CONTACT MADE, IN THE COURSE OF CONSTRUCTION, WITH ANY WATER AUTHORITY FACILITY.
- 6. CONTRACTOR SHALL FLUSH AND CLEAN ALL EXISTING AND NEW STORM DRAINAGE STRUCTURES, AND PIPES WITHIN THE PROJECT LIMITS AT THE COMPLETION OF CONSTRUCTION.
- 7. REFER TO PLUMBING DRAWINGS FOR COORDINATION AND ADDITIONAL INFORMATION.

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CITY OF ROCHESTER
414 ANDREWS STREET
ROCHESTER, NY 14604

RUNDEL LIBRARY PHASE IV 115 SOUTH AVE.

ROCHESTER, NY 14604

NO: DATE: DESCRIPTION:

Revisions

PROJECT NUMBER:

2170391

DRAWN BY: JJR / DPZ

REVIEWED BY: MHB

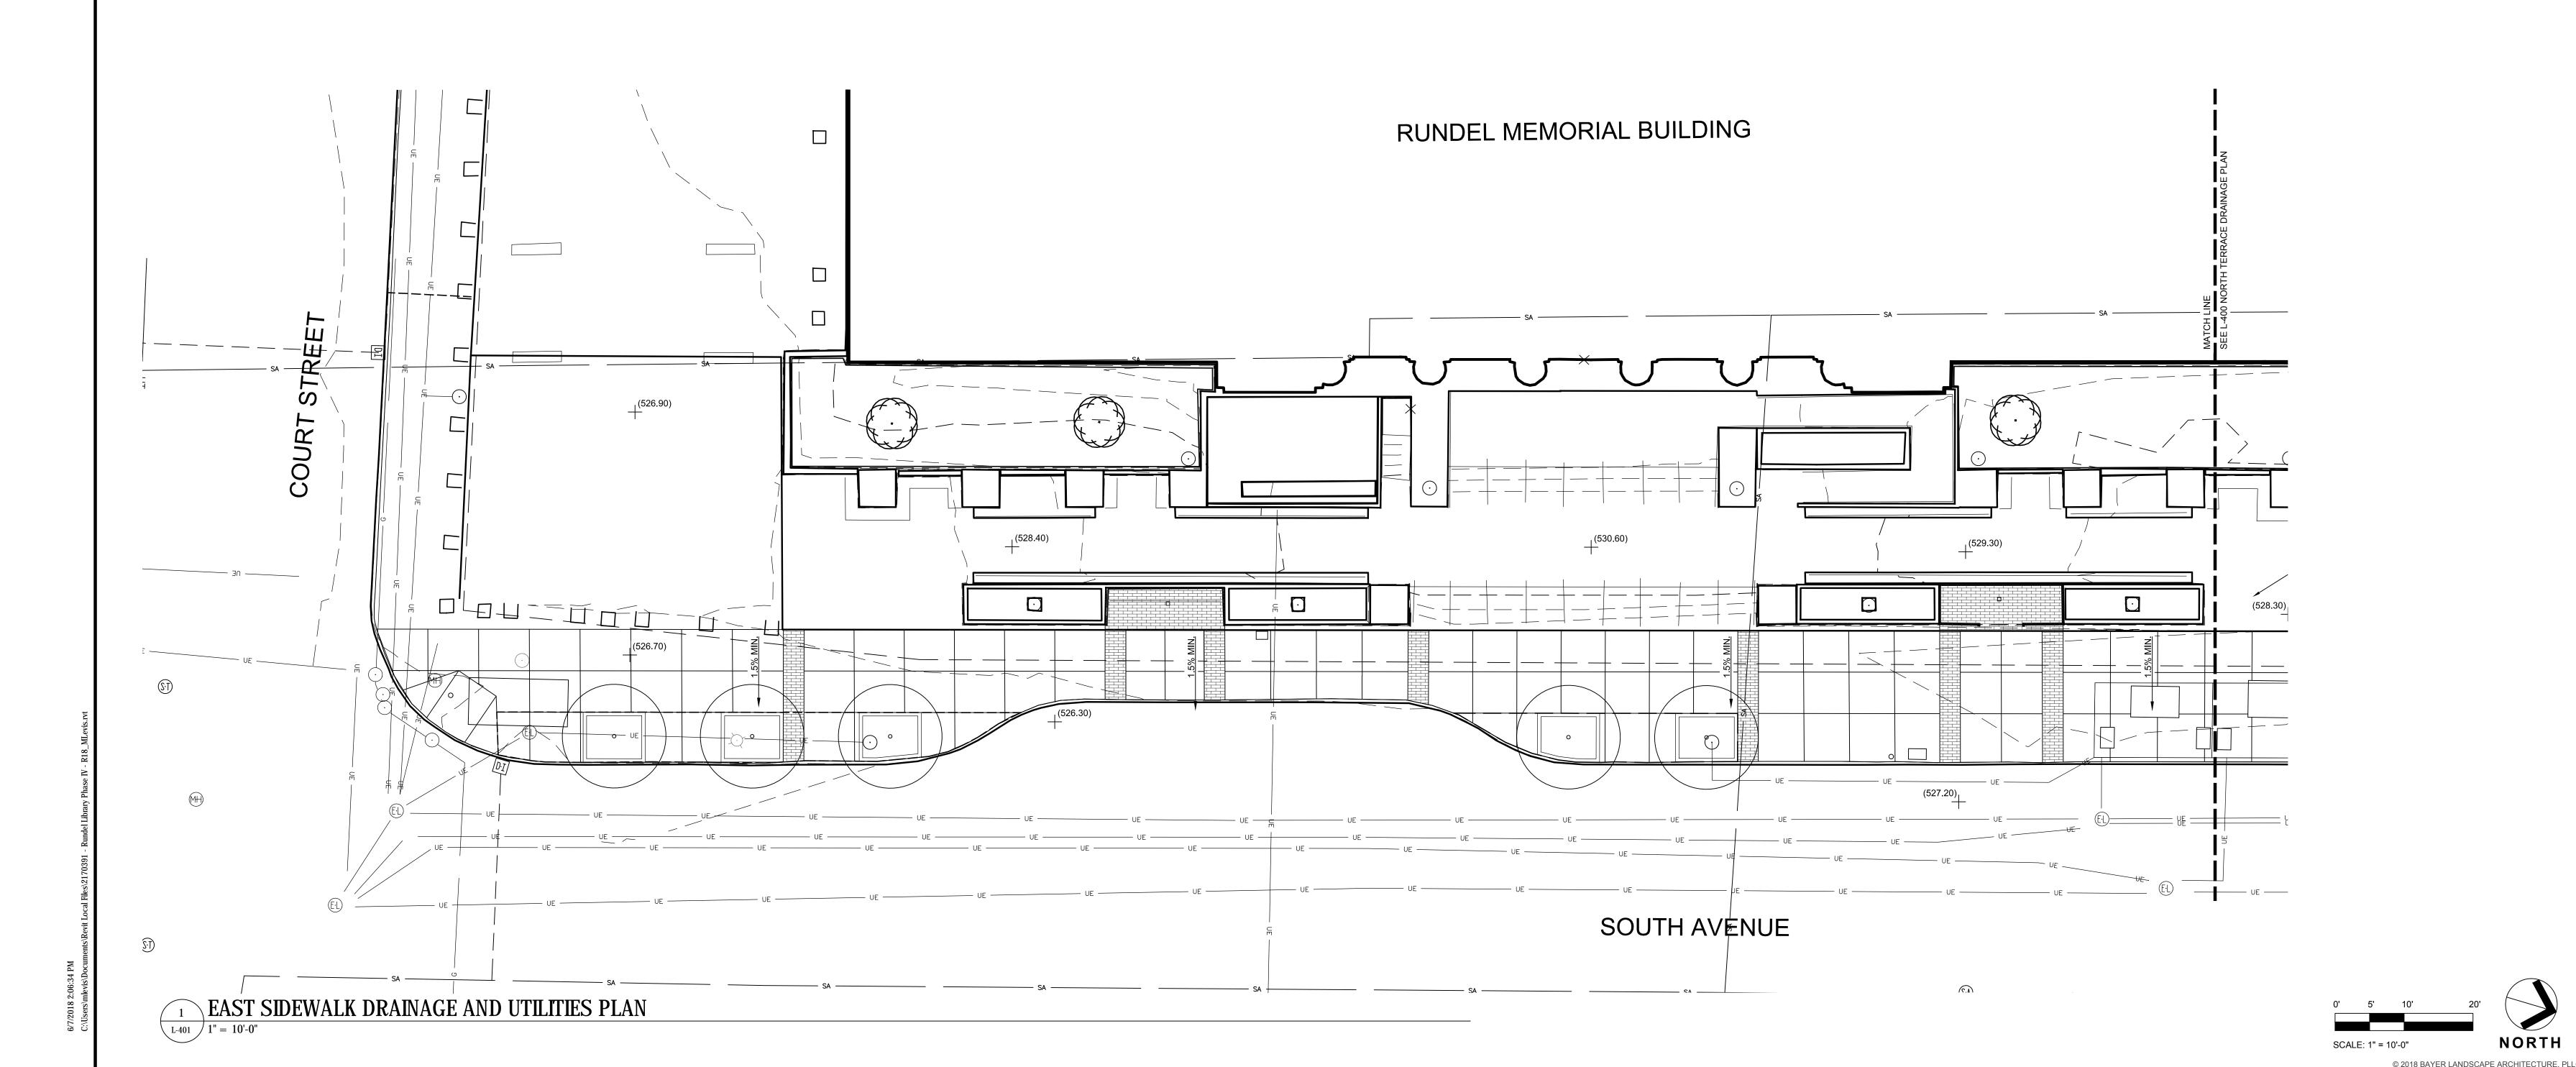
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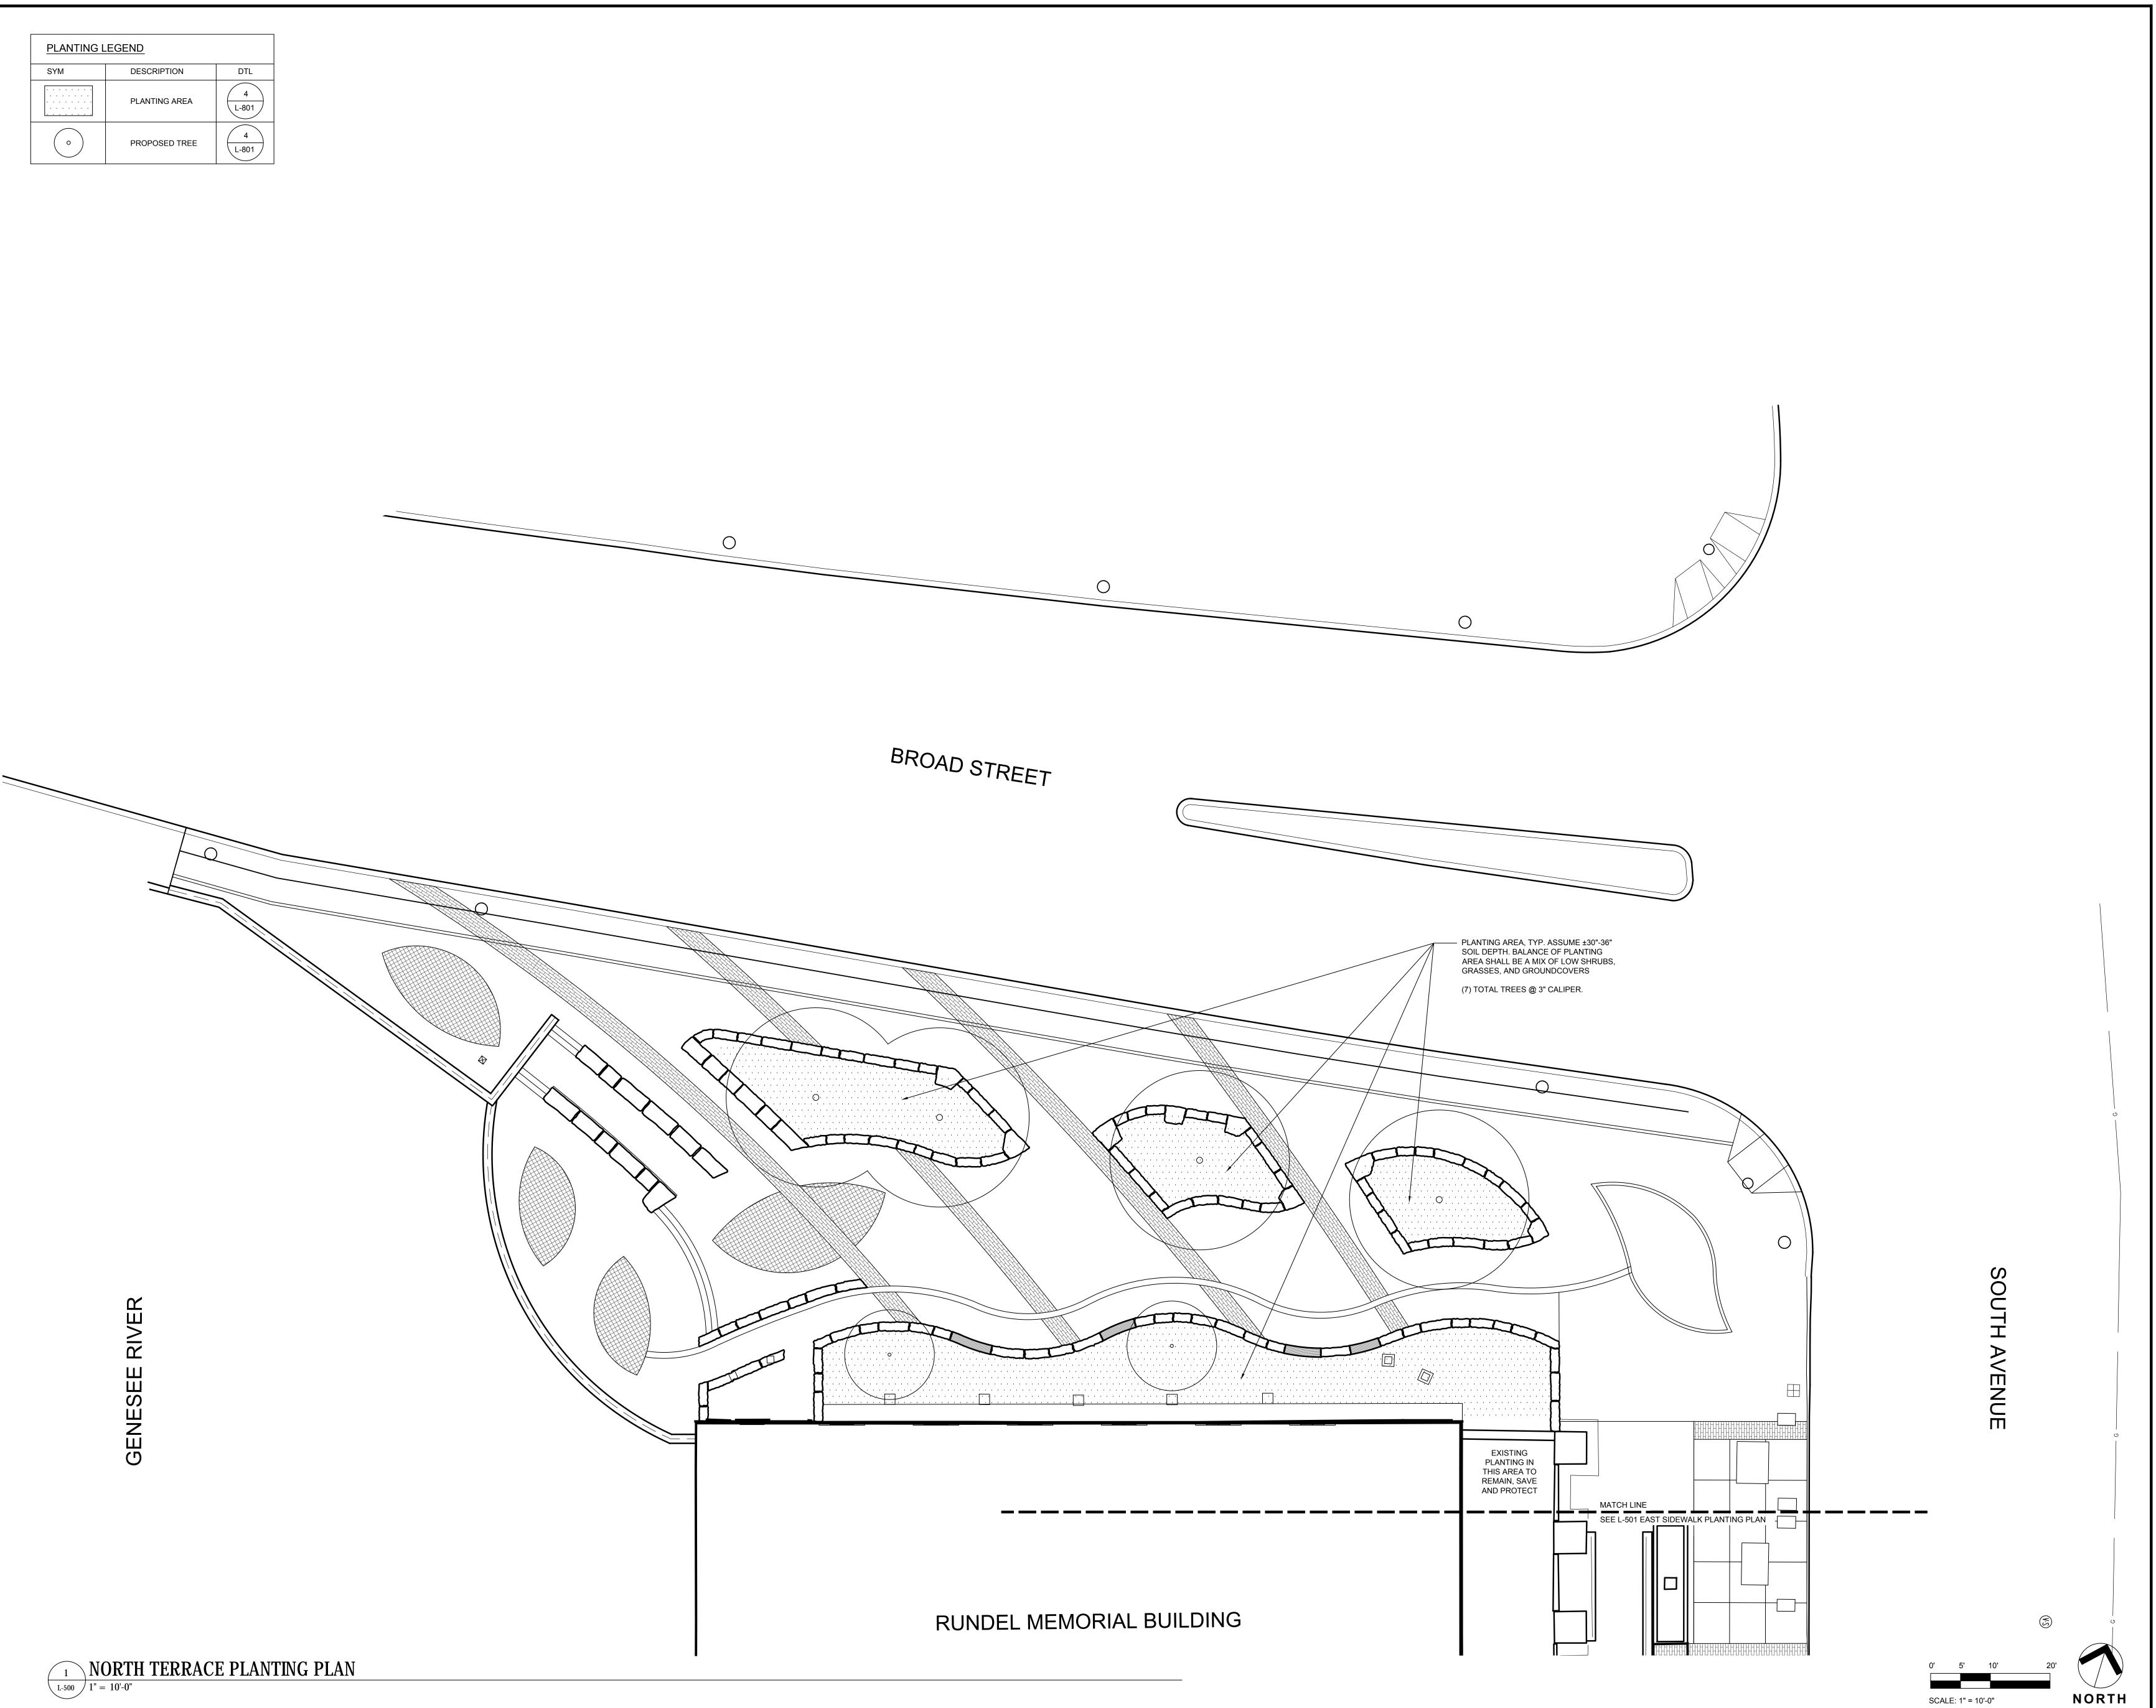
35% PRELIMINARY DESIGN

DATE: ILILY 2018

EAST SIDEWALK DRAINAGE PLAN

DRAWING NUMBE

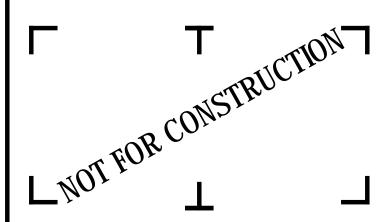






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DATE: JULY 2018

DRAWING NAME:

NORTH TERRACE PLANTING PLAN

DRAWING NUMBER:

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PLANTING LEGEND

SYM DESCRIPTION DTL

PLANTING AREA

PROPOSED TREE

4
L-801

1 EAST SIDEWALK PLANTING PLAN



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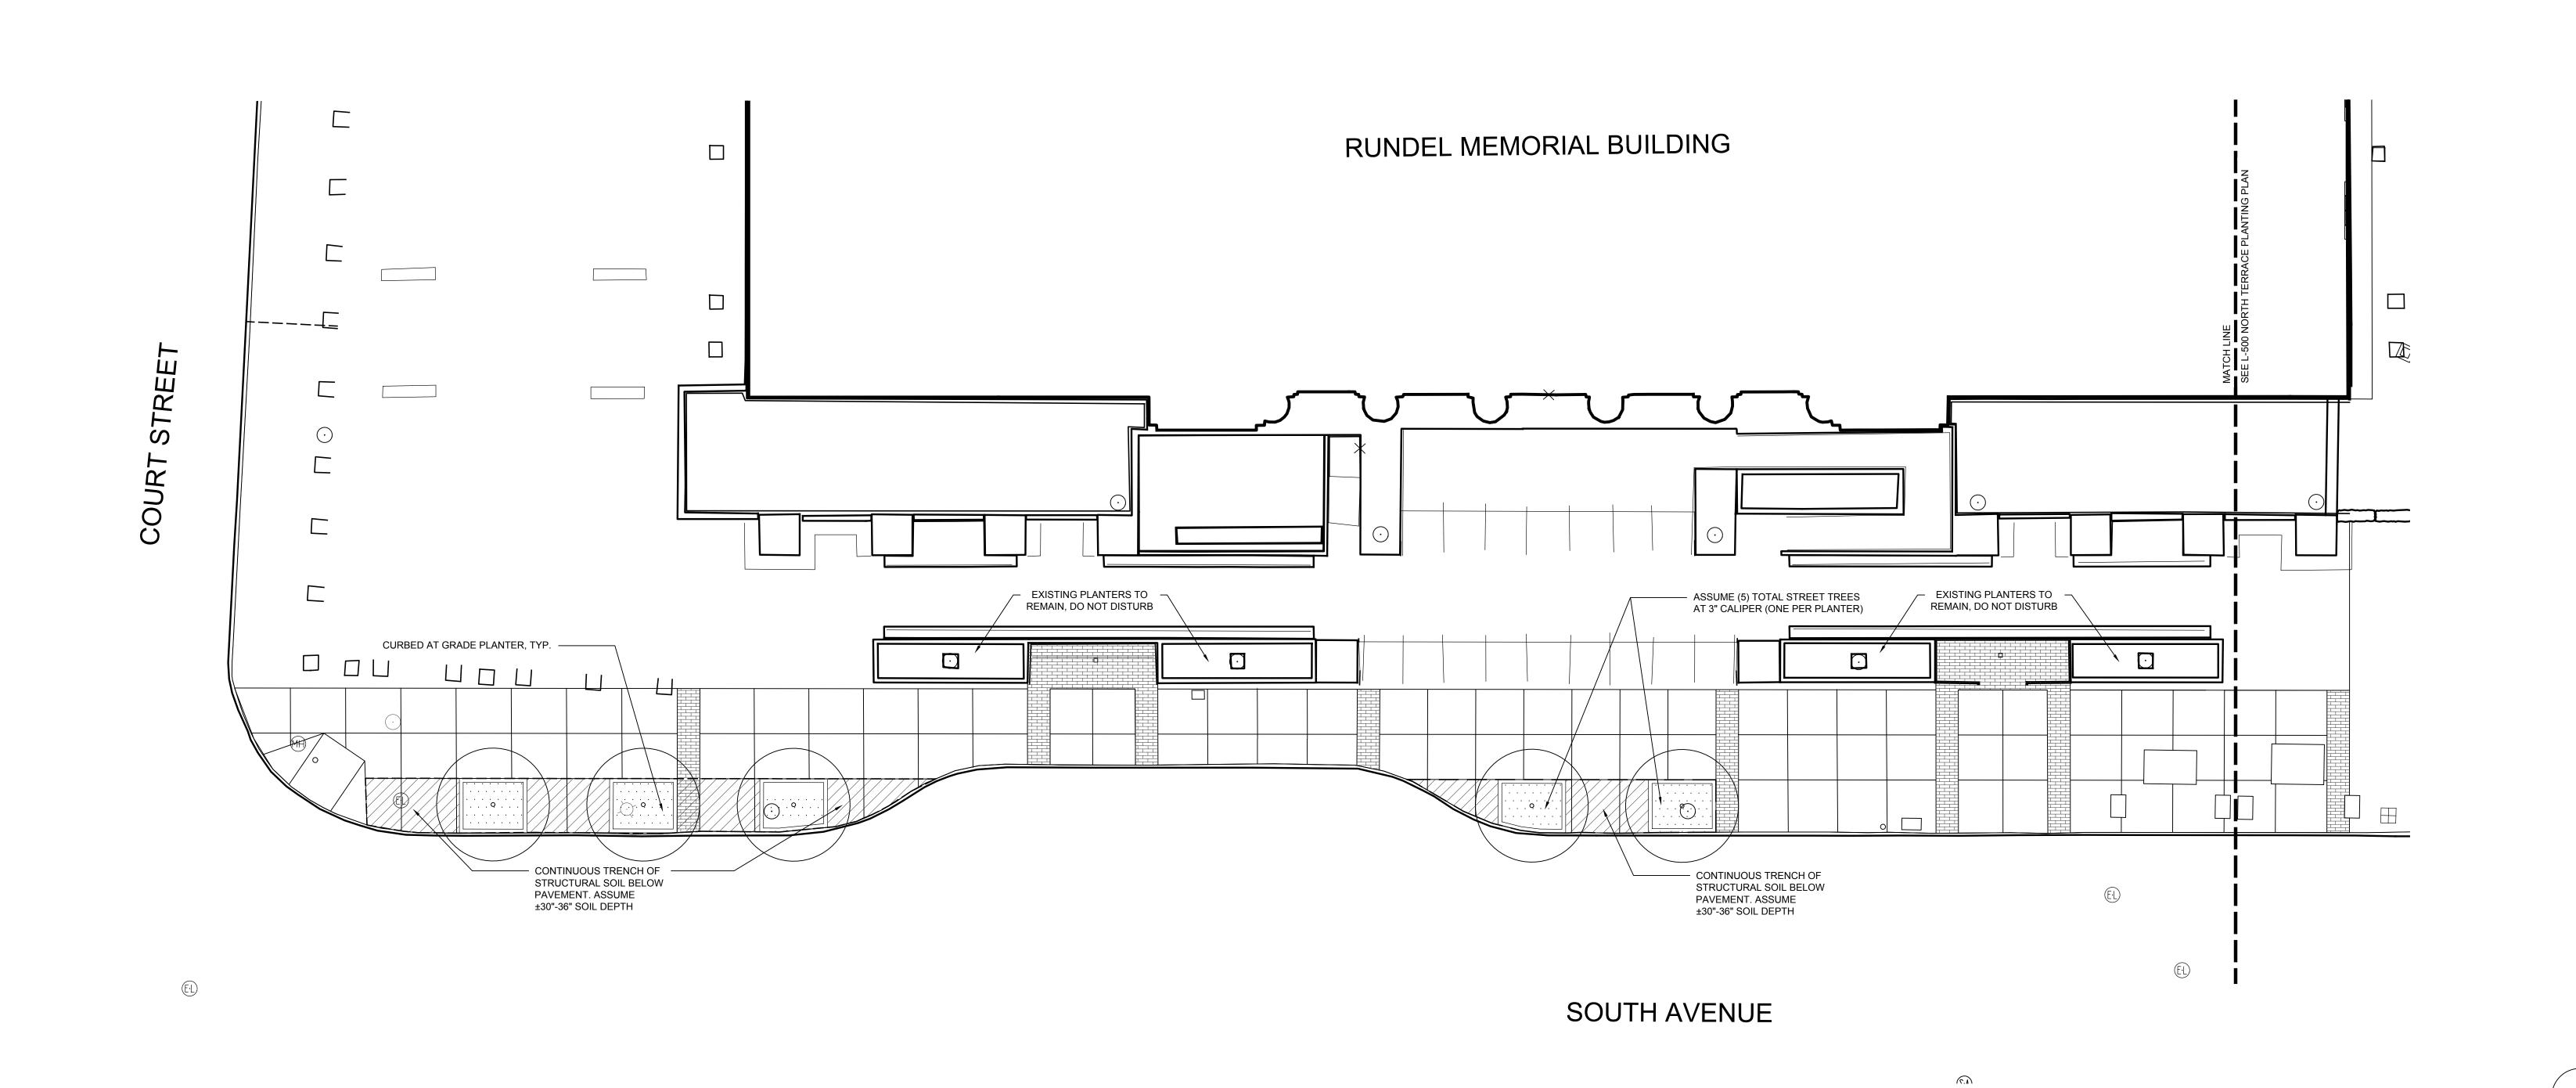
JULY 2018

DRAWING NAME:

EAST SIDEWALK PLANTING PLAN

DRAWING NUMBER:

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LIGHTING L	<u>EGEND</u>	
SYM	DESCRIPTION	DTL
*	PROPOSED STREET LIGHT	6 L-800
$\bigcirc$	EXISTING STREET LIGHT	
	EXISTING LIGHT BOX	
	RELOCATED LIGHT BOX	

### LIGHTING NOTES

THIS LIGHTING/ELECTRICAL SCHEMATIC IS INTENDED TO SHOW THE LOCATION AND TYPES OF FIXTURES TO BE INSTALLED. IT ALSO ILLUSTRATES SCHEMATICALLY THE LIGHTS THAT SHOULD BE

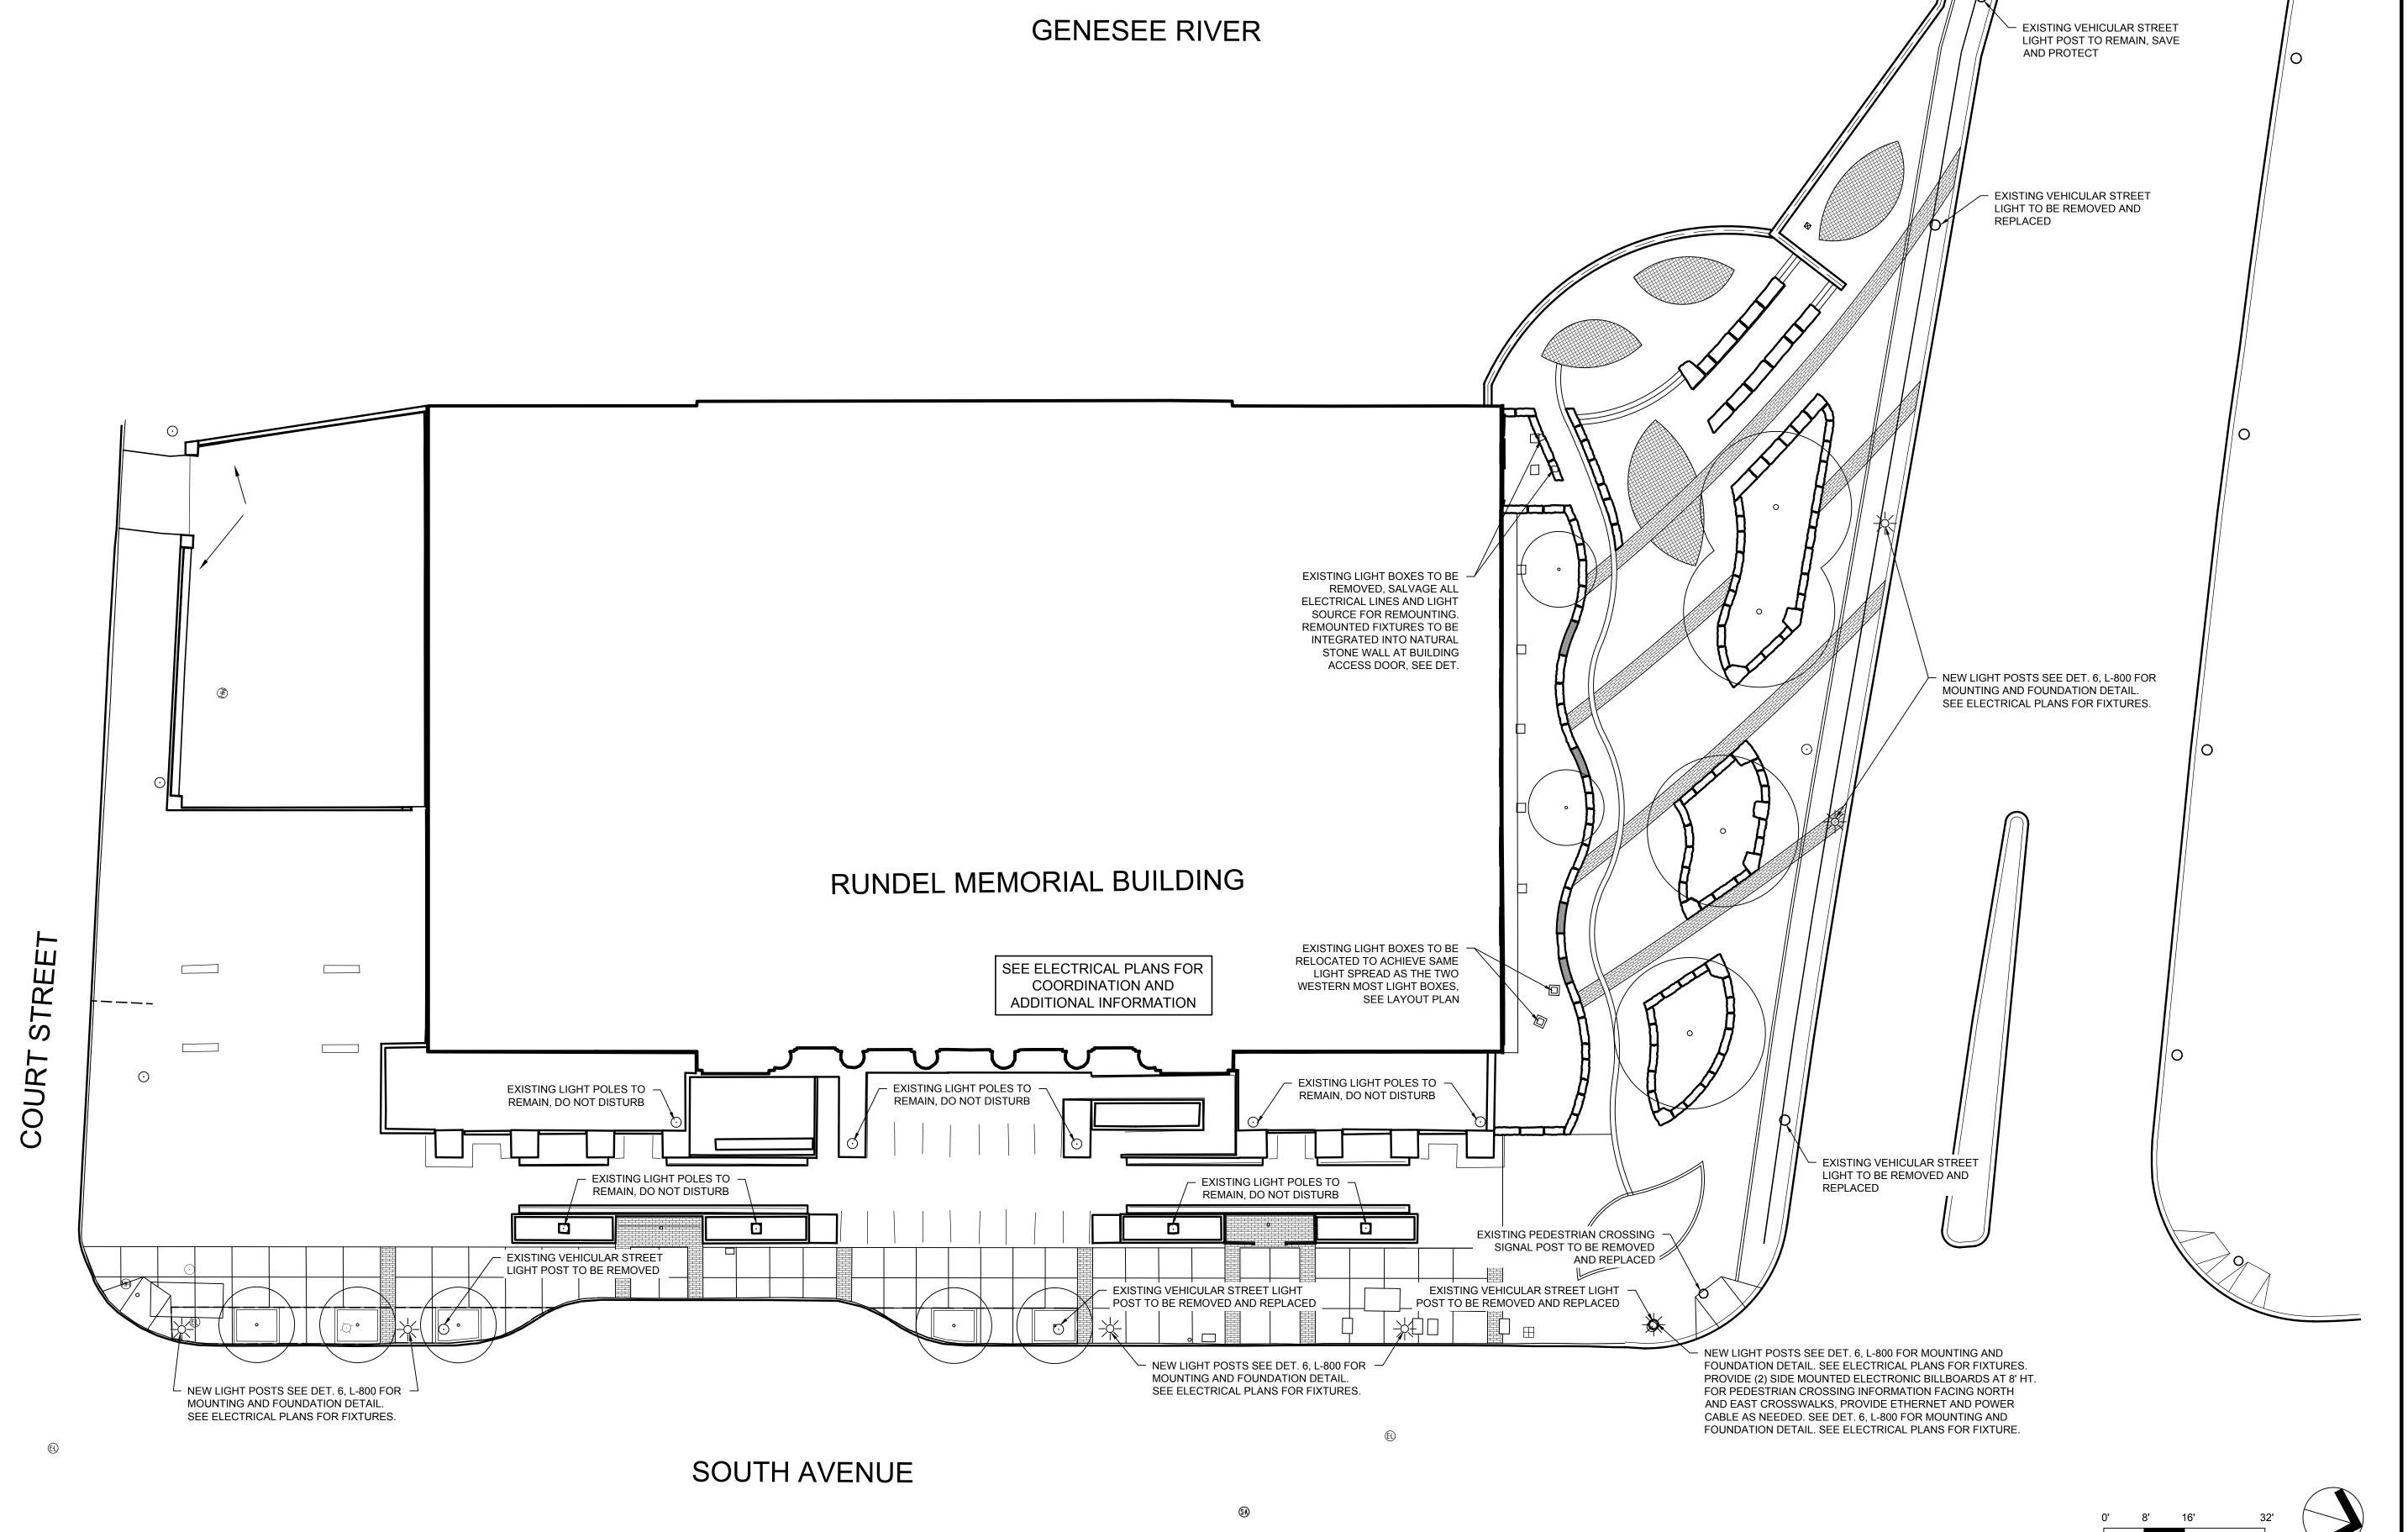
2. FINAL ELECTRICAL CIRCUITRY DESIGN, TRANSFORMER SELECTION, WIRE SIZING, AND POINT(S) OF CONNECTION ARE TO BE DETERMINED BY THE ELECTRICAL CONTRACTOR IN COMPLIANCE WITH ALL APPLICABLE NATIONAL, STATE, AND LOCAL CODES AND REGULATIONS.

INSTALLED ON THE SAME CIRCUIT, HAVE A COMMON MEANS OF CONTROL, OR COMMON SWITCH.

- THE ELECTRICAL CONTRACTOR SHALL CALCULATE VOLTAGE DROP ON ALL LOW VOLTAGE CIRCUITS AND BALANCE EACH CIRCUIT TO DELIVER BETWEEN MANUFACTURES RECOMMENDED VOLTAGE AT EACH LOW VOLTAGE FIXTURE.
- 4. THE ELECTRICAL CONTRACTOR SHALL REVIEW PLACEMENT OF ALL FIXTURES, WIRE/CONDUIT RUNS, SWITCHING, AND GENERAL CIRCUITRY WITH THE OWNER'S REPRESENTATIVE, ONSITE PRIOR TO ORDERING OF FIXTURES AND/OR INSTALLATION OF ANY CONDUIT, WIRE, OR LIGHT FIXTURES.
- 5. CONTRACTOR SHALL PROVIDE SAMPLE FIXTURES, COLOR CHIPS, AND LENSES TO CONFIRM FINAL LED CONFIGURATION / QUANTITY IN EACH FIXTURE, LIGHT COLOR / TEMPERATURE, AND FIXTURE FINISH. CONTRACTOR TO ARRANGE FOR AN EVENING TRIAL RUN WITH LANDSCAPE ARCHITECT O REVIEW / CONFIRM FIXTURES AND CONFIGURATIONS PRIOR TO PLACING ORDER.
- 6. ALL WIRE USED FOR LOW VOLTAGE CIRCUITS SHALL BE INSTALLED IN FLEX PVC CONDUIT TO PROTECT WIRE FROM DAMAGE. PROVIDE ADDITIONAL WIRE AT EACH FIXTURE TO ALLOW FOR FUTURE FIXTURE ADJUSTMENTS. ANY LINE VOLTAGE CIRCUITS RUN UNDERGROUND SHALL BE IN RIGID PVC CONDUIT.
- 7. THE ELECTRICAL CONTRACTOR SHALL PROVIDE AND INSTALL ALL LIGHT FIXTURES, FOR THE PROJECT. THE ELECTRICAL CONTRACTOR SHALL ALSO PROVIDE ALL OTHER ELECTRICAL COMPONENTS INCLUDING BUT NOT LIMITED TO CONDUIT, WIRE, PULL BOXES, JUNCTION BOXES, MOUNTING STAKES / DEVICES, TRANSFORMERS, PHOTOCELL(S), AND ANY OTHER COMPONENTS REQUIRED TO COMPLETE THE PROJECT.
- 8. PROVIDE DIRECT BURIAL LOW VOLTAGE ELECTRICAL CABLE FOR LOW VOLTAGE WIRING. BURY AT A MINIMUM OF 2" BELOW GRADE.

LIGHTING PLAN - SURFACE

L-600 / 1/16" = 1'-0"

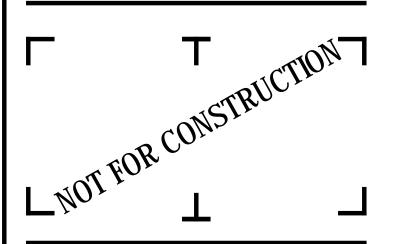




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CITY OF ROCHESTER
414 ANDREWS STREET
ROCHESTER, NY 14604

RUNDEL LIBRARY PHASE IV 115 SOUTH AVE.

ROCHESTER, NY 14604

NO: DATE: DESCRIPTION:

Revisions

PROJECT NUMBER:

2170391

DRAWN BY:

JJR / DPZ

REVIEWED BY:

MHB

ISSUED FOR:

35% PRELIMINARY DESIGN

TE: JULY 2018

DRAWING NAME:

LIGHTING PLAN -SURFACE

DRAWING NUMBER:

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### LIGHTING NOTES

1. THIS LIGHTING/ELECTRICAL SCHEMATIC IS INTENDED TO SHOW THE LOCATION AND TYPES OF FIXTURES TO BE INSTALLED. IT ALSO ILLUSTRATES SCHEMATICALLY THE LIGHTS THAT SHOULD BE INSTALLED ON THE SAME CIRCUIT,

HAVE A COMMON MEANS OF CONTROL, OR COMMON SWITCH.

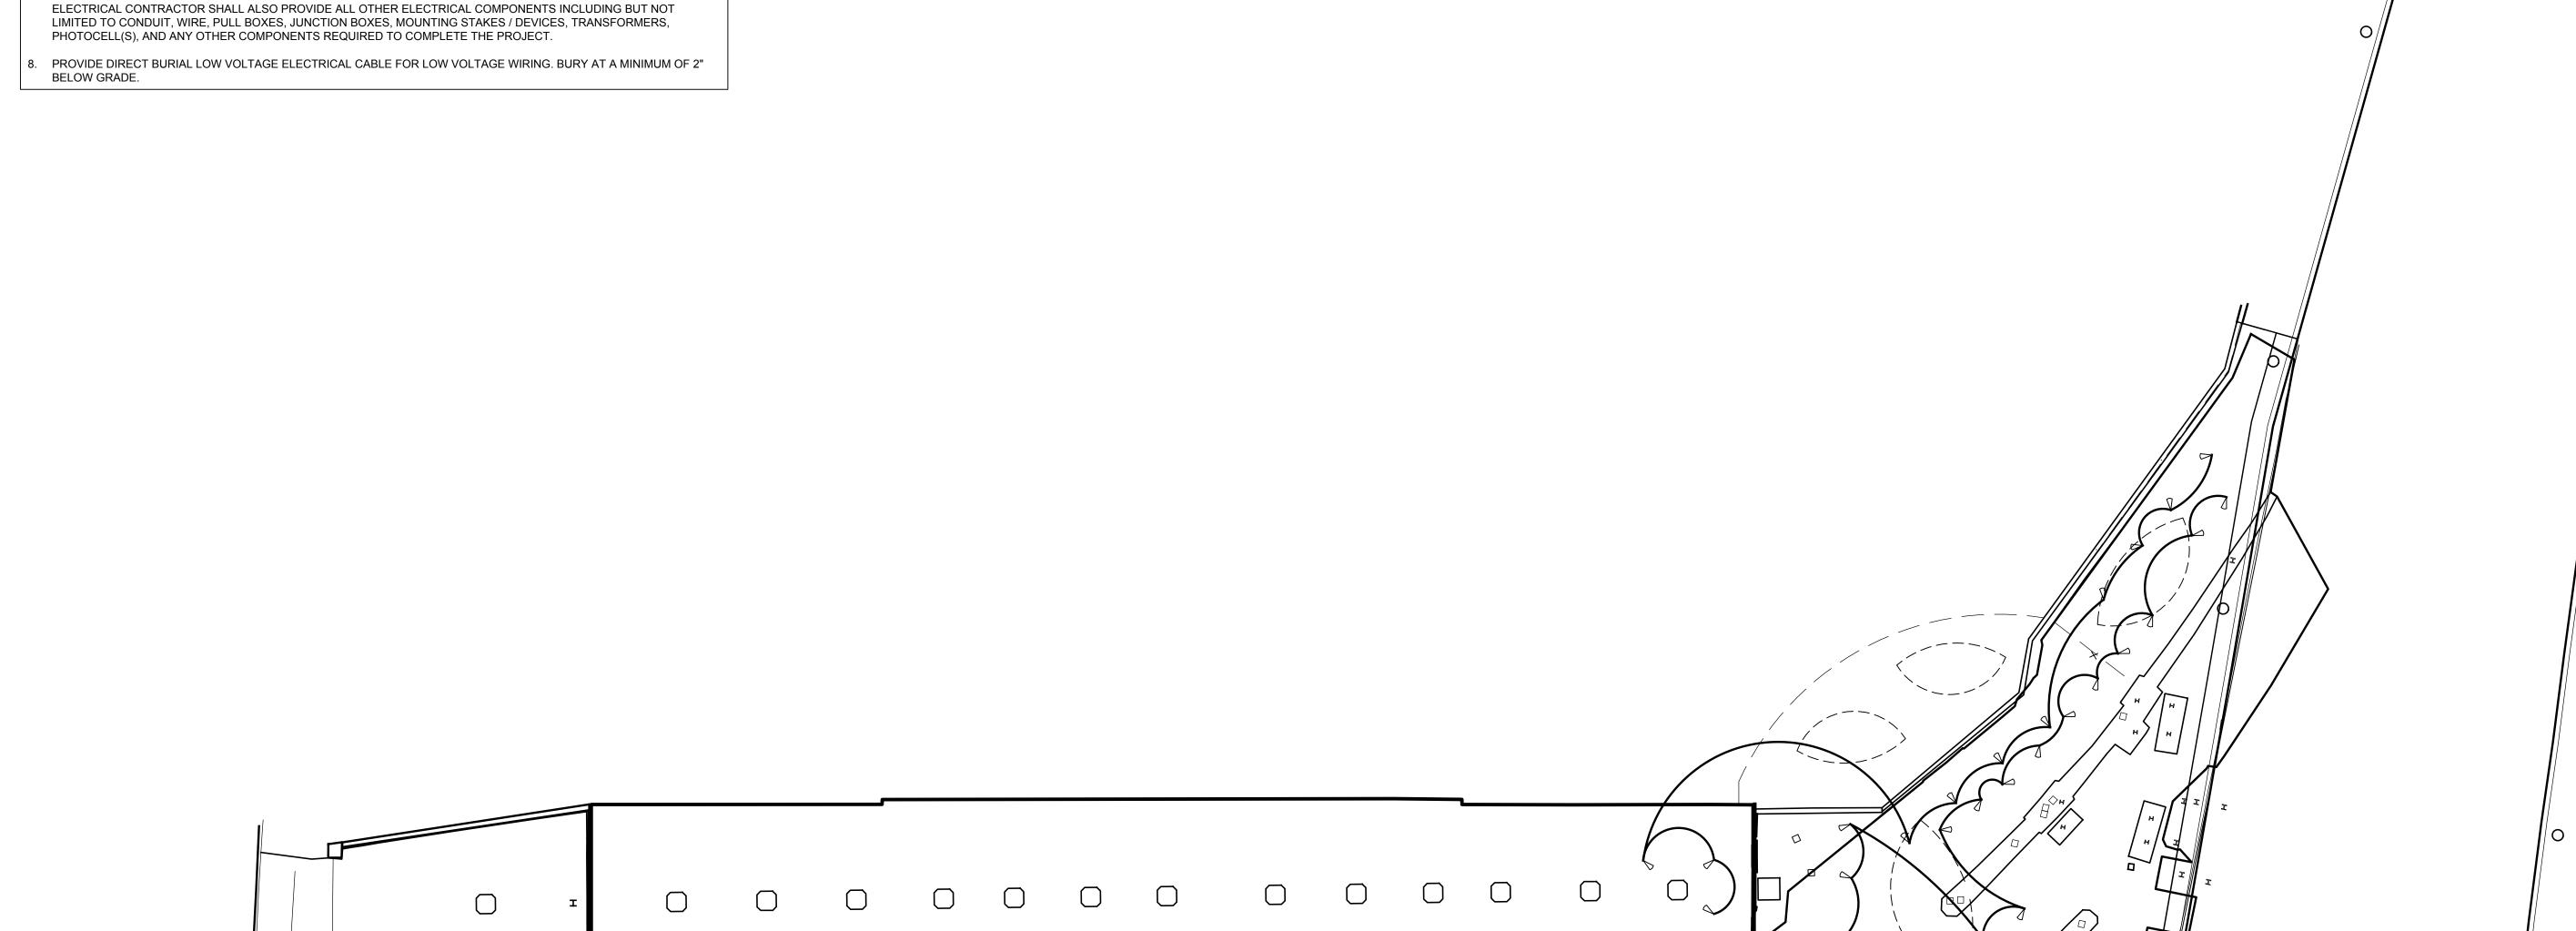
- 2. FINAL ELECTRICAL CIRCUITRY DESIGN, TRANSFORMER SELECTION, WIRE SIZING, AND POINT(S) OF CONNECTION ARE TO BE DETERMINED BY THE ELECTRICAL CONTRACTOR IN COMPLIANCE WITH ALL APPLICABLE NATIONAL, STATE, AND LOCAL CODES AND REGULATIONS.
- THE ELECTRICAL CONTRACTOR SHALL CALCULATE VOLTAGE DROP ON ALL LOW VOLTAGE CIRCUITS AND BALANCE EACH CIRCUIT TO DELIVER BETWEEN MANUFACTURES RECOMMENDED VOLTAGE AT EACH LOW VOLTAGE FIXTURE.
- 4. THE ELECTRICAL CONTRACTOR SHALL REVIEW PLACEMENT OF ALL FIXTURES, WIRE/CONDUIT RUNS, SWITCHING, AND GENERAL CIRCUITRY WITH THE OWNER'S REPRESENTATIVE, ONSITE PRIOR TO ORDERING OF FIXTURES AND/OR INSTALLATION OF ANY CONDUIT, WIRE, OR LIGHT FIXTURES.
- 5. CONTRACTOR SHALL PROVIDE SAMPLE FIXTURES, COLOR CHIPS, AND LENSES TO CONFIRM FINAL LED CONFIGURATION / QUANTITY IN EACH FIXTURE, LIGHT COLOR / TEMPERATURE, AND FIXTURE FINISH. CONTRACTOR TO ARRANGE FOR AN EVENING TRIAL RUN WITH LANDSCAPE ARCHITECT O REVIEW / CONFIRM FIXTURES AND CONFIGURATIONS PRIOR TO PLACING ORDER.

6. ALL WIRE USED FOR LOW VOLTAGE CIRCUITS SHALL BE INSTALLED IN FLEX PVC CONDUIT TO PROTECT WIRE FROM

DAMAGE. PROVIDE ADDITIONAL WIRE AT EACH FIXTURE TO ALLOW FOR FUTURE FIXTURE ADJUSTMENTS. ANY LINE VOLTAGE CIRCUITS RUN UNDERGROUND SHALL BE IN RIGID PVC CONDUIT.

7. THE ELECTRICAL CONTRACTOR SHALL PROVIDE AND INSTALL ALL LIGHT FIXTURES, FOR THE PROJECT. THE

L-601 / 1/16" = 1'-0"

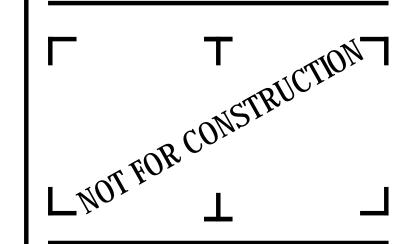


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RUNDEL LIBRARY PHASE IV 115 SOUTH AVE.

ROCHESTER, NY 14604

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Revisions

PROJECT NUMBER:

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DRAWN BY: JJR / DPZ

REVIEWED BY: MHB

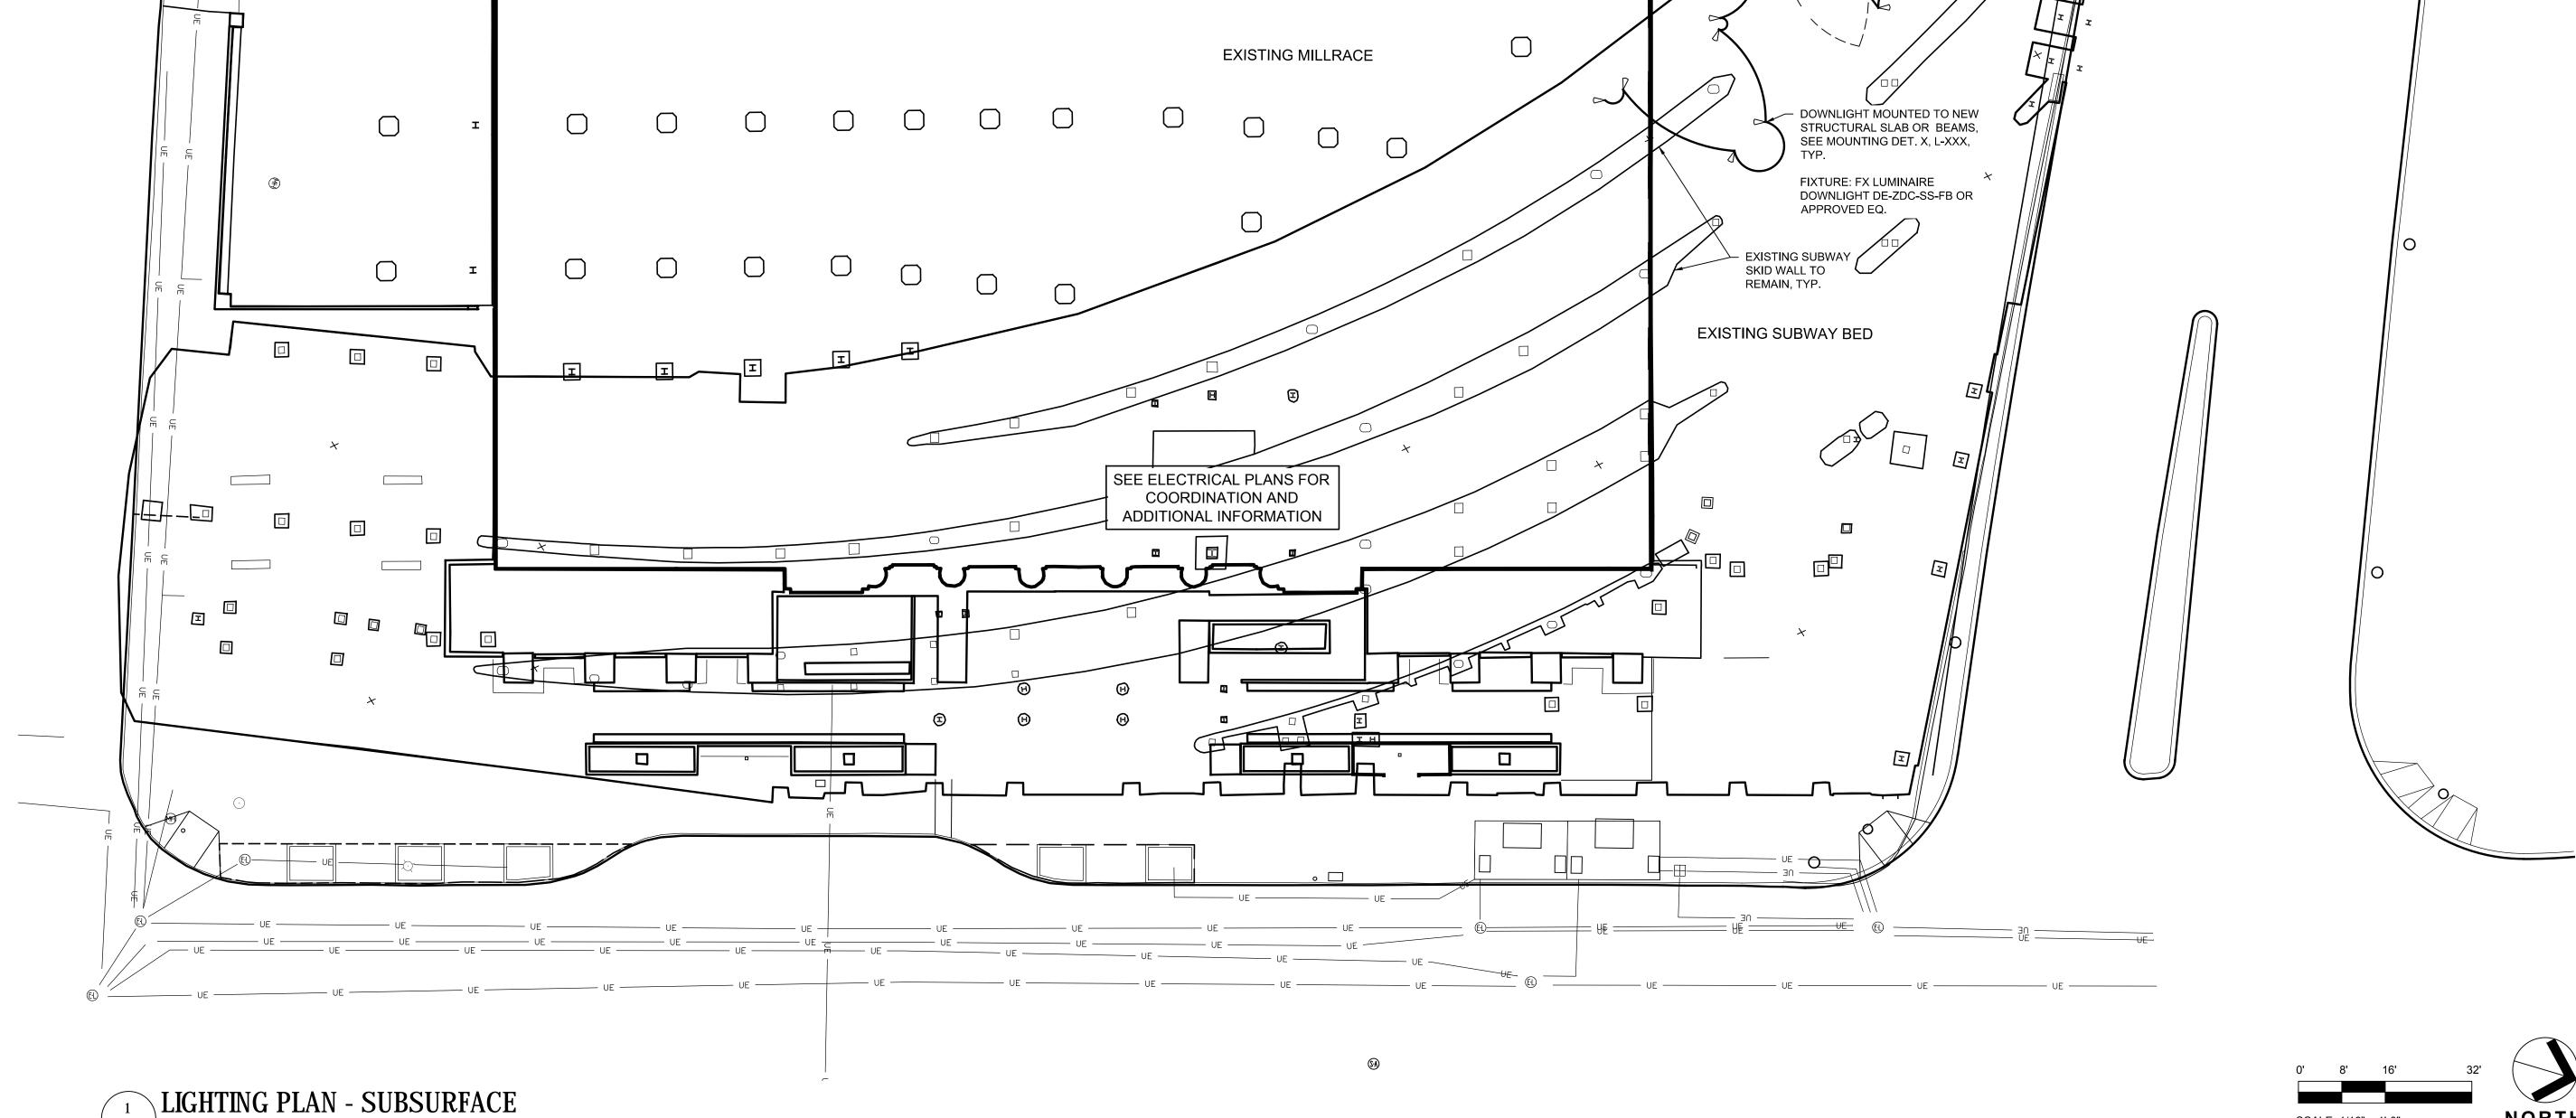
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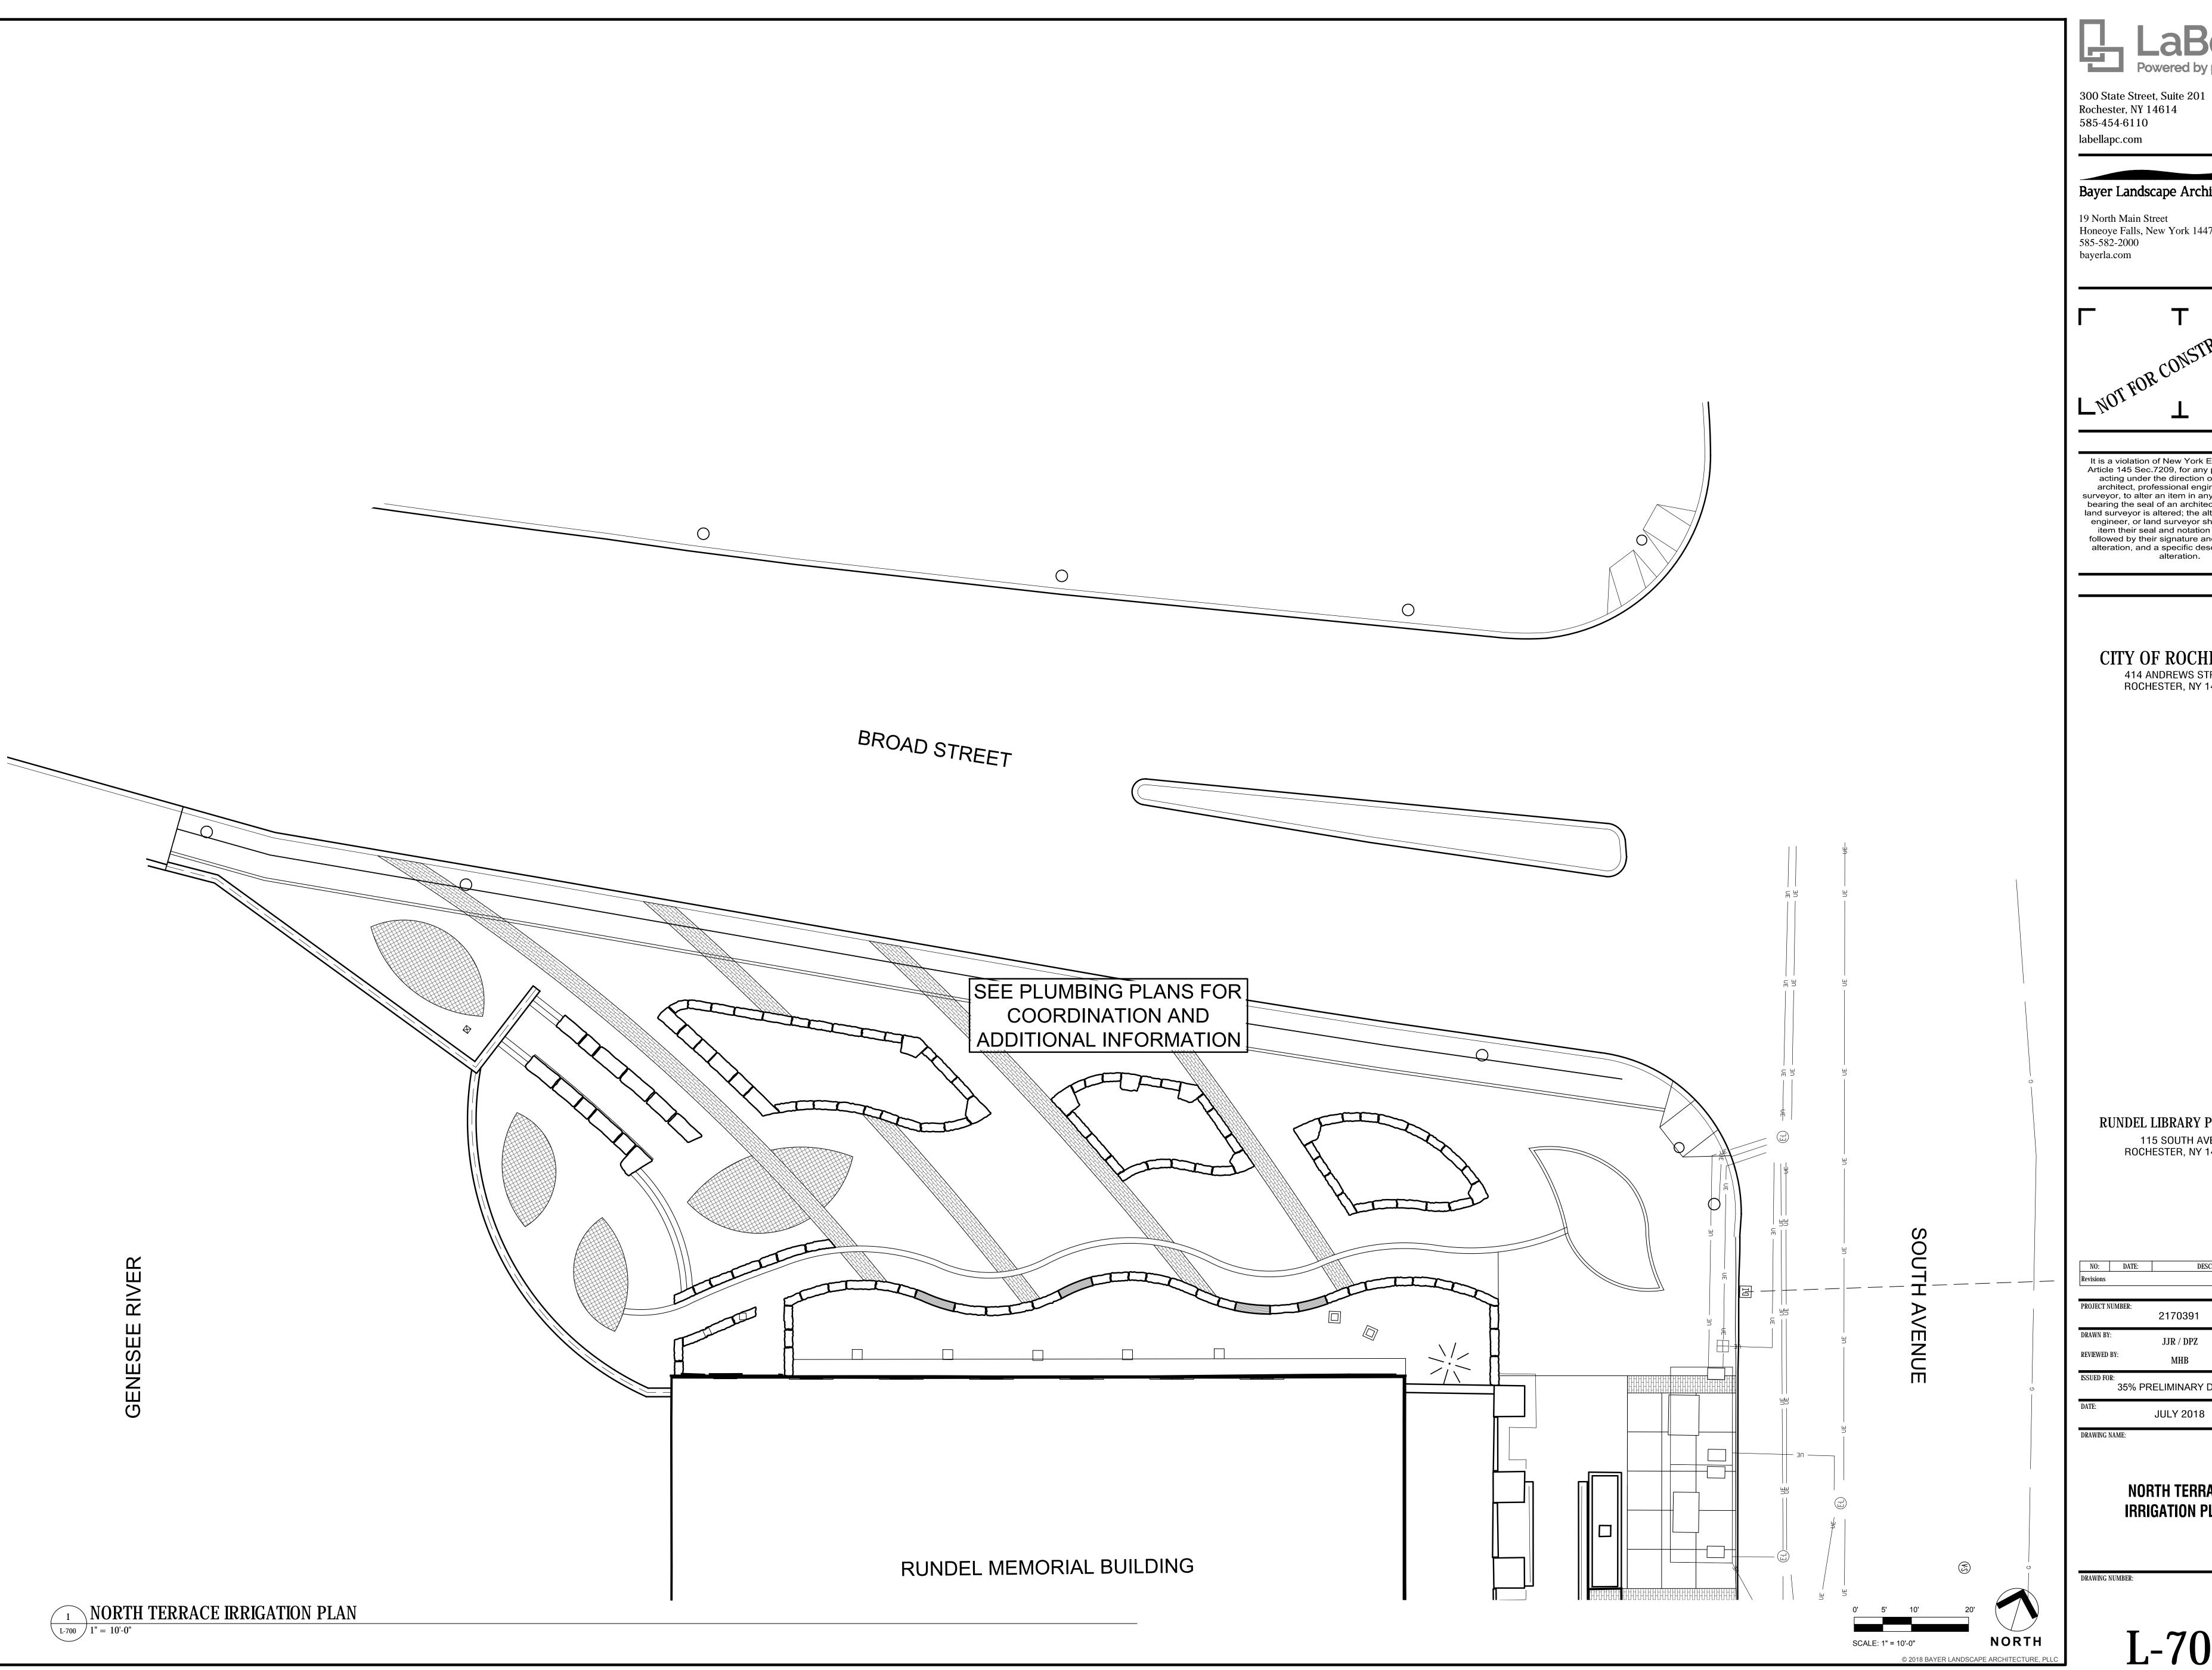
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LIGHTING PLAN -SUB-SURFACE

DRAWING NUMBER:

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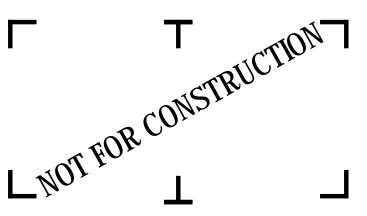




Rochester, NY 14614

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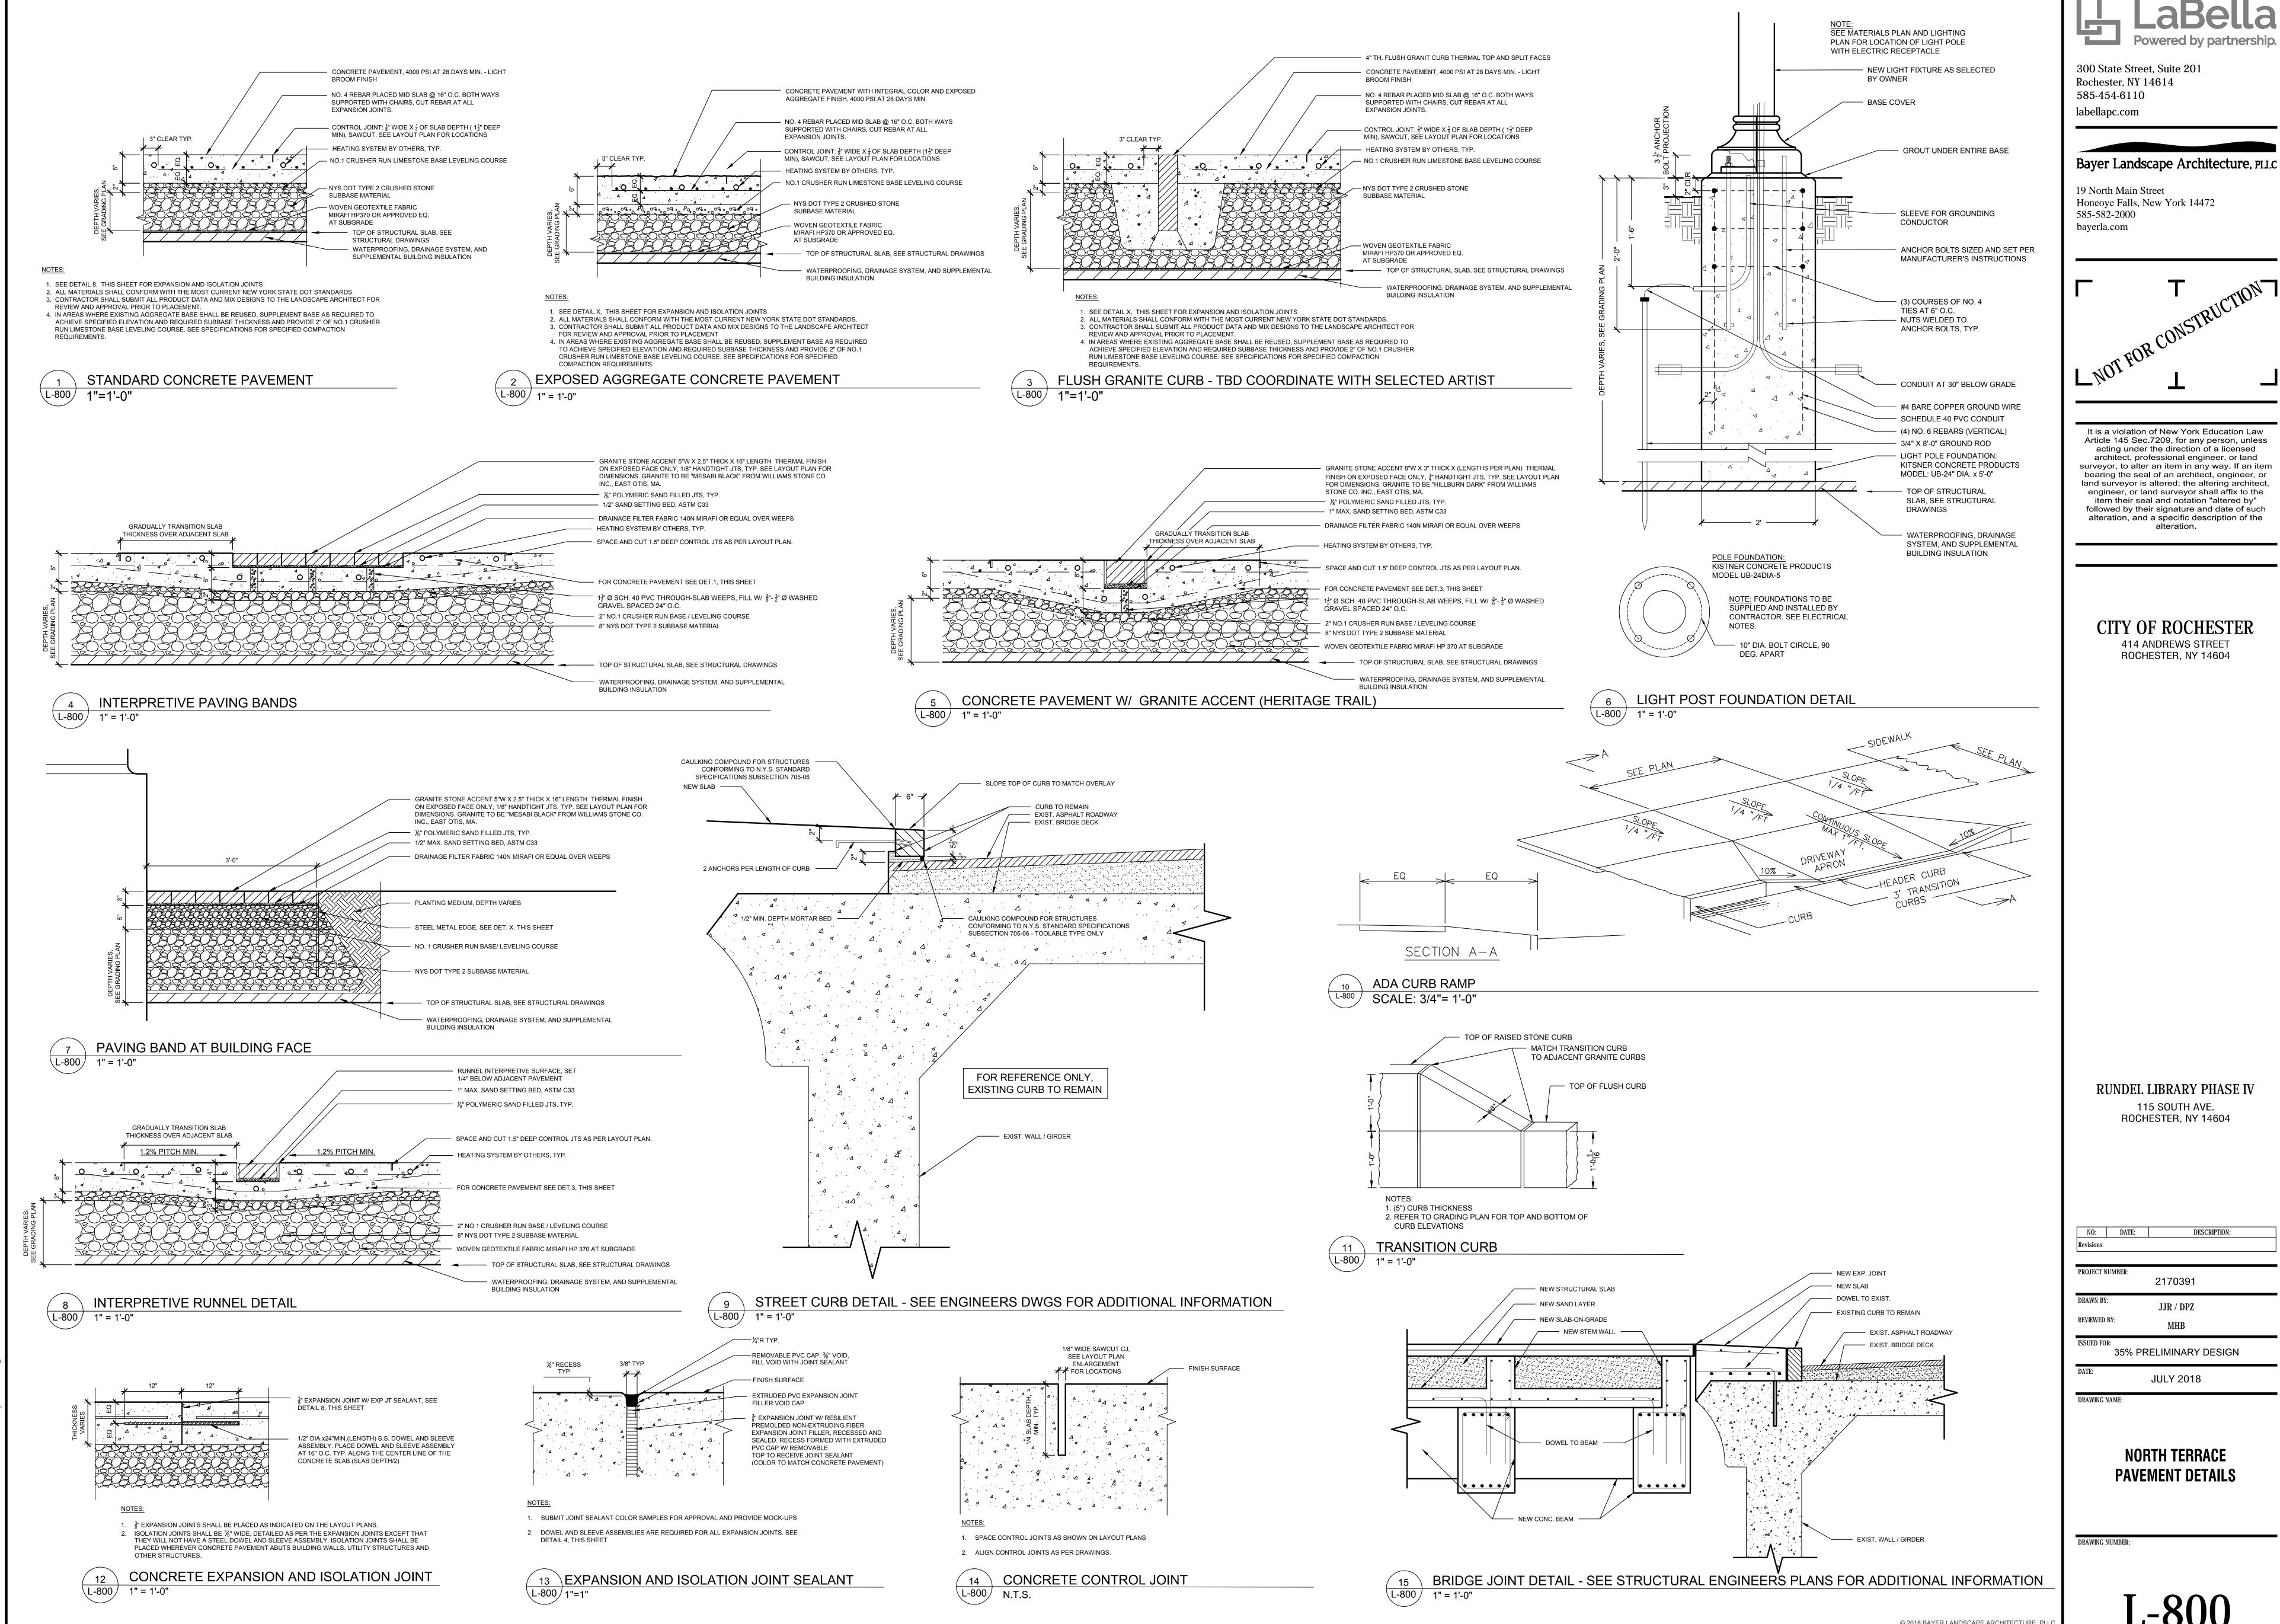
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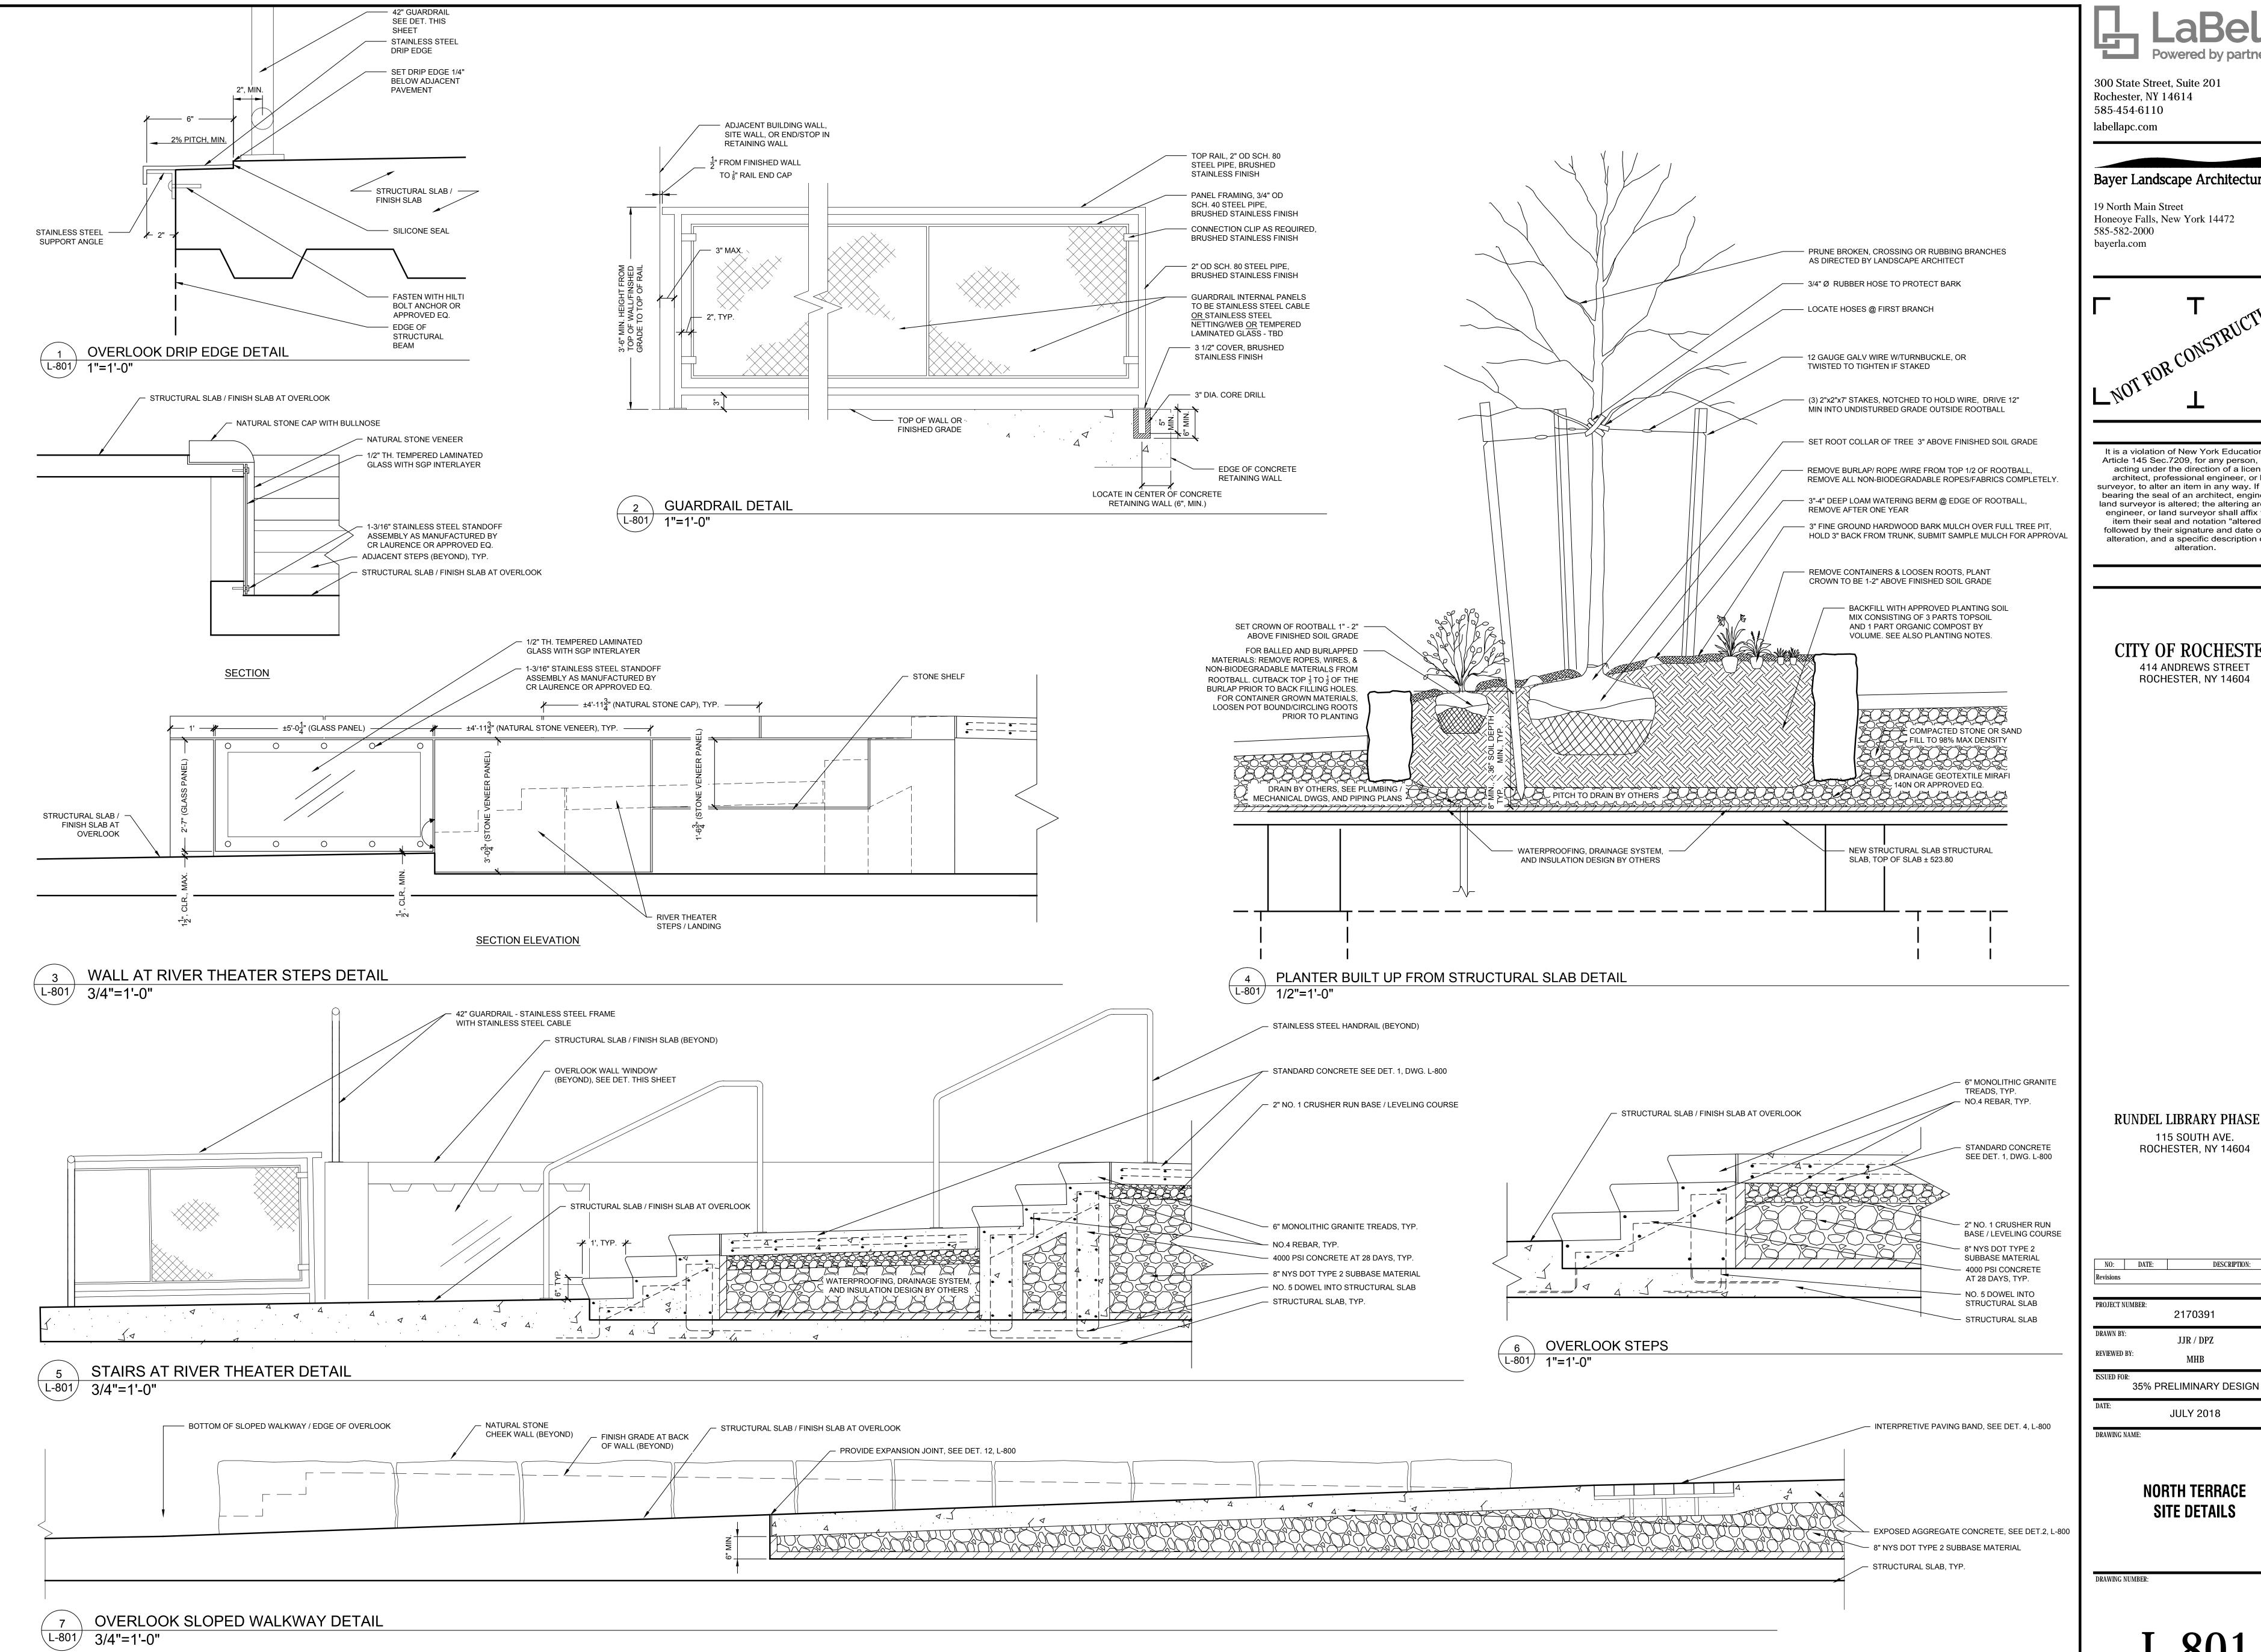
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RUNDEL LIBRARY PHASE IV 115 SOUTH AVE. ROCHESTER, NY 14604

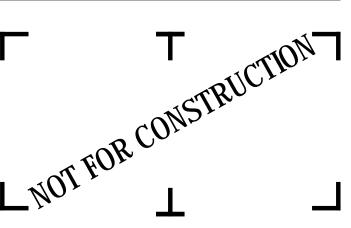
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> **NORTH TERRACE IRRIGATION PLAN**





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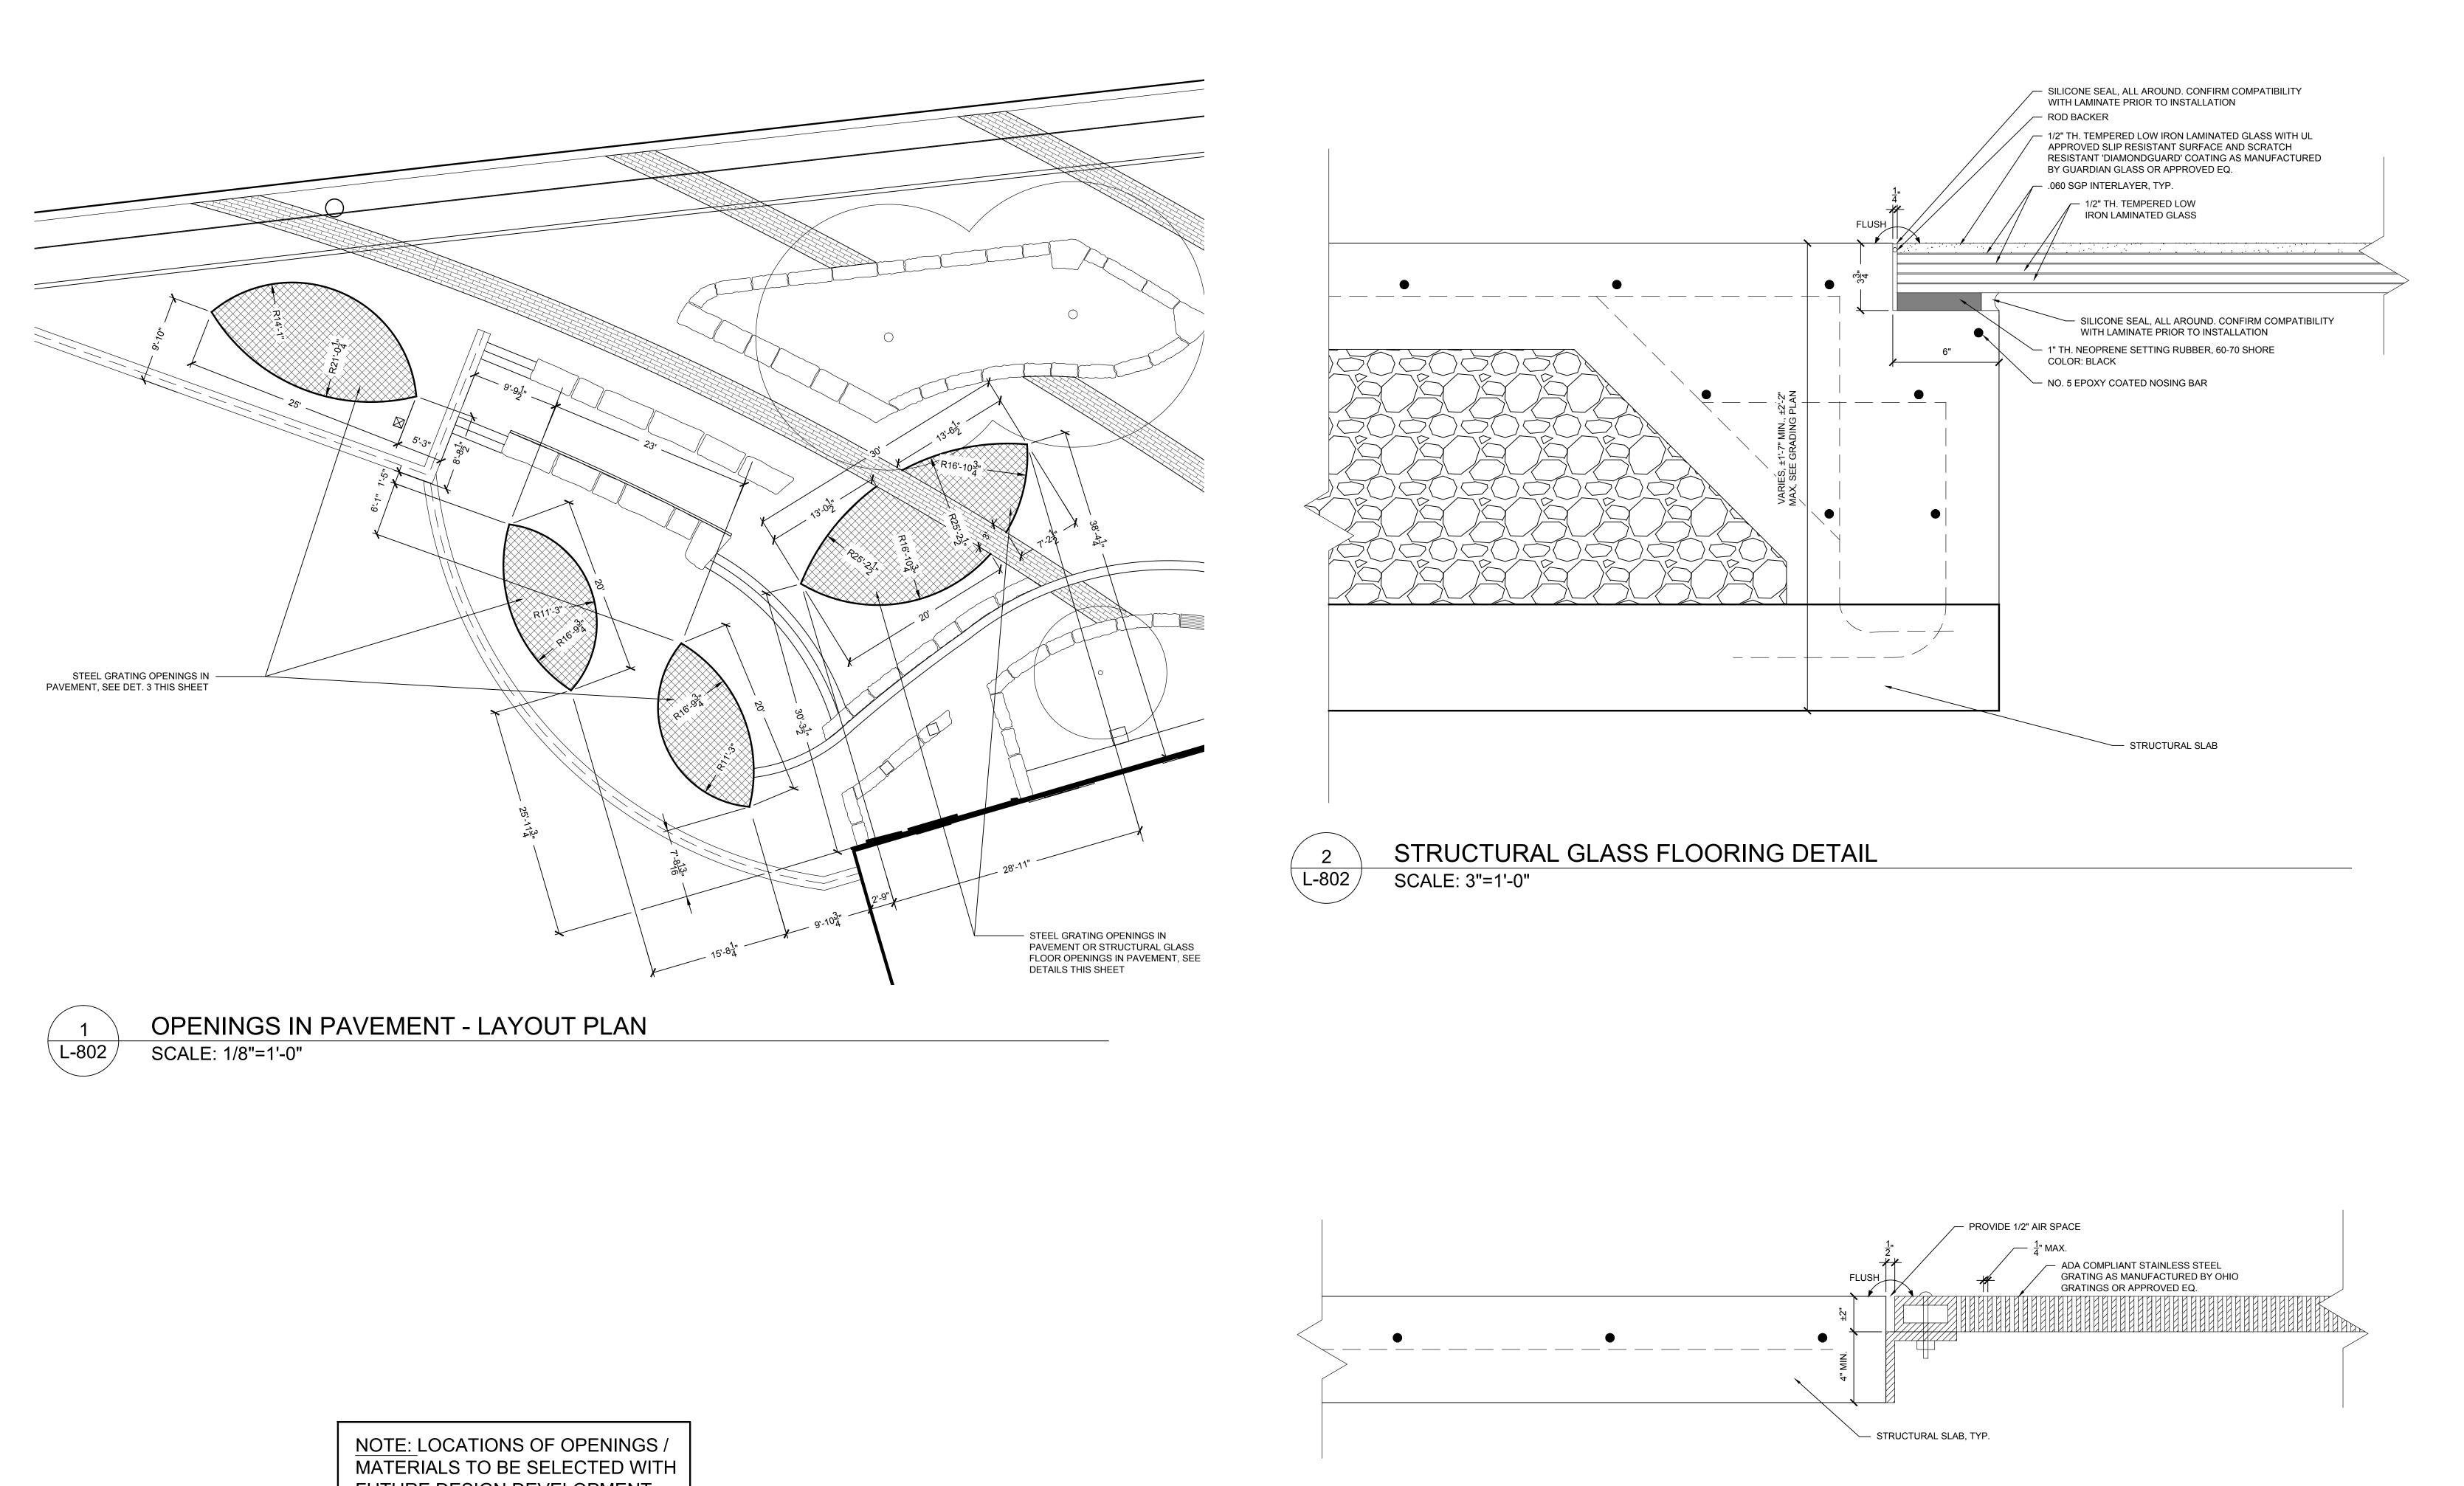
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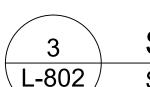
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**NORTH TERRACE** 

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FUTURE DESIGN DEVELOPMENT



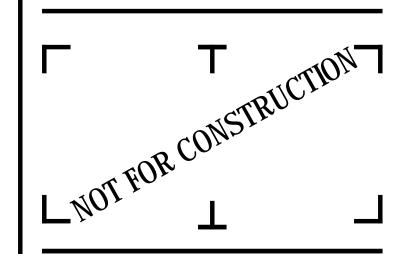
STAINLESS STEEL GRATING DETAIL

SCALE: 3"=1'-0"

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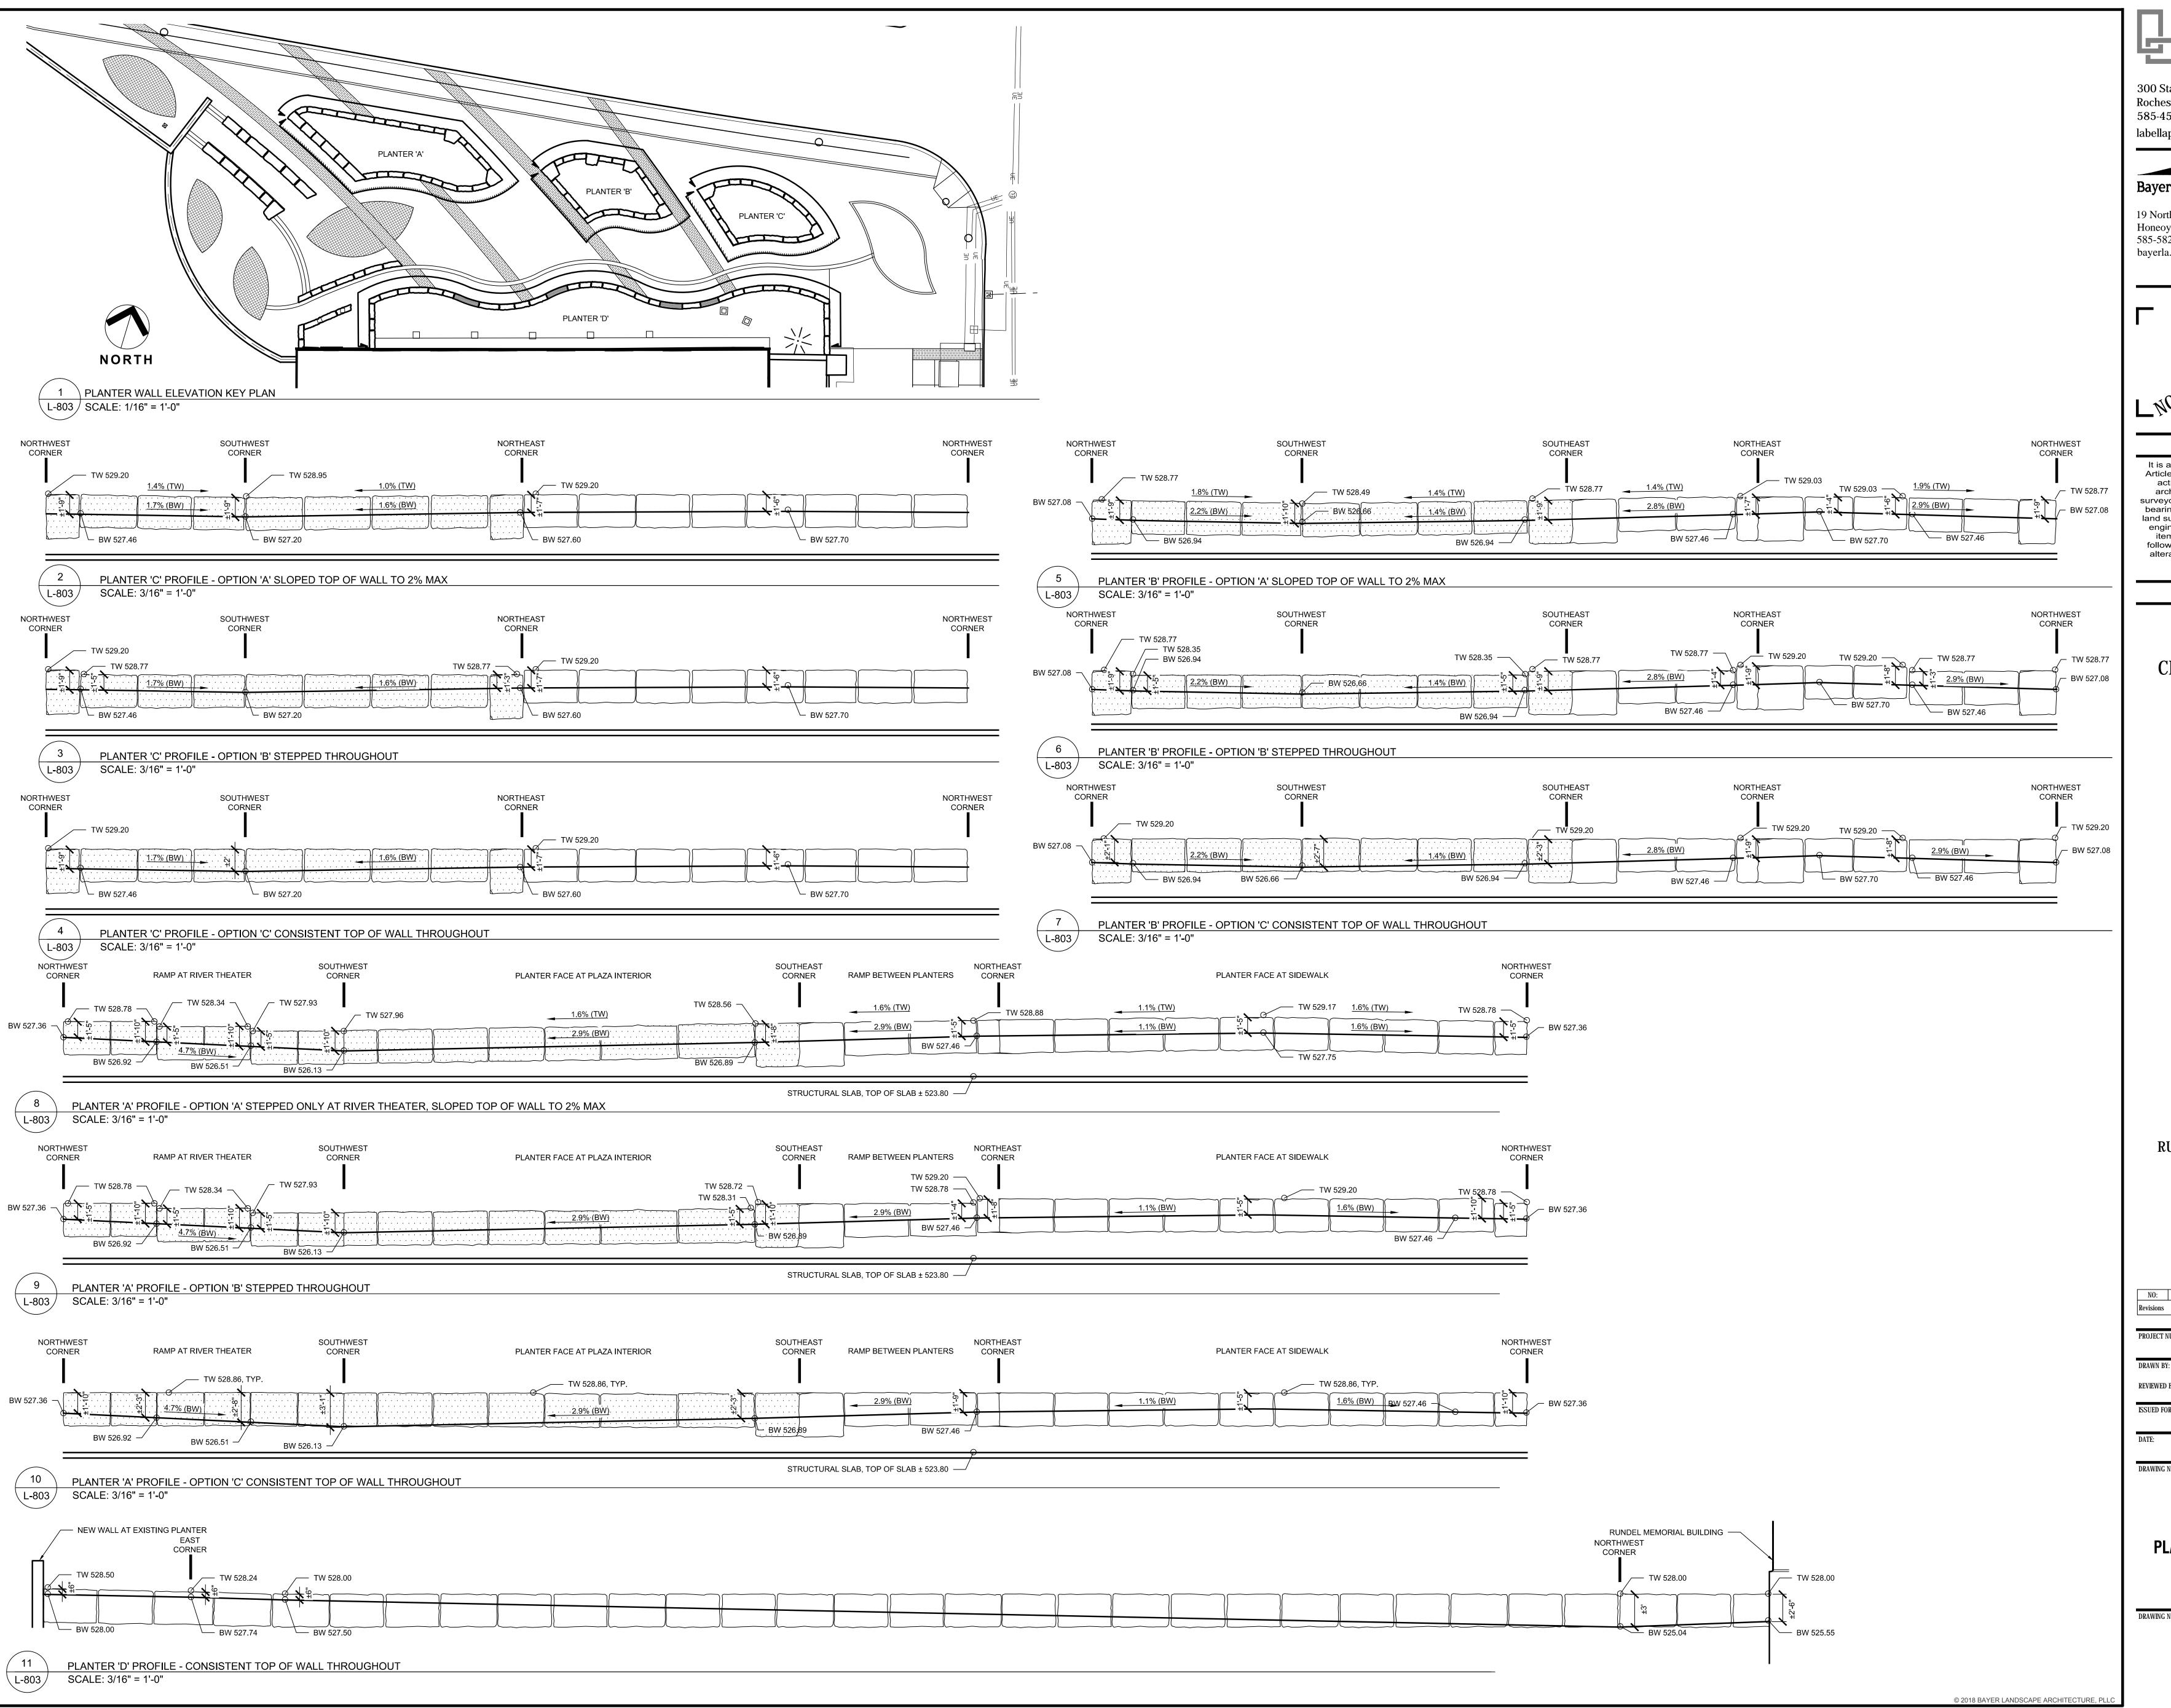
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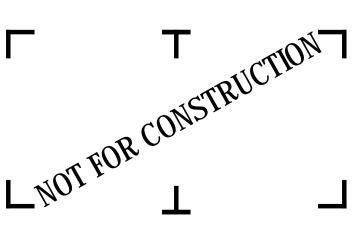
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**NORTH TERRACE GLASS FLOORING DETAILS** 



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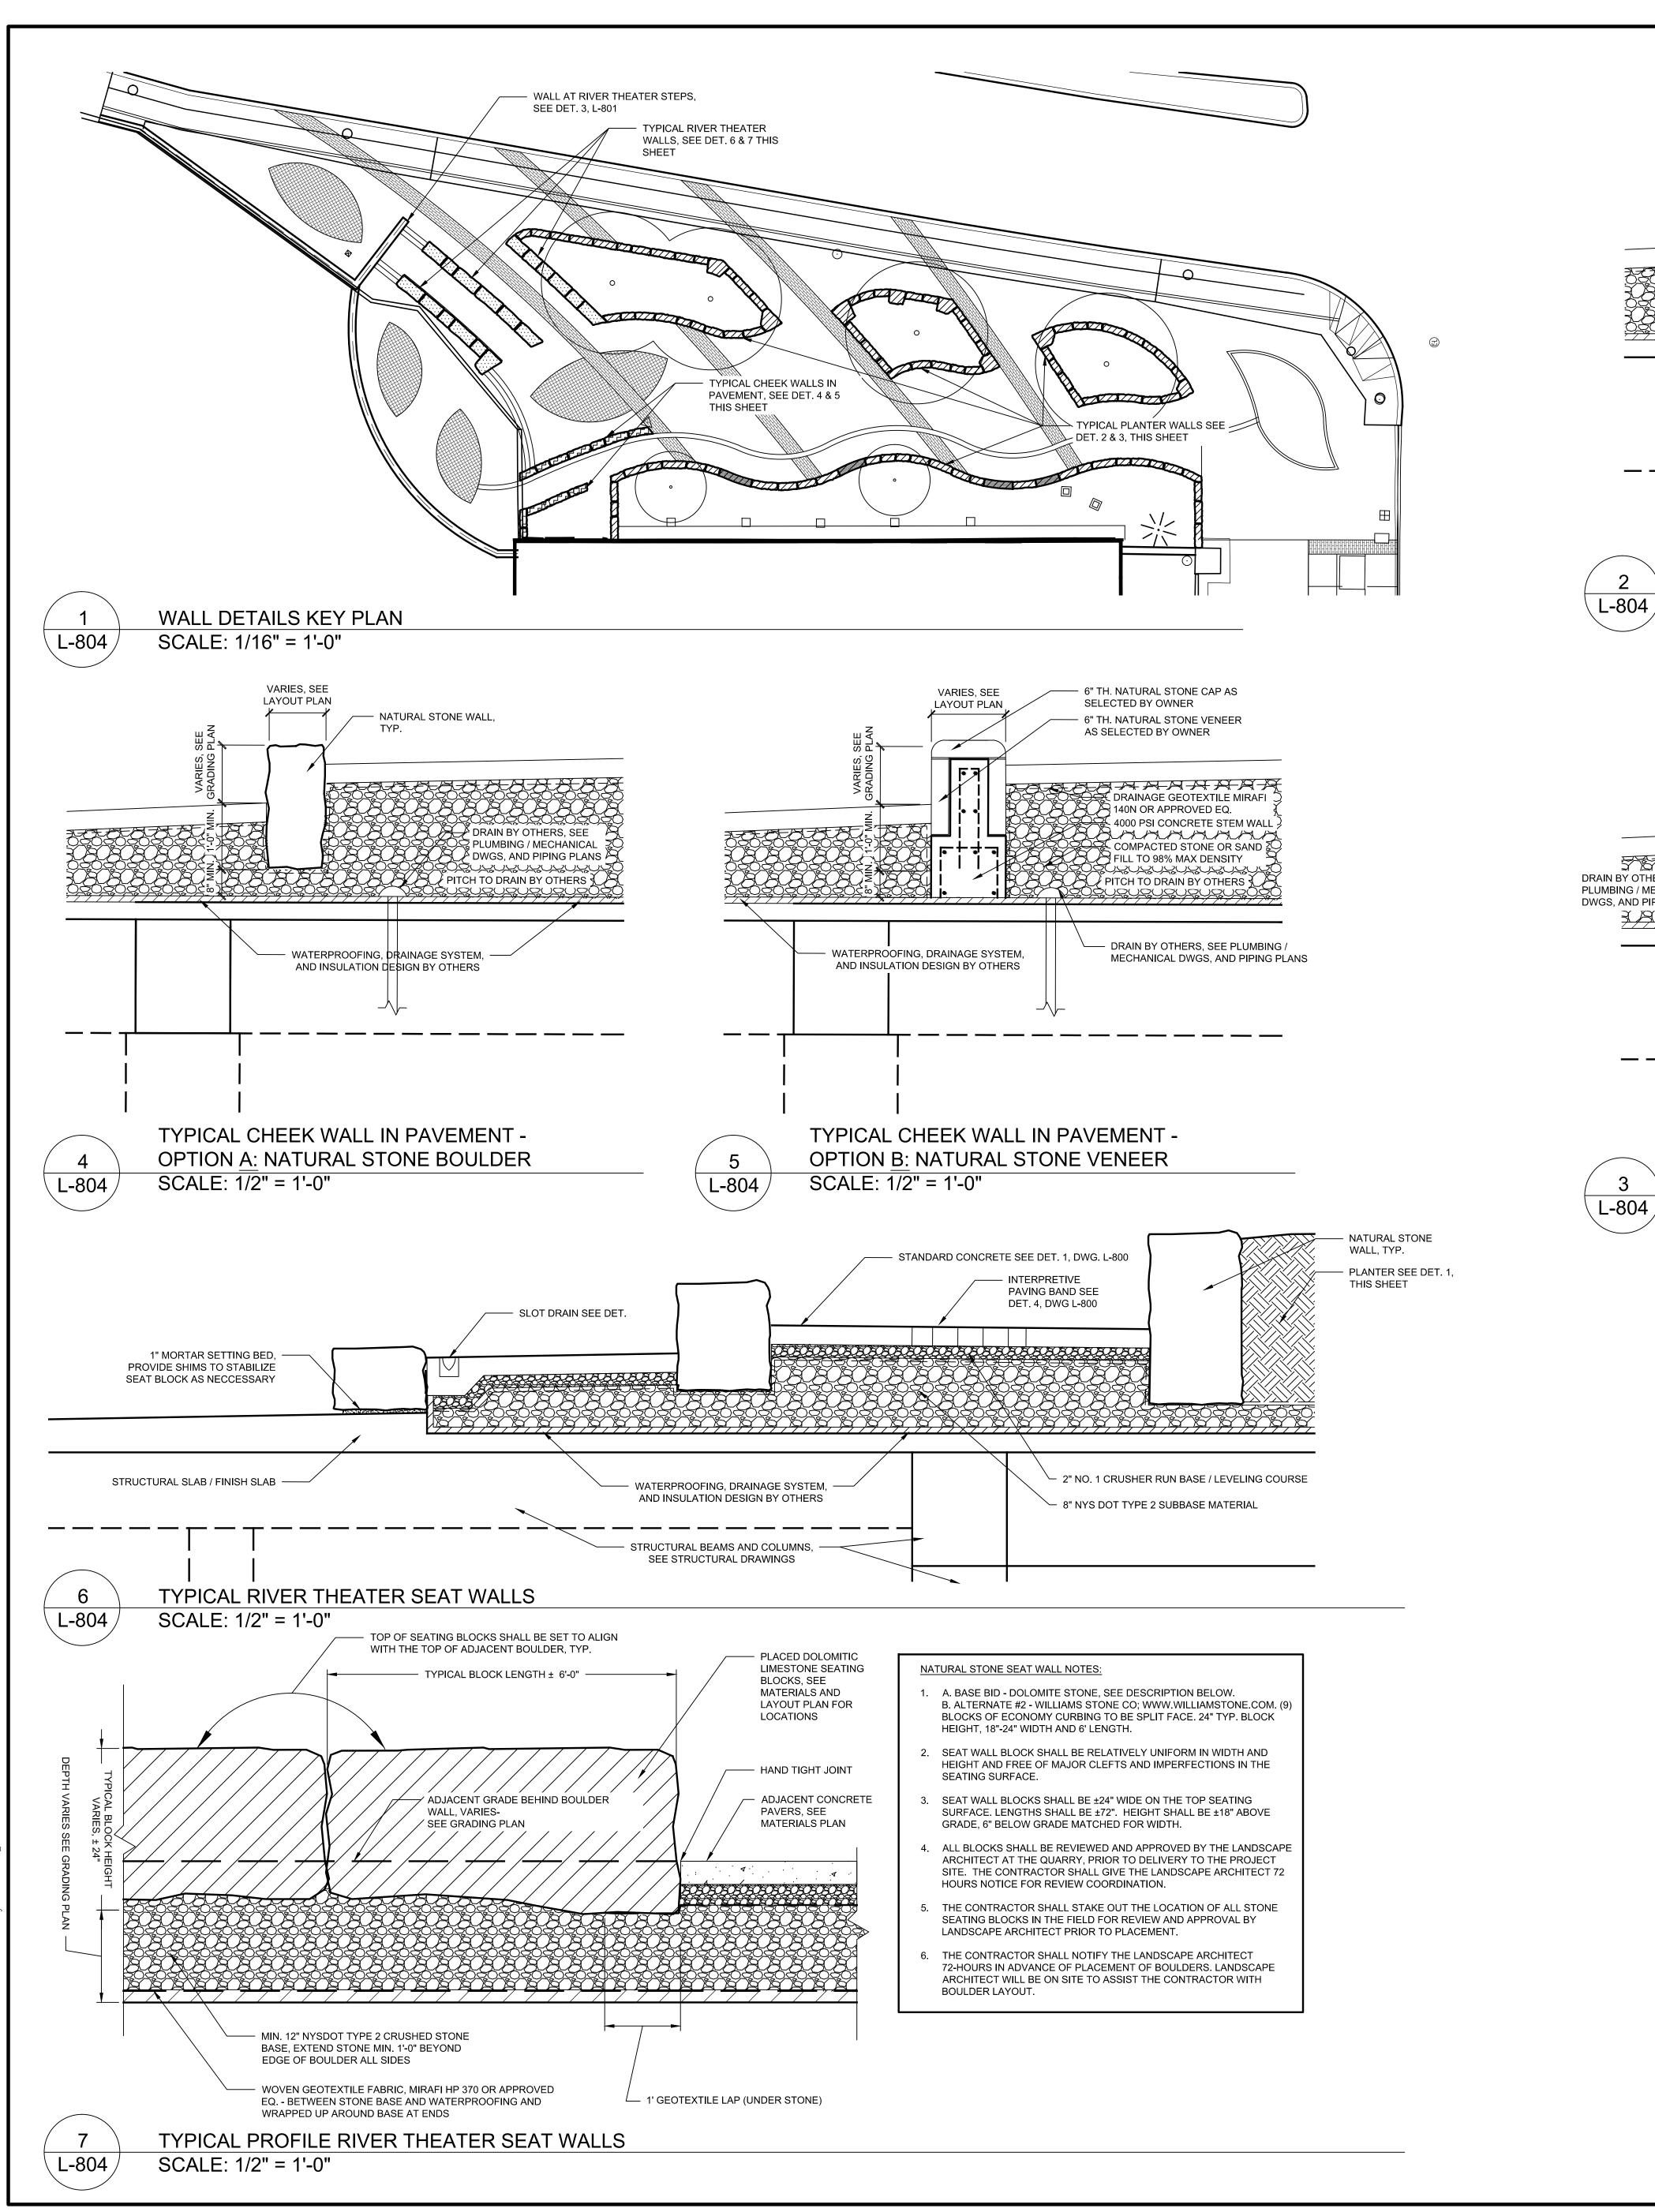
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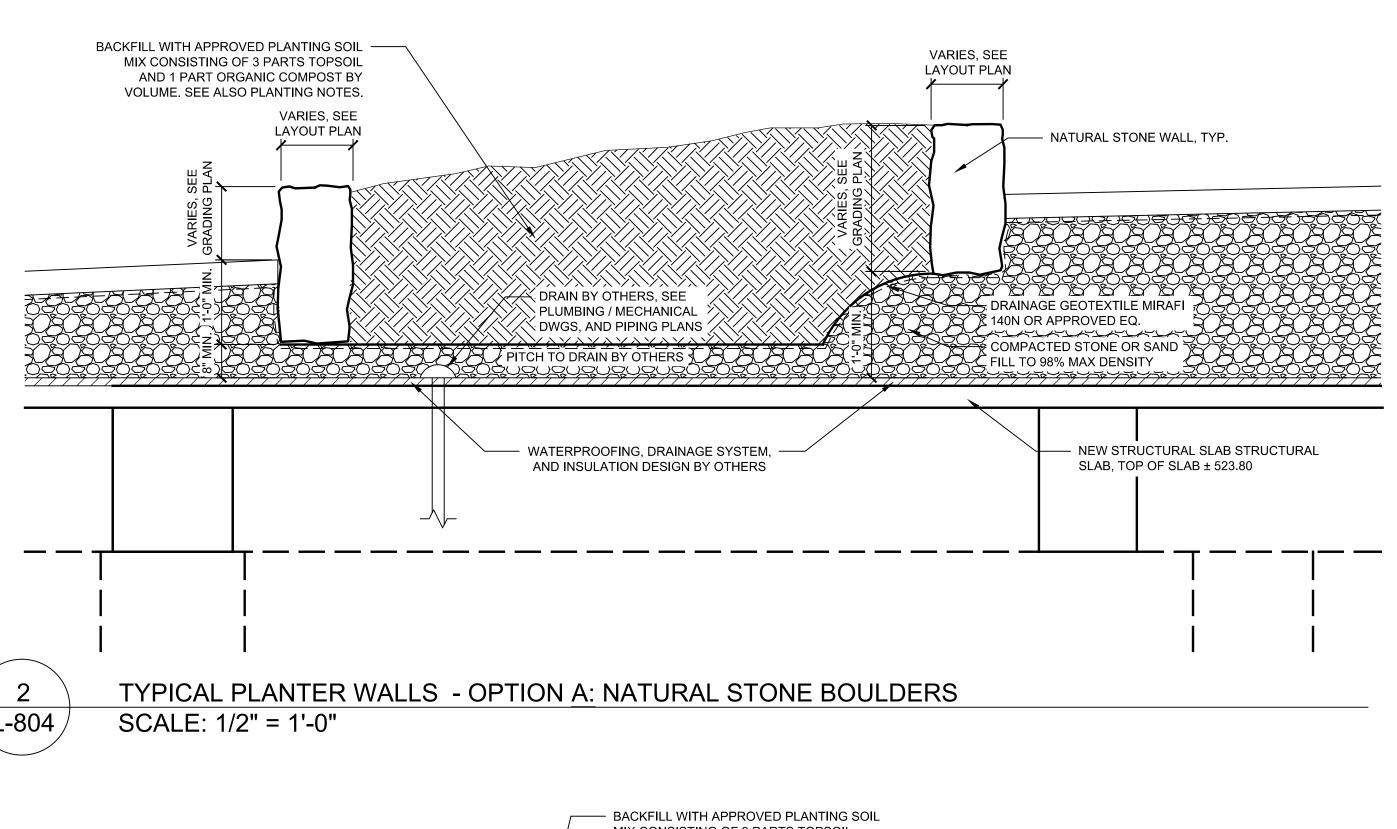
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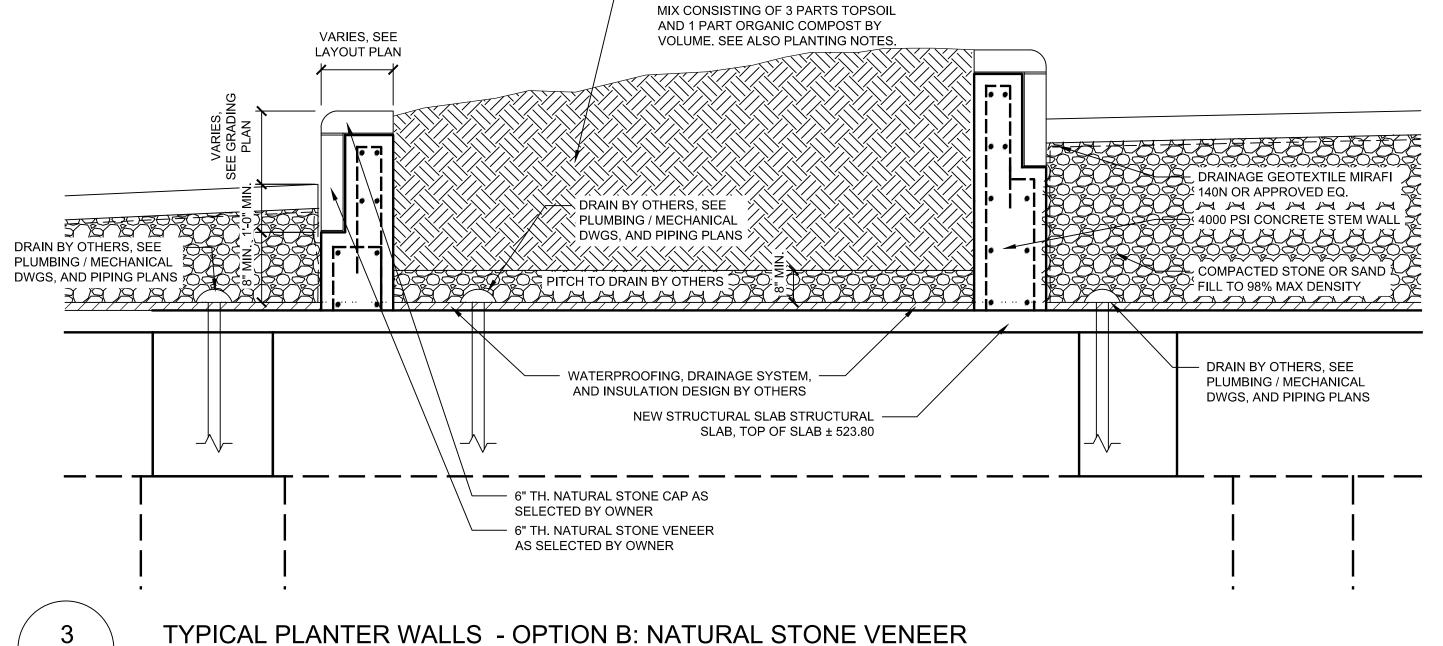
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PROJECT NUMBER:	0470004
	2170391
DRAWN BY:	JJR / DPZ
DEVIEWED DV.	JJIV / DI L
REVIEWED BY:	MHB
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DATE:	HH V 0040
	JULY 2018
DRAWING NAME:	

**NORTH TERRACE** PLANTER WALL ELEVATION **STUDIES** 

DRAWING NUMBER:







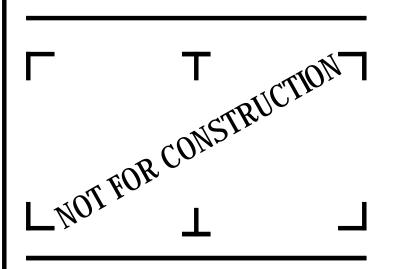
SCALE: 1/2" = 1'-0"

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REVIEWED BY: MHB

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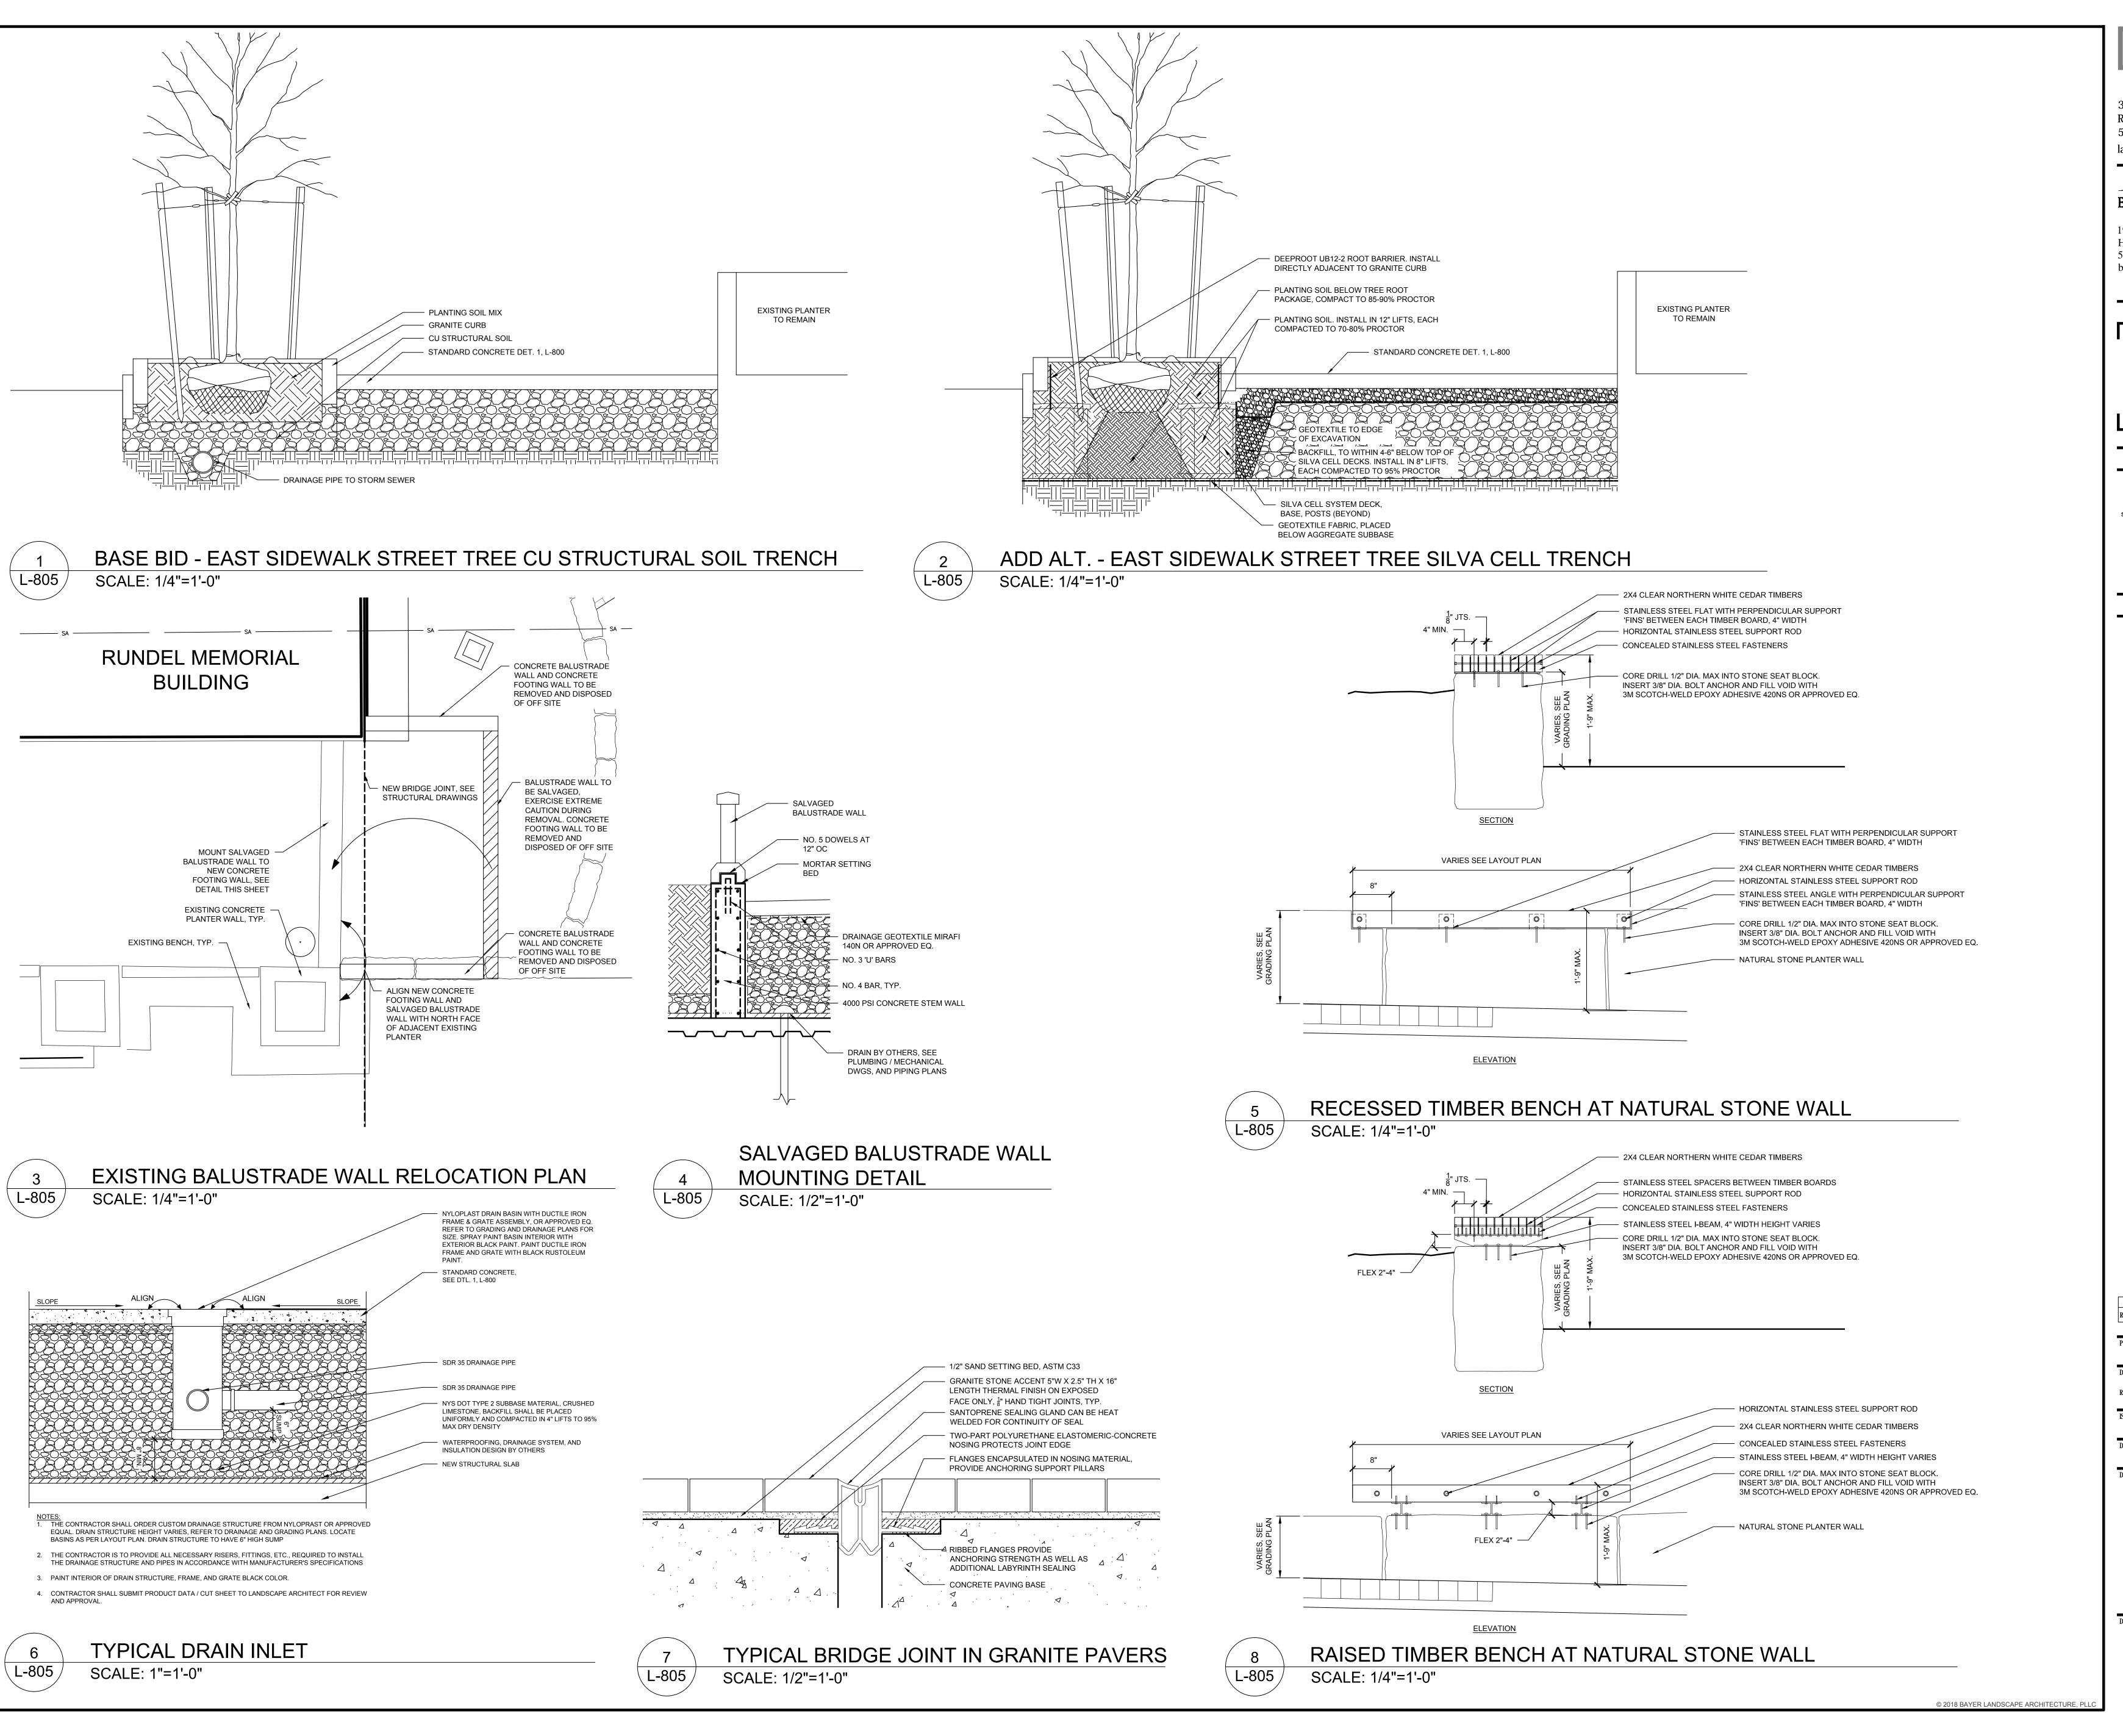
DATE: JULY 2018

DRAWING NAME:

NORTH TERRACE
WALL DETAILS

DRAWING NUMBER:

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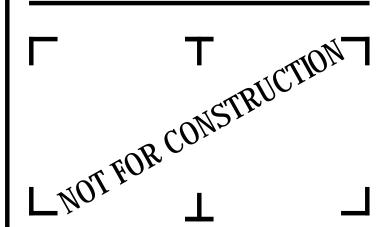


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115 SOUTH AVE. ROCHESTER, NY 14604

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Revisions

PROJECT NUMBER:

2170391

DRAWN BY:

JJR / DPZ
REVIEWED BY:

MHB

ISSUED FOR:

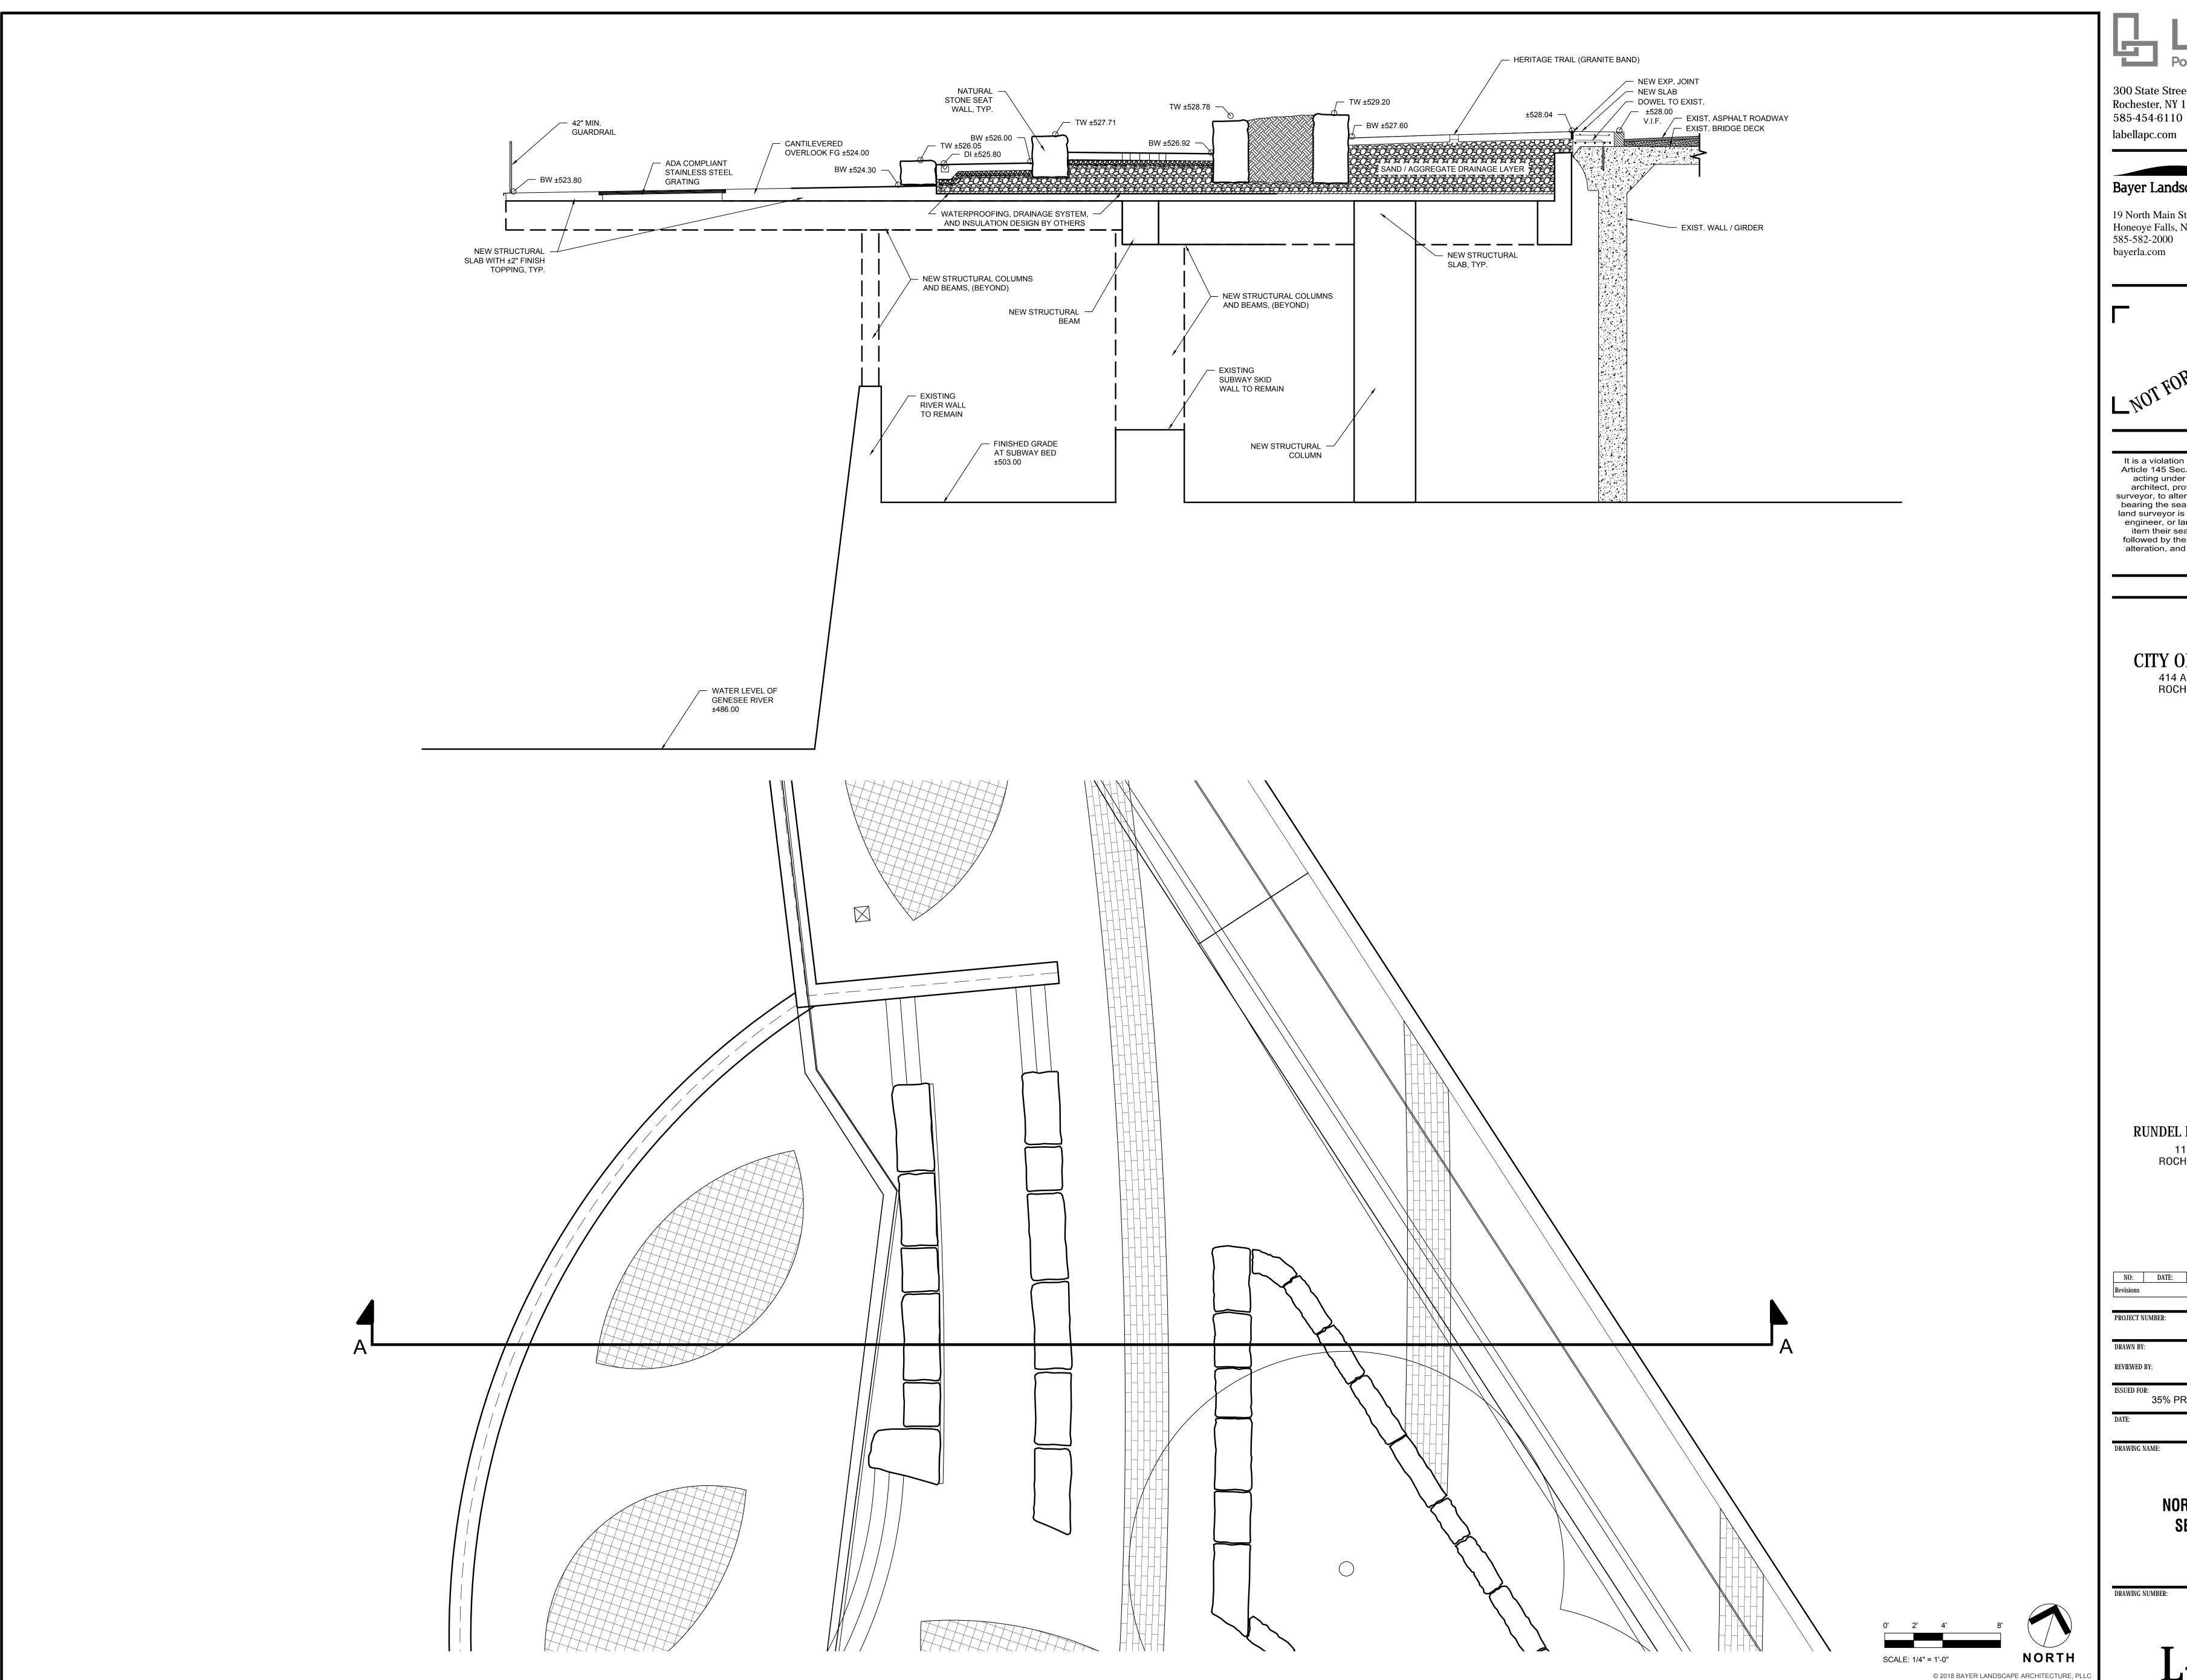
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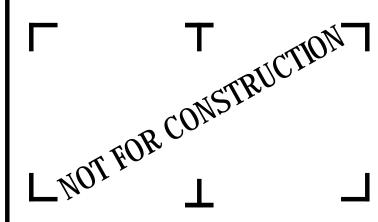




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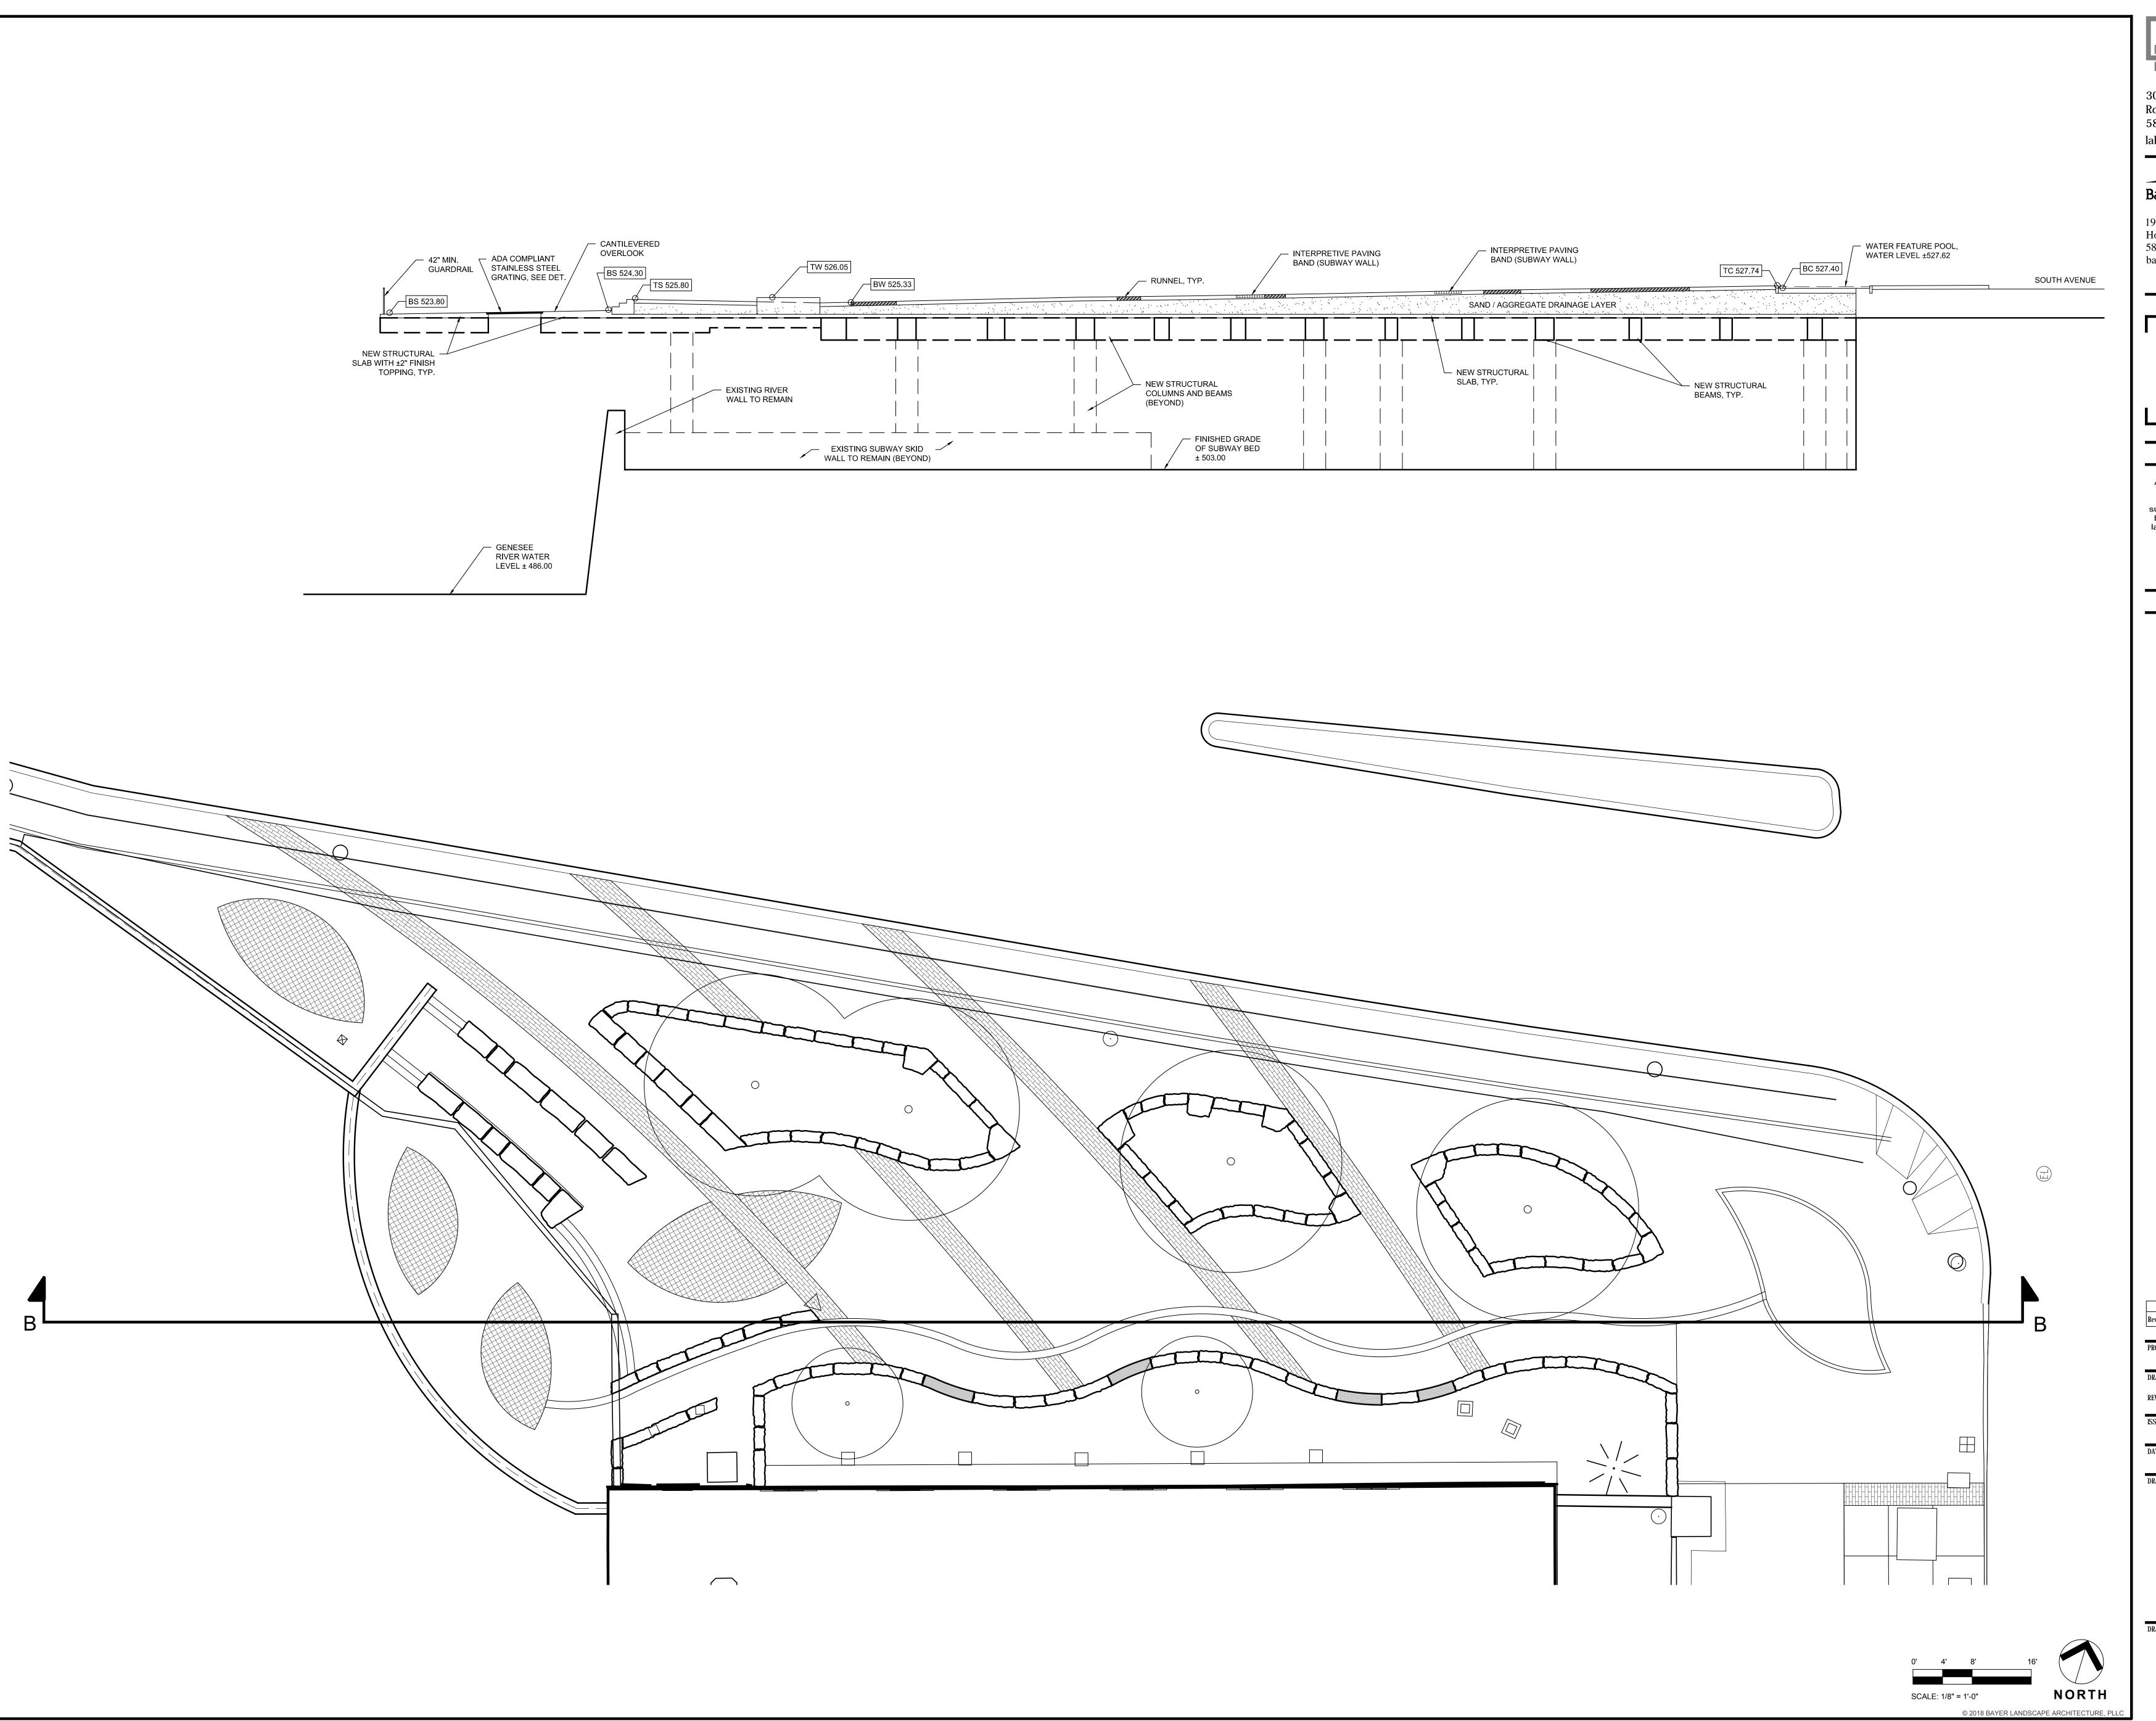
CITY OF ROCHESTER 414 ANDREWS STREET ROCHESTER, NY 14604

RUNDEL LIBRARY PHASE IV 115 SOUTH AVE. ROCHESTER, NY 14604

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PROJECT N	IUMBER:	2170391
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NORTH TERRACE SECTION A.A

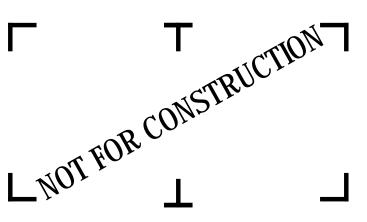
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REVIEWED BY: MHB

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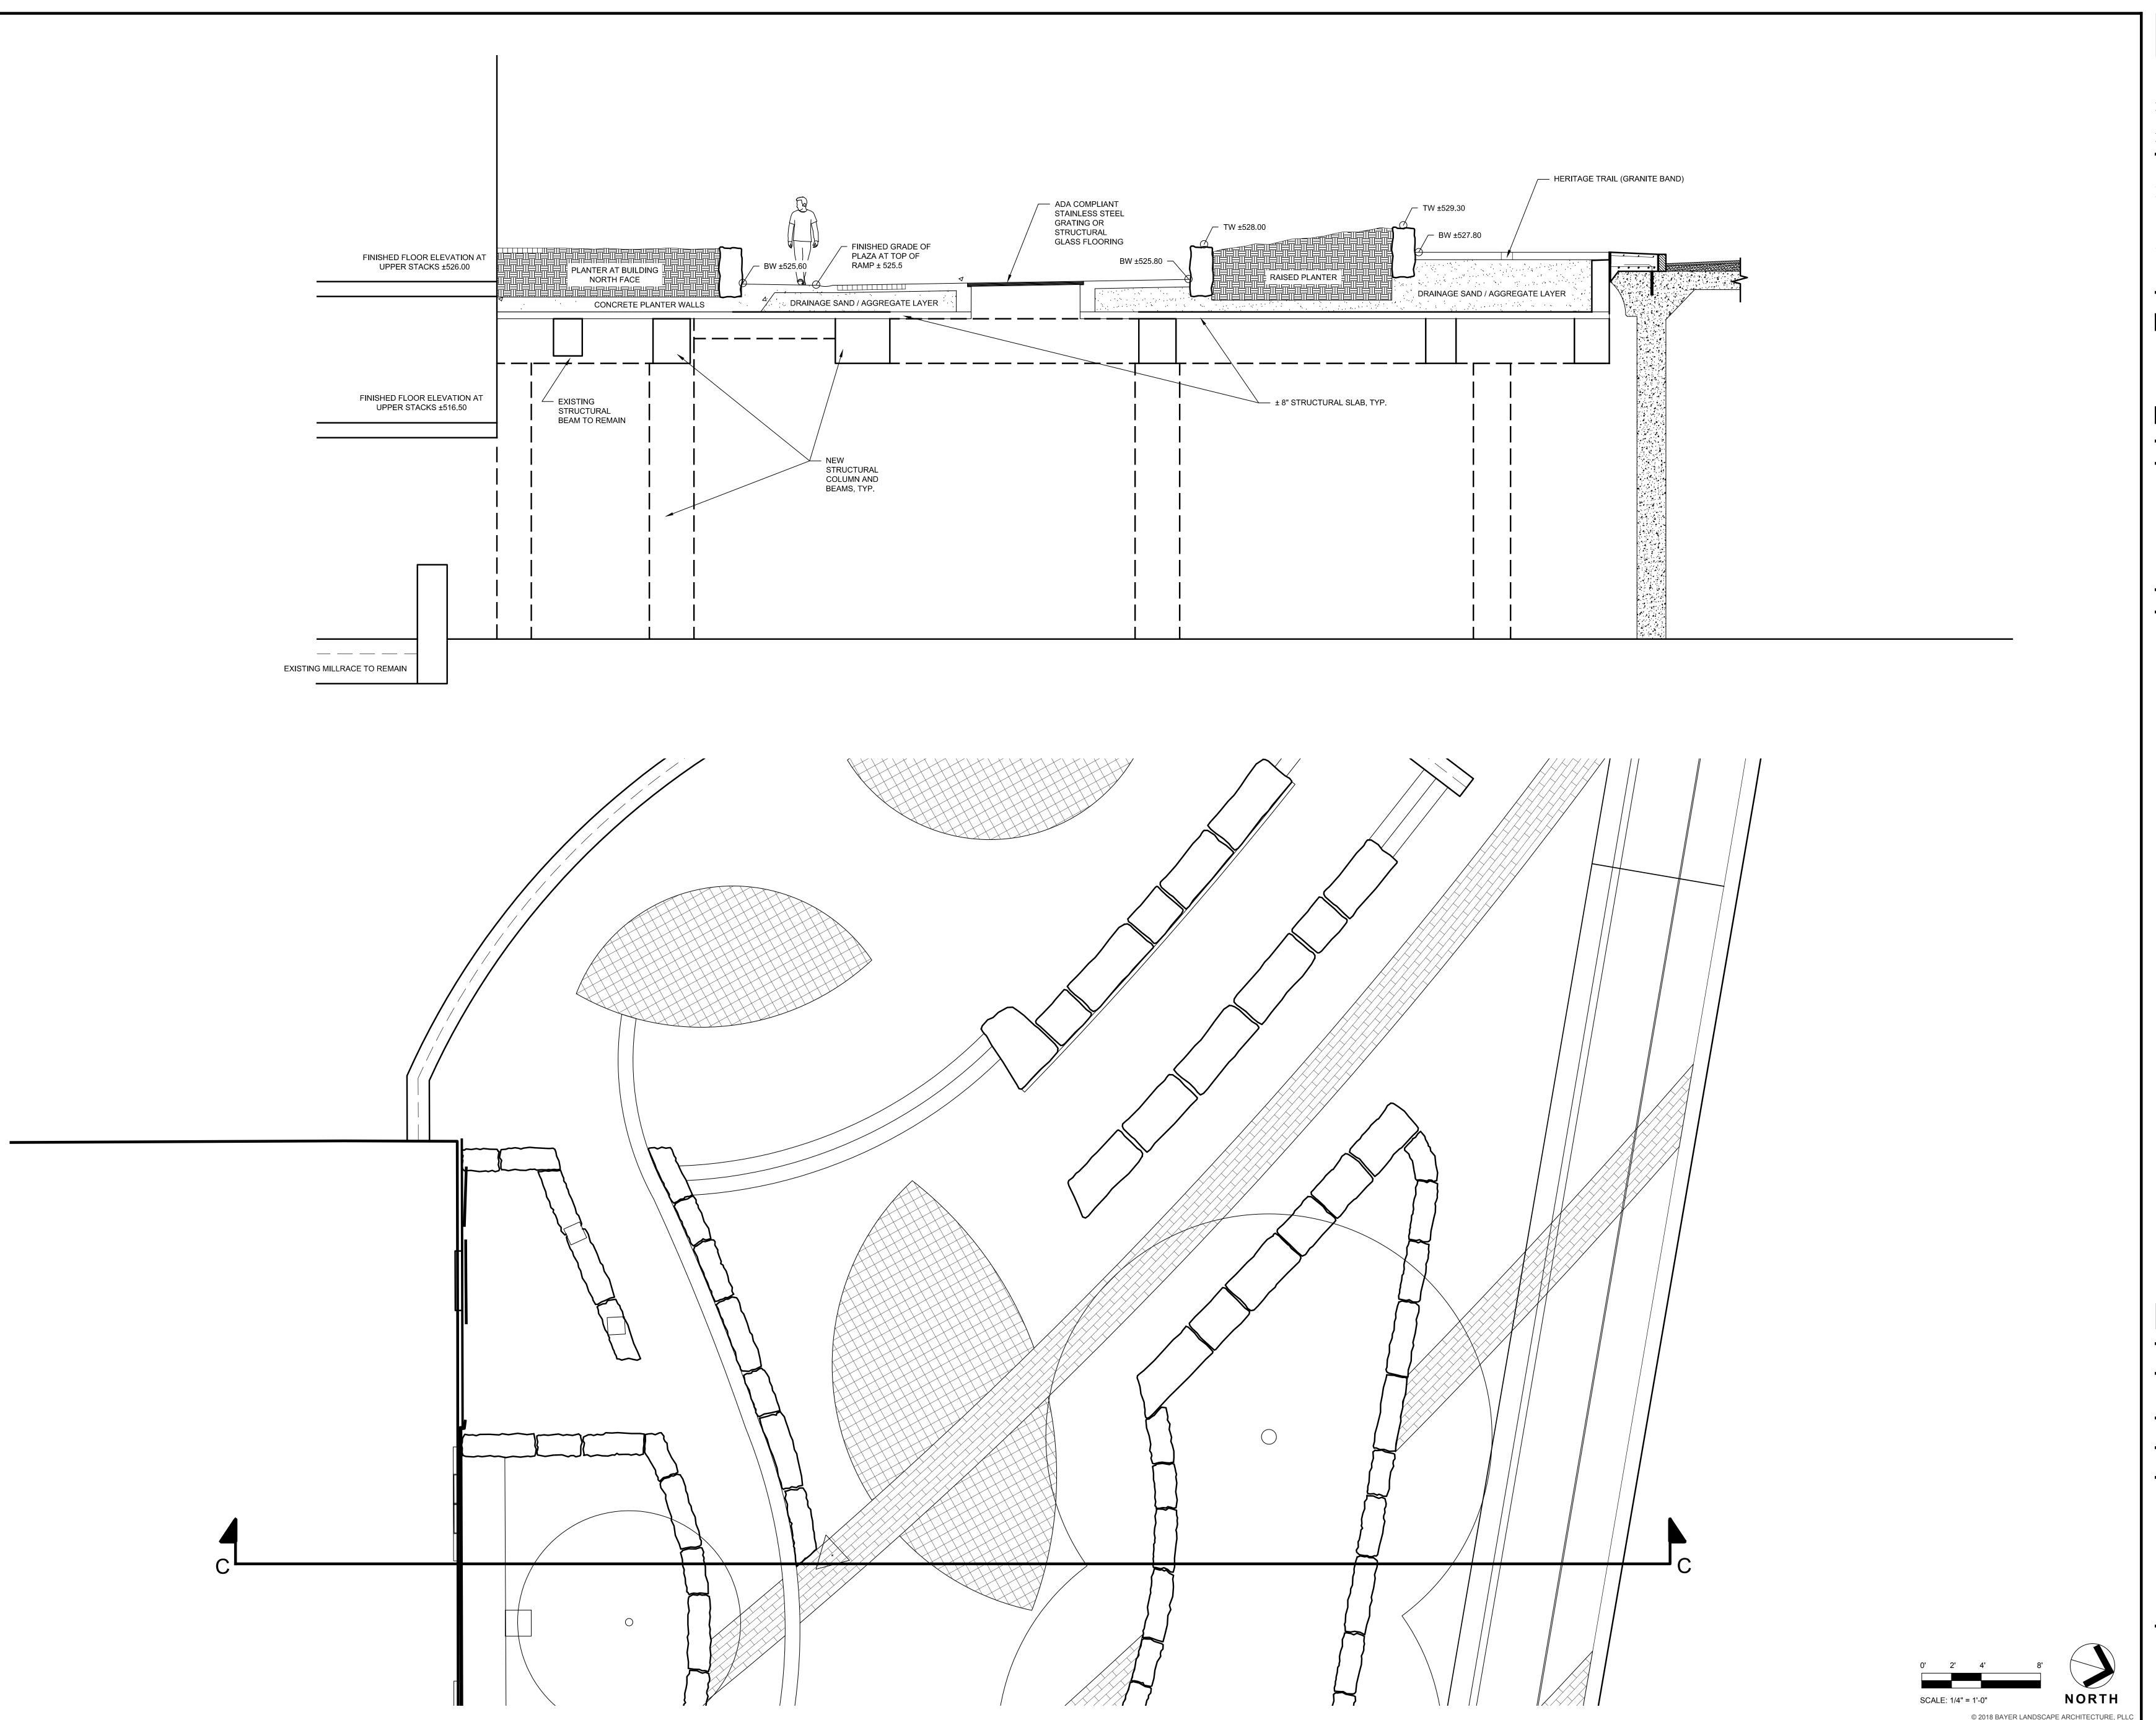
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DATE: JULY 2018

DRAWING NAME:

NORTH TERRACE SECTION B.B

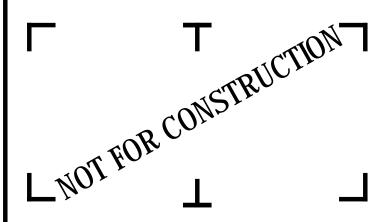
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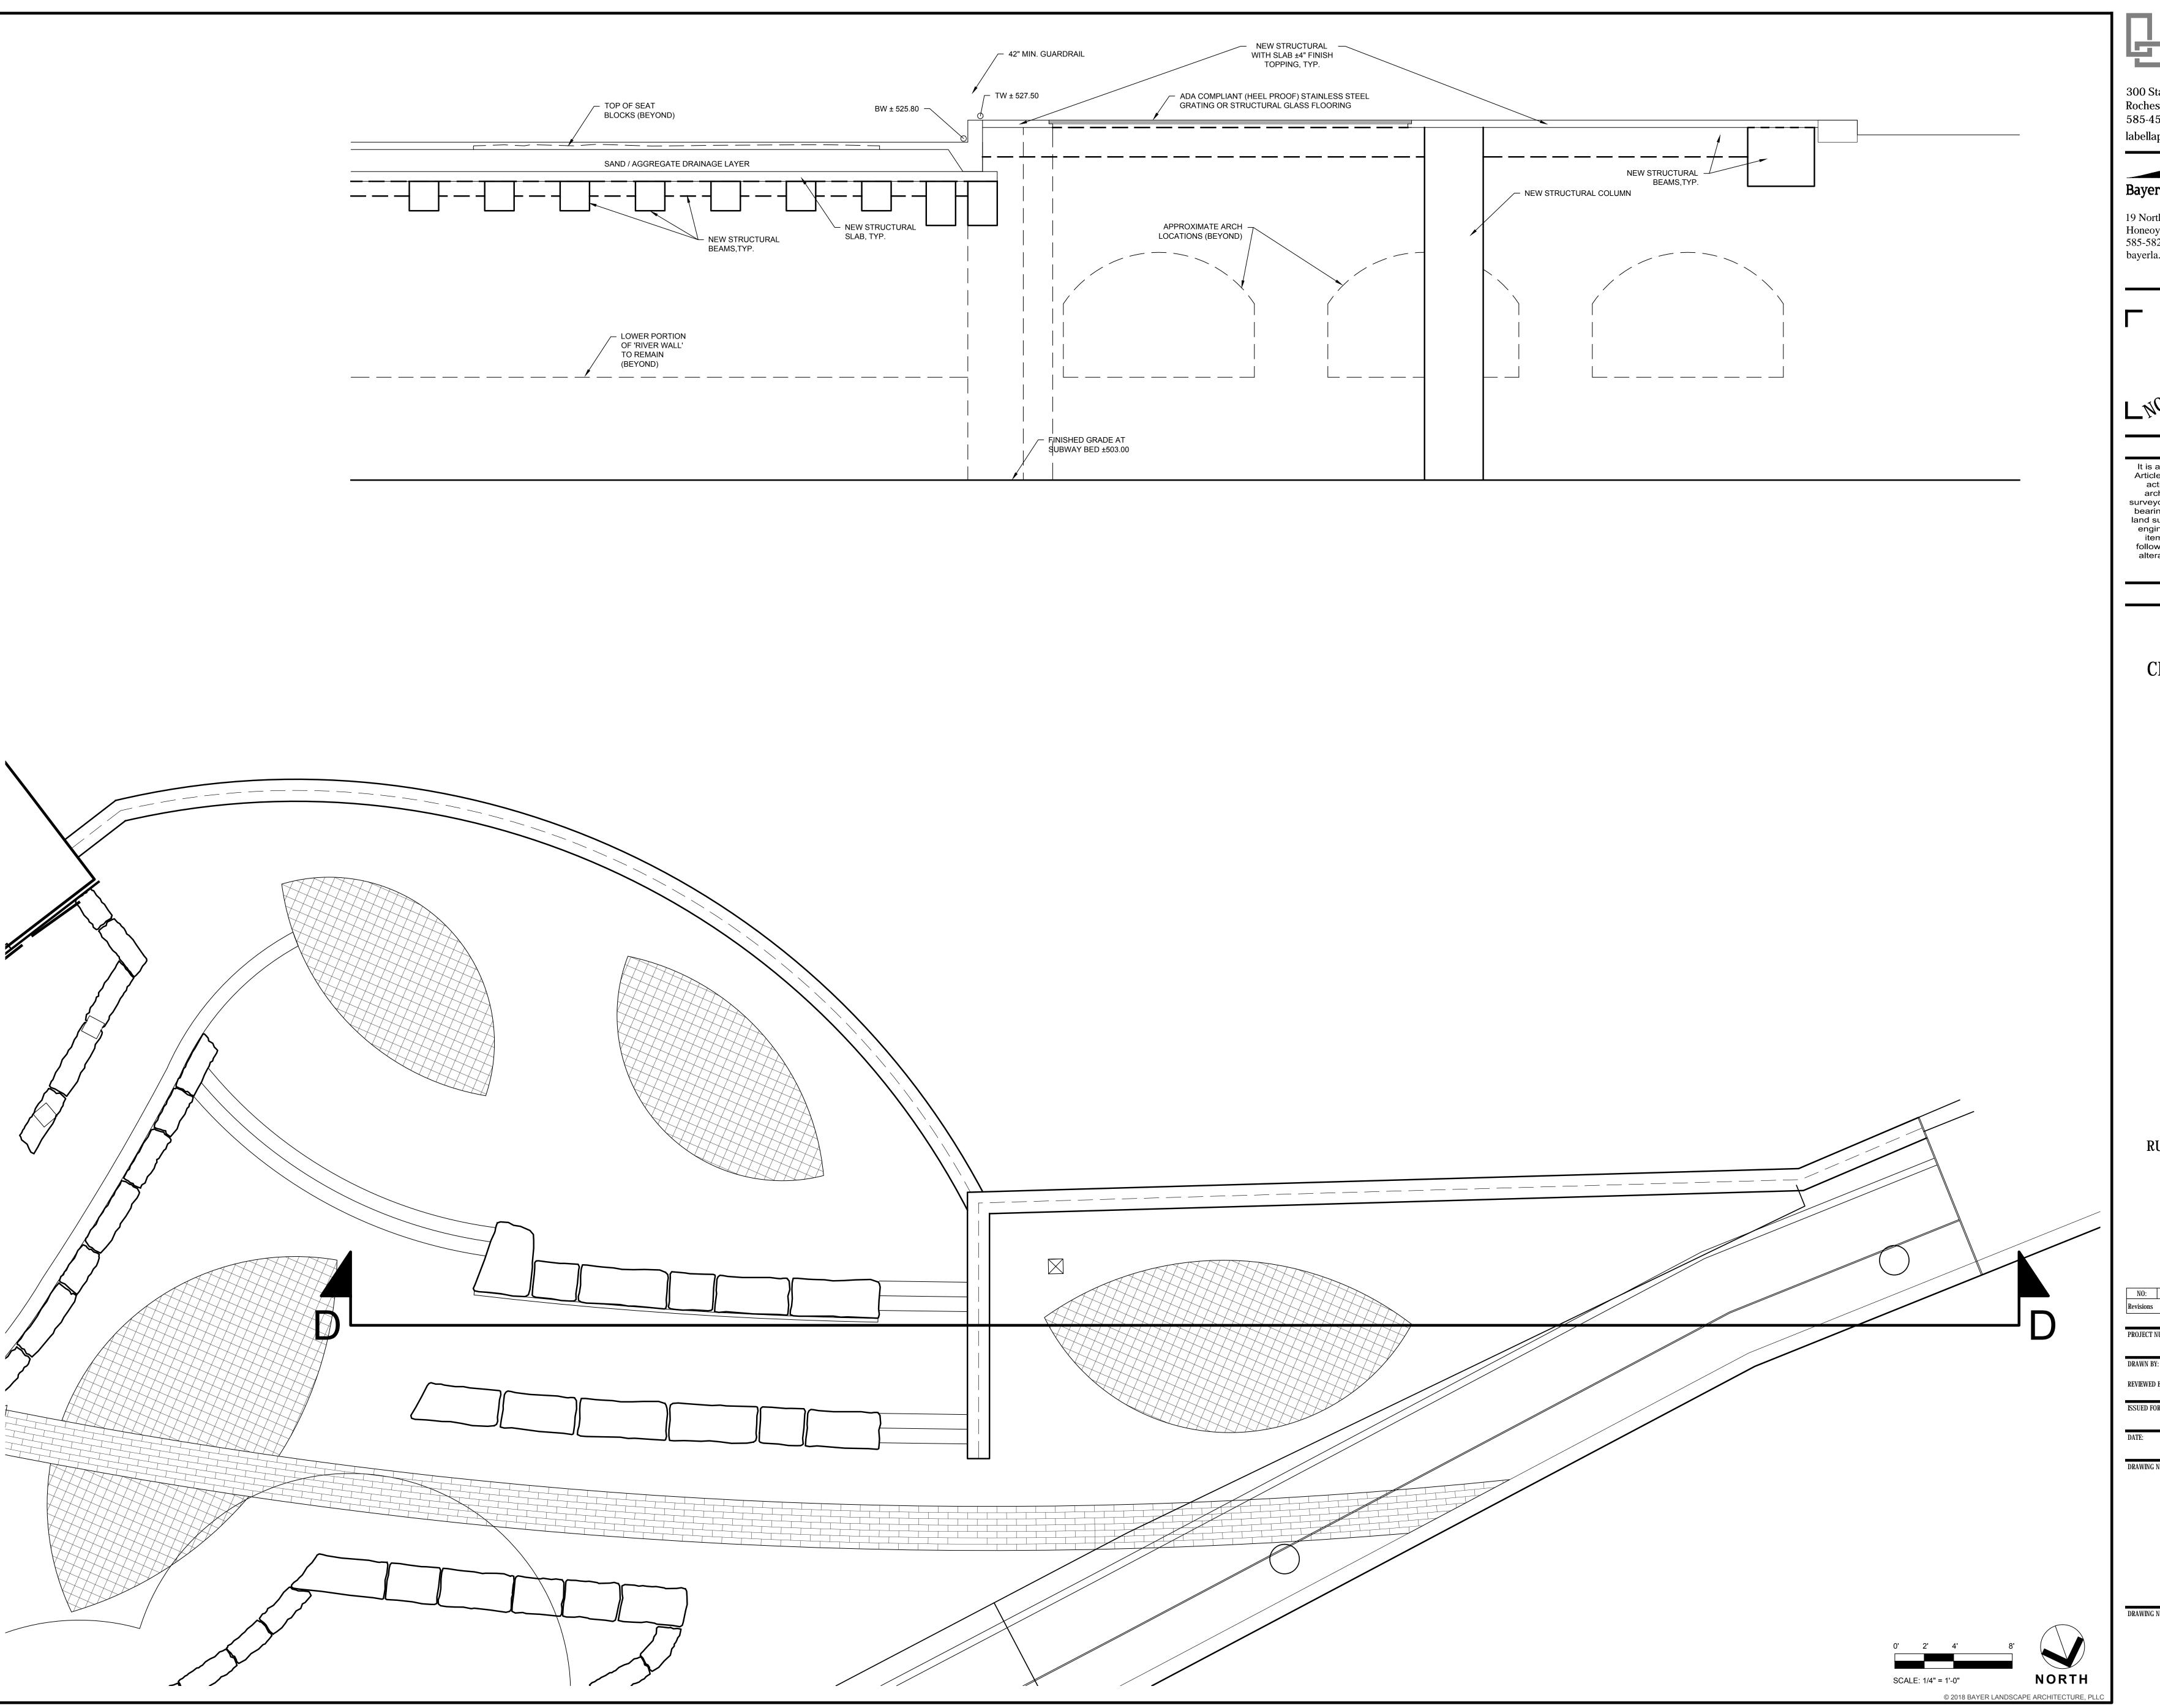
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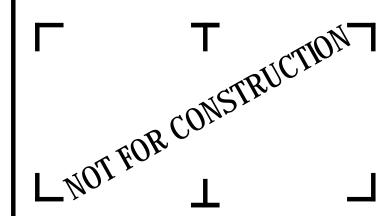
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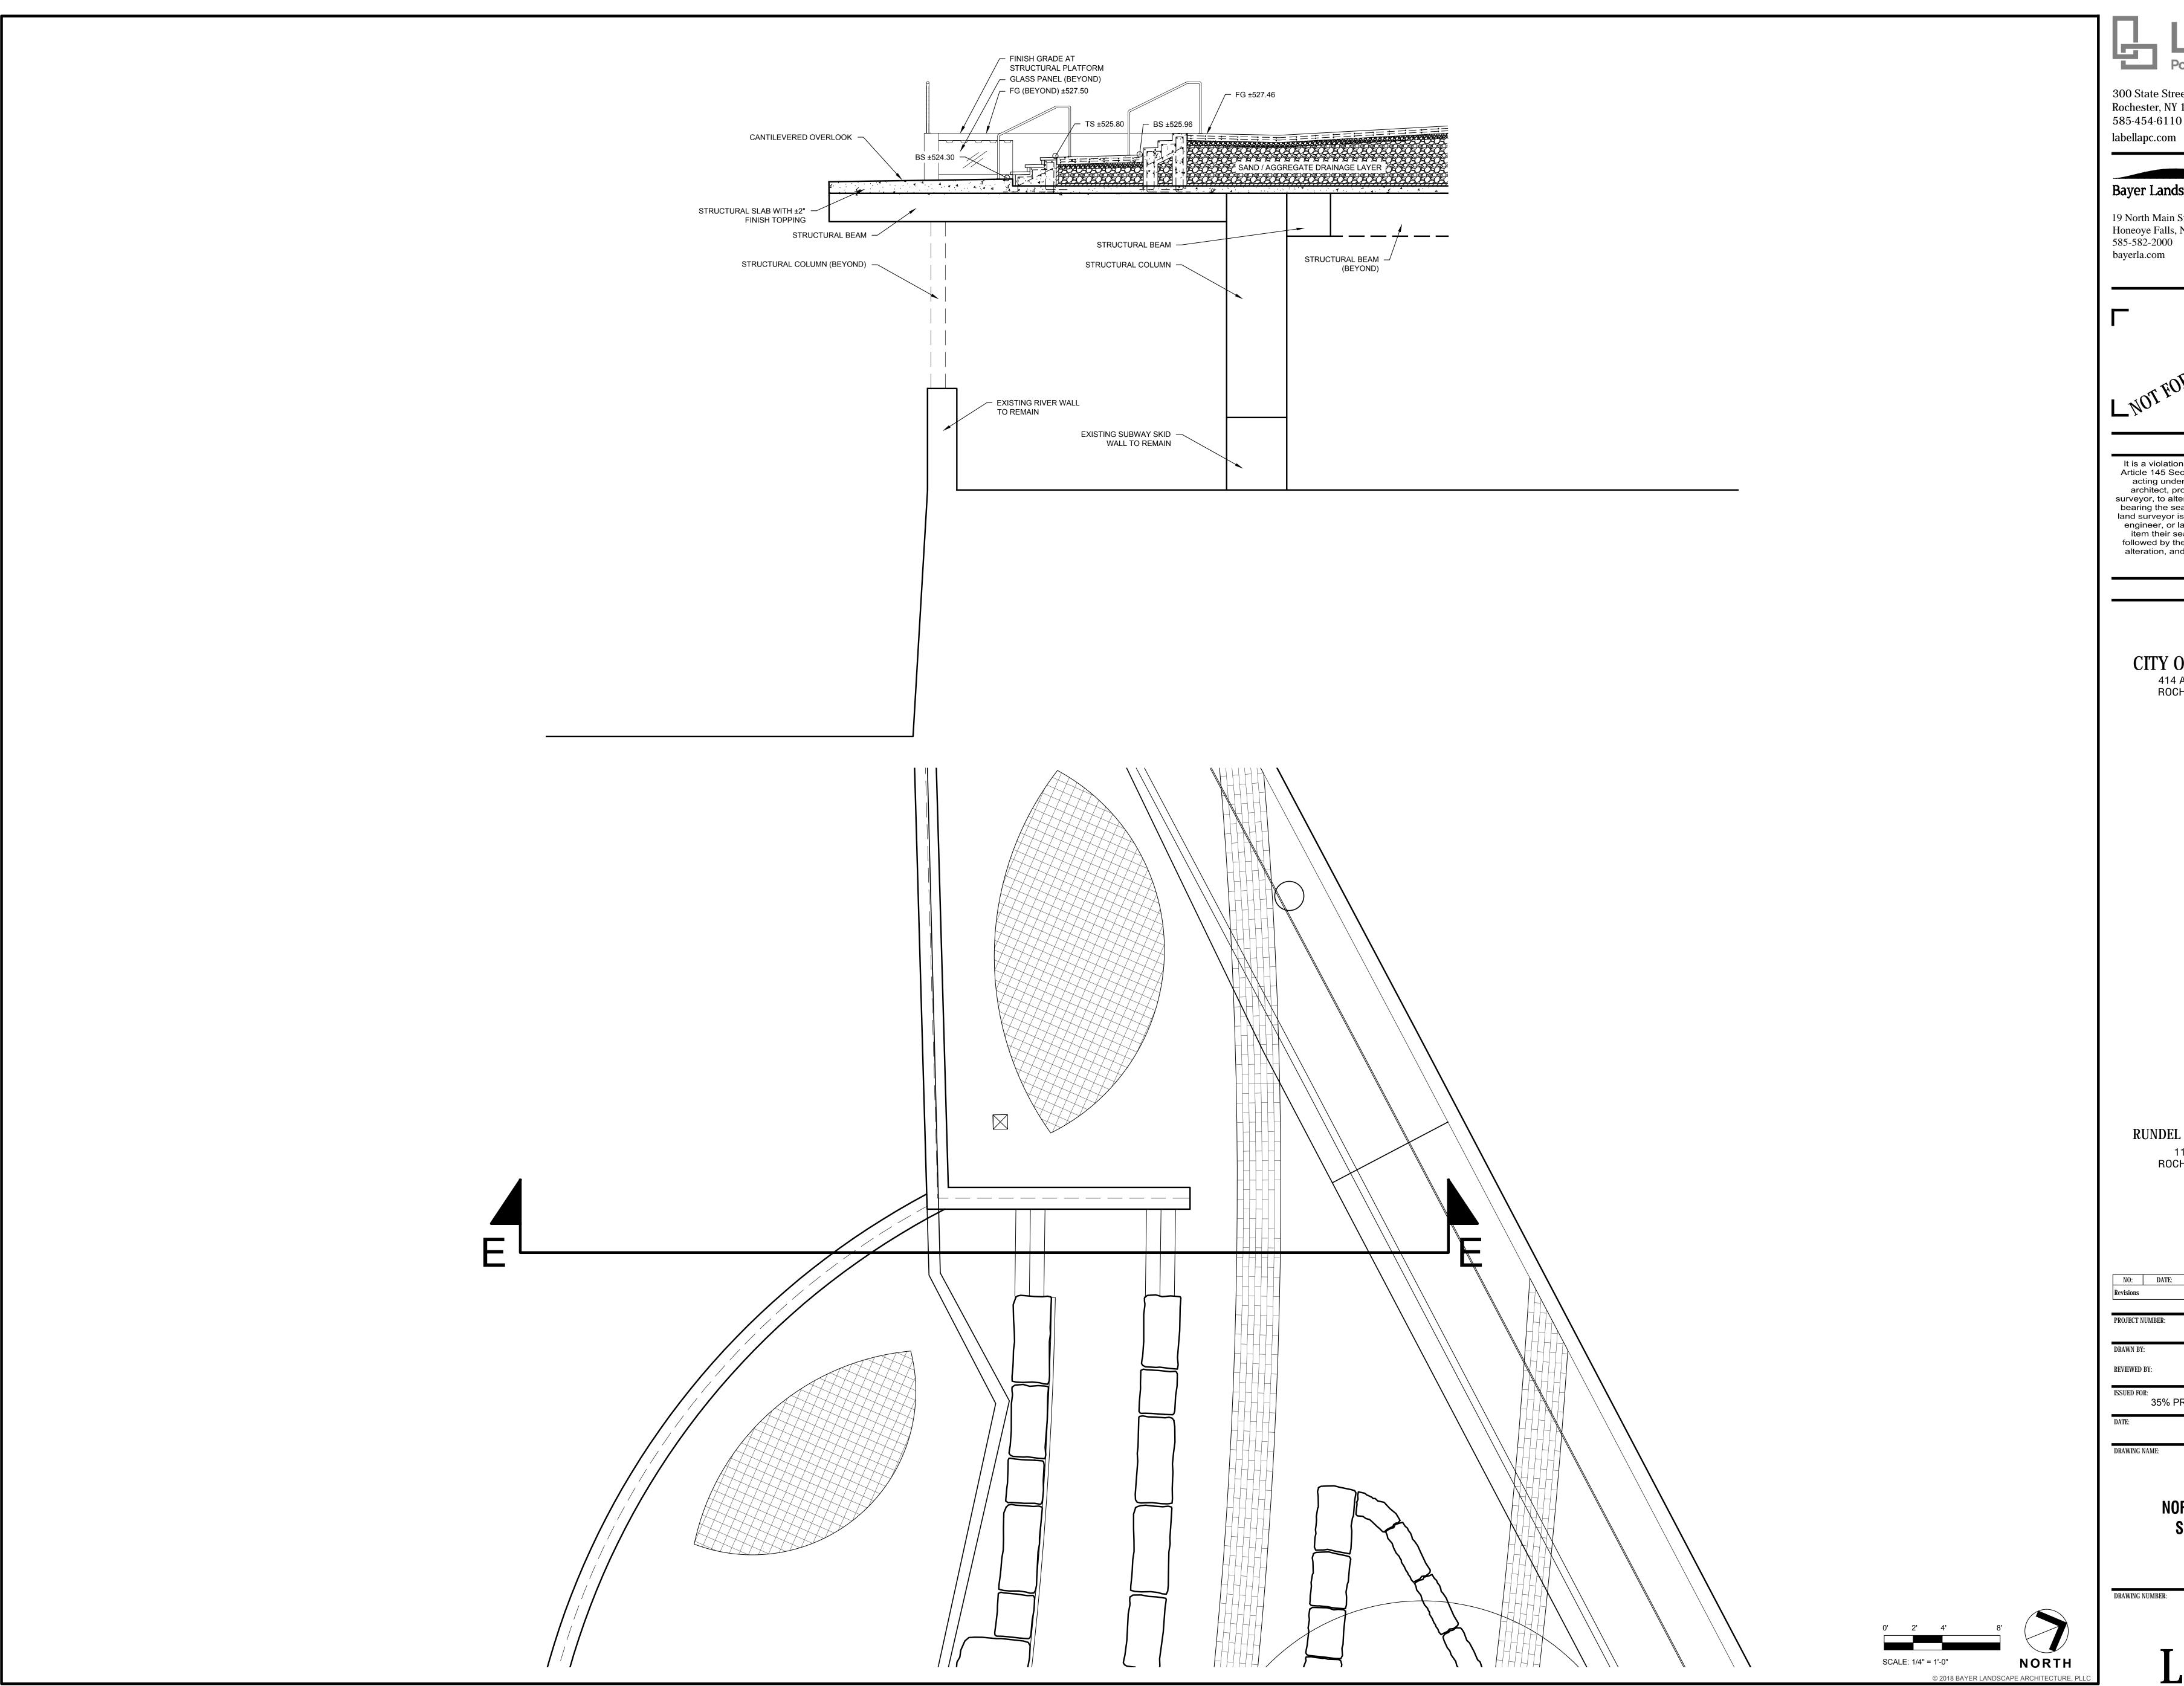
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DATE:		JULY 2018	

NORTH TERRACE SECTION D.D

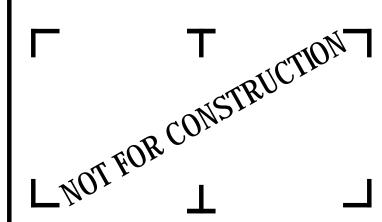




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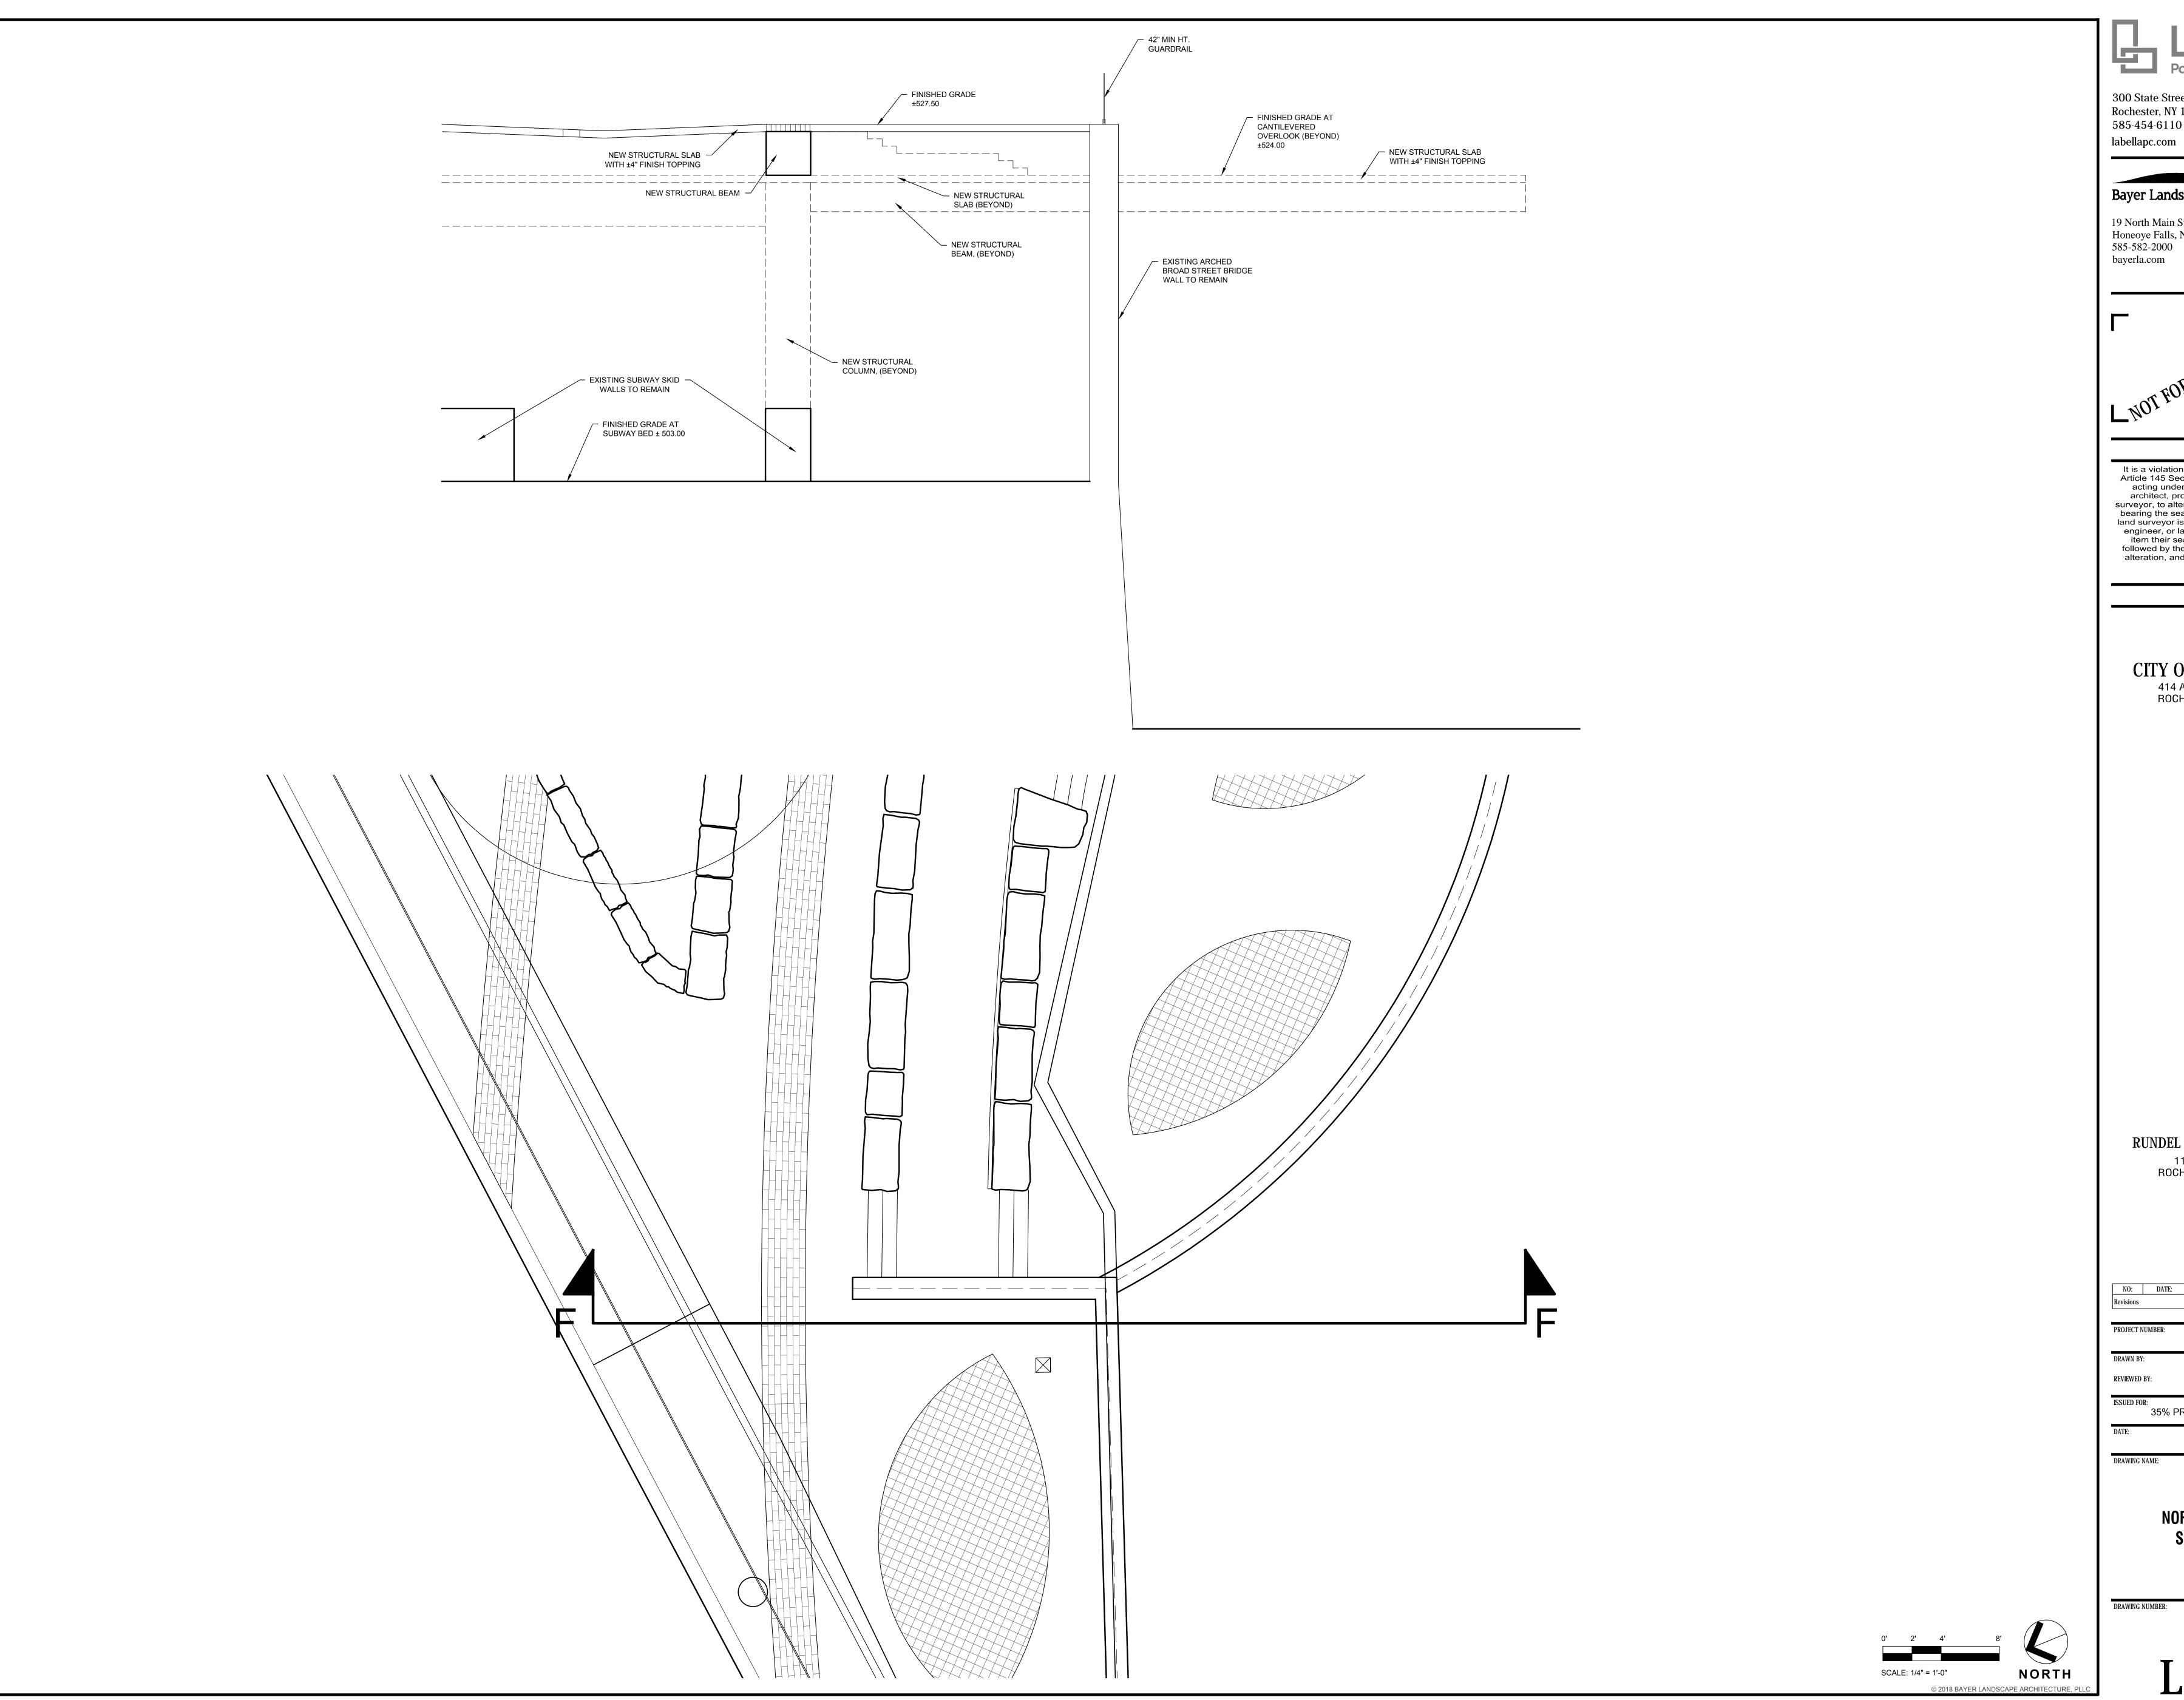
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NO: DATE: PROJECT NUMBER: 2170391 35% PRELIMINARY DESIGN JULY 2018 DRAWING NAME:

NORTH TERRACE SECTION E.E

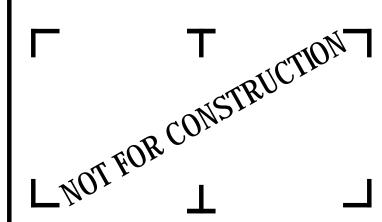




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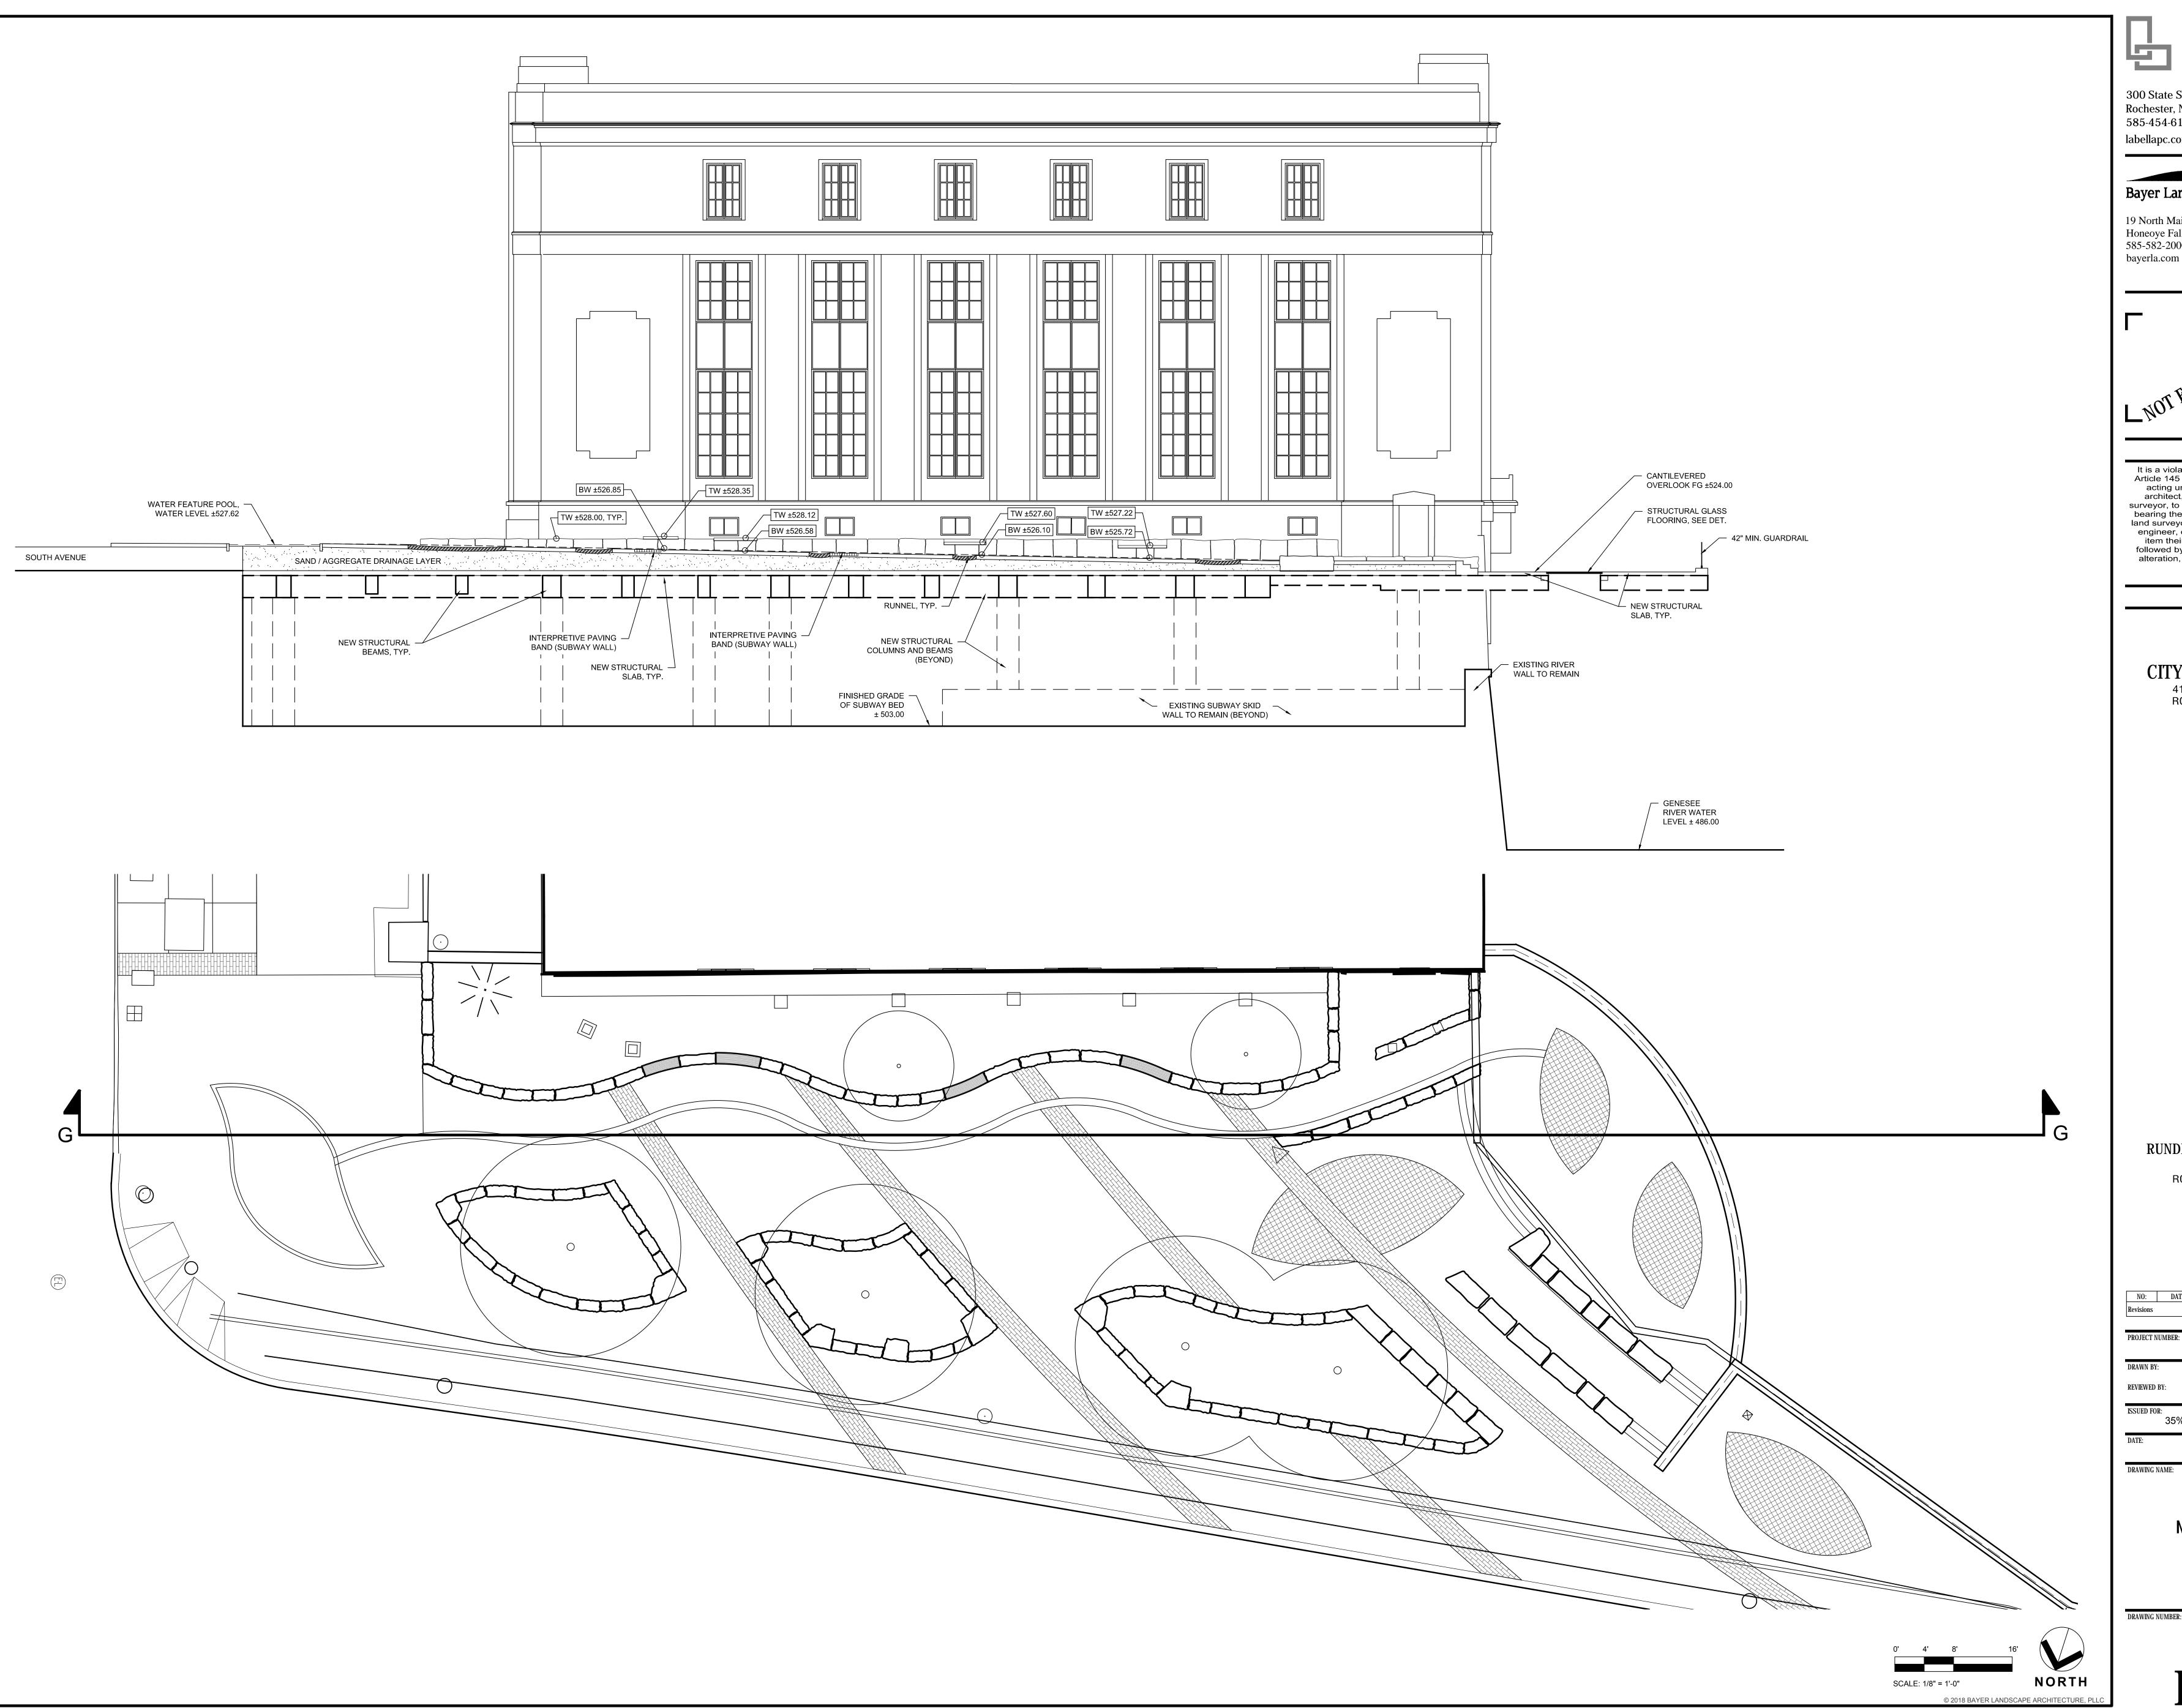
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RUNDEL LIBRARY PHASE IV 115 SOUTH AVE. ROCHESTER, NY 14604

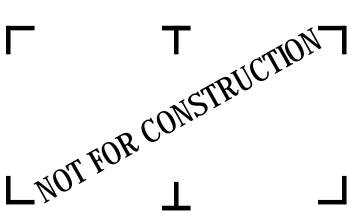
NO: DATE: PROJECT NUMBER: 2170391 35% PRELIMINARY DESIGN JULY 2018 DRAWING NAME:

> **NORTH TERRACE SECTION F.F**



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2170391 35% PRELIMINARY DESIGN

> **NORTH TERRACE SECTION G.G**

DRAWING NUMBER:

- 2. CONSTRUCTION LOADING: DURING CONSTRUCTION, THE GENERAL CONTRACTOR SHALL LIMIT AND CONTROL CONSTRUCTION LOADING, INCLUDING BUT NOT LIMITED TO: a. MATERIAL STOCKPILING AND EQUIPMENT TO PRECLUDE OVERSTRESSING, CONSTRUCTION LIVE LOAD IN EXCESS OF 20 PSF, OR DAMAGE TO ANY STRUCTURAL ELEMENT.
- 3. COORDINATION WITH OTHER DISCIPLINES: THE CONTRACTOR SHALL COORDINATE ALL STRUCTURAL WORK WITH THE ARCHITECTURAL, ELECTRICAL, MECHANICAL, PLUMBING AND FIRE PROTECTION DRAWINGS AND SPECIFICATIONS.
- 4. EXISTING CONDITIONS: THE INFORMATION SHOWN ON THESE DOCUMENTS IS THE BEST REPRESENTATION OF EXISTING CONDITIONS AVAILABLE TO THE ENGINEER. IT IS THE CONTRACTOR'S RESPONSIBILITY TO FIELD VERIFY AND BRING TO THE ENGINEER'S AND CONSTRUCTION MANAGER'S ATTENTION ANY DISCREPANCIES PRIOR TO COMMENCING WORK.
- 5. EXISTING STRUCTURES: ALL EXISTING STRUCTURES ADJACENT TO NEW WORK ARE TO BE ADEQUATELY PROTECTED AND/OR SUPPORTED DURING CONSTRUCTION. THE CONTRACTOR SHALL BE RESPONSIBLE FOR REPAIRING ANY NEW OR EXISTING CONSTRUCTION DAMAGED WHILE WORK IS IN PROGRESS. 6. OPENINGS: THE CONTRACTOR SHALL BE RESPONSIBLE FOR COORDINATING SIZE AND LOCATION OF ALL OPENINGS IN NEW AND EXISTING CONSTRUCTION WITH THE DISCIPLINE REQUIRING

1. NO GEOTECHNICAL INFORMATION WAS AVAILABLE AT THE TIME OF DESIGN. ASSUMED ALLOWABLE BEARING PRESSURE = 10 TSF. 2. TAKE ALL NECESSARY PRECAUTIONS WHEN EXCAVATING OR DRILLING ADJACENT TO EXISTING STRUCTURES TO AVOID DISTURBING EXISTING FOUNDATIONS. DO NOT EXCAVATE BELOW

EXISTING FOUNDATIONS. CONTACT THE ENGINEER IF EXISTING CONDITIONS DIFFER FROM THOSE SHOWN ON THE DRAWING. ALL EXCAVATIONS SHALL FULLY CONFORM TO LOCAL, STATE AND FEDERAL SAFETY REGULATIONS.

4. DO NOT BACKFILL AGAINST CONCRETE ELEMENTS UNTIL PLACED CONCRETE HAS REACHED 75% OF ITS SPECIFIED 28-DAY COMPRESSIVE STRENGTH.

- 5. BACKFILL BOTH SIDES OF FOUNDATION WALLS IN EQUAL, ALTERNATE LIFTS IN ORDER TO AVOID IMPOSING UNBALANCED LATERAL PRESSURE ON THE WALLS. 6. ALLOW TESTING AGENCY TO INSPECT AND APPROVE ALL COMPACTED SUBGRADE AND FILL LAYERS PRIOR TO FURTHER BACKFILL AND/OR PLACEMENT OF CONCRETE. TESTING AND INSPECTION RESULTS SHALL BE APPROVED BY THE GEOTECHNICAL ENGINEER.
- GRADES SHALL BE DETERMINED BY THE PROJECT GEOTECHNICAL ENGINEER. 8. BACKFILL AND FILL MATERIALS SHALL BE COMPACTED TO 95% OF MAXIMUM DRY DENSITY ACCORDING TO THE MODIFIED PROCTOR TEST (ASTM D-1557). ALL EXISTING BACKFILL SHALL
- 9. EXCAVATION AND BACKFILL OPERATIONS SHALL BE MAINTAINED IN A DRY CONDITION. SURFACE AND INFILTRATING WATER SHALL BE REMOVED BY SITE GRADING AND/OR BY PUMPING
- 1. PROVIDE THE FOLLOWING MINIMUM CONCRETE CLEAR COVER FOR REINFORCING STEEL, UNLESS OTHERWISE NOTED.:
- b. FORMED SURFACES IN CONTACT WITH EARTH OR EXPOSED TO WEATHER
- 2.0 IN. 1.5 IN.
- c. FORMED SURFACES NOT IN CONTACT WITH EARTH OR EXPOSED TO WEATHER 1.5 IN.
- 2. ALL CONCRETE WORK, CONSTRUCTION, AND REINFORCING DETAILS SHALL CONFORM TO THE "BUILDING CODE OF NEW YORK STATE, LATEST EDITION".
- 3. ALL REINFORCING STEEL SHALL BE DETAILED, FABRICATED AND PLACED IN ACCORDANCE WITH ACI 318.
- 4. ALL REINFORCING BARS SHALL CONFORM TO ASTM A615 GRADE 60.
- 5. ALL REINFORCING SHALL BE LAPPED OR EMBEDDED IN ACCORDANCE WITH ACI 318, UNLESS OTHERWISE NOTED.
- 6. PROVIDE CORNER BARS TO MATCH ALL HORIZONTAL REINFORCING AT CORNERS OR INTERSECTIONS.
- 7. CHAMFER EXTERIOR CORNERS AND EDGES OF PERMANENTLY EXPOSED CONCRETE.
- 8. PRIOR TO PLACEMENT OF CONCRETE, A FIELD REPRESENTATIVE SHALL BE INFORMED A MINIMUM OF 24 HOURS IN ADVANCE OF PLACEMENT, TO ALLOW INSPECTION OF REINFORCING STEEL, AND PREPARATION FOR TAKING CONCRETE SAMPLES. INDEPENDENT TESTS ARE REQUIRED FOR ALL CONCRETE PLACEMENTS.
- 9. INSTALLATION OF REINFORCEMENT SHALL BE COMPLETED AT LEAST 24 HOURS PRIOR TO THE SCHEDULED CONCRETE PLACEMENT. 10. FURNISH AND INSTALL WATERSTOPS AT ALL HORIZONTAL AND VERTICAL JOINTS IN FOOTINGS AND FOUNDATION WALLS ADJACENT TO EXISTING FOUNDATION WALLS AND FOOTINGS
- 11. W.W.R. SHALL CONFORM TO ASTM A1064 AND SHALL BE FABRICATED INTO FLAT SHEETS.
- 12. VAPOR BARRIER: POLYETHYLENE SHEET, ASTM D 4397, NOT LESS THAN 15-MIL. LOCATED BELOW SLABS-ON-GRADE.
- 14. GROUT: NON-METALLIC/NON-SHRINK STRUCTURAL GROUT. FIVE STAR GROUT OR APPROVED EQUAL.
- 15. PROTECT CONCRETE FROM PREMATURE DRYING IMMEDIATELY AFTER PLACEMENT. CURING OF CONCRETE SLABS MUST START WITHIN 2 HOURS AFTER FINISHING OPERATIONS ARE
- 16. SLABS-ON-GRADE SHALL HAVE CONTROL JOINTS AS SHOWN ON PLANS. SAW CUT JOINTS SHALL BE MADE WITHIN 12 HOURS OF PLACING SLAB. AFTER CONCRETE IS CURED AND READY FOR PLACEMENT OF FLOOR FINISH, ALL SLABS INSIDE THE BUILDING SHALL HAVE CONTROL JOINTS FILLED WITH APPROVED JOINT FILLER.
- 17. CONCRETE SHALL BE CONTROLLED, PROPORTIONED, MIXED AND PLACED IN THE PRESENCE OF A REPRESENTATIVE OF AN APPROVED TESTING AGENCY.
- 18. CONDUIT OR PIPES SHALL BE PLACED UNDER SLABS-ON-GRADE.
- 20. ALL CONCRETE SHALL HAVE 4 GALLONS PER CUBIC YARD OF CORROSION INHIBITOR. 21. THE CLEAR DISTANCE BETWEEN PARALLEL REINFORCING BARS SHALL NOT BE LESS THAN THE NOMINAL DIAMETER OF THE BARS NOR LESS THAN 1 1/3 TIMES THE MAXIMUM SIZE OF THE COARSE AGGREGATE. WHERE REINFORCING STEEL BECOMES CONGESTED, THE CONTRACTOR MAY OMIT THE LARGE COARSE AGGREGATE FROM THE CONCRETE TO FACILITATE PROPER
- ...ASTM A992
- c. Hollow Structural Sections (HSS) square or rectangular:......ASTM A500, grade c, Fy = 50 KSI d. HOLLOW STRUCTURAL SECTIONS (HSS) - ROUND: .. ...ASTM A500, GRADE B, Fy = 42 KSI
- 2. BOLTED CONNECTIONS SHALL CONFORM TO THE FOLLOWING: ...ASTM A325, ASTM A490
- 3. ANCHOR RODS SHALL CONFORM TO THE FOLLOWING: ...ASTM F1554, GRADE 36, WELDABLE (S1)
- 5. THREADED RODS SHALL CONFORM TO THE FOLLOWING:
- ...ASTM F1554, GRADE 55, WELDABLE (S1) 6. WELDING ELECTRODES SHALL CONFORM TO THE FOLLOWING:
- AWS SPECIFICATIONS FOR ELECTRODES BASED ON WELDING PROCESS AND THE TYPE AND GRADE OF STEEL. E70XX ELECTRODES (MIN.) FOR FILLET WELDS.
- 7. ALL STRUCTURAL STEEL SHALL BE DETAILED, FABRICATED AND ERECTED IN STRICT ACCORDANCE WITH THE LATEST AISC SPECIFICATIONS. 8. SHOP FABRICATE TO THE GREATEST EXTENT POSSIBLE BY WELDING INCLUDING BEAM STIFFENERS, COLUMN CAPS AND BASES, HOLES AND CONNECTIONS.
- 9. FRAMING SHALL BE EQUALLY SPACED BETWEEN COLUMN LINES UNLESS OTHERWISE NOTED.
- 10. ERECT ALL STEEL IN ACCORDANCE WITH THE LATEST AISC SPECIFICATIONS.
- PLANS AND SHALL MEET THE CRITERIA SHOWN IN THE TYPICAL DETAILS. 12. PROVIDE TEMPORARY BRACING FOR ALL ERECTED STEEL FRAMING UNTIL ALL CONNECTIONS HAVE BEEN FULLY TIGHTENED OR WELDED.
- 13. CUTS, HOLES, COPES, ETC., REQUIRED FOR WORK OF THE OTHER TRADES SHALL BE SHOWN ON SHOP DRAWINGS AND MADE IN THE SHOP. FIELD CUTTING OR BURNING WILL NOT BE
- 14. ALL WELDING BOTH SHOP AND FIELD SHALL BE PERFORMED BY CERTIFIED WELDERS IN ACCORDANCE WITH AWS SPECIFICATIONS. WELDING ELECTRODES SHALL CONFORM TO ASTM A233, E70-XX. MINIMUM WELD SIZE SHALL BE 1/4 INCHES (FILLET) UNLESS OTHERWISE NOTED.
- 15. BITUMINOUS COAT ALL STRUCTURAL STEEL LOCATED BELOW GRADE. 16. ALL EXTERIOR MEMBERS, LINTELS, ASSEMBLIES OR COMPONENTS SHALL BE GALVANIZED AND PAINTED.
- PAINTED: MANUFACTURERS STANDARD PRIMER. SEE SPECIFICATION
- 18. AFTER ERECTION, ALL DAMAGED AREAS IN THE SHOP COAT AND AT ALL FIELD WELD LOCATIONS, SHALL BE TOUCHED UP WITH THE SAME PAINT USED FOR THE PRIMER AND SHOP COAT. PREPARE SURFACES IN ACCORDANCE WITH SSPC-SP3, FOR PAINTED FINISH, OR IN ACCORDANCE WITH ASTM A780 IF FINISH IS GALVANIZED.
- 1. ALL PREFABRICATED ITEMS SHALL BE MANUFACTURED BY APPROVED AND CERTIFIED SHOPS.
- 2. SPECIAL INSPECTIONS WILL BE REQUIRED FOR THIS PROJECT. THE CONTRACTOR SHALL COORDINATE ALL WORK WITH THE OWNER'S TESTING AND SPECIAL INSPECTION
- 3a. SEE SPECIFICATIONS FOR STRUCTURAL SPECIAL INSPECTIONS AND ADDITIONAL INFORMATION.
- 1. DEMOLISH AND REMOVE EXISTING CONSTRUCTION ONLY TO THE EXTENT REQUIRED BY NEW CONSTRUCTION AND AS INDICATED. USE METHODS REQUIRED TO COMPLETE THE WORK WITHIN LIMITATIONS OF GOVERNING REGULATIONS AND AS FOLLOWS: a. PROCEED WITH SELECTIVE DEMOLITION SYSTEMATICALLY, FROM HIGHER TO LOWER LEVEL. COMPLETE SELECTIVE DEMOLITION OPERATIONS ABOVE EACH FLOOR OR TIER BEFORE
- b. NEATLY CUT OPENINGS AND HOLES PLUMB, SQUARE, AND TRUE TO DIMENSIONS REQUIRED. USE CUTTING METHODS LEAST LIKELY TO DAMAGE CONSTRUCTION TO REMAIN OR ADJOINING CONSTRUCTION. USE HAND TOOLS OR SMALL POWER TOOLS DESIGNED FOR SAWING OR GRINDING, NOT HAMMERING AND CHOPPING, TO MINIMIZE DISTURBANCE OF
- ADJACENT SURFACES. TEMPORARILY COVER OPENINGS TO MAINTAIN A WATERTIGHT CONDITION UNTIL PERMANENT CONSTRUCTION IS COMPLETE. c. CUT OR DRILL FROM THE EXPOSED OR FINISHED SIDE INTO CONCEALED SURFACES. AVOID MARRING EXISTING FINISHED SURFACES.
- e. REMOVE DECAYED, VERMIN-INFESTED, OR OTHERWISE DANGEROUS OR UNSUITABLE NON-HAZARDOUS MATERIALS. PROMPTLY DISPOSE OF OFF-SITE. f. ASBESTOS CONTAMINATED MATERICAL (ACM) / HAZARDOUS MATERIALS:
- ... i. NO ACM SURVEY HAS BEEN PERFORMED FOR THIS PROJECT g. REMOVE STRUCTURAL FRAMING MEMBERS AND LOWER TO GROUND BY METHOD SUITABLE TO AVOID FREE FALL AND TO PREVENT GROUND IMPACT OR DUST GENERATION.
- h. LOCATE SELECTIVE DEMOLITION EQUIPMENT AND REMOVE DEBRIS AND MATERIALS SO AS NOT TO IMPOSE EXCESSIVE LOADS ON SUPPORTING WALLS, FLOORS, OR FRAMING. i. DISPOSE OF DEBRIS OFF-SITE PROMPTLY AT CONTRACTOR'S EXPENSE AND IN ACCORDANCE WITH ALL APPLICABLE REGULATIONS AND CODES. 2. BUILDING ELEMENTS TO REMAIN: DO NOT DEMOLISH BUILDING ELEMENTS BEYOND LIMITS INDICATED. 3. EXISTING ITEMS TO REMAIN: PROTECT CONSTRUCTION INDICATED TO REMAIN AGAINST DAMAGE AND SOILING DURING SELECTIVE DEMOLITION. WHEN PERMITTED BY ARCHITECT, ITEMS
- MAY BE REMOVED TO A SUITABLE, PROTECTED STORAGE LOCATION DURING SELECTIVE DEMOLITION AND CLEANED AND REINSTALLED IN THEIR ORIGINAL LOCATIONS AFTER SELECTIVE
- DEMOLITION OPERATIONS ARE COMPLETE. COMPLY WITH INSTALLATION REQUIREMENTS FOR NEW MATERIALS AND EQUIPMENT. PROVIDE CONNECTIONS, SUPPORTS, AND MISCELLANEOUS MATERIALS NECESSARY TO MAKE ITEM FUNCTIONAL FOR USE INDICATED. 4. SELECTIVE DEMOLITION PROCEDURES FOR SPECIFIC MATERIALS:
- a. REINFORCED CONCRETE: DEMOLISH IN SMALL SECTIONS. SAW CUT CONCRETE TO A DEPTH OF AT LEAST 3/4 INCH AT JUNCTURES WITH CONSTRUCTION TO REMAIN. DISLODGE CONCRETE FROM REINFORCEMENT AT PERIMETER OF AREAS BEING DEMOLISHED, CUT REINFORCEMENT, AND THEN REMOVE REMAINDER OF CONCRETE INDICATED FOR SELECTIVE
- DEMOLITION USING MAXIMUM 15-LB CHIPPING HAMMER. NEATLY TRIM OPENINGS TO DIMENSIONS INDICATED. b. CONCRETE SLABS-ON-GRADE: SAW-CUT PERIMETER OF AREA TO BE DEMOLISHED, THEN BREAK UP AND REMOVE.
- c. WOOD: SAWCUT CLEANLY, LEVEL, PLUMB, AND SQUARE TO DIMENSIONS REQUIRED FOR RECONSTRUCTION. DISPOSAL OF DEMOLISHED MATERIALS
- d. General: except for items or materials indicated to be recycled, reused, salvaged, reinstalled, or otherwise indicated to remain owner's property, remove DEMOLISHED MATERIALS FROM PROJECT SITE AND LEGALLY DISPOSE OF THEM IN AN EPA-APPROVED LANDFILL.
- 5. DO NOT ALLOW DEMOLISHED MATERIALS TO ACCUMULATE ON-SITE. 6. REMOVE AND TRANSPORT DEBRIS IN A MANNER THAT WILL PREVENT SPILLAGE ON ADJACENT SURFACES AND AREAS. 7. REMOVE DEBRIS FROM ELEVATED PORTIONS OF BUILDING BY CHUTE, HOIST, OR OTHER DEVICE THAT WILL CONVEY DEBRIS TO GRADE LEVEL IN A CONTROLLED DESCENT.
- 8. BURNING: DO NOT BURN DEMOLISHED MATERIALS.
- 8a. COMPLY WITH REQUIREMENTS SPECIFIED IN DIVISION 01 SECTION "CONSTRUCTION WASTE MANAGEMENT AND DISPOSAL."
- TRANSPORT DEMOLISHED MATERIALS OFF OWNER'S PROPERTY AND LEGALLY DISPOSE OF THEM.
- CLEAN ADJACENT STRUCTURES AND IMPROVEMENTS OF DUST, DIRT, AND DEBRIS CAUSED BY ALL DEMOLITION OPERATIONS, RETURN ADJACENT AREAS TO CONDITION EXISTING BEFORE

### SHORING NOTES

1. SUBMITTALS: a. CONTRACTOR SHALL SUBMIT A DETAILED SHORING PLAN INCLUDING PRODUCT DATA, DRAWING SPECIFIC TO THIS PROJECT, AND STRUCTURAL CALCULATIONS PREPARED BY A

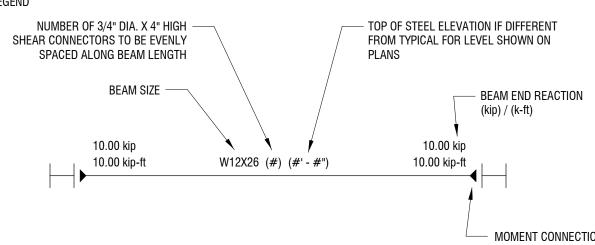
STRUCTURAL ENGINEER LICENSED IN THE STATE OF NEW YORK. 2. THE SHORING SHALL BE DESIGNED AND CONSTRUCTED BY THE CONTRACTOR SO THAT IT SUPPORTS THE DEAD WEIGHT OF EXISTING STRUCTURE, SUPERIMPOSED DEAD LOADS, AND THE CONSTRUCTION LOADS WITH A MINIMUM FACTOR OF SAFETY (ULTIMATE CAPACITY DIVIDED BY WORKING LOAD) OF 2.5 ON SHORING AND SO AS NOT TO OVERLOAD THE EXISTING

3. DESIGN LOADS SHALL BE AS SHOWN IN THESE DRAWINGS. 4. SHORING SHALL REMAIN IN PLACE FOR A MINIMUM OF SEVEN DAYS AFTER REPAIR MATERIAL PLACEMENT AND UNTIL SUCH TIME AS IT IS NO LONGER REQUIRED FOR CONSTRUCTION LOADING, IRRESPECTIVE OF CONCRETE STRENGTH. THEREAFTER, THE SHORING MAY BE REMOVED AFTER REPAIR MATERIAL ATTAINS 75% OF SPECIFIED TWENTY-EIGHT-DAY COMPRESSIVE STRENGTH. THE CONTRACTOR SHALL DETERMINE COMPRESSIVE STRENGTH OF CONCRETE PRIOR TO SHORE REMOVAL.

5. NO DEMOLITION SHALL PROCEED UNTIL THE SHORING PLAN SUBMITTAL IS REVIEWED BY THE ENGINEER OF RECORD. 6. THE ERECTION AND OPERATION OF SHORES SHALL CONFORM TO ALL SAFETY AND PRECAUTIONARY MEASURES AS RECOMMENDED BY THE SCAFFOLDING AND SHORING INSTITUTE AND IN ACCORDANCE WITH ALL STATE, LOCAL, AND FEDERAL CODES, ORDINANCES, AND REGULATIONS.

### MISCELLANEOUS NOTES

1. ALL ELEVATIONS ARE REFERENCED FROM FINISHED MAIN FLOOR ELEVATION [0' - 0"]



STRUCTURAL COMPONENTS OR SOIL ON WHICH IT BEARS. COMPATIBILITY OF DEFORMATIONS SHALL BE CONSIDERED IN THE SHORING DESIGN.

	STATEMENT OF SPECIAL I	NSPECTIONS	
LOCATION	115 SOUT	TH AVE. ROCHESTER, NY 14604	
OWNER		CITY OF ROCHESTER	
DESIGN PROFESSIONAL IN CHARGE		JESSE GOTHAM	
Special Inspections encompasses the foll shall furnish inspection reports to the Buil shall be brought to the immediate attentio the attention of the Building Official and the assurance.  Interim reports shall be submitted to the E A Final Report of Special Inspections doctors.	ntity of other approved agencies to be retained bying disciplines: STRUCTURAL. The Special ding Official and the Registered Design Professon of the contractor for correction. If such disciple RDP. The Special Inspection program does wilding Official and the RDP.  In the special Inspection of all required Special Inspecial In	Inspection Coordinator shall keep resional in Responsible Charge (RDP) repancies are not corrected, the discontractor of his or his or his contractor of his or his pections, testing, and correction of	ecords of all inspections and ). Discovered discrepancies crepancies shall be brought to iter responsibility for quality  f any discrepancies noted in
Job site safety and means and methods of Interim reports shall be submitted monthly	construction are solely the responsibility of $\dot{t}$ .	he contractor.	
Interim reports shall be submitted monthly In accordance with the applicable building		d in the Schedule of Special Inspect	ions are required.
Interim reports shall be submitted monthly In accordance with the applicable building	code, the Observations and Inspections liste	d in the Schedule of Special Inspect	ions are required.  TELEPHONE No.
Interim reports shall be submitted monthly In accordance with the applicable building	code, the Observations and Inspections liste	d in the Schedule of Special Inspect	·
Interim reports shall be submitted monthly In accordance with the applicable building SPECIAL INSPECTION AGENCIES	code, the Observations and Inspections liste	d in the Schedule of Special Inspect	· ·
Interim reports shall be submitted monthly In accordance with the applicable building  SPECIAL INSPECTION AGENCIES  Special Inspection Coordinator  Inspector  Note: The inspectors and testing agencies by the Contractor or Subcontractor whose contractor responsible for the work being	code, the Observations and Inspections liste  CHEDULE OF INSPECTION AND  FIRM  shall be engaged by the Owner or the Owner work is to be inspected or tested. An approvinspected. The agency shall also disclose to the terest so that objectivity can be confirmed.	d in the Schedule of Special Inspect  FESTING AGENCIES  ADDRESS  ADDRESS  AS Agent in accordance with the apped agency shall be objective, competed be building official and the registere	TELEPHONE No.  Iicable building code, and not etent and independent from the
Interim reports shall be submitted monthly In accordance with the applicable building  SPECIAL INSPECTION AGENCIES  Special Inspection Coordinator  Inspector  Note: The inspectors and testing agencies by the Contractor or Subcontractor whose contractor responsible for the work being responsible charge possible conflicts of in	code, the Observations and Inspections liste  CHEDULE OF INSPECTION AND  FIRM  shall be engaged by the Owner or the Owner work is to be inspected or tested. An approving a spected. The agency shall also disclose to the terest so that objectivity can be confirmed.  STATEMENT OF CONTRACTORS	d in the Schedule of Special Inspect  FESTING AGENCIES  ADDRESS  S Agent in accordance with the apped agency shall be objective, compete building official and the registere  RESPONSIBILITY	Iicable building code, and not etent and independent from the d design professional in
Interim reports shall be submitted monthly In accordance with the applicable building  SPECIAL INSPECTION AGENCIES  Special Inspection Coordinator  Inspector  Note: The inspectors and testing agencies by the Contractor or Subcontractor whose contractor responsible for the work being responsible charge possible conflicts of ir  In accordance with the applicable building designated seismic system or a wind or s statement of responsibility to the building	code, the Observations and Inspections liste  CHEDULE OF INSPECTION AND  FIRM  shall be engaged by the Owner or the Owner work is to be inspected or tested. An approvinspected. The agency shall also disclose to the terest so that objectivity can be confirmed.	d in the Schedule of Special Inspect  FESTING AGENCIES  ADDRESS  S Agent in accordance with the apped agency shall be objective, compete building official and the registere  FESPONSIBILITY  Instruction of a main wind or seismice statement of special inspections at a ged agent prior to the commencement	Iicable building code, and not etent and independent from the d design professional in

When the Registered Design Professional in Responsible Charge deems it appropriate that the individual performing a stipulated test of inspection have a

Engineer - In - Training - a graduate engineer who as passed the Fundamentals of Engineering examination

AMERICAN CONCRETE INSTITUTE (ACI) CERTIFICATION

AMERICAN WELDING SOCIETY (AWS) CERTIFICATION

INTERNATIONAL CODE COUNCIL (ICC) CERTIFICATION

NATIONAL INSTITUTE FOR CERTIFICATION IN ENGINEERING TECHNOLOGIES (NICET)

Structural Engineer - a licensed PE specializing in the design of building structures

Geotechnical Engineer - a licensed PE specializing in soil mechanics and foundations

specific certification or license as indicated below, such designation shall appear below the Agency Number on the Schedule.

Concrete Field Testing Technician - Grade 1

Concrete Construction Special Inspector

Strength Testing Technician

Certified Welding Inspector

AWS/AISC-SSI

ICC-RCSI

Certified Structural Steel Inspector

Structural Masonry Special Inspector

Structural Steel and Welding Special Inspector

Spray-Applied Fireproofing Special Inspector

Prestressed Concrete Special Inspector

Reinforced Concrete Special Inspector

Concrete Technician - Levels I, II, III, & IV

Geotechnical Engineering Technician - Levels I, II, III & IV

Soil Technicians - Levels I, II, III & IV

Laboratory Testing Technician - Grade 1&2

		ESIGN TABLE - IBC 2015 VERSION EE WITH APPLICABLE BUILDING CODE)	
BUILDING DATA:			
LOCATION BUILDING OCCUPANCY RISK CATEGORY APPLICABLE BUILDING CODE		115 SOUTH AVENUE, ROCHESTER, NY 14604 III NEW YORK STATE	IBC 2015 TABLE 1604.5
GEOTECHNICAL INFORMATION:		40 TOE (ACCUMED)	
ALLOWABLE BEARING PRESSURE DEAD LOAD:		10 TSF (ASSUMED)	
TERRACE / SIDEWALK	DL1	PER MATERIAL	
FLOOR LIVE LOAD:	DL2	10 PSF	
TERRACE: SIDEWALKS, VEHICULAR DRIVEWAYS AND YARDS, SUBJECT TO TRUCKING	LL1	250 PSF / 8,000 LBS	IBC 2015 TABLE 1607.1
TERRACE: AREAS ACCESSIBLE TO FIRETRUCKS BALCONY: YARDS AND TERRACES, PEDESTRIAN	LL2 LL3	75 PSI @ OUTRIGGER (18"x18" PAD) 100 PSF	NFPA 1901 IBC 2015 TABLE 1607.1
SNOW LOAD:	lo.	1.1	ASCE 7 10 TABLE 1 F 0
SNOW LOAD IMPORTANCE FACTOR GROUND SNOW LOAD	ls Pg	1.1 40 PSF	ASCE 7-10 TABLE 1.5-2 IBC 2015 FIGURE 1608.2
SNOW EXPOSURE FACTOR	Ce	1.0	ASCE 7-10 TABLE 7-2
THERMAL FACTOR	Ct	1.2	ASCE 7-10 TABLE 7-3
FLAT ROOF SNOW DRIFTING SNOW WIDTH	Pf W	37 PSF 21'-6"	ASCE 7-10 SECTION 7.3 ASCE 7-10 SECTION 7.7
DRIFT SURCHARGE LOAD	Pd	103 PSF	ASCE 7-10 SECTION 7.7
WIND LOAD (MAIN WIND-FORCE RESISTING SYSTEM):		DIDECTIONAL DROOFFILE	1005 7 10 0110 0750 07
ANALYSIS PROCEDURE ULTIMATE DESIGN WIND SPEED (3-SECOND GUST)	Vult	DIRECTIONAL PROCEDURE 120 mph	ASCE 7-10 CHAPTER 27 ASCE 7-10 SECTION 26.5
NOMINAL DESIGN WIND SPEED (3-SECOND GUST)	Vasd	93 mph	IBC 2015 SECTION 1609.3.
WIND DIRECTIONALITY FACTOR	Kd	0.85	ASCE 7-10 SECTION 26.6
EXPOSURE CATEGORY TOPOGRAPHIC FACTOR	V-+	C 1.00	ASCE 7-10 SECTION 26.7 ASCE 7-10 SECTION 26.8
GUST-EFFECT FACTOR	Kzt G	0.85	ASCE 7-10 SECTION 26.9
ENCLOSURE CLASSIFICATION		PARTIALLY ENCLOSED	ASCE 7-10 SECTION 26.10
INTERNAL PRESSURE COEFFICIENT	GCpi	+0.55/-0.55	ASCE 7-10 SECTION 26.11
VELOCITY PRESSURE EXPOSURE COEFFICIENT VELOCITY PRESSURE	Kz q	0.94 30 PSF	ASCE 7-10 TABLE 27.3-1 ASCE 7-10 SECTION 27.3.2
MINIMUM WALL WIND PRESSURE		16 PSF	ASCE 7-10 SECTION 27.4.7
MINIMUM ROOF WIND PRESSURE	Pmin	8 PSF	ASCE 7-10 SECTION 27.4.7
NOTES		WIND LOADS ARE CALCULATED FROM THESE PARAMETERS FOR EACH SURFACE OF THE MAIN WIND-FORCE RESISTING SYSTEM.	
WIND LOAD (COMPONENTS & CLADDING):			1005 7 10 2005
ANALYSIS PROCEDURE BASIC WIND SPEED (3-SECOND GUST)	V	METHOD 1 120 mph	ASCE 7-10 CHAPTER 30 ASCE 7-10 SECTION 26.5
WIND DIRECTIONALITY FACTOR	Kd	0.85	ASCE 7-10 SECTION 26.6
EXPOSURE CATEGORY		C	ASCE 7-10 SECTION 26.7
TOPOGRAPHIC FACTOR ENCLOSURE CLASSIFICATION	Kzt	1.00 PARTIALLY ENCLOSED	ASCE 7-10 SECTION 26.8 ASCE 7-10 SECTION 26.10
ENCLUSURE CLASSIFICATION EFFECTIVE WIND AREA	Aeff	10 SQFT	ASCE 7-10 SECTION 26.10 ASCE 7-10 FIGURE 30.5-1
INTERNAL PRESSURE COEFFICIENT	GCpi	+0.55/-0.55	ASCE 7-10 SECTION 26.11
VELOCITY PRESSURE EXPOSURE COEFFICIENT	Kh	0.94	ASCE 7-10 TABLE 30.3-1
VELOCITY PRESSURE MINIMUM DESIGN WIND PRESSURE	q Pmin	30 PSF +/- 16 PSF	ASCE 7-10 SECTION 30.3.2 ASCE 7-10 SECTION 30.2.2
NOTES	1.	EFFECTIVE AREA ABOVE USED AS BASIS FOR "WORST	
		CASE" PRESSURE CALCULATIONS. THE EFFECTIVE AREA FOR EACH INDIVIDUAL COMPONENT SHALL BE CALCULATED AND PRESSURE VALUES ADJUSTED	
		ACCORDINGLY.	
	2.	INCREASED WIND PRESSURES AT EDGES, OVERHANGS, AND OTHER SURFACES ARE AS DEFINED IN ASCE 7-10 "MINIMUM DESIGN LOADS FOR	
EARTHQUAKE LOAD:		BUILDINGS AND OTHER STRUCTURES".	
SEISMIC - FORCE RESISTING SYSTEM		ORDINARY REINFORCED CONCRETE MOMENT	ASCE 7-10 TABLE 12.2-1
CON DITE OF ACCIEDATION		FRAMES	ACCE 7 10 CECTION 00 0
SOIL SITE CLASSIFICATION SPECTRAL RESPONSE ACCELERATION AT 0.2 SEC	Ss	B (ASSUMED) 0.163g	ASCE 7-10 SECTION 20.3 ASCE 7-10 FIGURE 22-1
SPECTRAL RESPONSE ACCELERATION AT 1.0 SEC	S1	0.060g	ASCE 7-10 SECTION 11.4.1
SEISMIC IMPORTANCE FACTOR		1.25	ASCE 7-10 TABLE 1.5-2
DESIGN SPECTRAL RESPONSE COEFFICIENT DESIGN SPECTRAL RESPONSE COEFFICIENT		0.109g 0.040g	ASCE 7-10 SECTION 11.4.4
		0.040a	- ACCOL / 10 CEPTION 11 / /

DESIGN SPECTRAL RESPONSE COEFFICIENT | SD1

SEISMIC DESIGN CATEGORY

SEISMIC RESPONSE COEFFICIENT | Cs

RESPONSE MODIFICATION FACTOR | R

ANALYSIS PROCEDURE

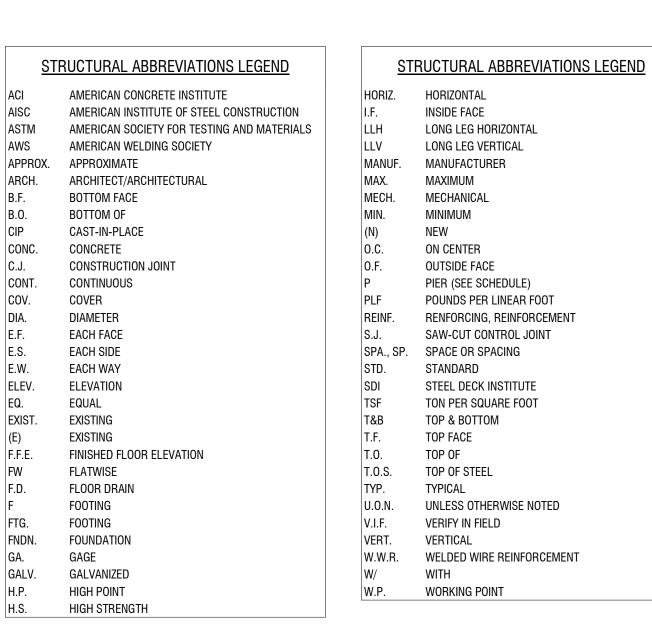
SEISMIC BASE SHEAR

ALL PERSONNEL PERFORMING SPECIAL INSPECTION ACTIVITIES AND ADDITIONAL TESTING INFORMATION.

			RTHWORK - REQUIREMENTS FOR	FREQUENCY OF	REFERENCE			STEEL CONSTRUCTION - REQUIREME	FREQUENCY OF	REFERENCE	
	AREAS OF IN			INSPECTION OR TESTING	STANDARD	IBC REFERENCE		AREAS OF INSPECTION & TESTING	INSPECTION OR TESTING	STANDARD	IBC REFEREN
	ADEQUATE TO ACHIEVE	THE DE	LLOW FOUNDATIONS ARE SIGN BEARING CAPACITY.	PERIODIC	-	1705.6	1.	I. FABRICATOR'S SHOP TESTING AND QUALITY CONTROL PROGRAM: A. VERIFY FABRICATOR'S CERTIFICATION AND QUALITY	PERIODIC  NOT REQUIRED. IF	AISC PLANT CERTIFICATION PROGRAM	1705.2
	VERIFY EXCAVATIONS AI AND HAVE REACHED PR		NDED TO PROPER DEPTH ATERIAL.	PERIODIC				CONTROL PROGRAM.  B. SPECIAL INSPECTIONS REQUIRED IN FABRICATOR'S	FABRICATOR IS AISC CERTIFIED	PROGRAM	
	PERFORM CLASSIFICATI MATERIALS	ION AND	TESTING OF COMPACTED FILL	PERIODIC				SHOP FOR ELEMENTS IDENTIFIED BELOW.	SEITH IES	NO. 000	
	THICKNESS DURING PLA		IALS, DENSITIES, AND LIFT T AND COMPACTION OF	CONTINUOUS			2.	<ol> <li>INSPECTION TASKS FOR HIGH-STRENGTH BOLTS, NUTS AND WASHERS PRIOR TO BOLTING:</li> <li>A. VERIFY MANUFACTURER'S CERTIFICATIONS AVAILABLE</li> </ol>	CONTINUOUS	AISC 360, TABLE N5.6-1	
5.	COMPACTED FILL. PRIOR TO PLACEMENT O			PERIODIC				FOR FASTENER MATERIALS. B. FASTENERS MARKED IN ACCORDANCE WITH ASTM	PERIODIC		
	PROPERLY.		ITE HAS BEEN PREPARED					REQUIREMENTS. C. PROPER FASTENERS SELECTED FOR JOINT DETAIL (GRADE, TYPE, BOLT LENGTH IF THREADS ARE TO BE	PERIODIC		
	CA	AST-IN-F	LACE CONCRETE - REQUIREMEN	TS FOR SPECIAL INSPEC	CTION & TESTING REFERENCE			EXCLUDED FROM SHEAR PLANE)  D. PROPER BOLTING PROCEDURE SELECTED FOR JOINT	PERIODIC		
	AREAS OF INS	SPECTIO	ON & TESTING	INSPECTION OR TESTI		IBC REFERENCE		DETAIL.  E. CONNECTING ELEMENTS, INCLUDING THE APPROPRIATE	PERIODIC		
	INSPECT REINFORCEME TENDONS, AND VERIFY F			PERIODIC	ACI 318 CH. 20, 25.2, 25.3, 26.6.1 - 26.6.3	1908.4		FAYING SURFACE CONDITION AND HOLE PREPARATION, SPECIFIED, MEET APPLICABLE REQUIREMENTS. F. PRE-INSTALLATION VERIFICATION AND TESTING BY INSTALLATION PERSONNEL OBSERVED AND	PERIODIC		
			IFORCING BARS OTHER THAN	PERIODIC	AWS D1.4 ACI 318: 26.6.4	-		DOCUMENTED FOR FASTENER ASSEMBLIES AND METHODS USED. G. PROPER STORAGE PROVIDED FOR BOLTS, NUTS,	PERIODIC		
	ASTM A706; B. INSPECT SINGLE-PAS AND	S FILLE	T WELDS, MAXIMUM 5/16";	PERIODIC				WASHERS, AND OTHER FASTENERS.	PENIODIC		
	C. INSPECT ALL OTHER			CONTINUOUS			3.	<ul> <li>INSPECTION TASKS FOR HIGH-STRENGTH BOLTS, NUTS</li> <li>AND WASHERS DURING BOLTING:</li> <li>A. FASTENER ASSEMBLIES, OF SUITABLE CONDITION,</li> </ul>	PERIODIC	AISC 360, TABLE N5.6-2	
	INSPECT ANCHORS CAS			PERIODIC	ACI 318: 17.8.2	-		PLACED IN ALL HOLES AND WASHERS (IF REQUIRED)  ARE POSITIONED AS REQUIRED.	LINODIO		
			ED IN HORIZONTALLY OR	CONTINUOUS	ACI 318: 17.8.2.4	-		B. JOINT BROUGHT TO THE SNUG-TIGHT CONDITION PRIOR TO THE PRETENSIONING OPERATION.	PERIODIC		
	UPWARDLY INCLINED OI SUSTAINED TENSION LO B. MECHANICAL ANCHOI	DADS.		PERIODIC	ACI 318: 17.8.2			C. FASTENER COMPONENT NOT TURNED BY THE WRENCH PREVENTED FROM ROTATING. D. FASTENERS ARE PRETENSIONED IN ACCORDANCE	PERIODIC PERIODIC		
	VERIFY USE OF REQUIRE			PERIODIC	ACI 318: CH. 19,	1904.1, 1904.2,		WITH THE RCSC SPECIFICATION, PROGRESSING SYSTEMATICALLY FROM THE POST RIGID POINT	1 Enlegie		
			NT, FABRICATE SPECIMENS	CONTINUOUS	26.4.3, 26.4.4 ASTM C172	1908.2, 1908.3 1908.10	4.	TOWARD THE FREE EDGES.  1. INSPECTION TASK FOR HIGH-STRENGTH BOLTS, NUTS AND	CONTINUOUS	AISC 360,	
	TESTS, AND DETERMINE CONCRETE.  INSPECT CONCRETE ANI	THE TE		CONTINUOUS	ASTM C31 ACI 318: 26.4, 26.12 ACI 318: 26.5	1908.6, 1908.7,		WASHERS AFTER BOLTING:  A. DOCUMENT ACCEPTANCE OR REJECTION OF BOLTED CONNECTIONS.		TABLE N5.6-3	
	PROPER APPLICATION T	ECHNIQ		PERIODIC	ACI 318: 26.5.3	1908.8	5.	5. INSPECTION TASKS PRIOR TO WELDING: A. WELDING PROCEDURE SPECIFICATIONS (WPSs)	CONTINUOUS	AISC 360, TABLE N4.6-	
	AND TECHNIQUES.			PENIODIO	- 26.5.5	1900.9		ARE AVAILABLE B. MANUFACTURER CERTIFICATIONS FOR WELDING CONSUMABLES ARE AVAILABLE	CONTINUOUS	1	
	INSPECT PRESTRESSED A. APPLICATION OF PRES B. GROUTING OF BONDE	STRESS	ING FORCES; AND	CONTINUOUS CONTINUOUS	ACI 318: 26.10	-		C. MATERIAL IDENTIFICATION (TYPE/GRADE) D. WELDER IDENTIFICATION SYSTEM	PERIODIC PERIODIC		
10.	INSPECT ERECTION OF F	PRECAS	CONCRETE MEMBERS.	PERIODIC	ACI 318: CH. 26.8	-		F. FIT-UP OF GROOVE WELDS (INCLUDING JOINT GEOMETRY):	PERIODIC		
		s in Pos L of Sh	ST-TENSIONED CONCRETE ORES AND FORMS FROM	PERIODIC	ACI 318: 26.11.2	-		JOINT PREPARATION DIMENSIONS (ALIGNMENT, ROOT OPENING & FACE, LEVE CLEANLINESS (CONDITION OF STEEL SURFACES) TACKING (TACK WELD QUALITY AND LOCATION) BACKING TYPE AND FIT (IF APPLICABLE)	.)		
	INSPECT FORMWORK FO		PE, LOCATION AND E MEMBER BEING FORMED.	PERIODIC	ACI 318: 26.11.2 (b)	-		G. CONFIGURATION AND FINISH OF ACCESS HOLE. H. FIT-UP OF FILLET WELDS:	PERIODIC		
	DIMENSIONS OF THE SO	NOTILITE	MEMBER BEING FORMED.		20.11.2 (b)			DIMENSIONS (ALIGNMENT, GAPS AT ROOT) CLEANLINESS (CONDITION OF STEEL SURFACES)	PERIODIC		
							6.			AISC 360,	
								A. USE OF QUALIFIED WELDERS B. CONTROL AND HANDLING OF WELDING CONSUMABLES, INCLUDING PACKING AND EXPOSURE	PERIODIC PERIODIC	TABLE N4.6-2	
								C. ENVIRONMENTAL CONDITIONS INCLUDING WIND SPEED WITHIN LIMITS, PRECIPITATION, AND TEMPERATURE	PERIODIC		
								D. WPS FOLLOWED: SETTINGS ON WELDING EQUIPMENT.	PERIODIC		
								TRAVEL SPEED SELECTED WELDING MATERIALS SHIELDING GAS TYPE/FLOW RATE			
								PREHEAT APPLIED INTERPASS TEMPERATURE MAINTAINED (MIN/MAX)			
								PROPER POSITION (F, V, H, OH)  E. WELDING TECHNIQUES: INTERPASS AND FINAL CLEANING	PERIODIC		
			SIGN TABLE - IBC 2015 \ E WITH APPLICABLE BUILDING C					EACH PASS WITHIN PROFILE LIMITATIONS EACH PASS MEETS QUALITY REQUIREMENTS			
							7.	A. WELDS CLEANED.	PERIODIC	AISC 360, TABLE N4.6-3	
CCUI	LOCATION PANCY RISK CATEGORY		115 SOUTH AVENUE, ROCH	,	BC 2015 TABLE 1604.5			B. SIZE, LENGTH, AND LOCATIONS OF WELDS C. WELDS MEET VISUAL ACCEPTANCE CRITERIA: CRACK PROHIBITION	CONTINUOUS CONTINUOUS		
	ICABLE BUILDING CODE		NEW YORK S		BO 2010 IMBLE 100 II.0			WELD/BASE-METAL FUSION CRATER CROSS SECTION			
WAB	LE BEARING PRESSURE		10 TSF (ASSU	MED)				WELD PROFILES WELD SIZE UNDERCUT			
	TERRACE / SIDEWALK MECHANICAL	DL1 DL2	PER MATER 10 PSF	IAL				POROSITY D. ARC STRIKES	CONTINUOUS		
EHIC	CULAR DRIVEWAYS AND		250 PSF / 8,00	0 LBS	BC 2015 TABLE 1607.1			E. k-AREA F. BACKING REMOVED AND WELD TABS REMOVED (IF	CONTINUOUS CONTINUOUS		
RDS,	SUBJECT TO TRUCKING SSIBLE TO FIRETRUCKS		75 PSI @ OUTRIGGER		NFPA 1901			REQUIRED) G. REPAIR ACTIVITIES F. DOCUMENT ACCEPTANCE OR REJECTION OF WELDED JOIN'	CONTINUOUS CONTINUOUS		
	ERRACES, PEDESTRIAN		100 PSF	` '	BC 2015 TABLE 1607.1		0	OR MEMBER  3. VERIFY PLACEMENT OF ANCHOR RODS AND OTHER	PERIODIC	AISC 360, N5.7	
LOAD	O IMPORTANCE FACTOR GROUND SNOW LOAD	Is Pg	1.1 40 PSF		ASCE 7-10 TABLE 1.5-2 BC 2015 FIGURE 1608.2		0.	EMBEDMENT SUPPORTING STRUCTURAL STEEL FOR COMPLIANCE WITH THE CONSTRUCTION DOCUMENTS.	FLNIUDIU	AIOU 000, NO./	
SN	OW EXPOSURE FACTOR THERMAL FACTOR	Ce Ct	1.0 1.2		ASCE 7-10 TABLE 7-2 ASCE 7-10 TABLE 7-3			VERIFY DIAMETER, GRADE, TYPE, AND LENGTH OF ANCHOR ROD OR EMBEDMENT ITEM AND THE EXTENT OR DEPTH OF			
	FLAT ROOF SNOW DRIFTING SNOW WIDTH	Pf w	37 PSF 21'-6"		ASCE 7-10 SECTION 7.3 ASCE 7-10 SECTION 7.7			THE EMBEDMENT INTO THE CONCRETE PRIOR TO PLACEMENT OF CONCRETE.			
DI	RIFT SURCHARGE LOAD ESISTING SYSTEM):	Pd	103 PSF		ASCE 7-10 SECTION 7.7		9.	<ol> <li>INSPECT STEEL FRAME JOINT DETAILS FOR COMPLIANCE WIT CONSTRUCTION DOCUMENTS:</li> </ol>	H PERIODIC	AISC 360, N5.7	

SCHEDULE OF STRUCTURAL SPECIAL INSPECTIONS

THE FOLLOWING TABLES COMPRISES THE STRUCTURAL SPECIAL INSPECTION REQUIREMENTS FOR THIS PROJECT IN ACCORDANCE WITH CHAPTER 17 OF THE 2015 INTERNATIONAL BUILDING CODE. REFER TO THE PROJECT SPECIFICATIONS FOR REQUIRED QUALIFICATIONS OF



A. DETAILS SUCH AS BRACING AND STIFFENERS.

APPLICATION OF JOINT DETAILS AT EACH CONNECTION.

B. PLACEMENT AND INSTALLATION OF STEEL HEADED STUD

. DOCUMENT ACCEPTANCE OR REJECTION OF STEEL

O. INSPECT STEEL ELEMENTS OF COMPOSITE CONSTRUCTION

A. PLACEMENT AND INSTALLATION OF STEEL DECK.

MEMBER LOCATIONS.

PRIOR TO CONCRETE PLACEMENT:

ASCE 7-10 SECTION 11.4.4

ASCE 7-10 TABLE 11.6-(1&2)

ASCE 7-10 SECTION 12.8.1.1

ASCE 7-10 SECTION 1.4.3

ASCE 7-10 TABLE 12.2-1

ASCE 7-10 SECTION 12.8.1

GENERAL STRUCTURAL INTEGRITY

F.	INSIDE FACE
LH	LONG LEG HORIZONTAL
LV	LONG LEG VERTICAL
IANUF.	MANUFACTURER
IAX.	MAXIMUM
IECH.	MECHANICAL
IIN.	MINIMUM
٧)	NEW
.C.	ON CENTER
.F.	OUTSIDE FACE
	PIER (SEE SCHEDULE)
LF	POUNDS PER LINEAR FOOT
EINF.	RENFORCING, REINFORCEMENT
.J.	SAW-CUT CONTROL JOINT
PA., SP.	SPACE OR SPACING
TD.	STANDARD
DI	STEEL DECK INSTITUTE
SF	TON PER SQUARE FOOT
&B	TOP & BOTTOM
.F.	TOP FACE
.0.	TOP OF
.0.S.	TOP OF STEEL
YP.	TYPICAL
.O.N.	UNLESS OTHERWISE NOTED
.I.F.	VERIFY IN FIELD
ERT.	VERTICAL
/.W.R.	WELDED WIRE REINFORCEMENT
<b>I</b> /	WITH
	WORKING POINT

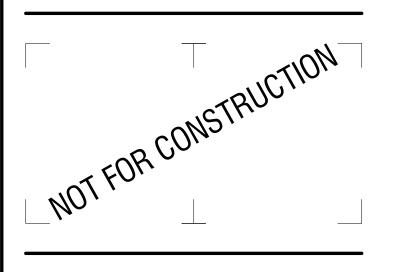
AISC 360, N6



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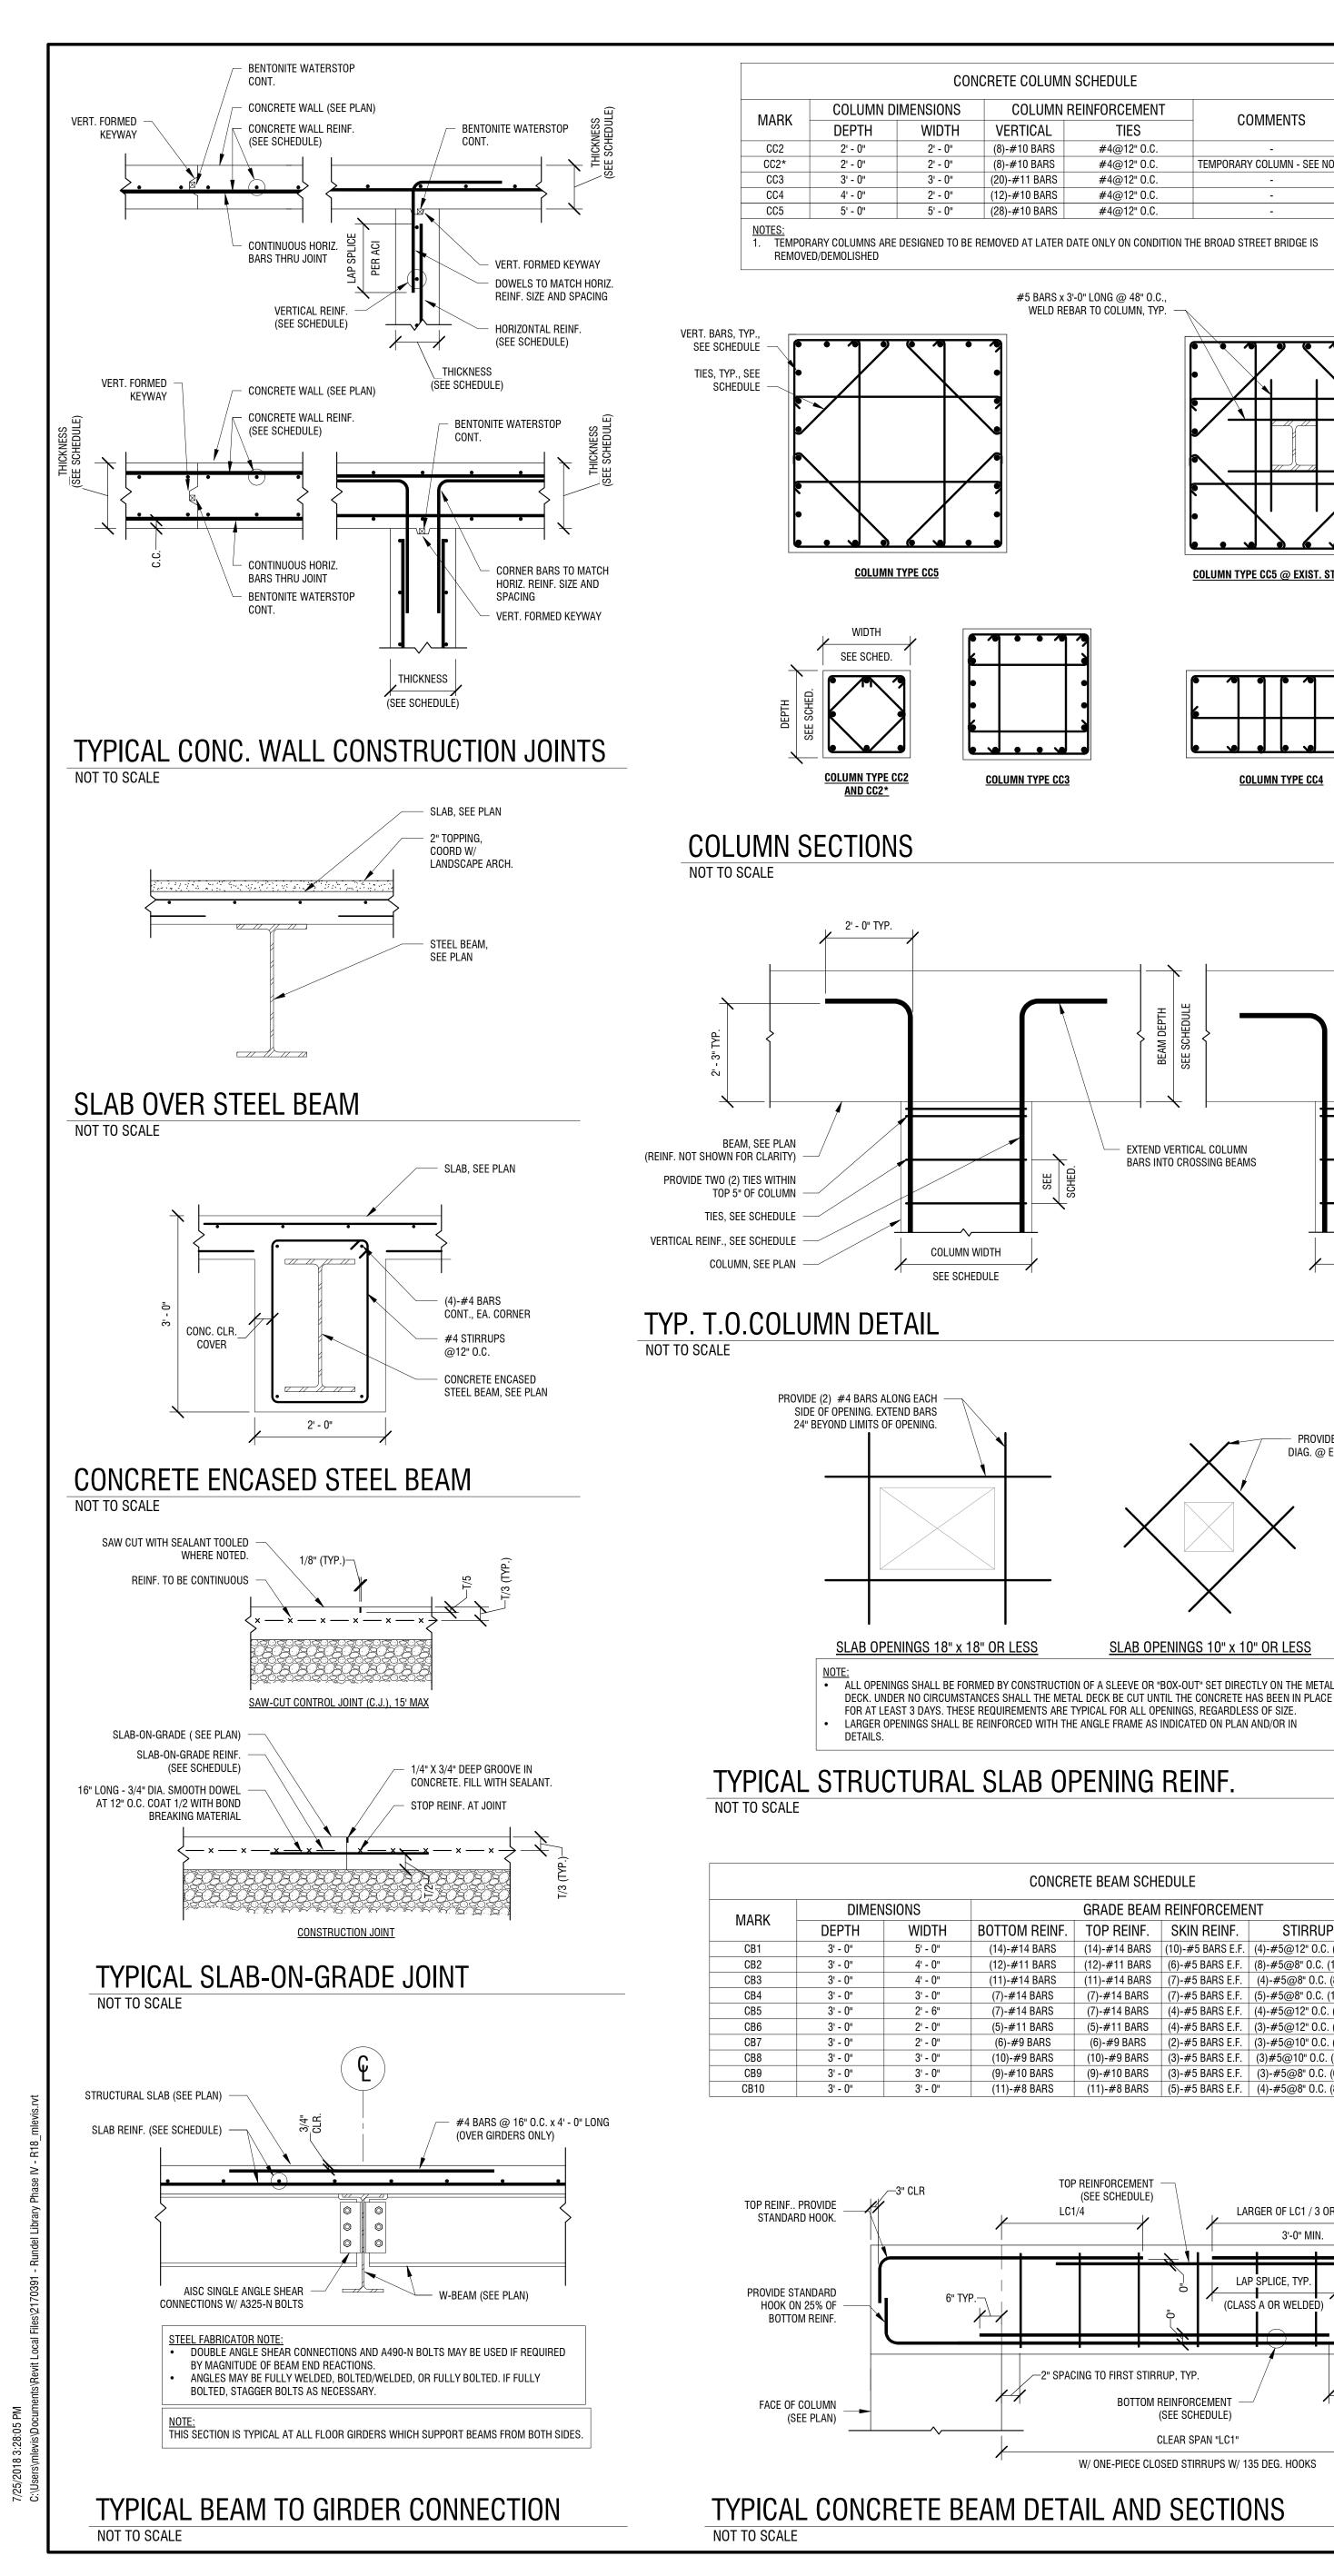
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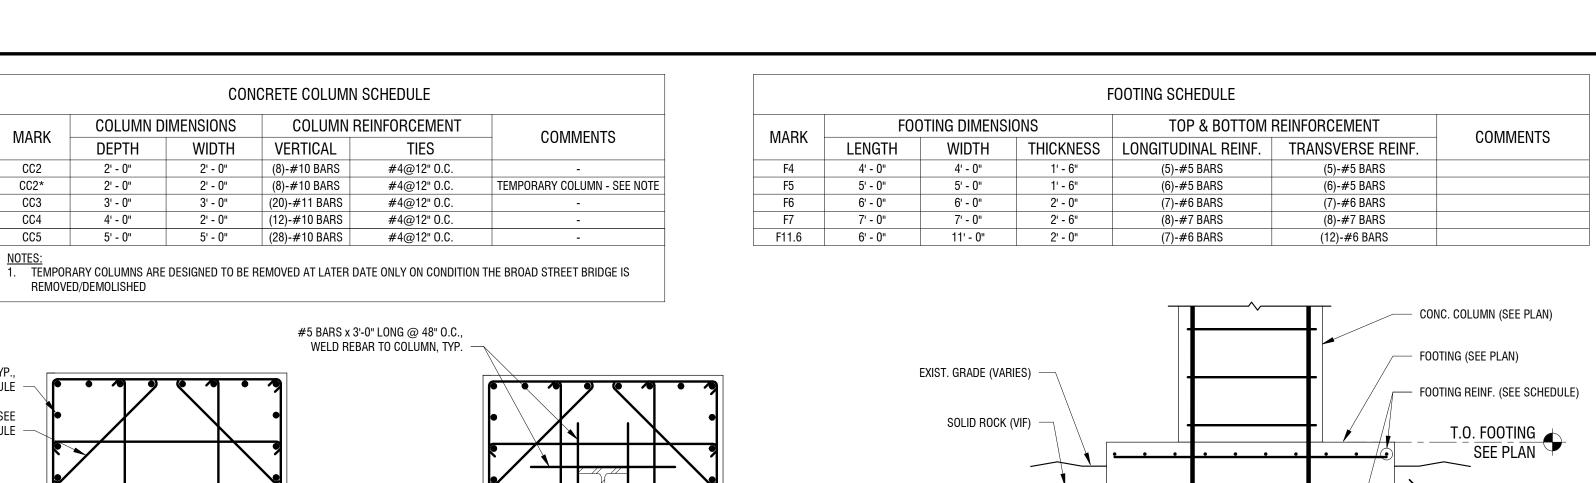
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> **GENERAL NOTES & SPECIAL INSPECTIONS**

DRAWING NUMBER:

DRAWING NAME:





NOT TO SCALE

NOT TO SCALE

**COLUMN TYPE CC4** 

COLUMN WIDTH

SEE SCHEDULE

PROVIDE (1) #4 BAR x 3' - 0" LONG

COMMENTS

(4)-#5@8" O.C. (8 LEGS)

(9)-#10 BARS (3)-#5 BARS E.F. (3)-#5@8" O.C. (6 LEGS)

(11)-#8 BARS (5)-#5 BARS E.F. (4)-#5@8" O.C. (8 LEGS)

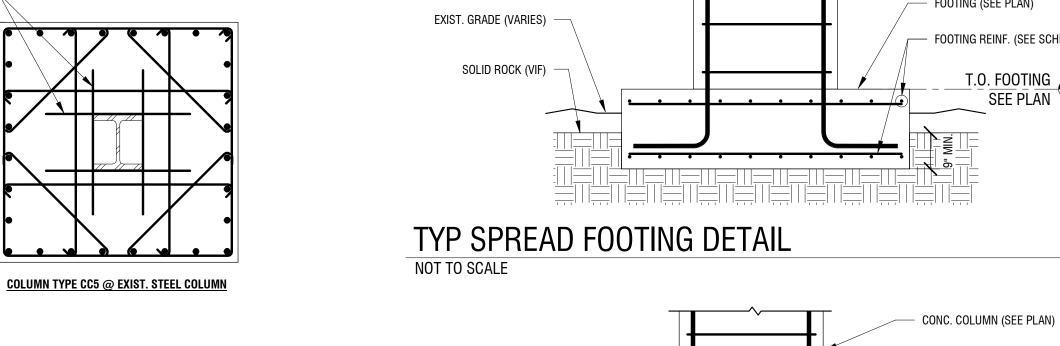
DIAG. @ EACH CORNER OF OPENING.

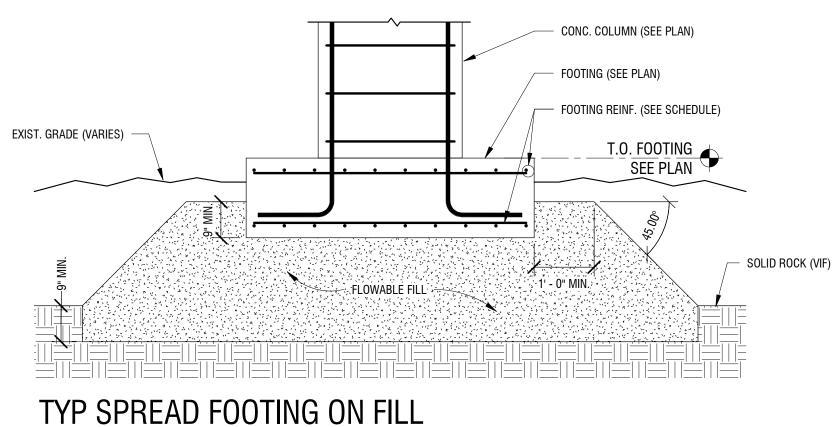
EXTEND VERTICAL COLUMN

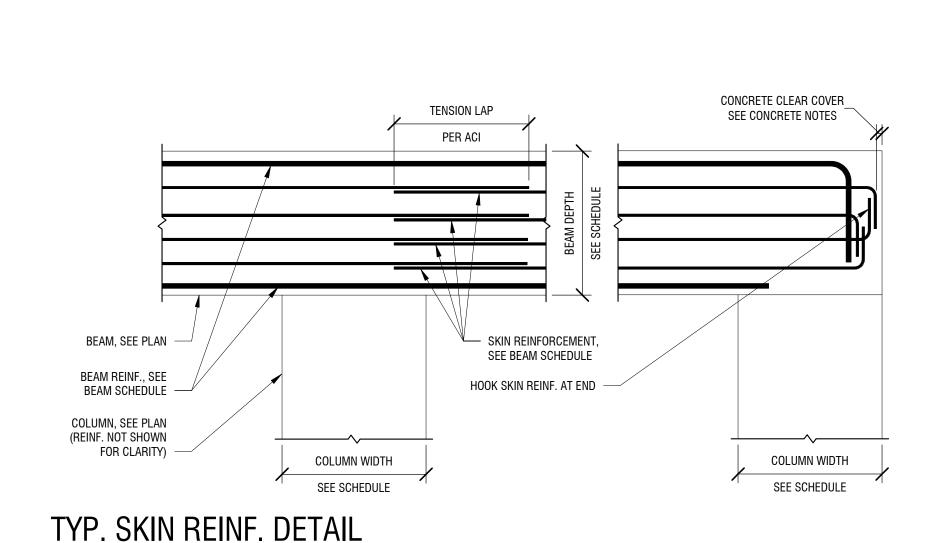
BARS INTO CROSSING BEAMS

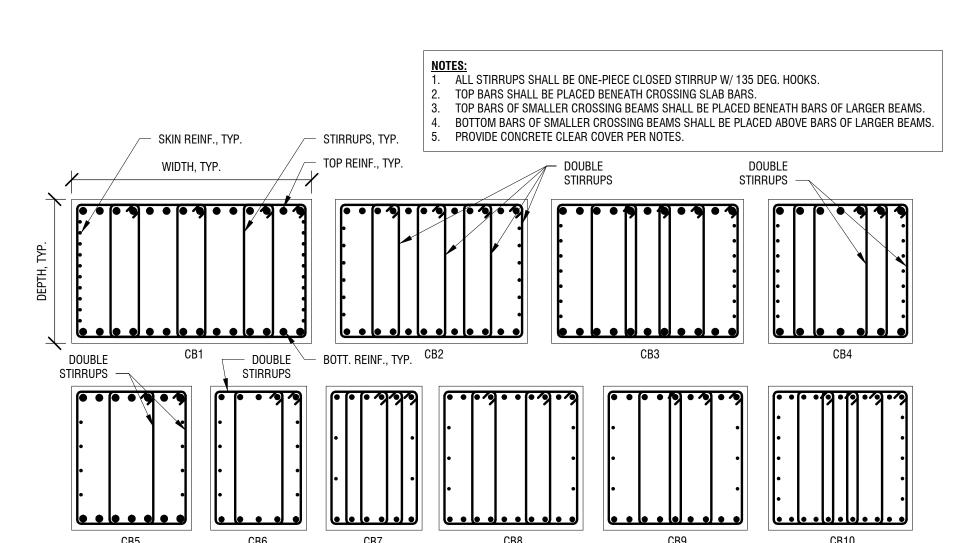
SLAB OPENINGS 10" x 10" OR LESS

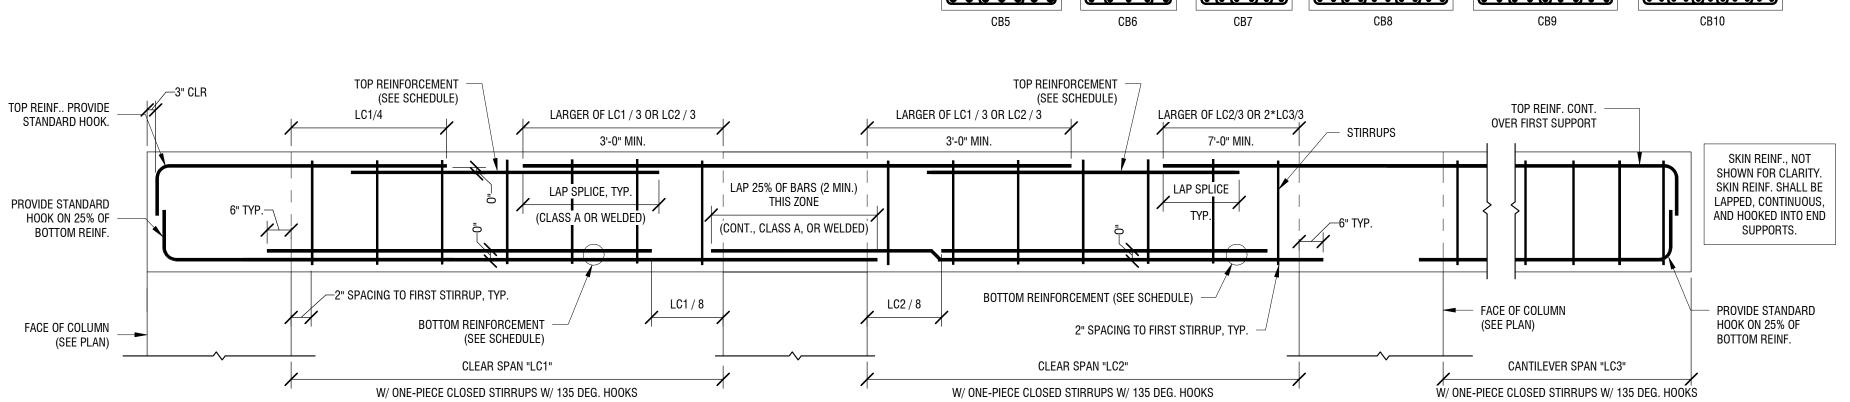
**CONCRETE BEAM SCHEDULE** 







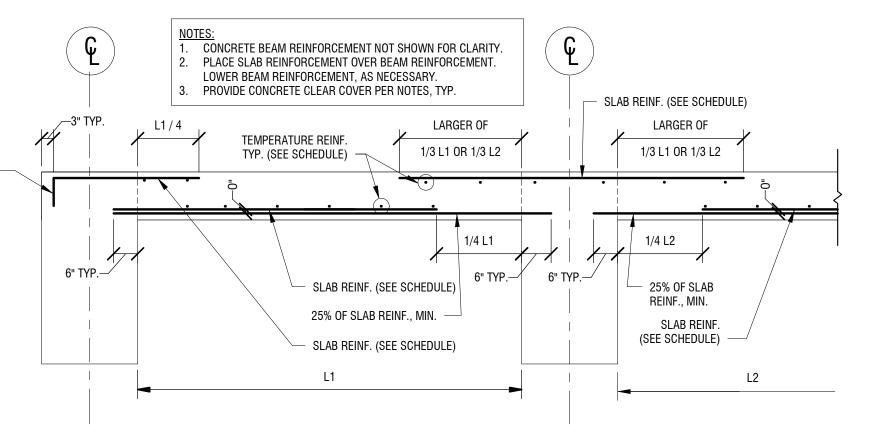




TYPICAL CONCRETE BEAM DETAIL AND SECTIONS

			FOUNDATION V	VALL SCHEDULE	
MARK	TYPE	THICKNESS		EINFORCEMENT	COMMENTS
			HORIZONTAL	VERTICAL	
C8	CONCRETE	8"	#5 @ 12" O.C.	#5 @ 12" O.C.	
					•

		STRUC	CTURAL SLAB SCHEDULE	
MARK	TYPE	SLAB THICKNESS	SLAB REINFORCEMENT	COMMENTS
S6+T2	ONE WAY SLAB	6"	#4@11" O.C.	TEMP/SHRINK STEEL: #4@12" O.C., 2" TOPPING
S8A	ONE WAY SLAB	8"	#5@10" O.C.	TEMP/SHRINK STEEL: #4@12" O.C.
S8B	ONE WAY SLAB	8"	#5@7" O.C.	TEMP/SHRINK STEEL: #4@12" O.C.
S12	ONE WAY SLAB	1' - 0"	#5@10" O.C.	TEMP/SHRINK STEEL: #4@8" O.C.
S12A	ONE-WAY SLAB	1' - 0"	#5@7" O.C. (T&B)	TEMP/SHRINK STEEL: #4@9" O.C.
S14	ONE WAY SLAB	1' - 2"	#5@9" O.C.	TEMP/SHRINK STEEL: #4@7" O.C.



TYPICAL ONE WAY SLAB DETAIL

NOT TO SCALE

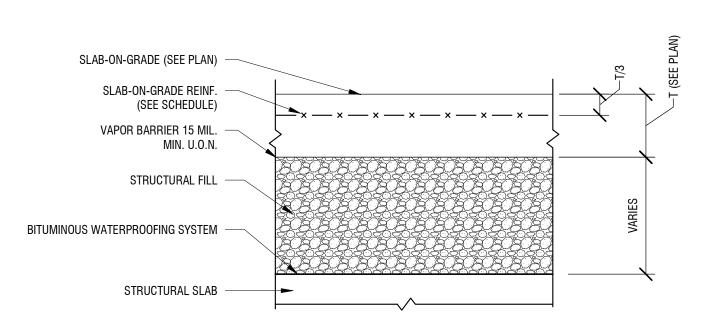
STD. HOOK,

MARK	TYPE	SLAB THICKNESS	SLAB REINFORCEMENT	COMMENTS
S.O.G.5	SLAB-ON-GRADE	5"	4x4-W6xW6 WWR	
S.O.G.6.5R	SLAB-ON-GRADE	6 1/2"	4x4-W6xW6 WWR	RADIANT HEATED SLAB, COORD. W/ M
S.O.G.8	SLAB-ON-GRADE	8"	4x4-W6xW6 WWR	
S.O.G.8R	SLAB-ON-GRADE	8"	4x4-W6xW6 WWR	RADIANT HEATED SLAB, COORD. W/ M
	I-GRADE (SEE PLAN)  IB-ON-GRADE REINF.			3 EE PLAN)
SLA	,	_ x _ x _		T/3

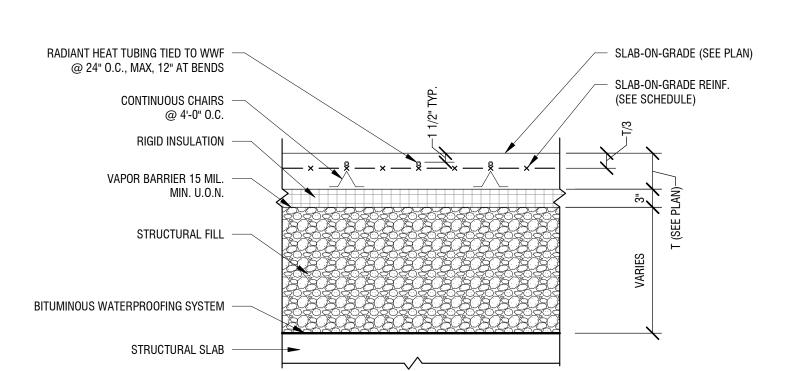
TYPICAL SLAB-ON-GRADE

FLOWABLE FILL

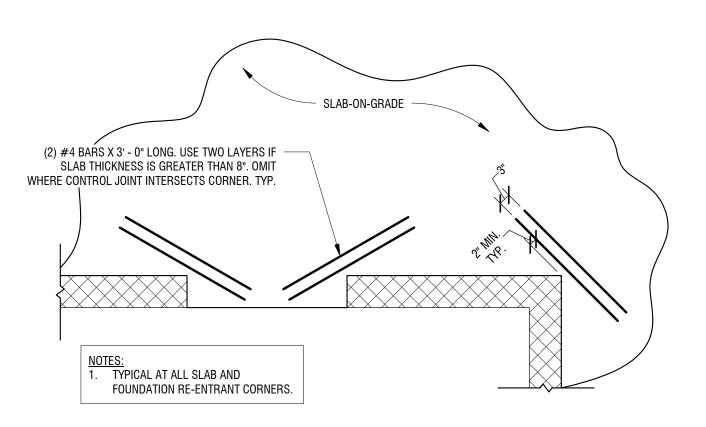
NOT TO SCALE



### TYPICAL SLAB-ON-GRADE OVER STRUCTURAL SLAB NOT TO SCALE



TYPICAL RADIANT SLAB OVER STRUCTURAL SLAB NOT TO SCALE

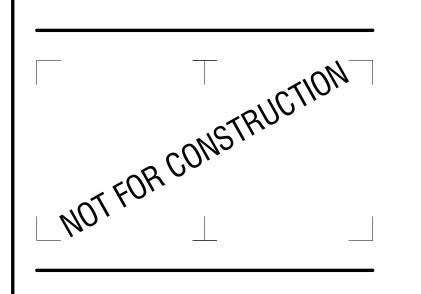


TYPICAL SLAB-ON-GRADE RE-ENTRANT CORNER

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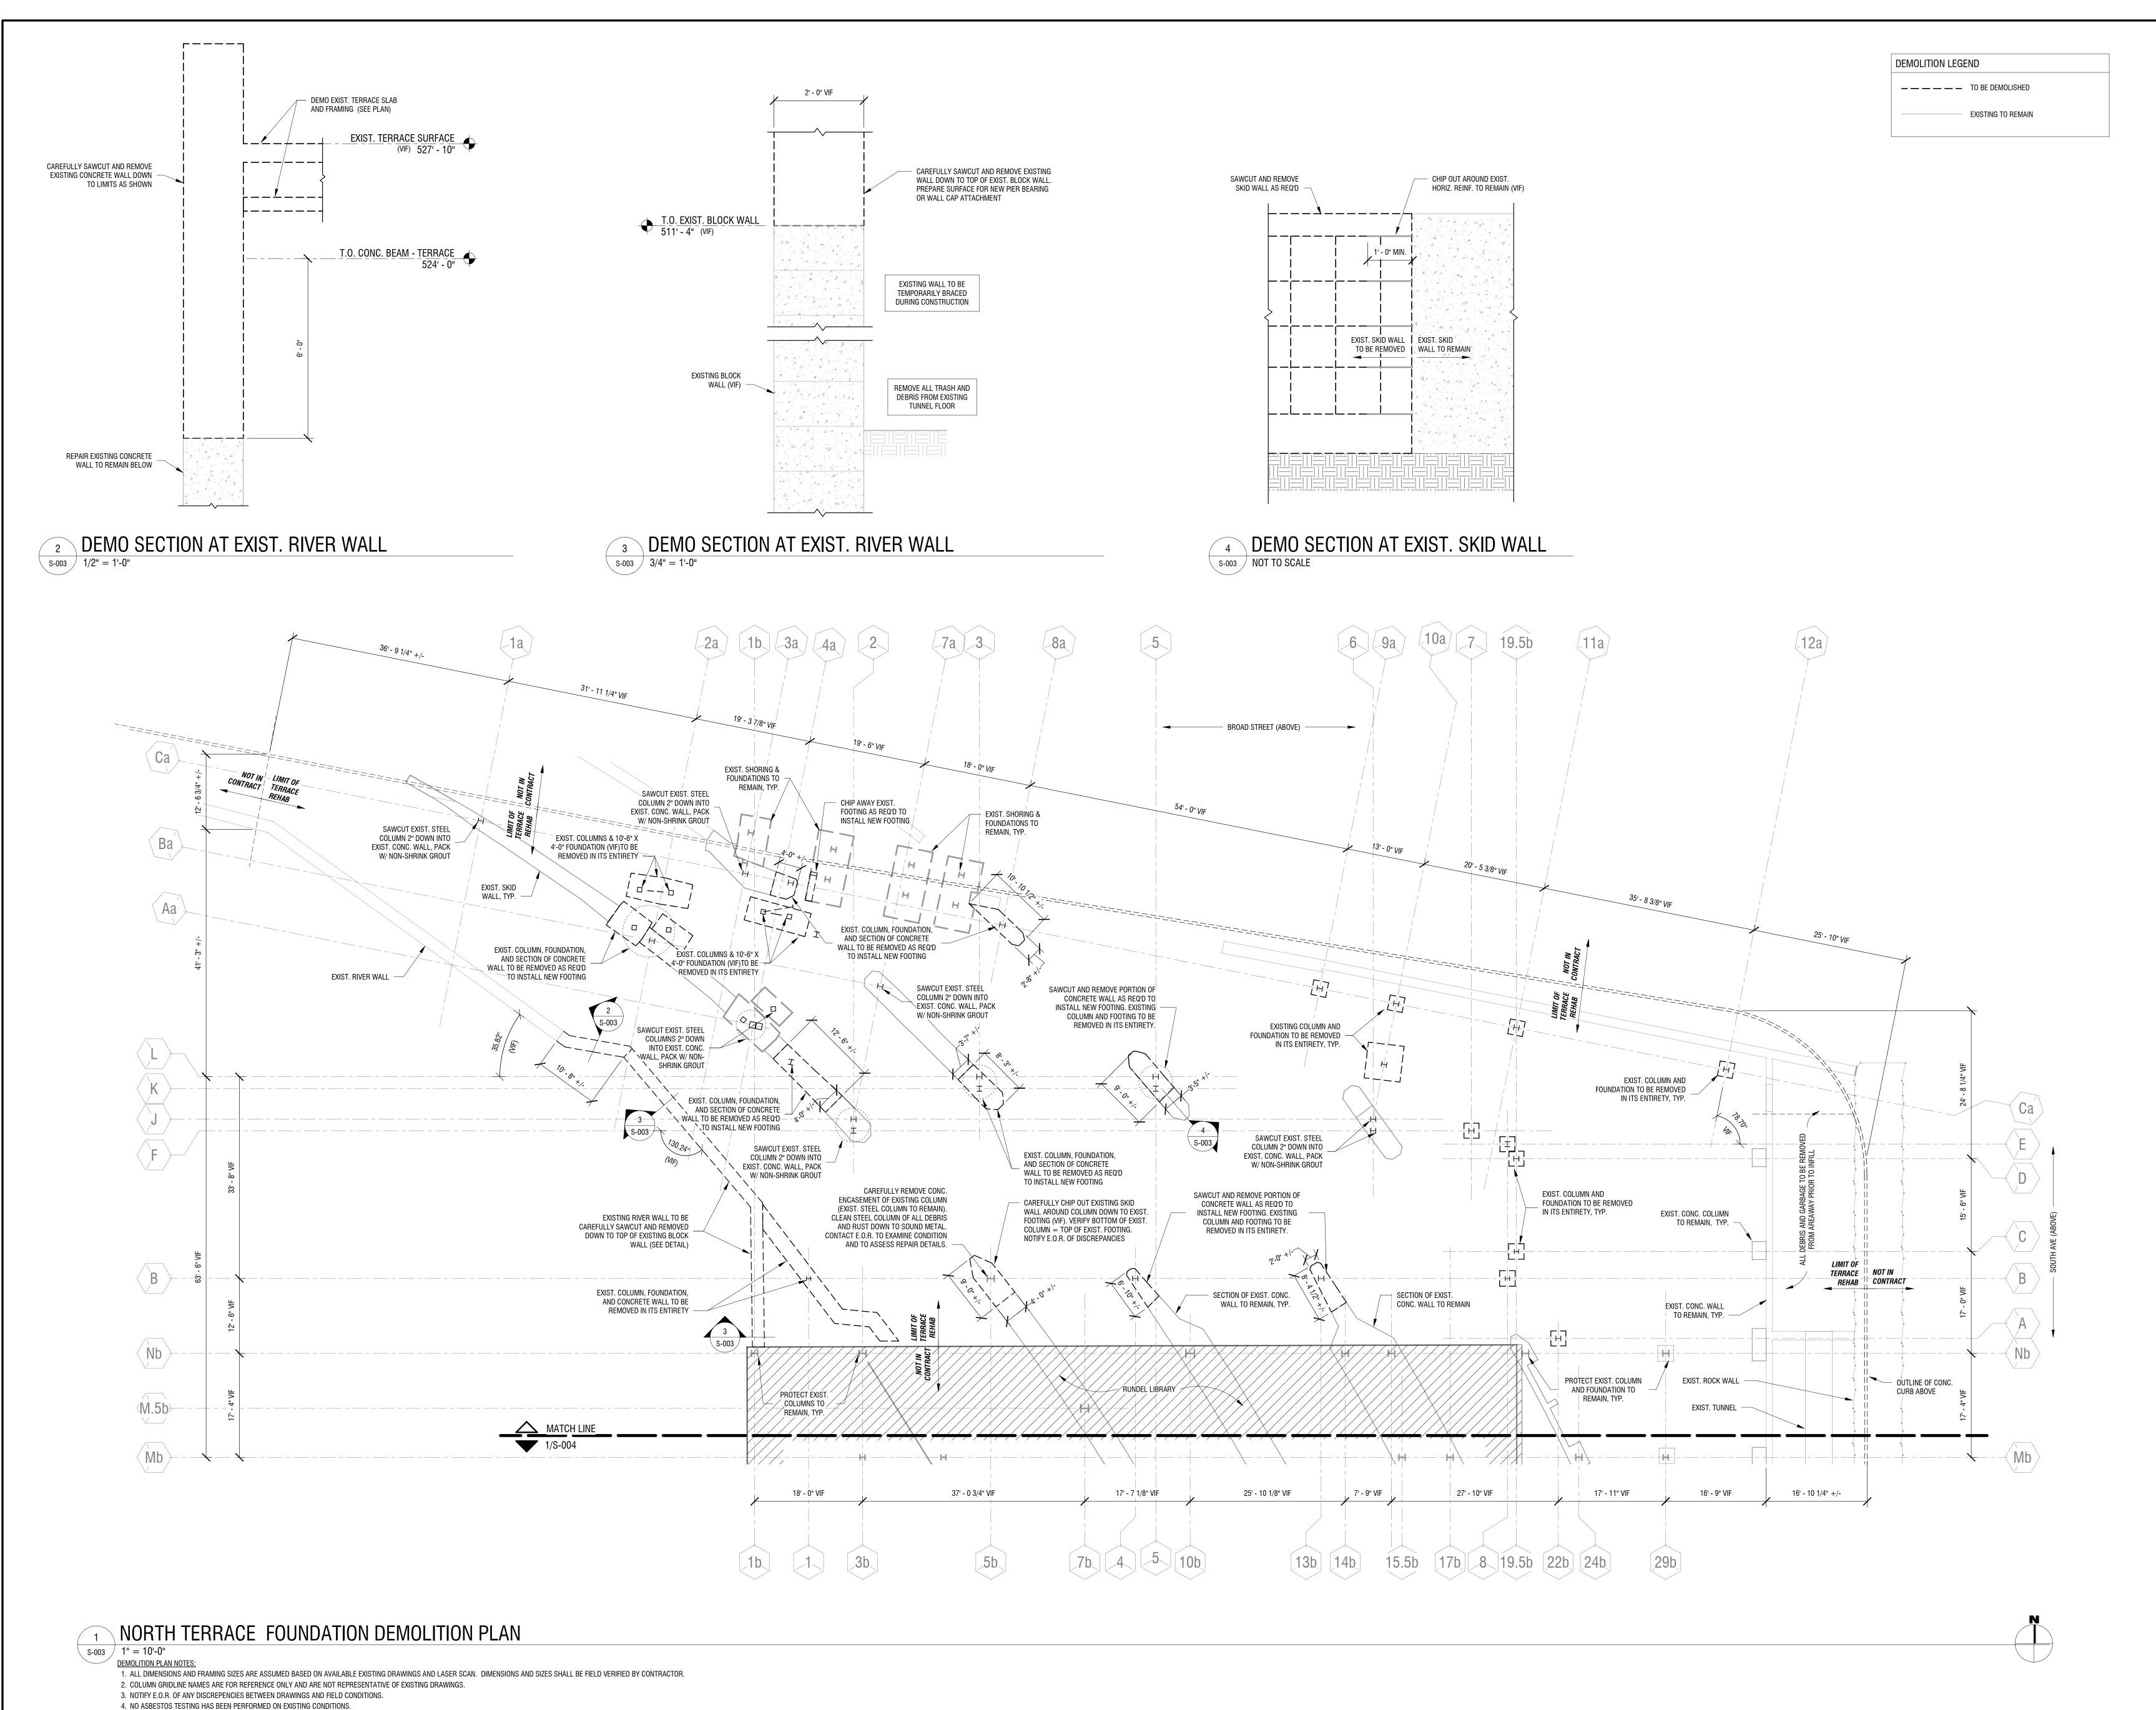
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JULY 2018 DRAWING NAME:

> **SCHEDULES & TYPICAL DETAILS**

DRAWING NUMBER:



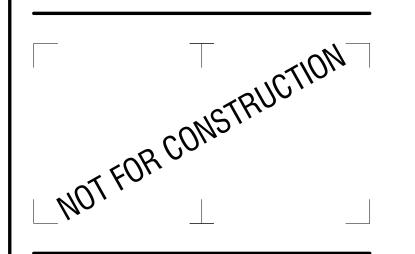
5. COORDINATE WITH MEP FOR TEMPORARY SUPPORTS AND MEP REMOVALS.

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MML

REVIEWED BY:

JMG

ISSUED FOR:

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DESCRIPTION:

JULY 2018

DRAWING NAME:

NORTH TERRACE
FOUNDATION DEMOLITION
PLAN

DRAWING NUMBER:

**S-003** 

DEMOLITION LEGEND

TO BE DEMOLISHED

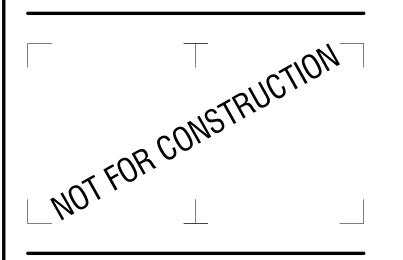
EXISTING TO REMAIN

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alteration.

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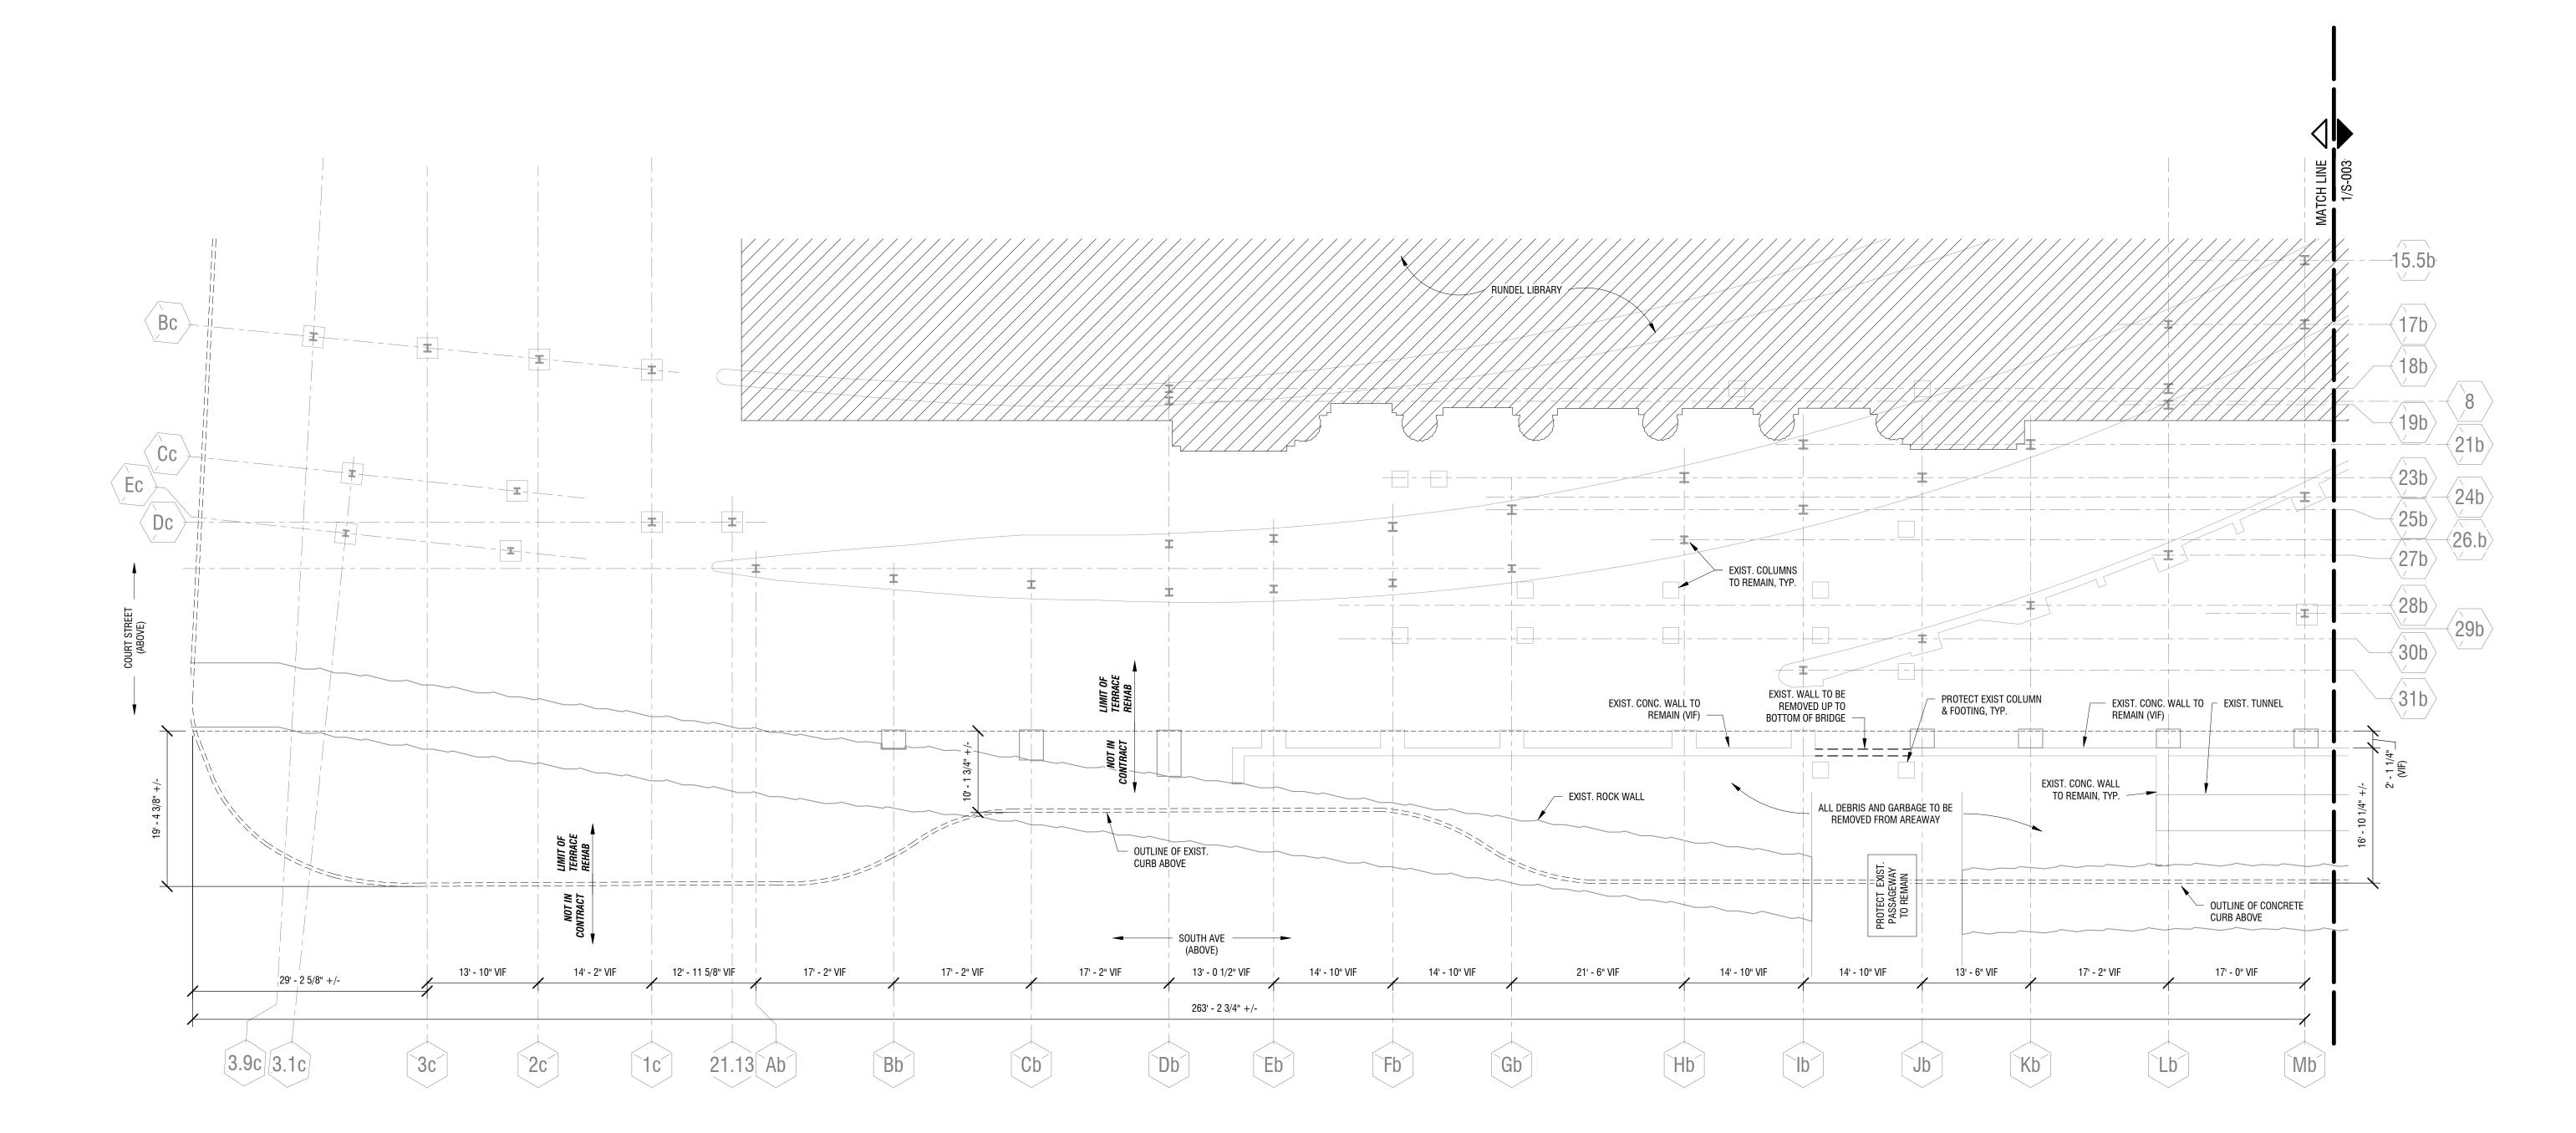
DATE:

DRAWING NAME:

EAST SIDEWALK & AREAWAY FOUNDATION

**DEMOLITION PLAN** 

DRAWING NUMBER:



#### 1 EAST SIDEWALK & AREAWAY FOUNDATION DEMOLITION PLAN

s-004 1" = 10'-0"

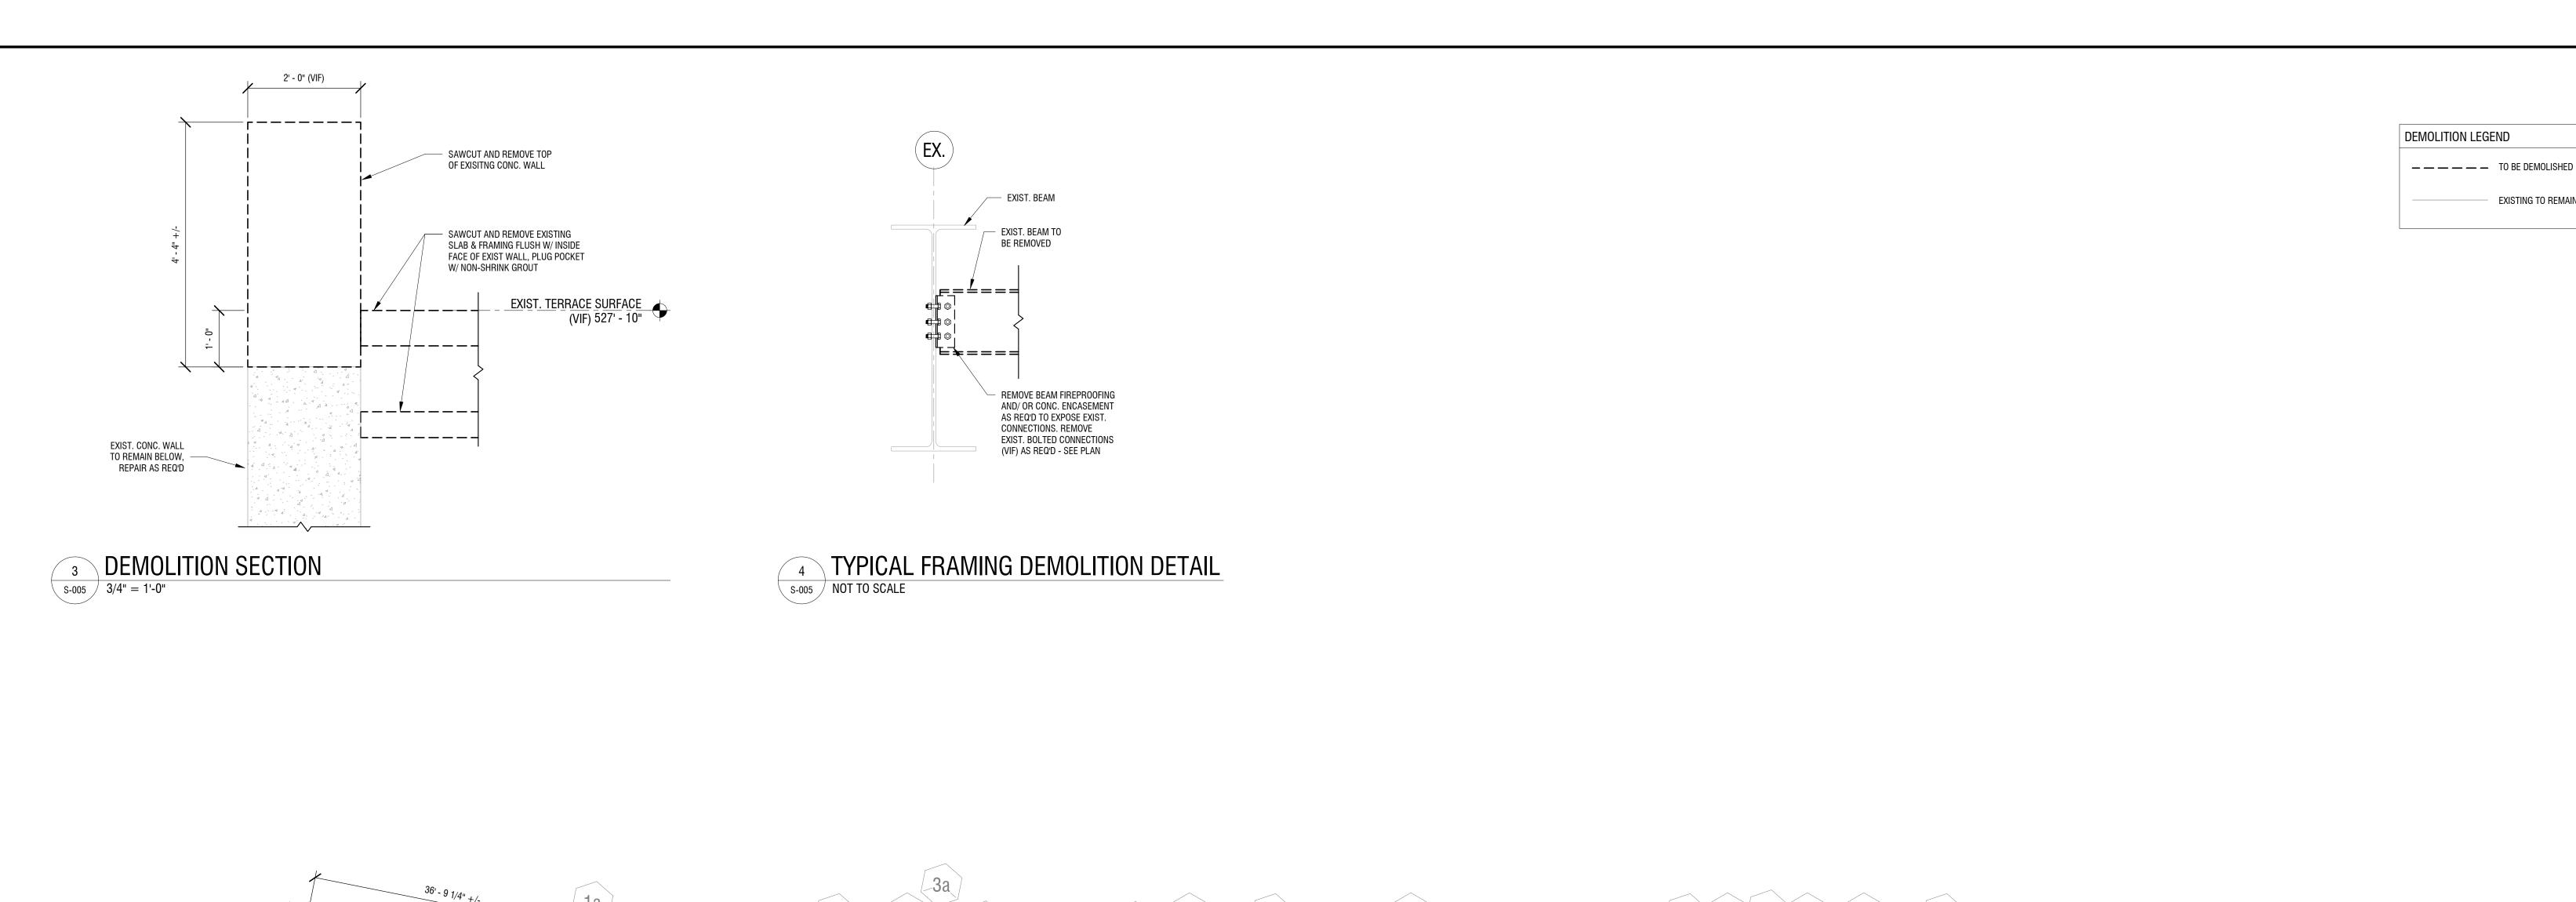
DEMOLITION PLAN NOTES:

1. ALL DIMENSIONS AND FRAMING SIZES ARE ASSUMED BASED ON AVAILABLE EXISTING DRAWINGS AND LASER SCAN. DIMENSIONS AND SIZES SHALL BE FIELD VERIFIED BY CONTRACTOR.

ALL DIMENSIONS AND FRAMING SIZES ARE ASSUMED BASED ON AVAILABLE EXISTING DRAWINGS AND LASER SCA
 COLUMN GRIDLINE NAMES ARE FOR REFERENCE ONLY AND ARE NOT REPRESENTATIVE OF EXISTING DRAWINGS.
 NOTIFY E.O.R. OF ANY DISCREPENCIES BETWEEN DRAWINGS AND FIELD CONDITIONS.

4. NO ASBESTOS TESTING HAS BEEN PERFORMED ON EXISTING CONDITIONS.5. COORDINATE WITH MEP FOR TEMPORARY SUPPORTS AND MEP REMOVALS.

**S-004** 

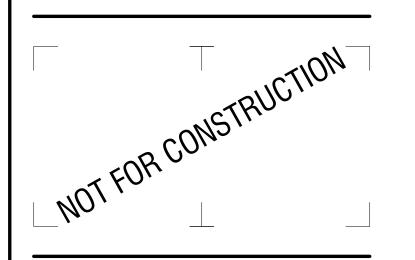




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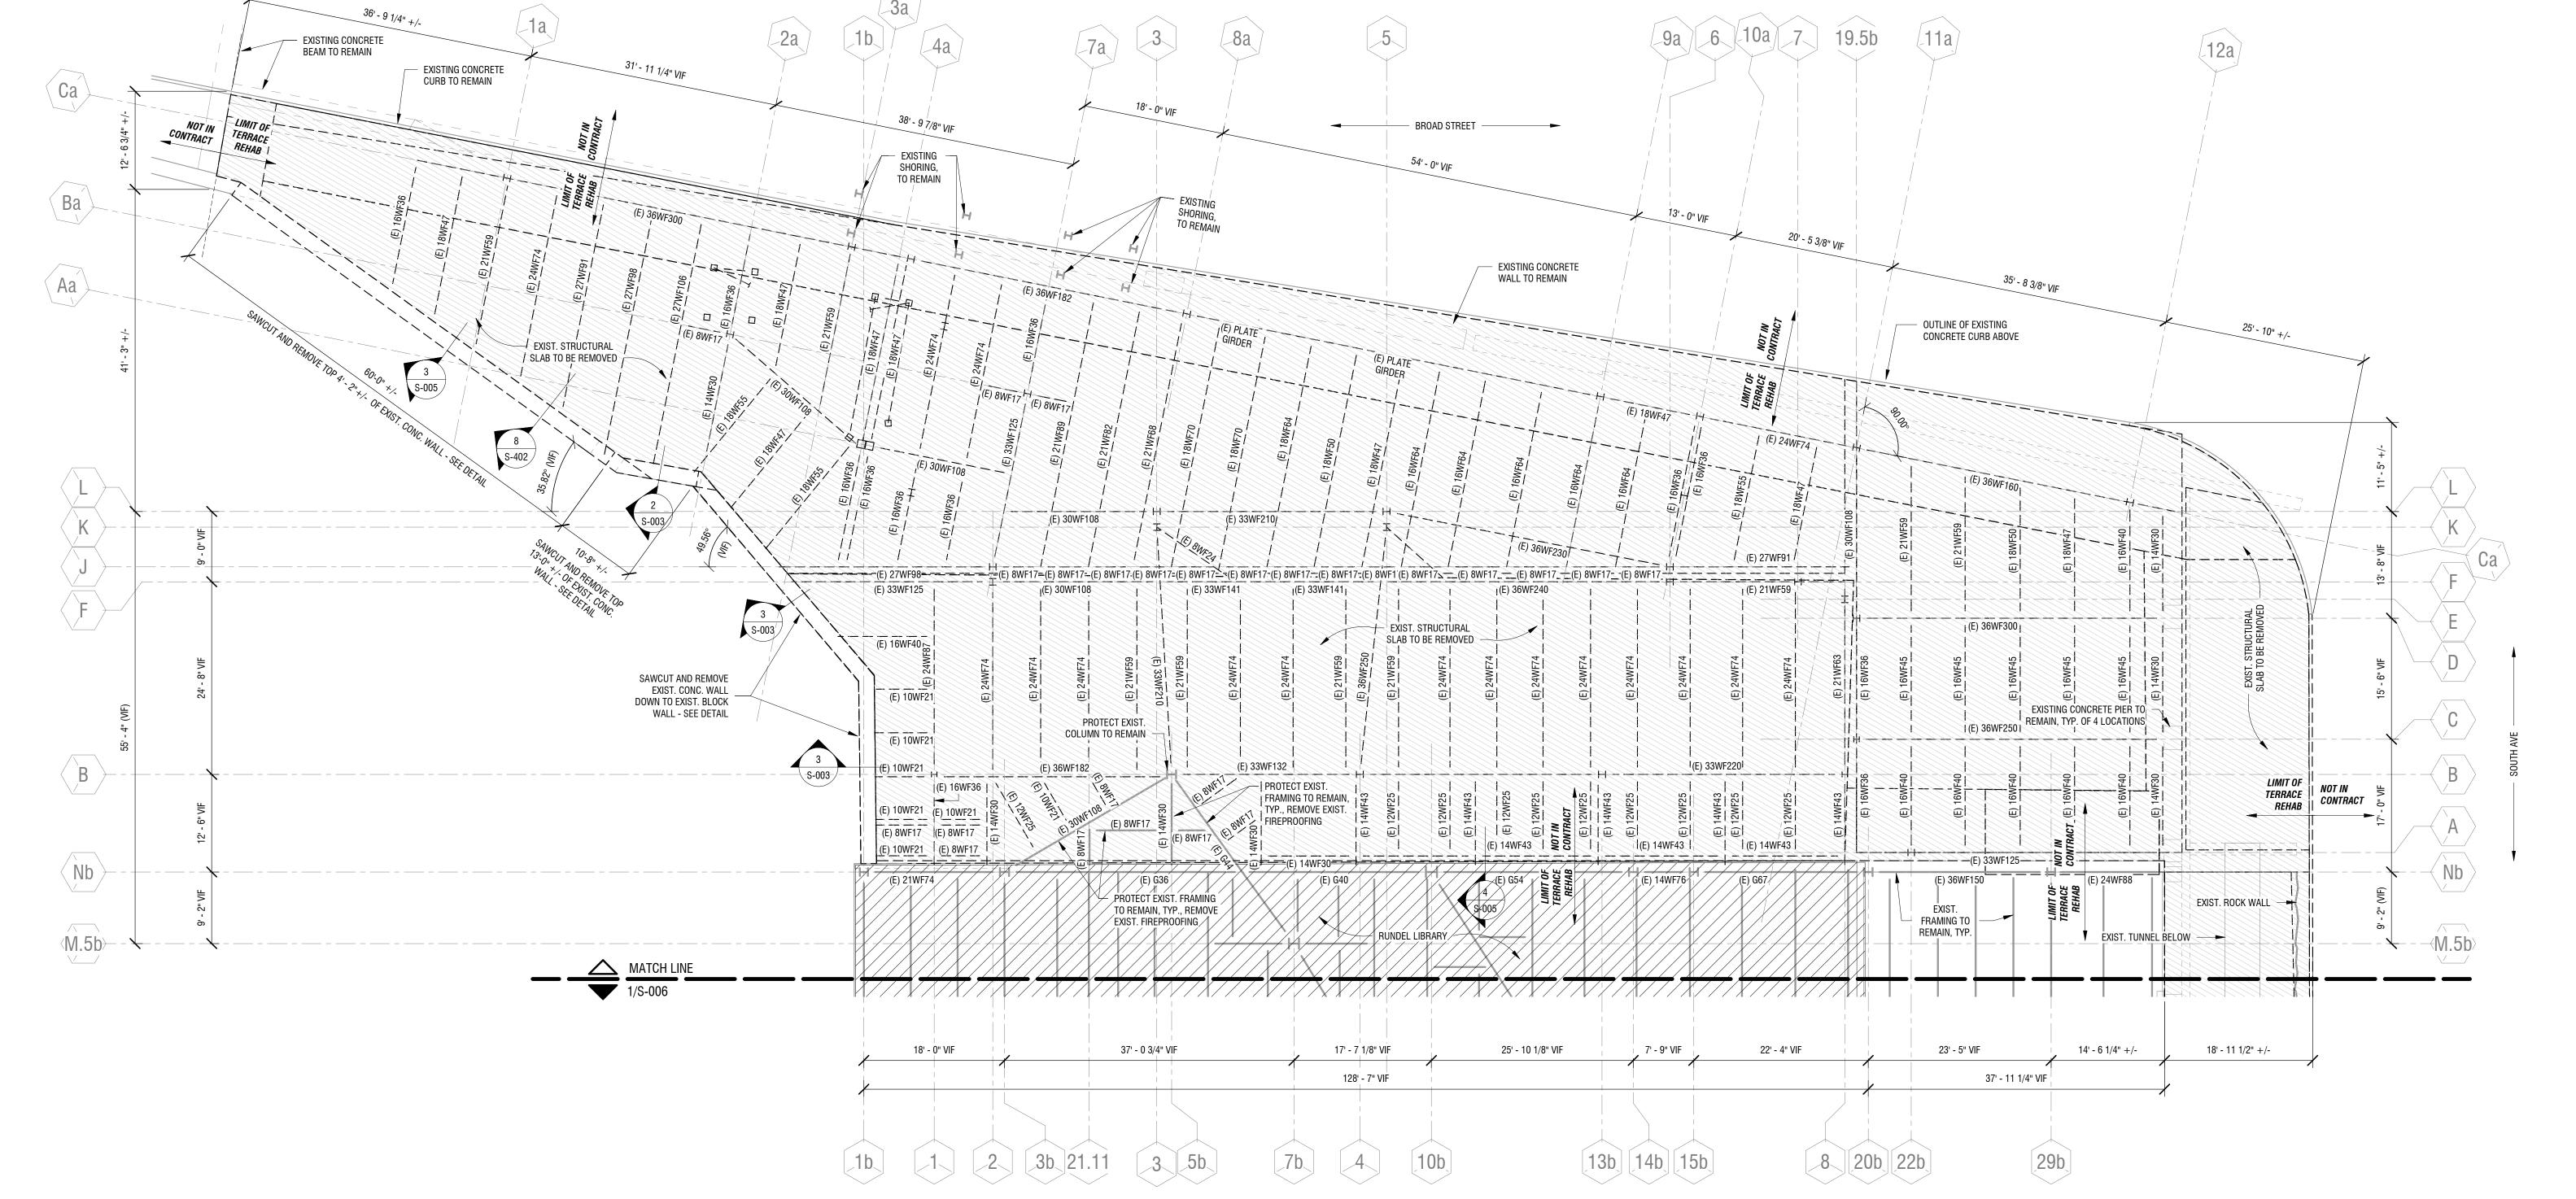
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> **NORTH TERRACE** FRAMING DEMOLITION **PLAN**

DRAWING NUMBER:

DRAWING NAME:



NORTH TERRACE DEMOLITION FRAMING PLAN - WEST

s-005 1" = 10'-0"

**DEMOLITION PLAN NOTES:** 1. ALL DIMENSIONS AND FRAMING SIZES ARE ASSUMED BASED ON AVAILABLE EXISTING DRAWINGS AND LASER SCAN. DIMENSIONS AND SIZES SHALL BE FIELD VERIFIED BY CONTRACTOR.

2. COLUMN GRIDLINE NAMES ARE FOR REFERENCE ONLY AND ARE NOT REPRESENTATIVE OF EXISTING DRAWINGS.

3. NOTIFY E.O.R. OF ANY DISCREPENCIES BETWEEN DRAWINGS AND FIELD CONDITIONS. 4. NO ASBESTOS TESTING HAS BEEN PERFORMED ON EXISTING CONDITIONS.

5. COORDINATE WITH MEP FOR TEMPORARY SUPPORTS AND MEP REMOVALS.

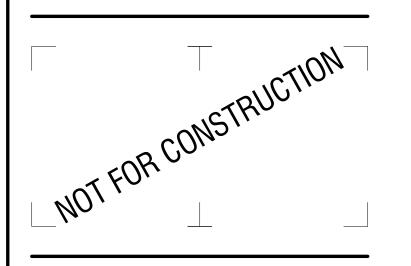
DEMOLITION LEGEND — — — — TO BE DEMOLISHED

EXISTING TO REMAIN

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**RUNDEL LIBRARY PHASE IV** 115 SOUTH AVE.

ROCHESTER, NY 14604

DESCRIPTION: PROJECT NUMBER: 2170391

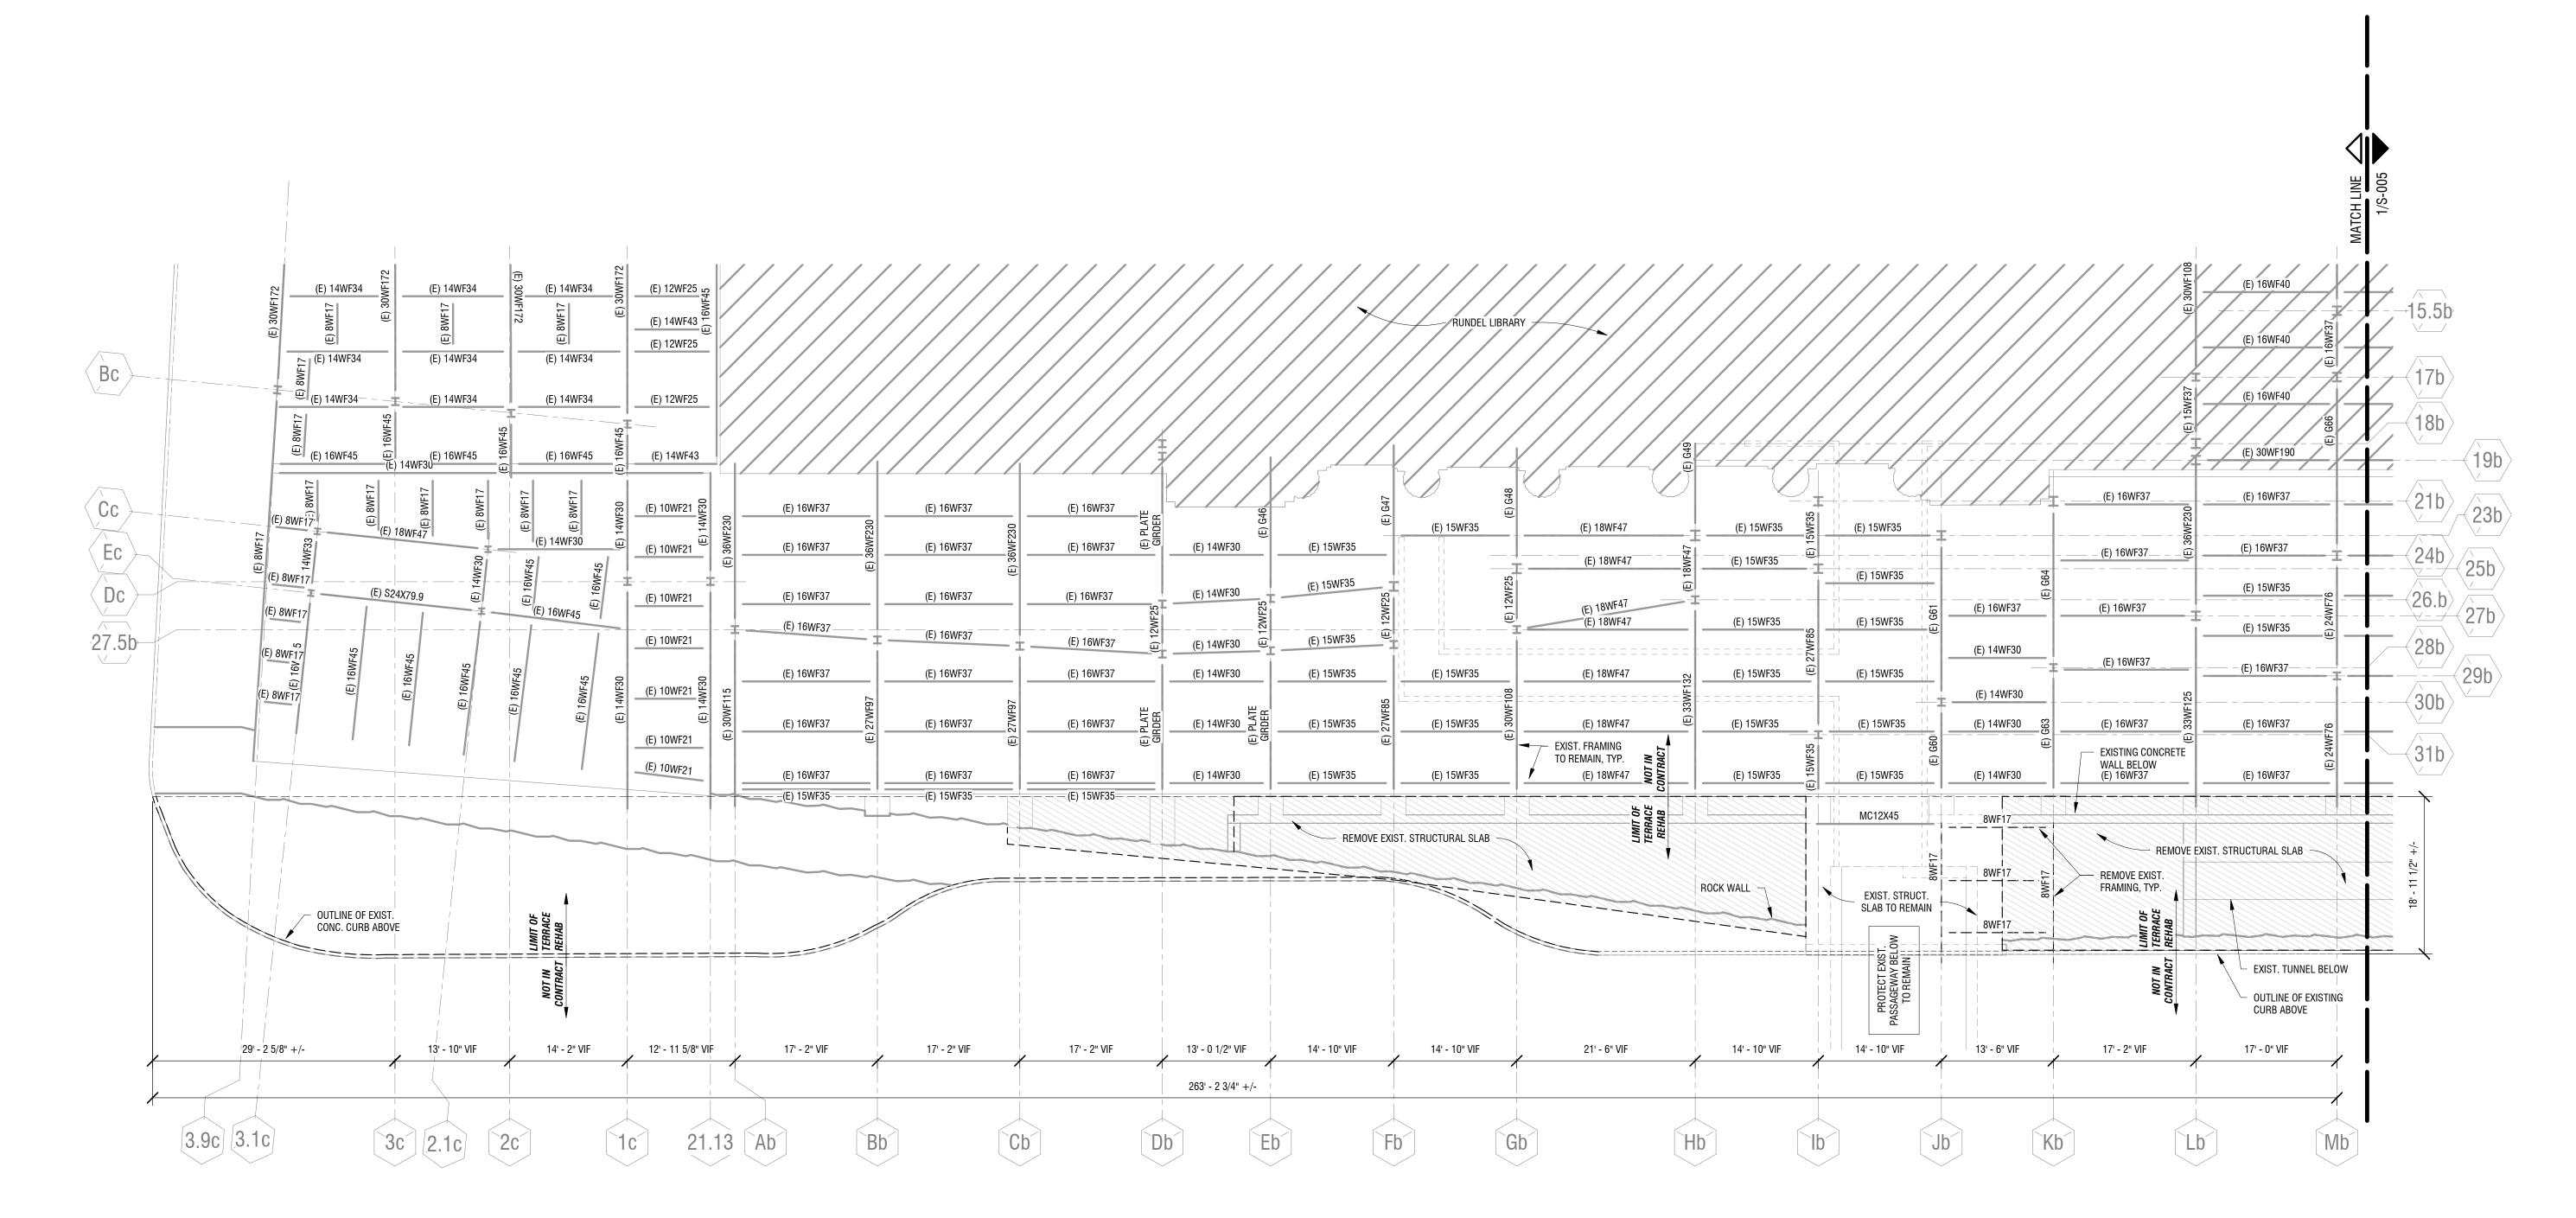
35% PRELIMINARY DESIGN

DRAWING NAME:

**—**Z

**EAST SIDEWALK DEMOLITION FRAMING** 

DRAWING NUMBER:



#### 1 EASTSIDE SIDEWALK DEMOLITION FRAMING PLAN

S-006 1" = 10'-0"

**DEMOLITION PLAN NOTES:** 

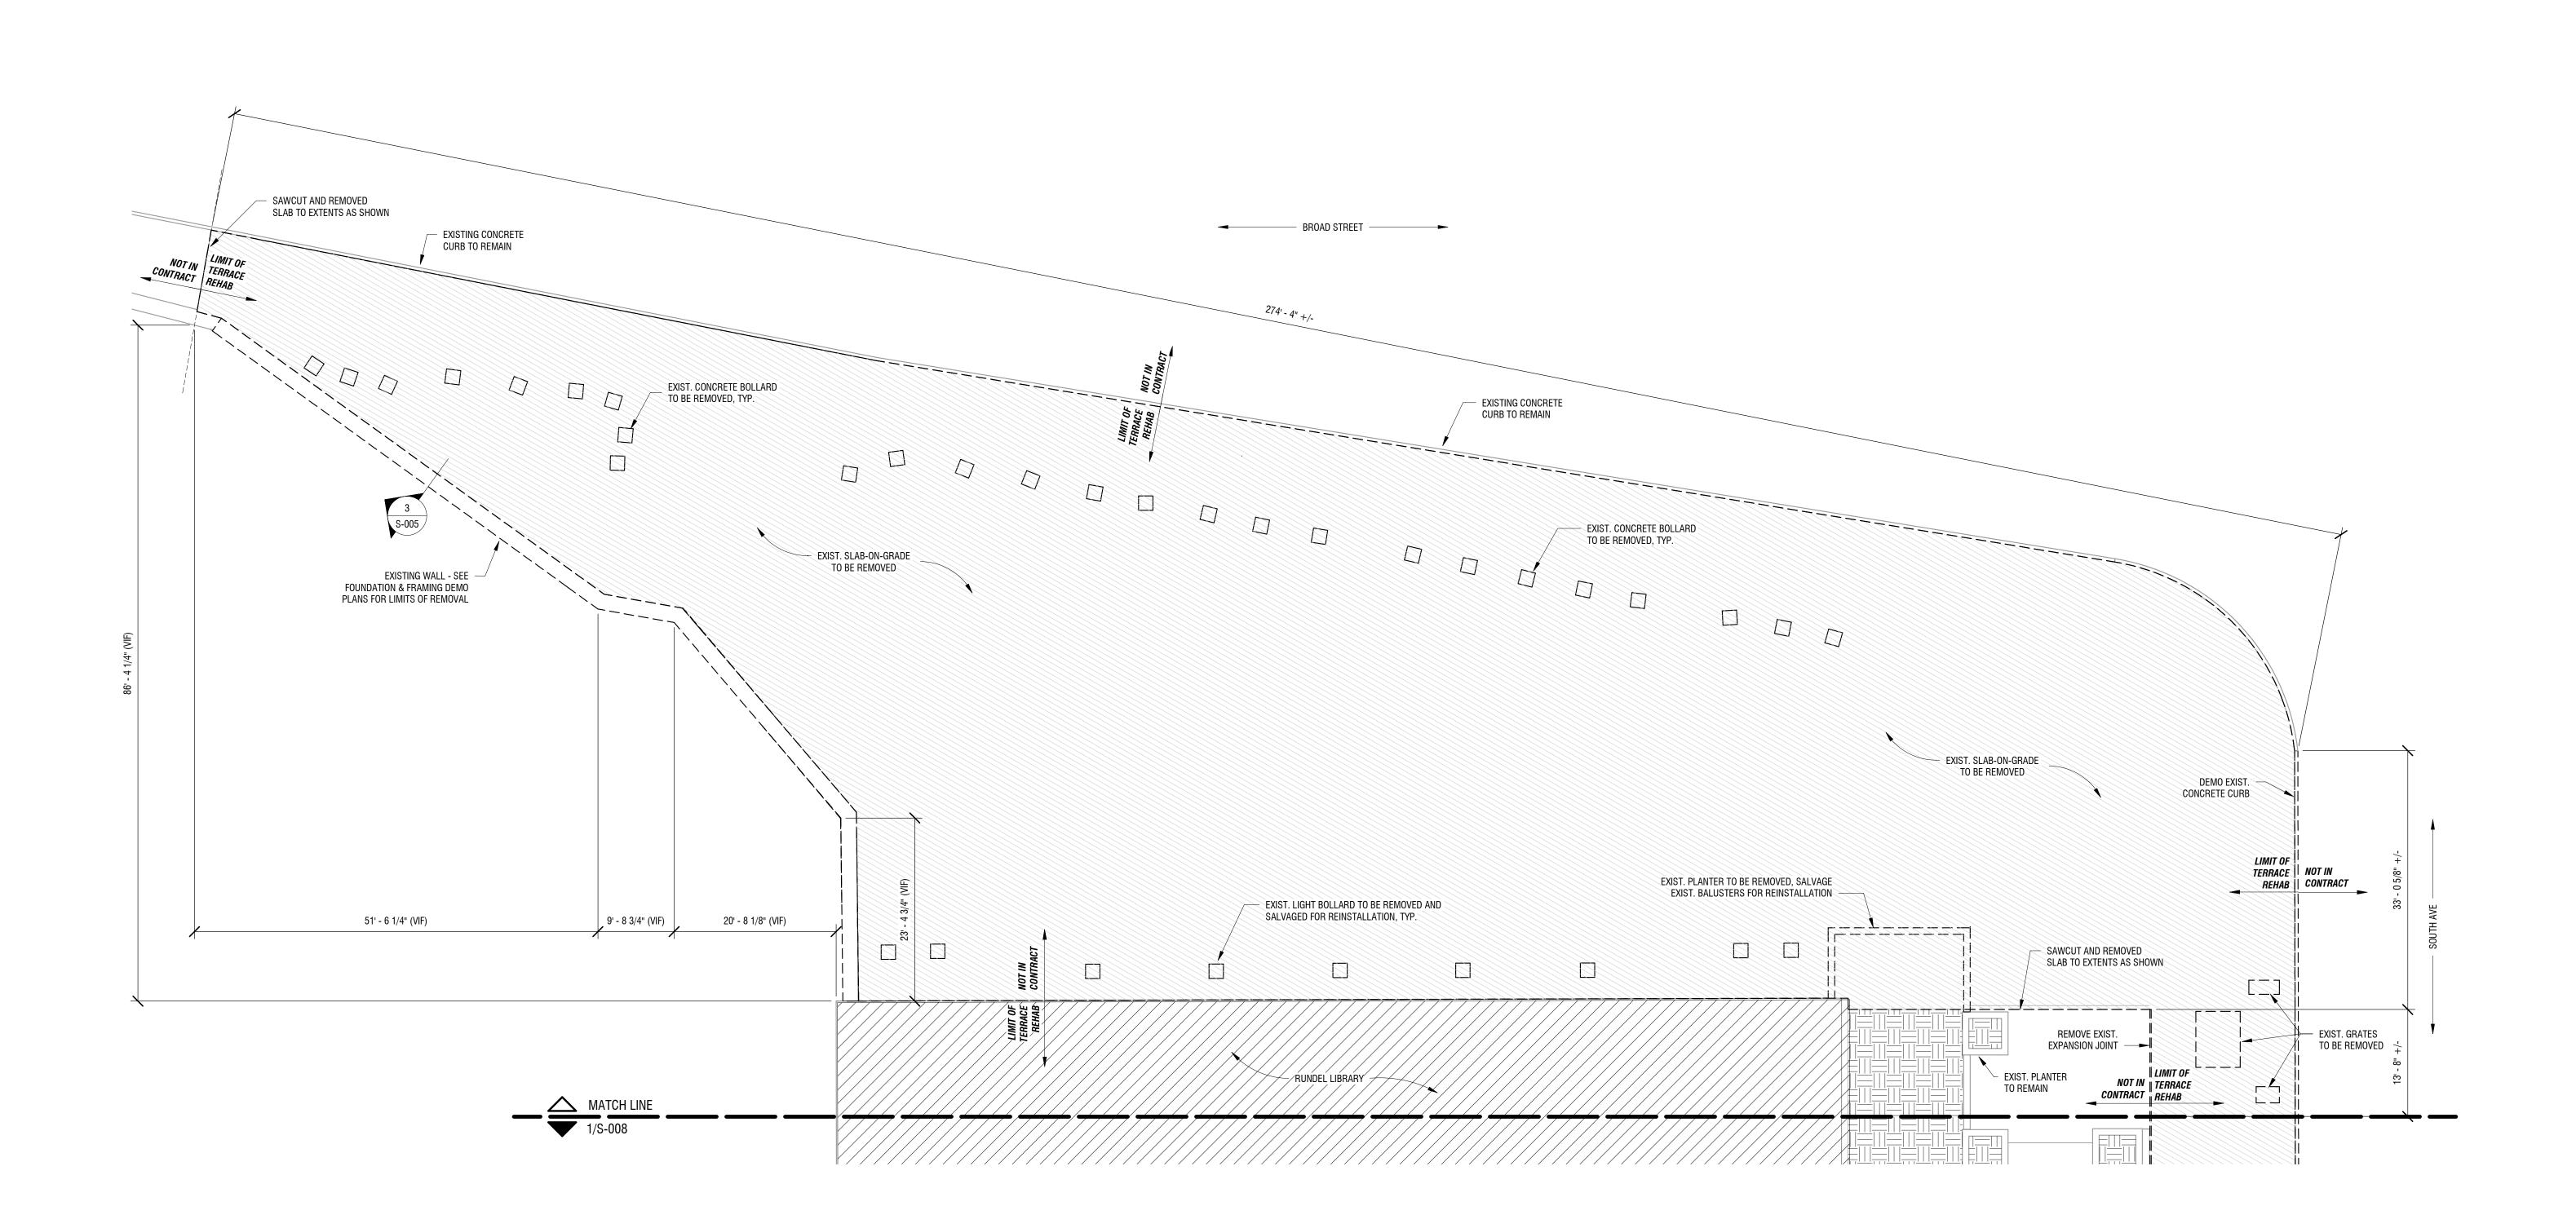
1. ALL DIMENSIONS AND FRAMING SIZES ARE ASSUMED BASED ON AVAILABLE EXISTING DRAWINGS AND LASER SCAN. DIMENSIONS AND SIZES SHALL BE FIELD VERIFIED BY CONTRACTOR.

2. COLUMN GRIDLINE NAMES ARE FOR REFERENCE ONLY AND ARE NOT REPRESENTATIVE OF EXISTING DRAWINGS. 3. NOTIFY E.O.R. OF ANY DISCREPENCIES BETWEEN DRAWINGS AND FIELD CONDITIONS.

4. NO ASBESTOS TESTING HAS BEEN PERFORMED ON EXISTING CONDITIONS.

5. COORDINATE WITH MEP FOR TEMPORARY SUPPORTS AND MEP REMOVALS.

DEMOLITION LEGEND — — — — TO BE DEMOLISHED EXISTING TO REMAIN



# NORTH TERRACE DEMOLITION SURFACE PLAN 1" = 10'-0"

1. ALL DIMENSIONS AND FRAMING SIZES ARE ASSUMED BASED ON AVAILABLE EXISTING DRAWINGS AND LASER SCAN. DIMENSIONS AND SIZES SHALL BE FIELD VERIFIED BY CONTRACTOR.

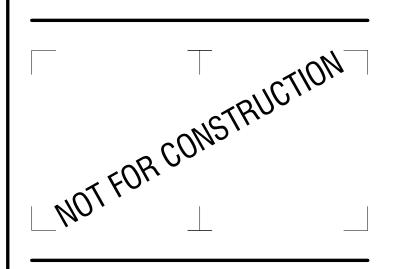
2. COLUMN GRIDLINE NAMES ARE FOR REFERENCE ONLY AND ARE NOT REPRESENTATIVE OF EXISTING DRAWINGS. 3. NOTIFY E.O.R. OF ANY DISCREPENCIES BETWEEN DRAWINGS AND FIELD CONDITIONS.

4. NO ASBESTOS TESTING HAS BEEN PERFORMED ON EXISTING CONDITIONS. 5. COORDINATE WITH MEP FOR TEMPORARY SUPPORTS AND MEP REMOVALS.

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**NORTH TERRACE SURFACE DEMOLITION PLAN** 

DRAWING NUMBER:

DRAWING NAME:

DEMOLITION LEGEND

— — — — TO BE DEMOLISHED

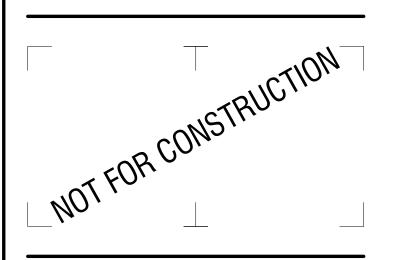
EXISTING TO REMAIN

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NO: DATE: DESCRIPTION:
Revisions

PROJECT NUMBER:

DRAWN BY: MML

REVIEWED BY: JMG

ISSUED FOR:

35% PRELIMINARY DESIGN

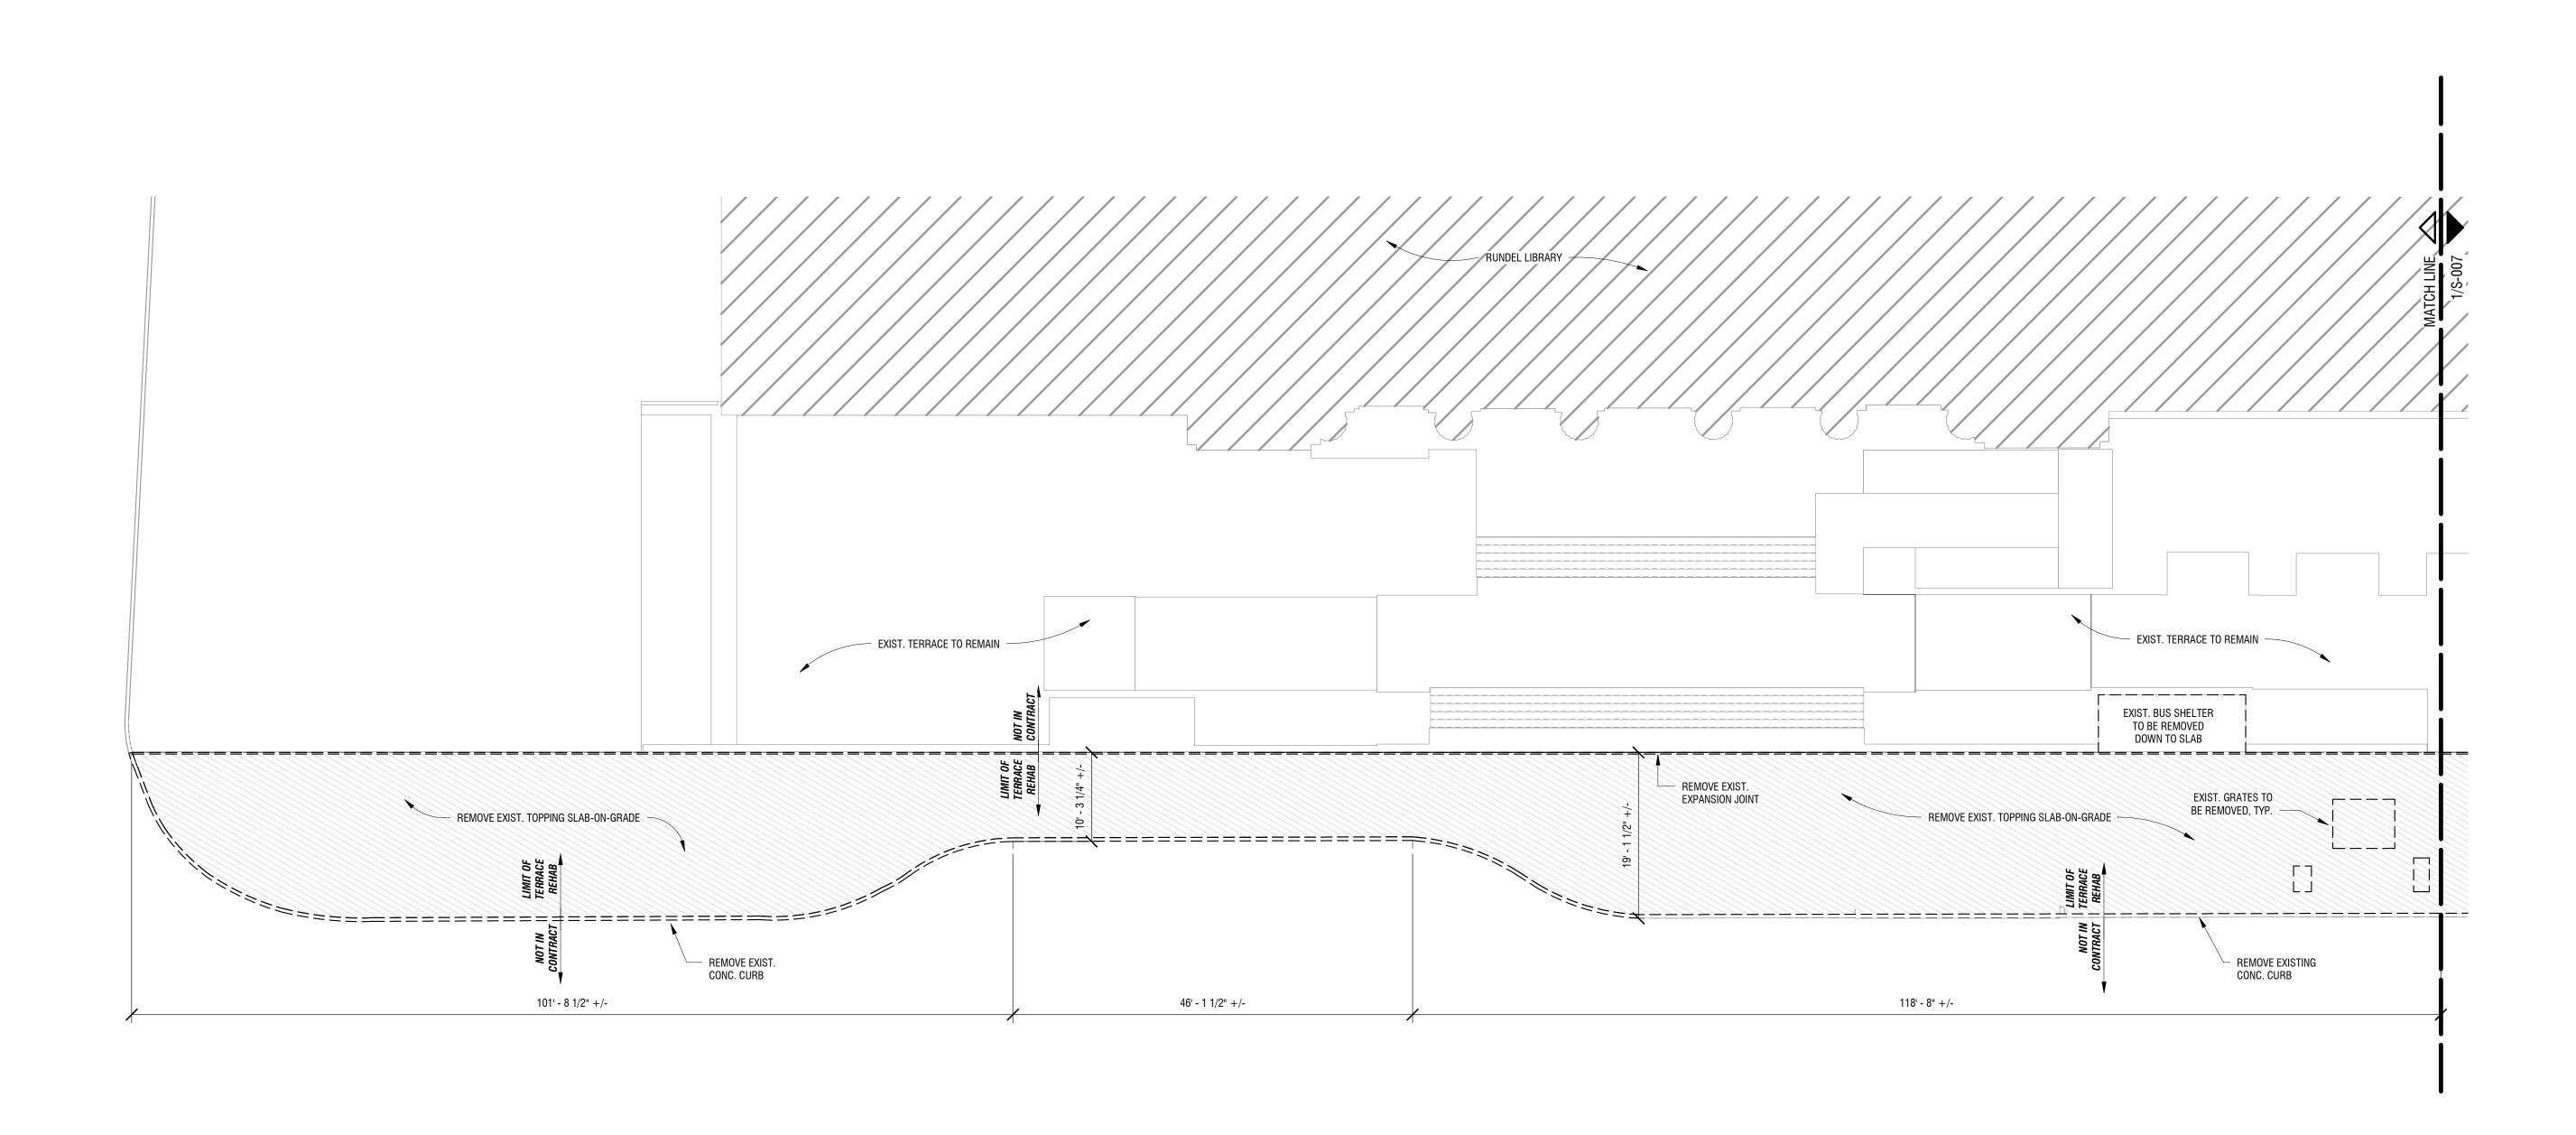
JULY 2018

DRAWING NAME:

EAST SIDEWALK SURFACE DEMOLITION PLAN

DRAWING NUMBER:

**S-008** 



### 1 EAST SIDEWALK SURFACE DEMOLITION PLAN

s-008 1" = 10'-0"

DEMOLITION PLAN NOTES:

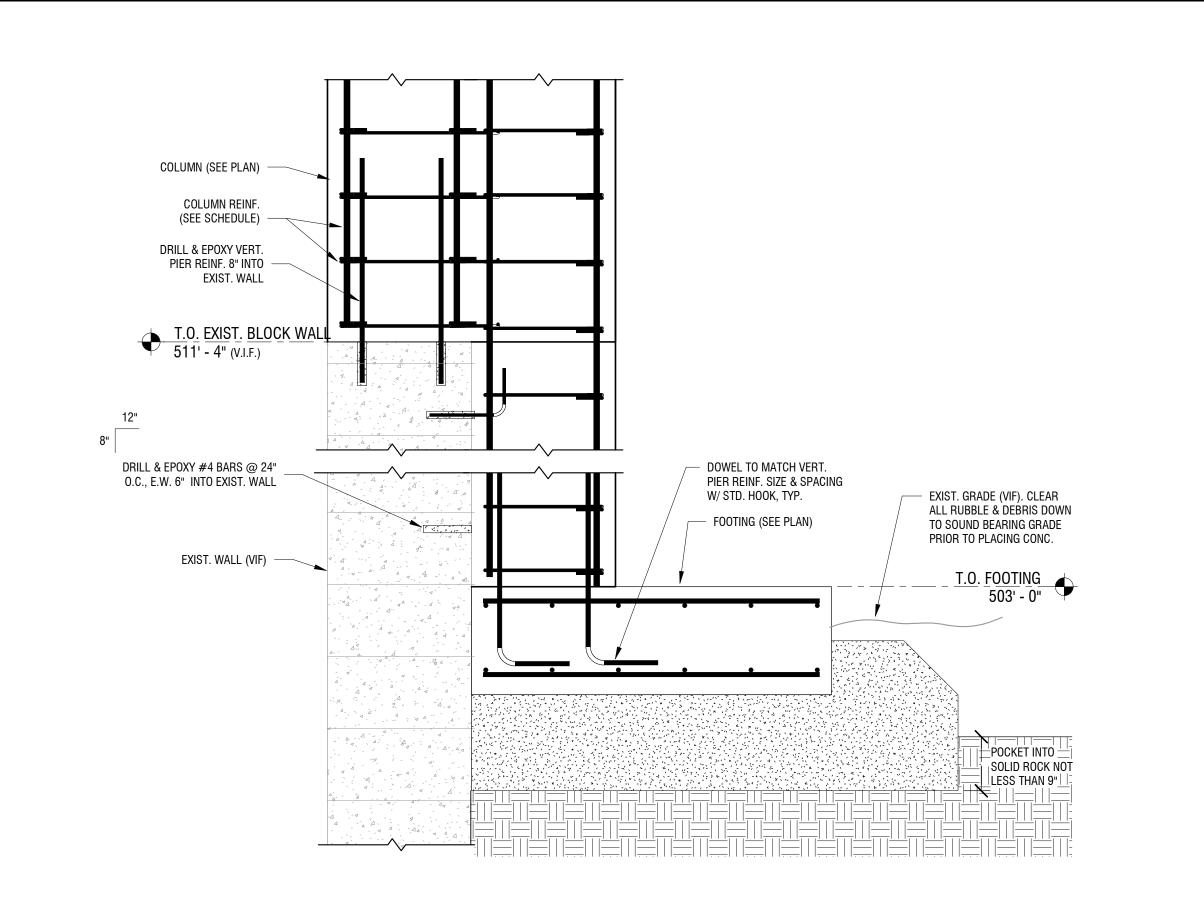
1. ALL DIMENSIONS AND FRAMING SIZES ARE ASSUMED BASED ON AVAILABLE EXISTING DRAWINGS AND LASER SCAN. DIMENSIONS AND SIZES SHALL BE FIELD VERIFIED BY CONTRACTOR.

COLUMN GRIDLINE NAMES ARE FOR REFERENCE ONLY AND ARE NOT REPRESENTATIVE OF EXISTING DRAWINGS.
 NOTIFY E.O.R. OF ANY DISCREPENCIES BETWEEN DRAWINGS AND FIELD CONDITIONS.

4. NO ASBESTOS TESTING HAS BEEN PERFORMED ON EXISTING CONDITIONS.

5. COORDINATE WITH MEP FOR TEMPORARY SUPPORTS AND MEP REMOVALS.

28:06 PM



FOUNDATION SECTION AT EXIST. RIVERWALL

FOUNDATION LEGEND

F# - INDICATES COLUMN FOOTING TYPE (SEE FOOTING SCHEDULE) [-#' - #"] - BELOW COLUMN FOOTING TYPE INDICATES TOP OF FOOTING ELEVATION CC# - INDICATES CONCRETE COLUMN TYPE (SEE COLUMN SCHEDULE) ## - INDICATES WALL TYPE (SEE FOUNDATION WALL &/OR WALL SCHEDULE) WF# WF# - INDICATES WALL FOOTING TYPE (SEE WALL FOOTING SCHEDULE)

#'-#"

#'-#" - BOTTOM OF FOOTING ELEV. FOR WALL FOOTING W/ RESPECT TO DATUM ELEVATION = 0' - 0". TOP OF WALL ELEVATION





PHOTO LOCATION A: WALL REPAIR - EXISTING CONDITIONS

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alteration.

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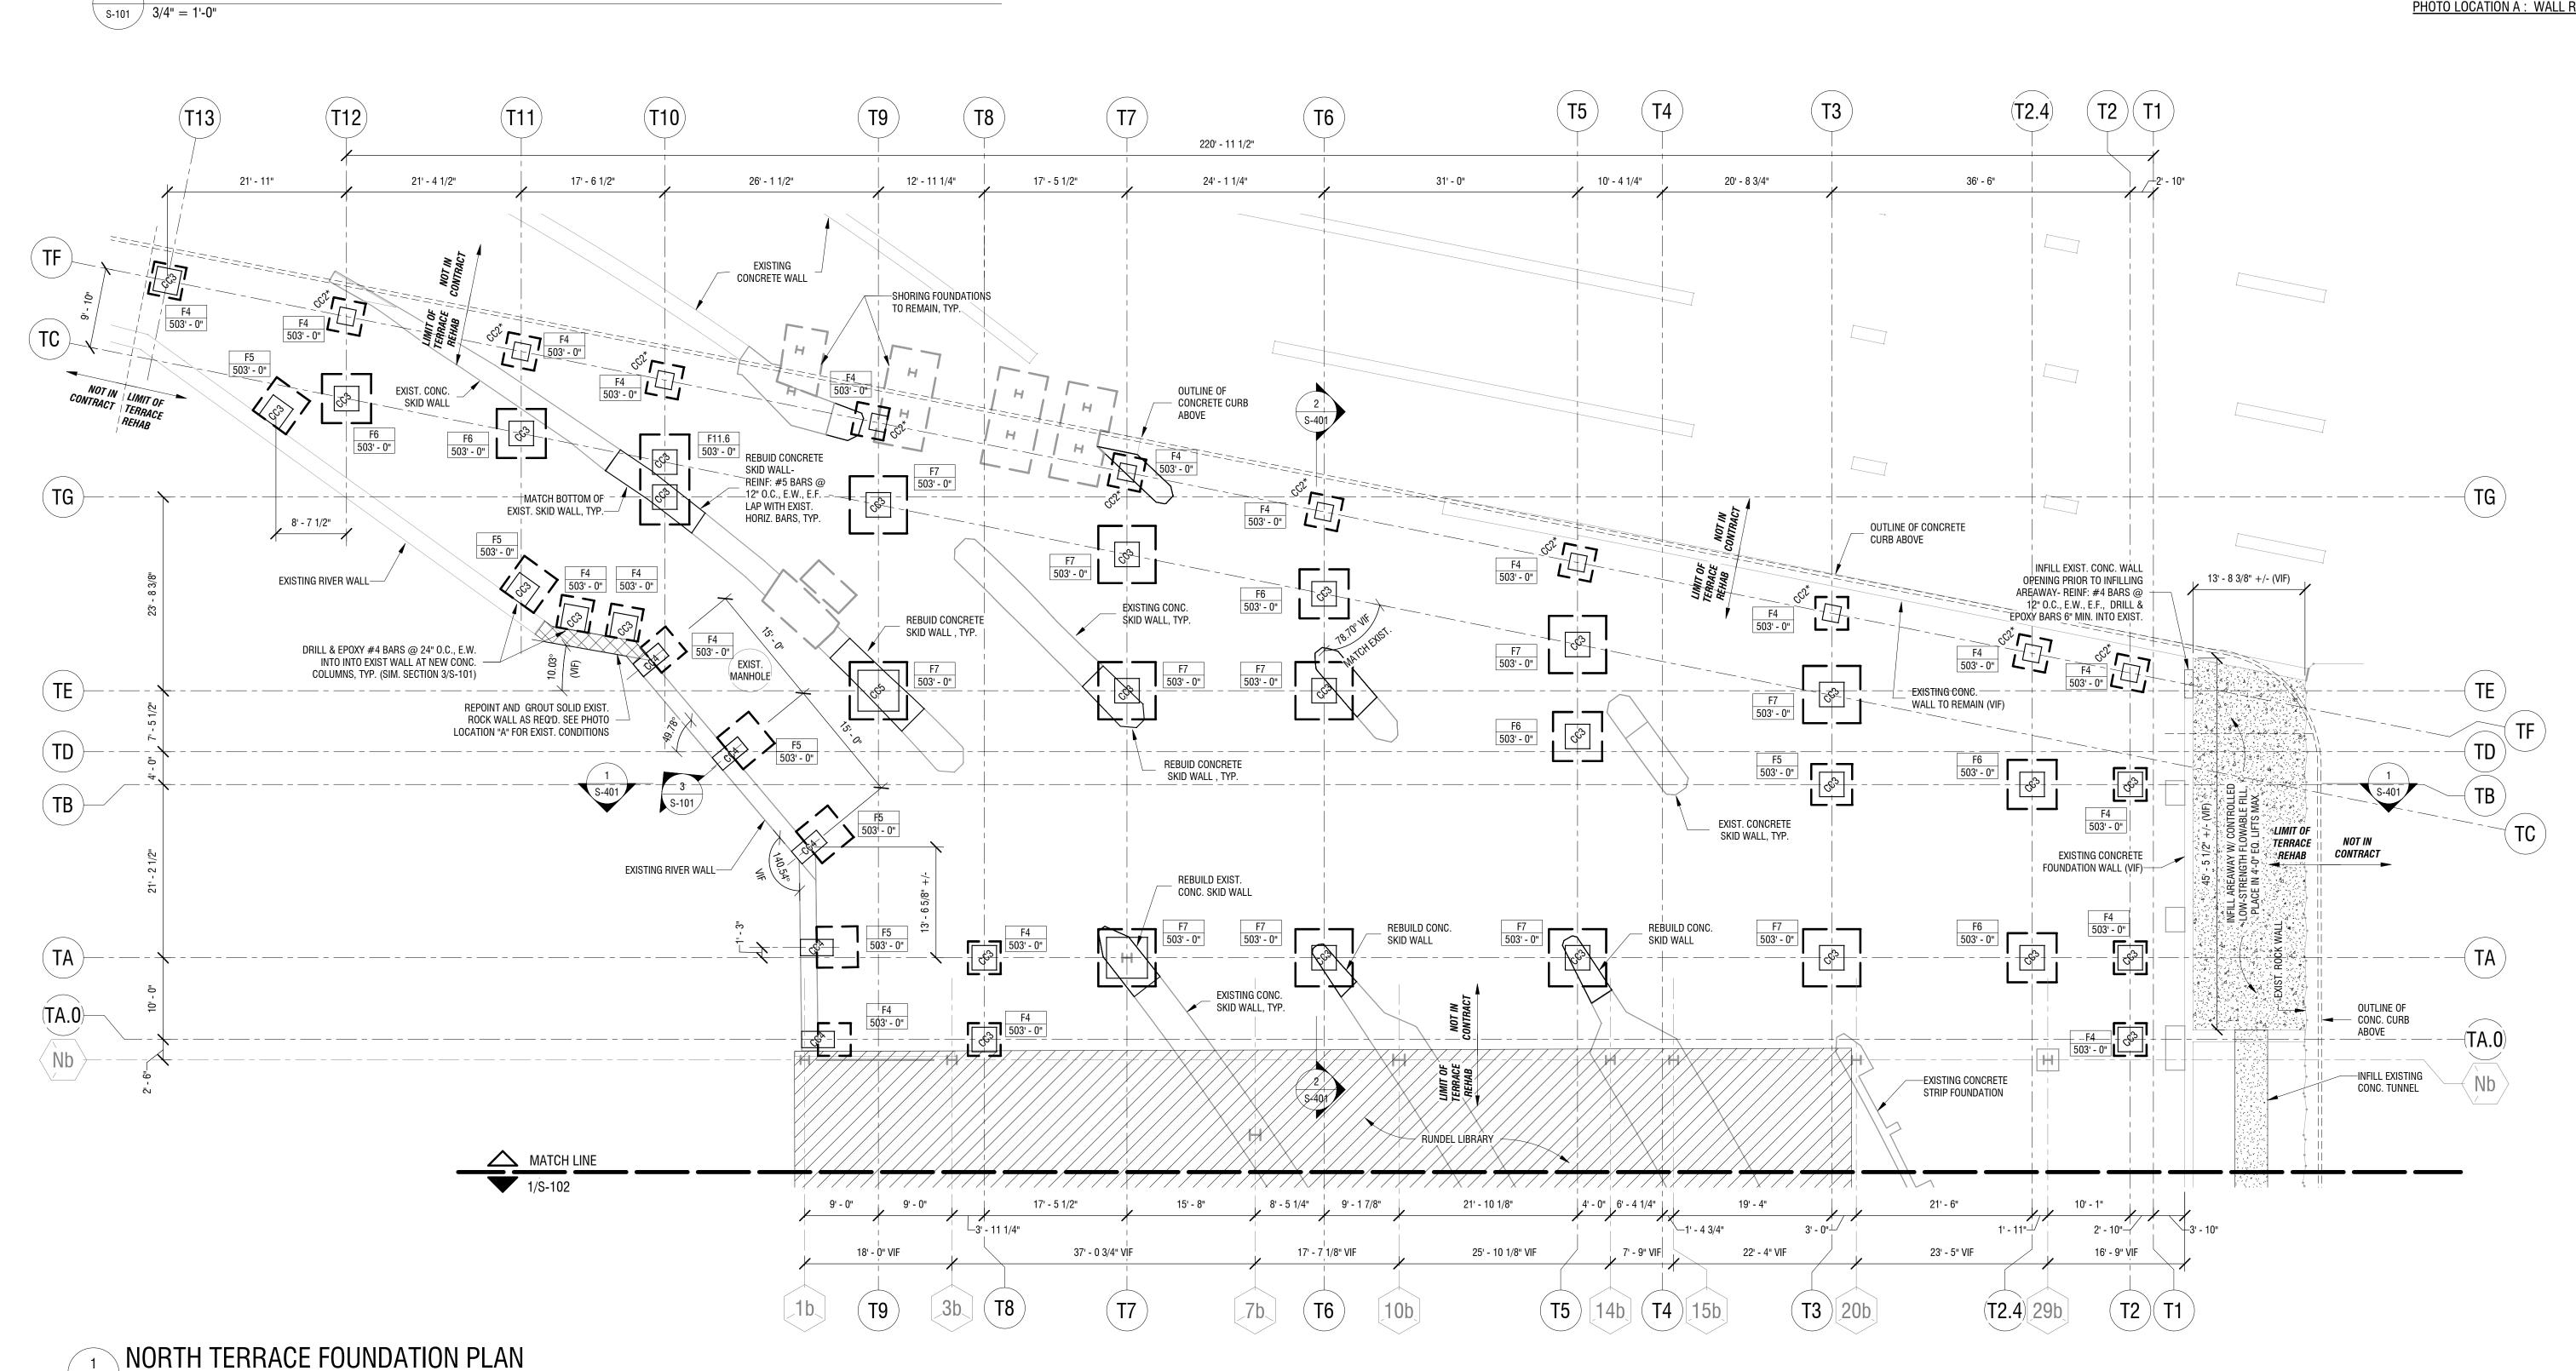
ROCHESTER, NY 14604

PROJECT NUMBER: 2170391 35% PRELIMINARY DESIGN

> **NORTH TERRACE FOUNDATION PLAN**

DRAWING NUMBER:

DRAWING NAME:

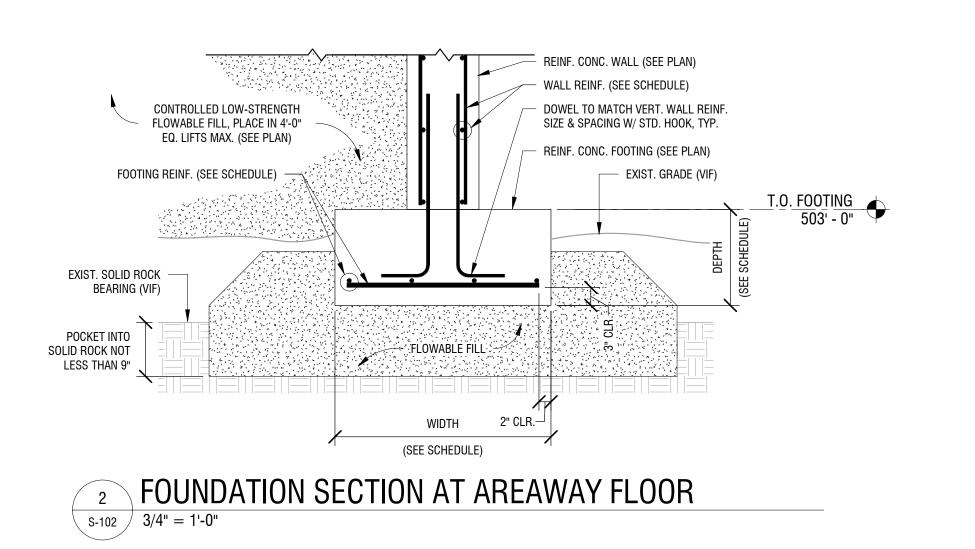


s-101 1" = 10'-0"

FOUNDATION PLAN NOTES: 1. EXISTING GRADE EQUALS FINISHED GRADE, EXISTING GRADE VARIES (VIF). TOP OF FOOTING ELEVATION AT 503' - 0", U.N.O.

2. ALL COLUMNS SHALL BE 18'-0" FROM B.O.CONCRETE BEAMS TO T.O.FOOTING. POCKET FOOTINGS INTO ROCK 9", MINIMUM, PER TYPICAL DETAILS. ELSE, INSTALL CONTROLLED LOW-STRENGTH MATERIAL (FLOWABLE FILL) FROM T.O.ROCK TO UNDERSIDE OF FOOTING. POCKET FOOTING 9" INTO FLOWABLE FILL PER TYPICAL DETAILS.

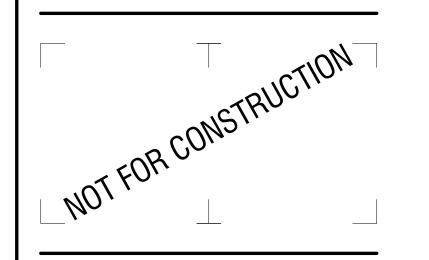
3. CENTER ISOLATED FOOTINGS UNDER COLUMNS AND/OR AT COLUMN LINE INTERSECTIONS. U.O.N.. 4. DO NOT SCALE DRAWINGS. SEE LANDSCAPE ARCHITECTURAL FLOOR PLANS FOR DIMENSIONS NOT INDICATED ON STRUCTURAL DRAWINGS. 5. SECTIONS INDICATED ON PLAN ARE TYPICAL FOR SIMILAR CONDITIONS.



FOL	JNDATION LEG	GEND
1.	F# -#' - #"	F# - INDICATES COLUMN FOOTING TYPE (SEE FOOTING SCHEDULE) [-#' - #"] - BELOW COLUMN FOOTING TYPE INDICATES TOP OF FOOTING ELEVATIO
2.	CC#	CC# - INDICATES CONCRETE COLUMN TYPE (SEE COLUMN SCHEDULE)
3.	W#	## - INDICATES WALL TYPE (SEE FOUNDATION WALL &/OR WALL SCHEDULE)
4.	WF#	WF# - INDICATES WALL FOOTING TYPE (SEE WALL FOOTING SCHEDULE)
5.	#1-#11	#'- $#''$ - BOTTOM OF FOOTING ELEV. FOR WALL FOOTING W/ RESPECT TO DATUM ELEVATION = 0' - 0".
6.	[##'-##"]	TOP OF WALL ELEVATION

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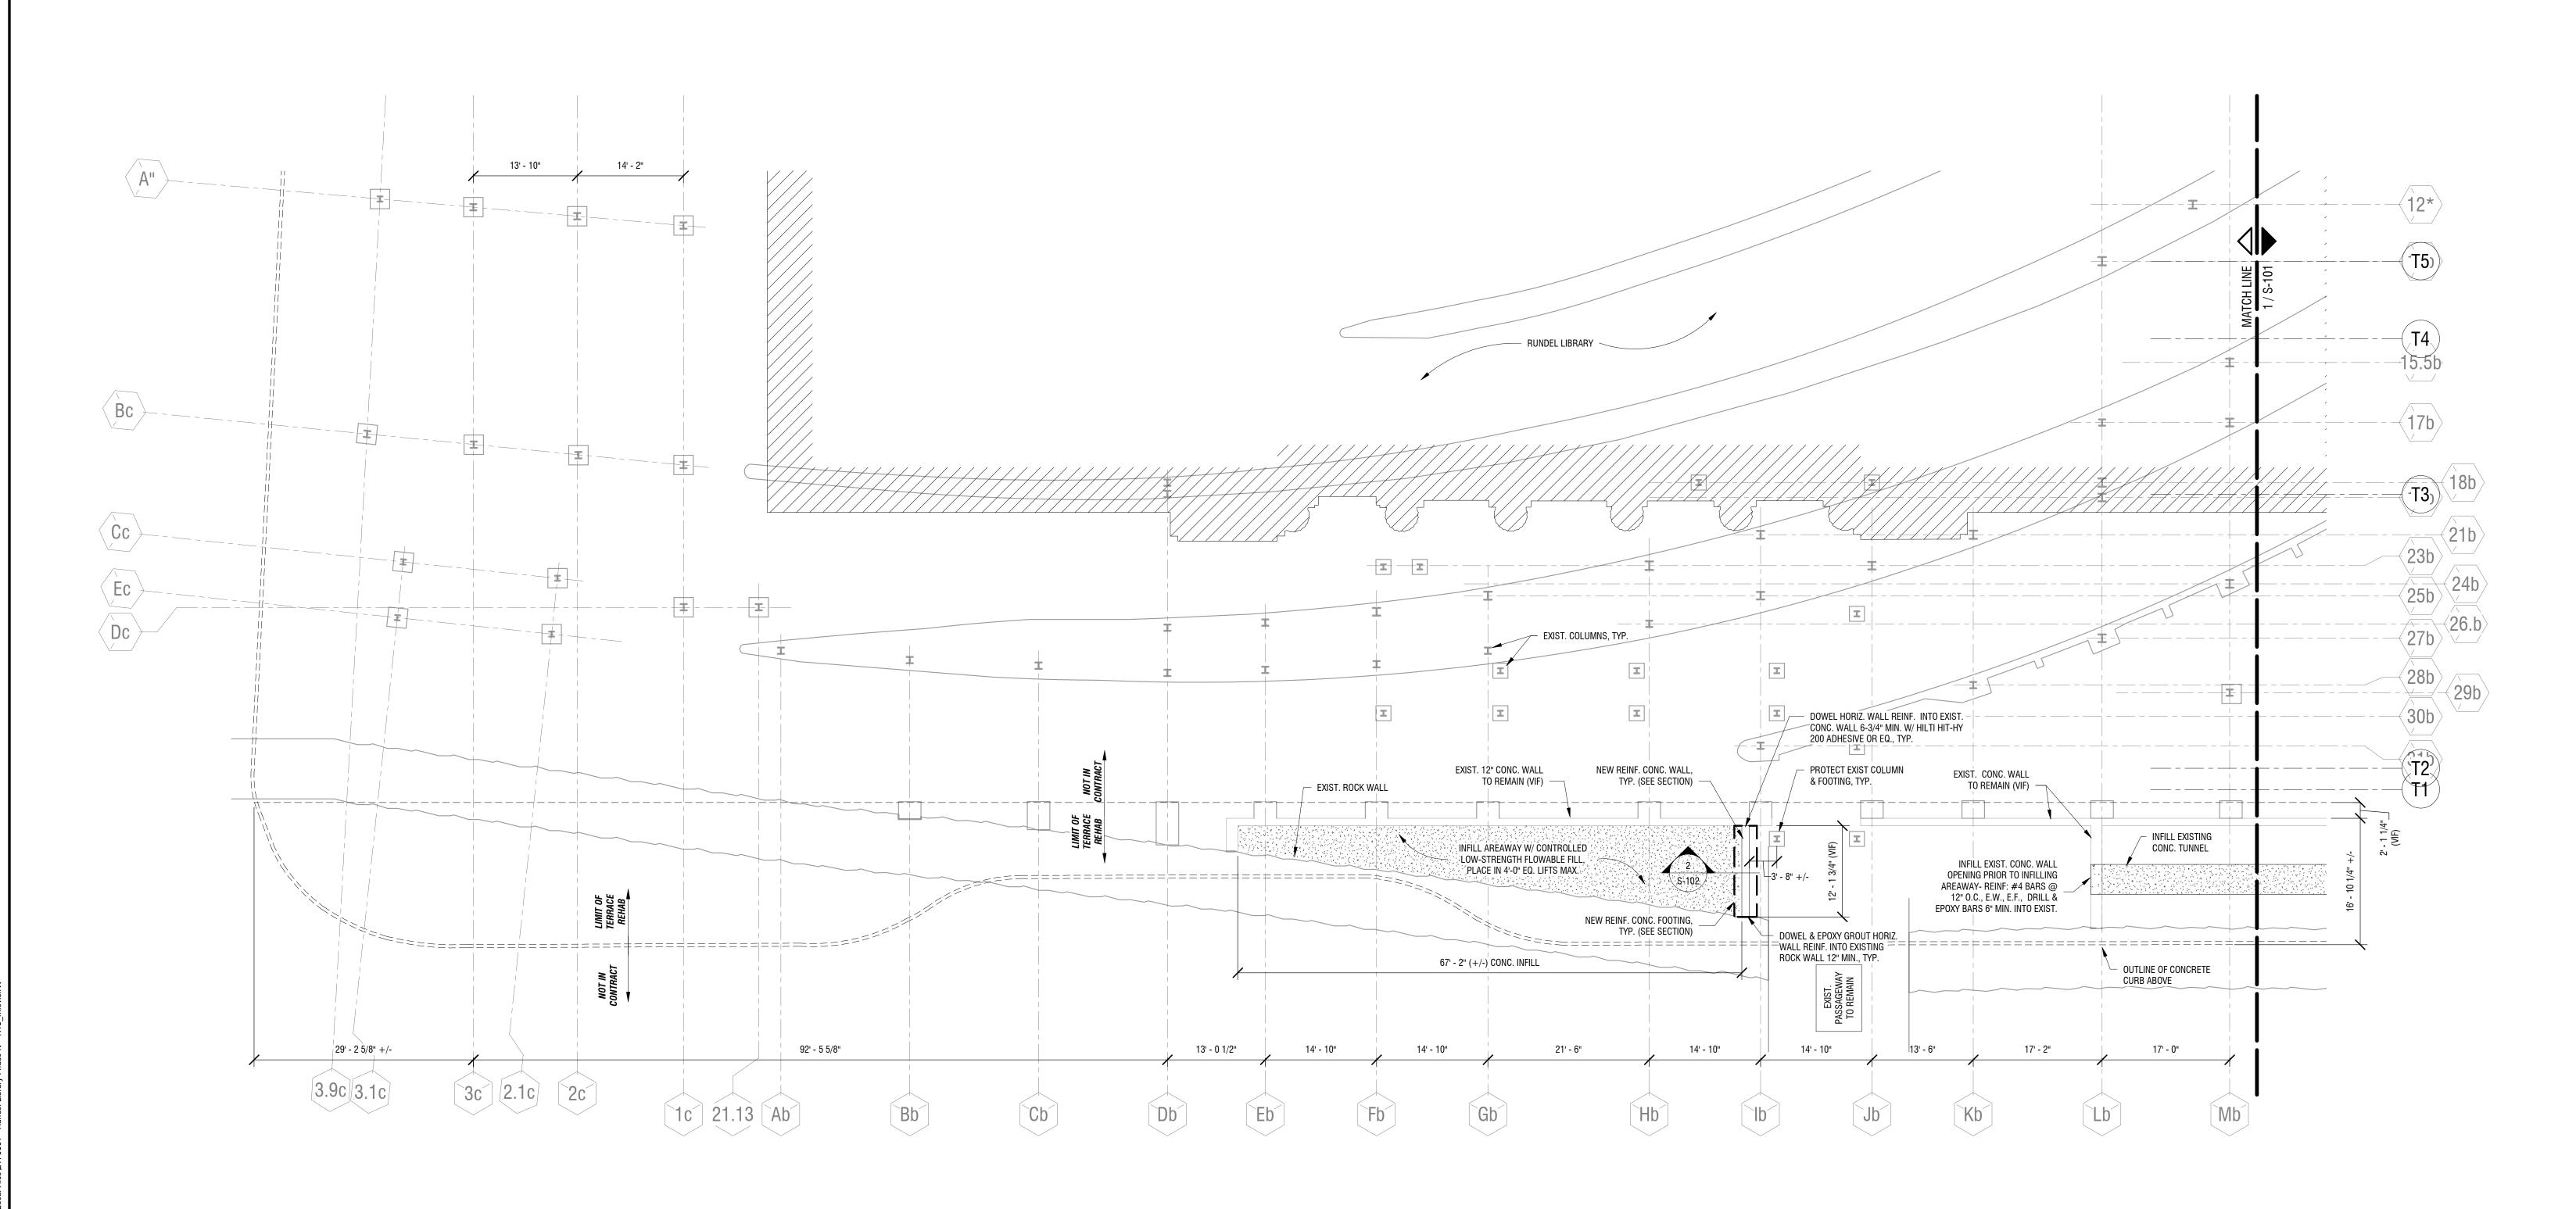
PROJECT NUMBER: REVIEWED BY:

35% PRELIMINARY DESIGN

DRAWING NAME:

**EASTSIDE SIDEWALK** FOUNDATION PLAN & **AREAWAY INFILL PLAN** 

DRAWING NUMBER:



#### 1 EASTSIDE SIDEWALK FOUNDATION PLAN & AREAWAY INFILL PLAN

S-102 1" = 10'-0"

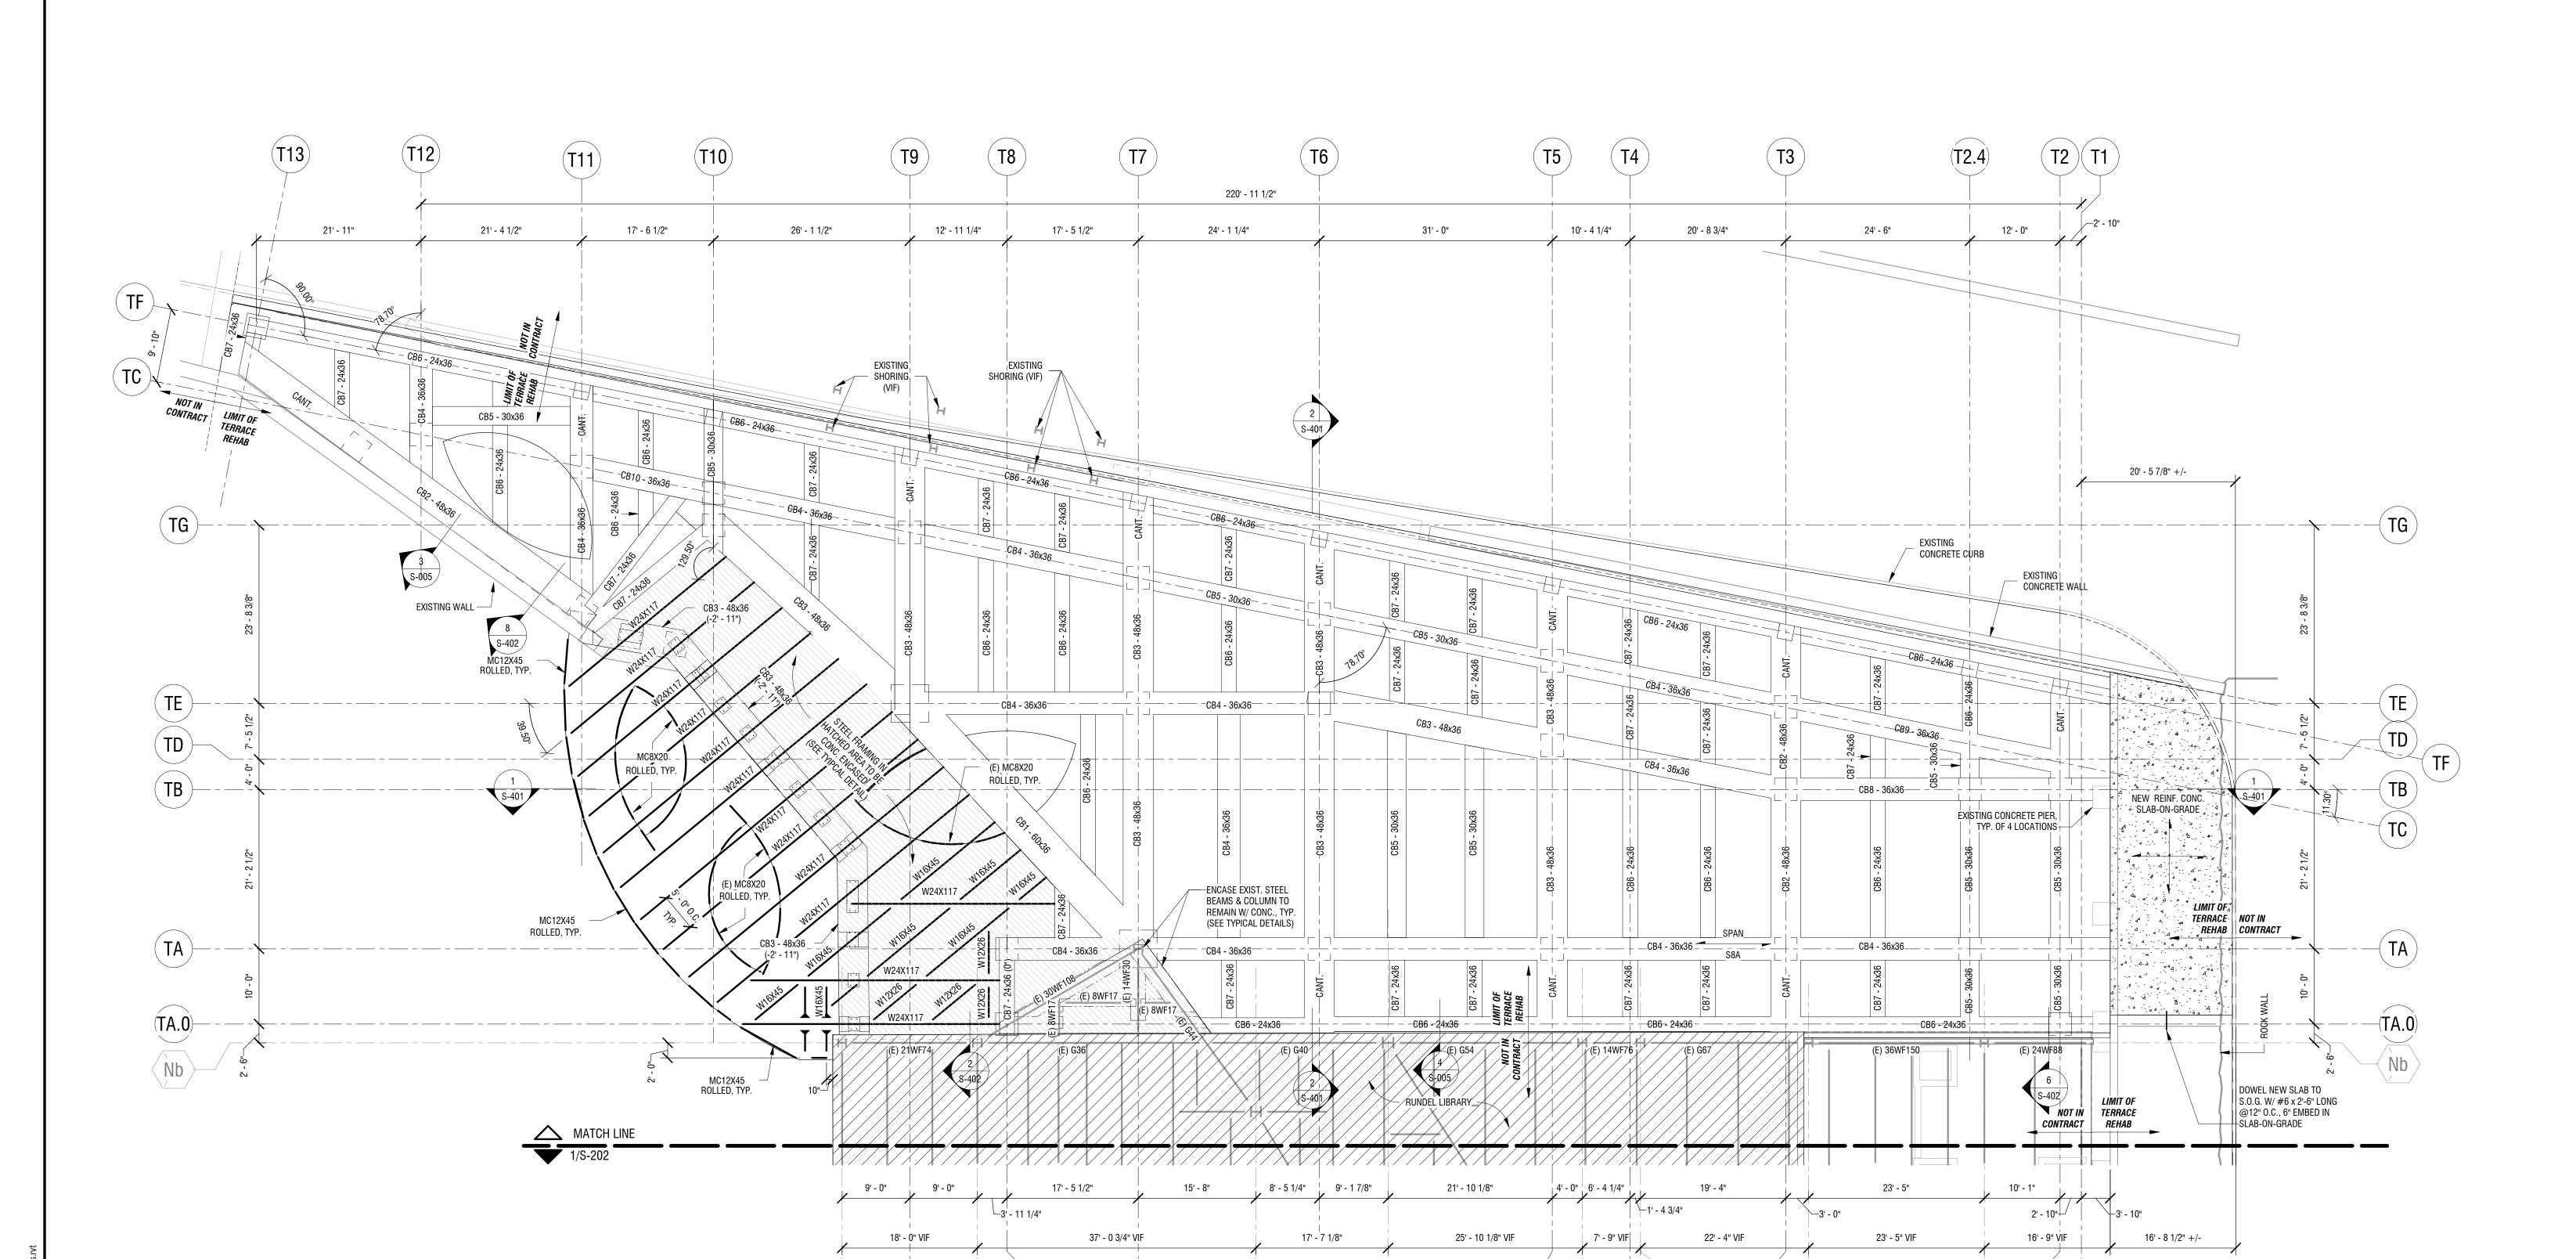
FOUNDATION PLAN NOTES:

1. EXISTING GRADE EQUALS FINISHED GRADE, EXISTING GRADE VARIES (VIF). TOP OF FOOTING ELEVATION AT 503' - 0", U.N.O.

2. ALL COLUMNS SHALL BE 18'-0" FROM B.O.CONCRETE BEAMS TO T.O.FOOTING. POCKET FOOTINGS INTO ROCK 9", MINIMUM, PER TYPICAL DETAILS. ELSE, INSTALL CONTROLLED

LOW-STRENGTH MATERIAL (FLOWABLE FILL) FROM T.O.ROCK TO UNDERSIDE OF FOOTING. POCKET FOOTING 9" INTO FLOWABLE FILL PER TYPICAL DETAILS. 3. CENTER ISOLATED FOOTINGS UNDER COLUMNS AND/OR AT COLUMN LINE INTERSECTIONS. U.O.N...

4. DO NOT SCALE DRAWINGS. SEE LANDSCAPE ARCHITECTURAL FLOOR PLANS FOR DIMENSIONS NOT INDICATED ON STRUCTURAL DRAWINGS. 5. SECTIONS INDICATED ON PLAN ARE TYPICAL FOR SIMILAR CONDITIONS.



#### NORTH TERRACE FRAMING PLAN

S-201 1" = 10'-0"

NORTH TERRACE FRAMING PLAN NOTES:

1. TOP OF CONCRETE BEAM ELEVATIONS SHALL BE (+524' - 0") AND TOP OF STEEL BEAM ELEVATIONS SHALL BE (+523' - 4"), FLOOR DATUM

ELEV. (0' - 0"). DEVIATIONS FROM THIS ELEVATION ARE NOTED ON PLAN.
2. SEE M.E.P. DRAWINGS FOR THE BALANCE OF ALL EQUIPMENT, FLOOR PENETRATIONS, ETC. REQUIRED AT THIS LEVEL.

DO NOT SCALE DRAWINGS. SEE LANDSCAPE ARCHITECTURAL PLANS FOR DIMENSIONS NOT INDICATED ON STRUCTURAL DRAWINGS.
 SECTIONS INDICATED ON PLAN ARE TYPICAL FOR SIMILAR CONDITIONS.
 SEE COLUMN, BEAM, AND STRUCTURAL SLAB WITH TYPICAL DETAILS ON S-001.

6. HOLD
7. BALANCE OF SLAB REINF. FOR REENTRANT CORNERS AND OPENINGS NOT SHOWN FOR CLARITY. SEE TYPICAL DETAILS.

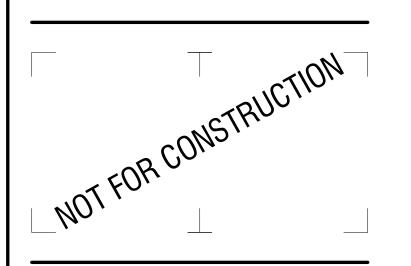
8. DO NOT PLACE CONTROL JOINTS IN STRUCTURAL SLABS.

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NO: DATE: DESCRIPTION:
Revisions

PROJECT NUMBER:

2170391

DRAWN BY: MML
REVIEWED BY: JMG

ISSUED FOR:
35% PRELIMINARY DESIGN

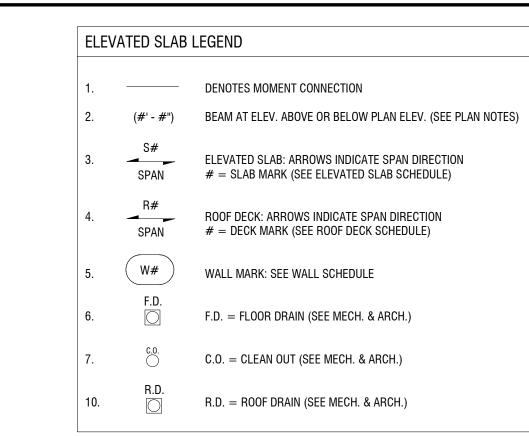
DRAWING NAME:

DRAWING NAME:

NORTH TERRACE FRAMING PLAN

DRAWING NUMBER:

**S-20**1

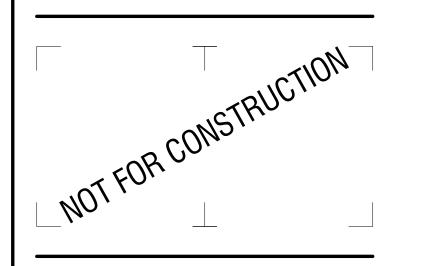


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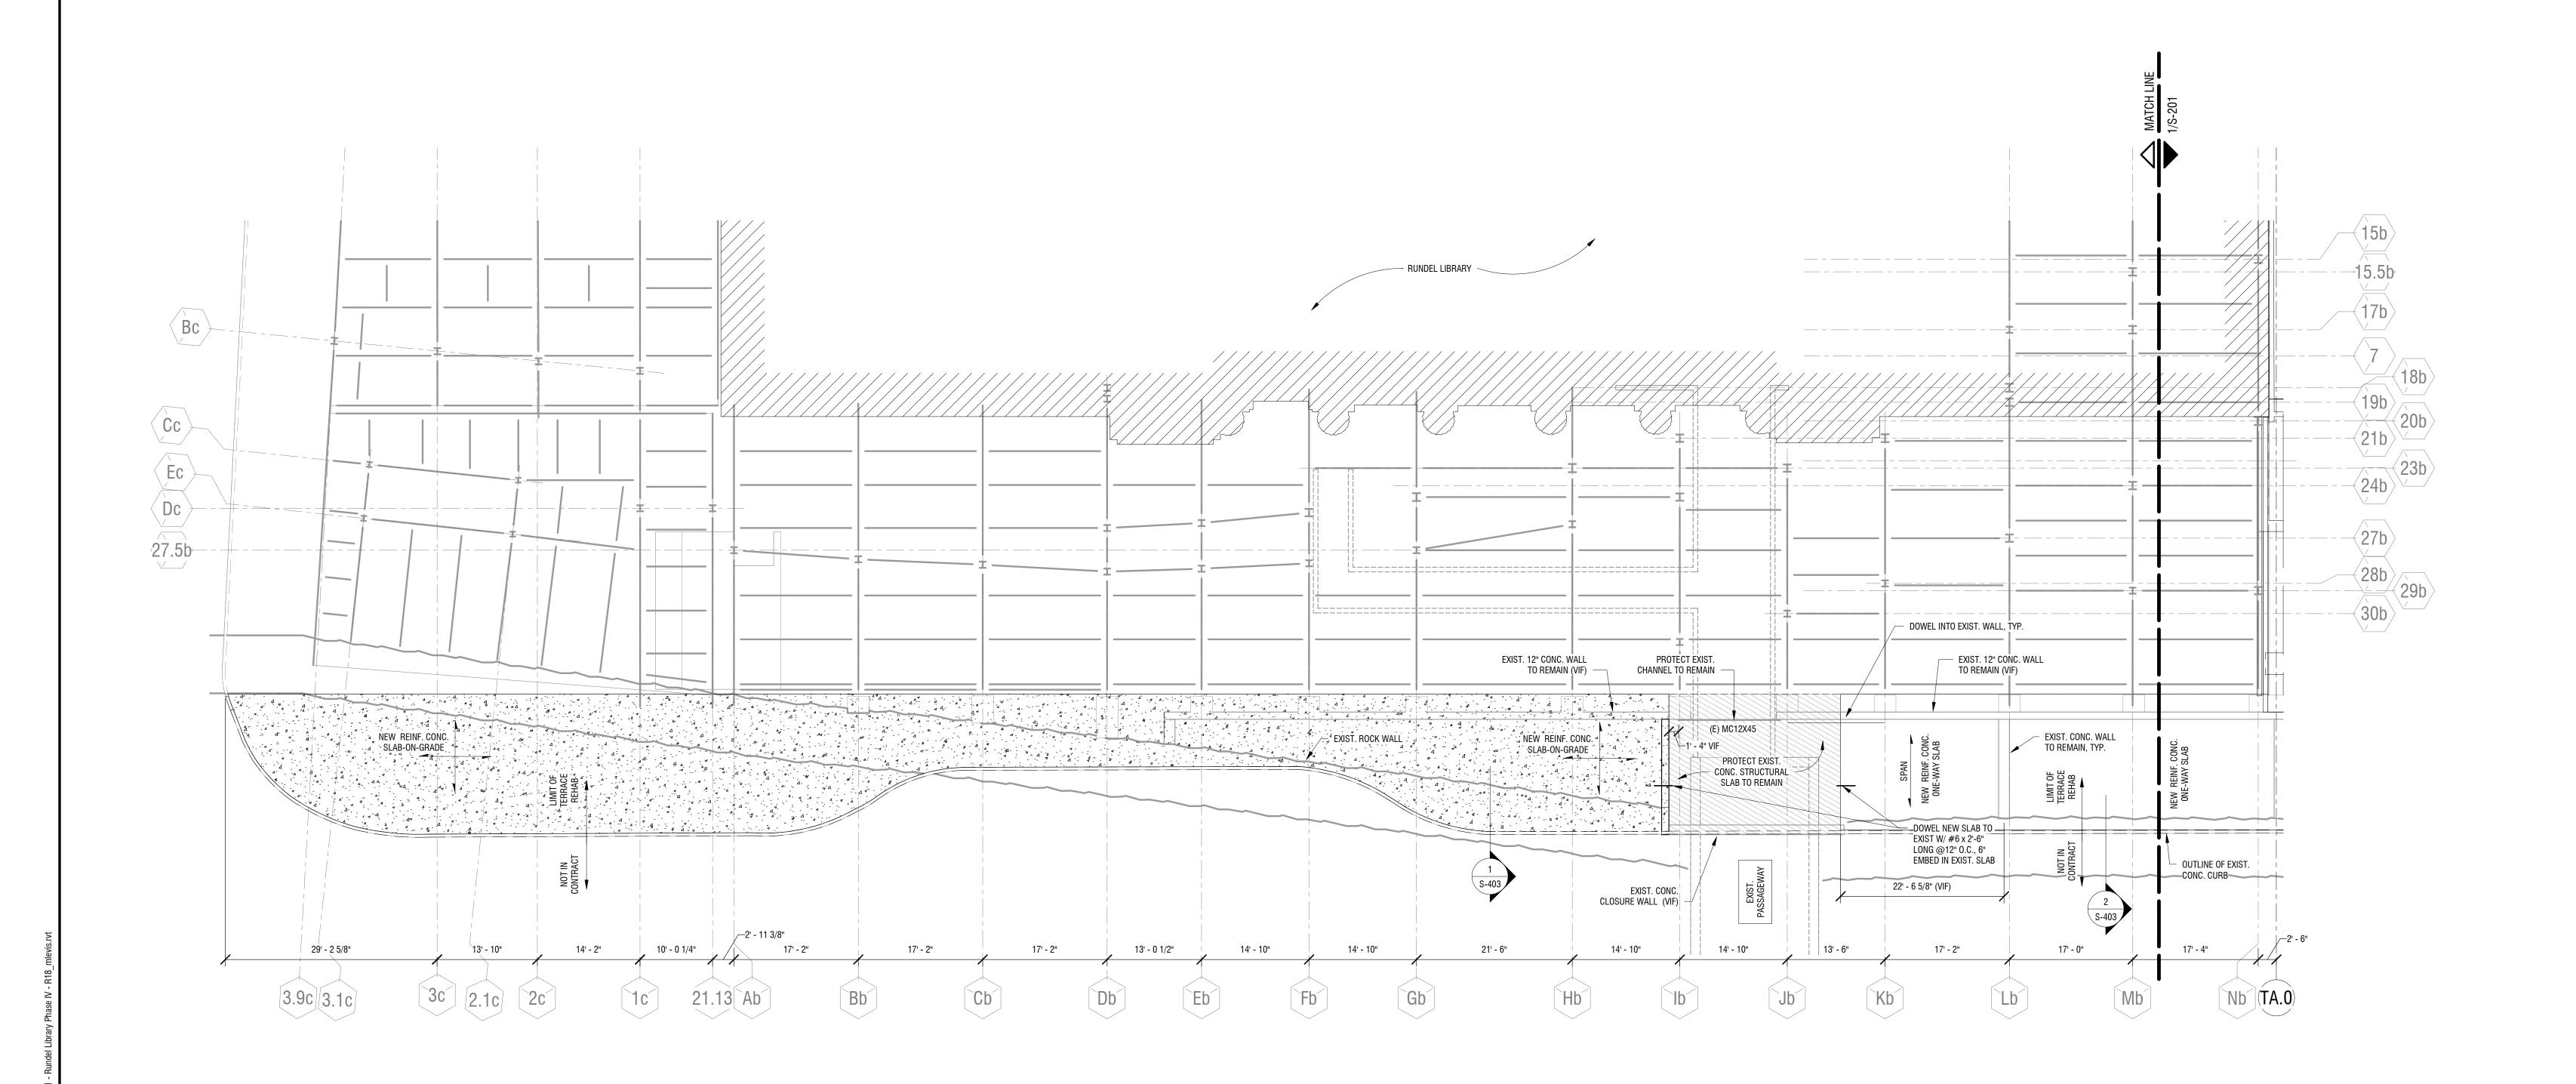
ATE:
JULY 2018

DRAWING NAME:

EAST SIDEWALK FRAMING

DRAWING NUMBER:

**S-202** 



1 EAST SIDEWALK FRAMING PLAN

7. SECTIONS INDICATED ON PLAN ARE TYPICAL FOR SIMILAR CONDITIONS.

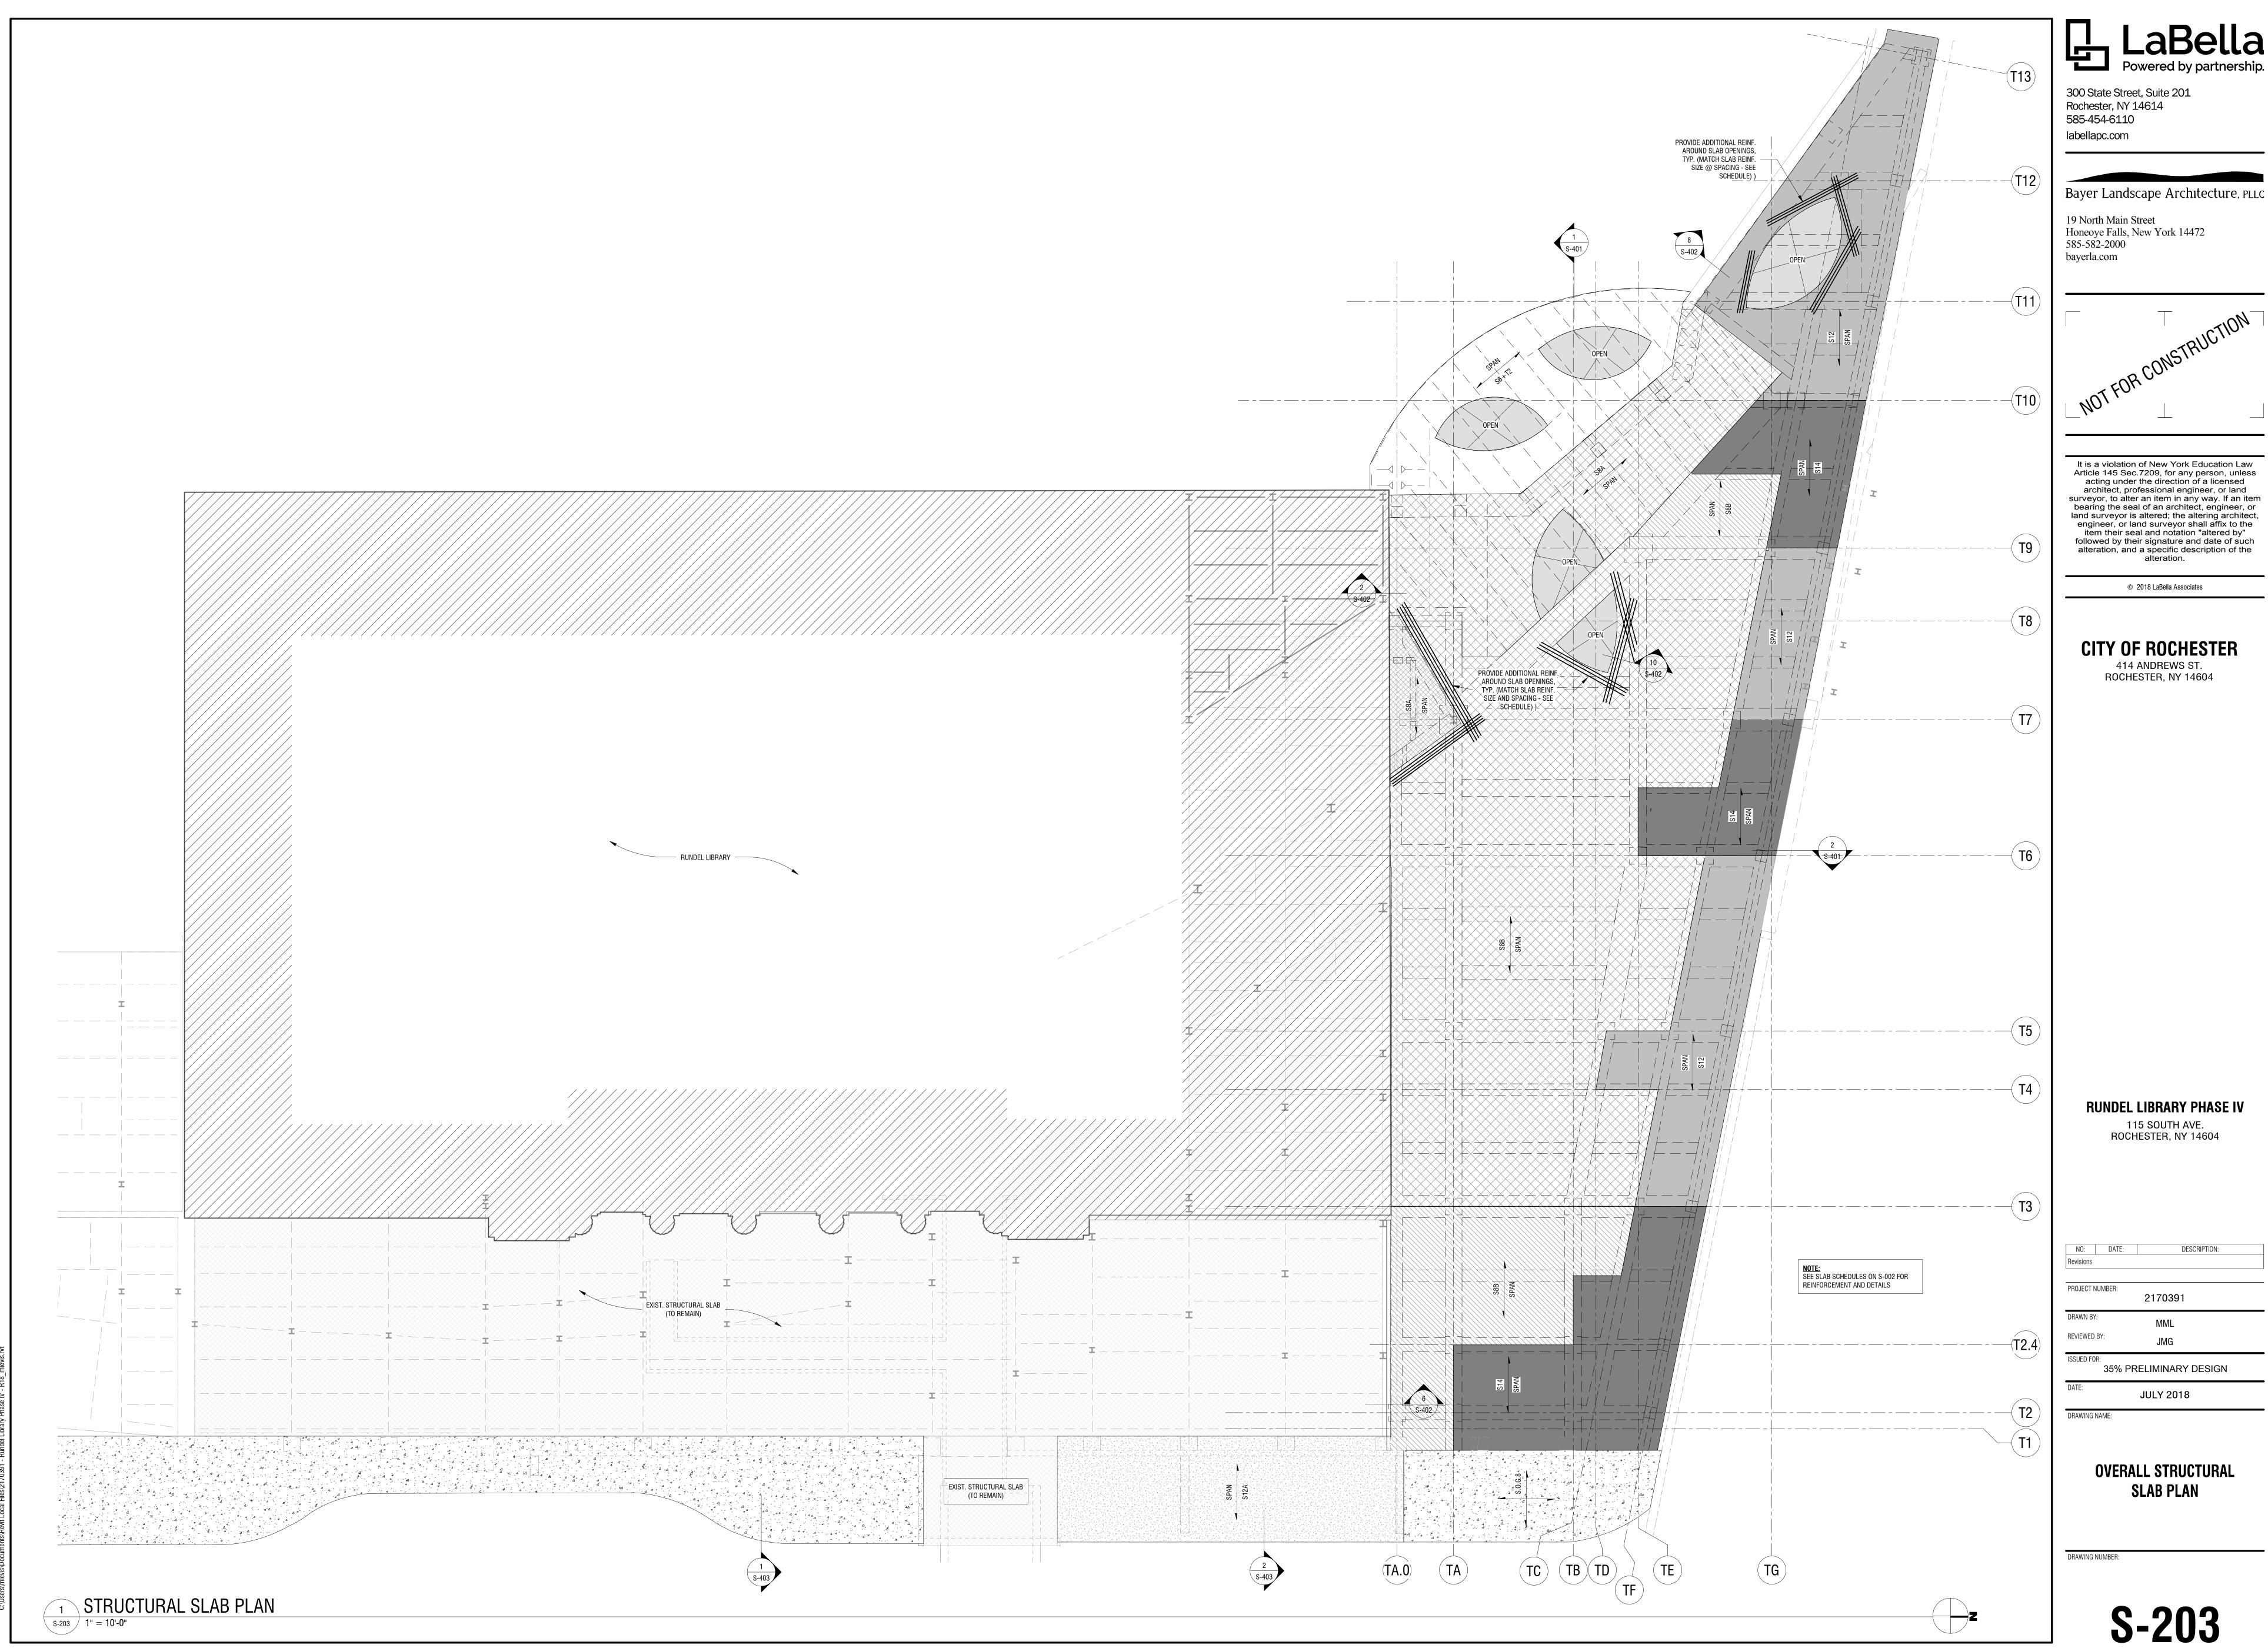
1. TOP OF EXISTING FRAMING STEEL ELEVATIONS AT (+525' - 10") AS PER EXISTING DRAWINGS (VIF).

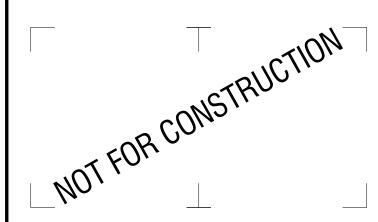
5. SEE MECHANICAL/ELECTRICAL DRAWINGS FOR THE BALANCE OF ALL EQUIPMENT, FLOOR PENETRATIONS, ETC. REQUIRED AT THIS LEVEL.

6. DO NOT SCALE DRAWINGS. SEE ARCHITECTURAL FLOOR PLANS FOR DIMENSIONS NOT INDICATED ON STRUCTURAL DRAWINGS.

2. ALL DIMENSIONS AND FRAMING SIZES ARE ASSUMED BASED ON AVAILABLE EXISTING DRAWINGS AND LASER SCAN. DIMENSIONS AND SIZES SHALL BE FIELD VERIFIED BY CONTRACTOR.

**ROOF FRAMING PLAN NOTES:** 





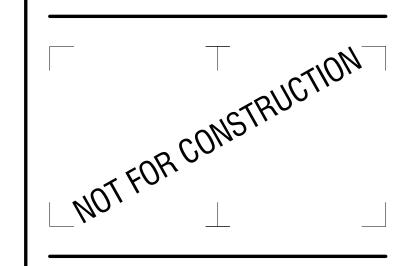
SLAB-ON-GRADE LEGEND S# SLAB-ON-GRADE: ARROWS INDICATE LIMITS # = SLAB MARKSPOT ELEVATION INDICTES DEPTH BELOW F.F.E. (DATUM ELEVATION 0'-0") CONTROL/CONSTRUCTION JOINT WALL MARK: SEE WALL SCHEDULE F.D. = FLOOR DRAIN (SEE MECH. & ARCH.) C.O. = CLEAN OUT (SEE MECH. & ARCH.) DENOTES STEP IN SLAB DENOTES SLOPE IN SLAB



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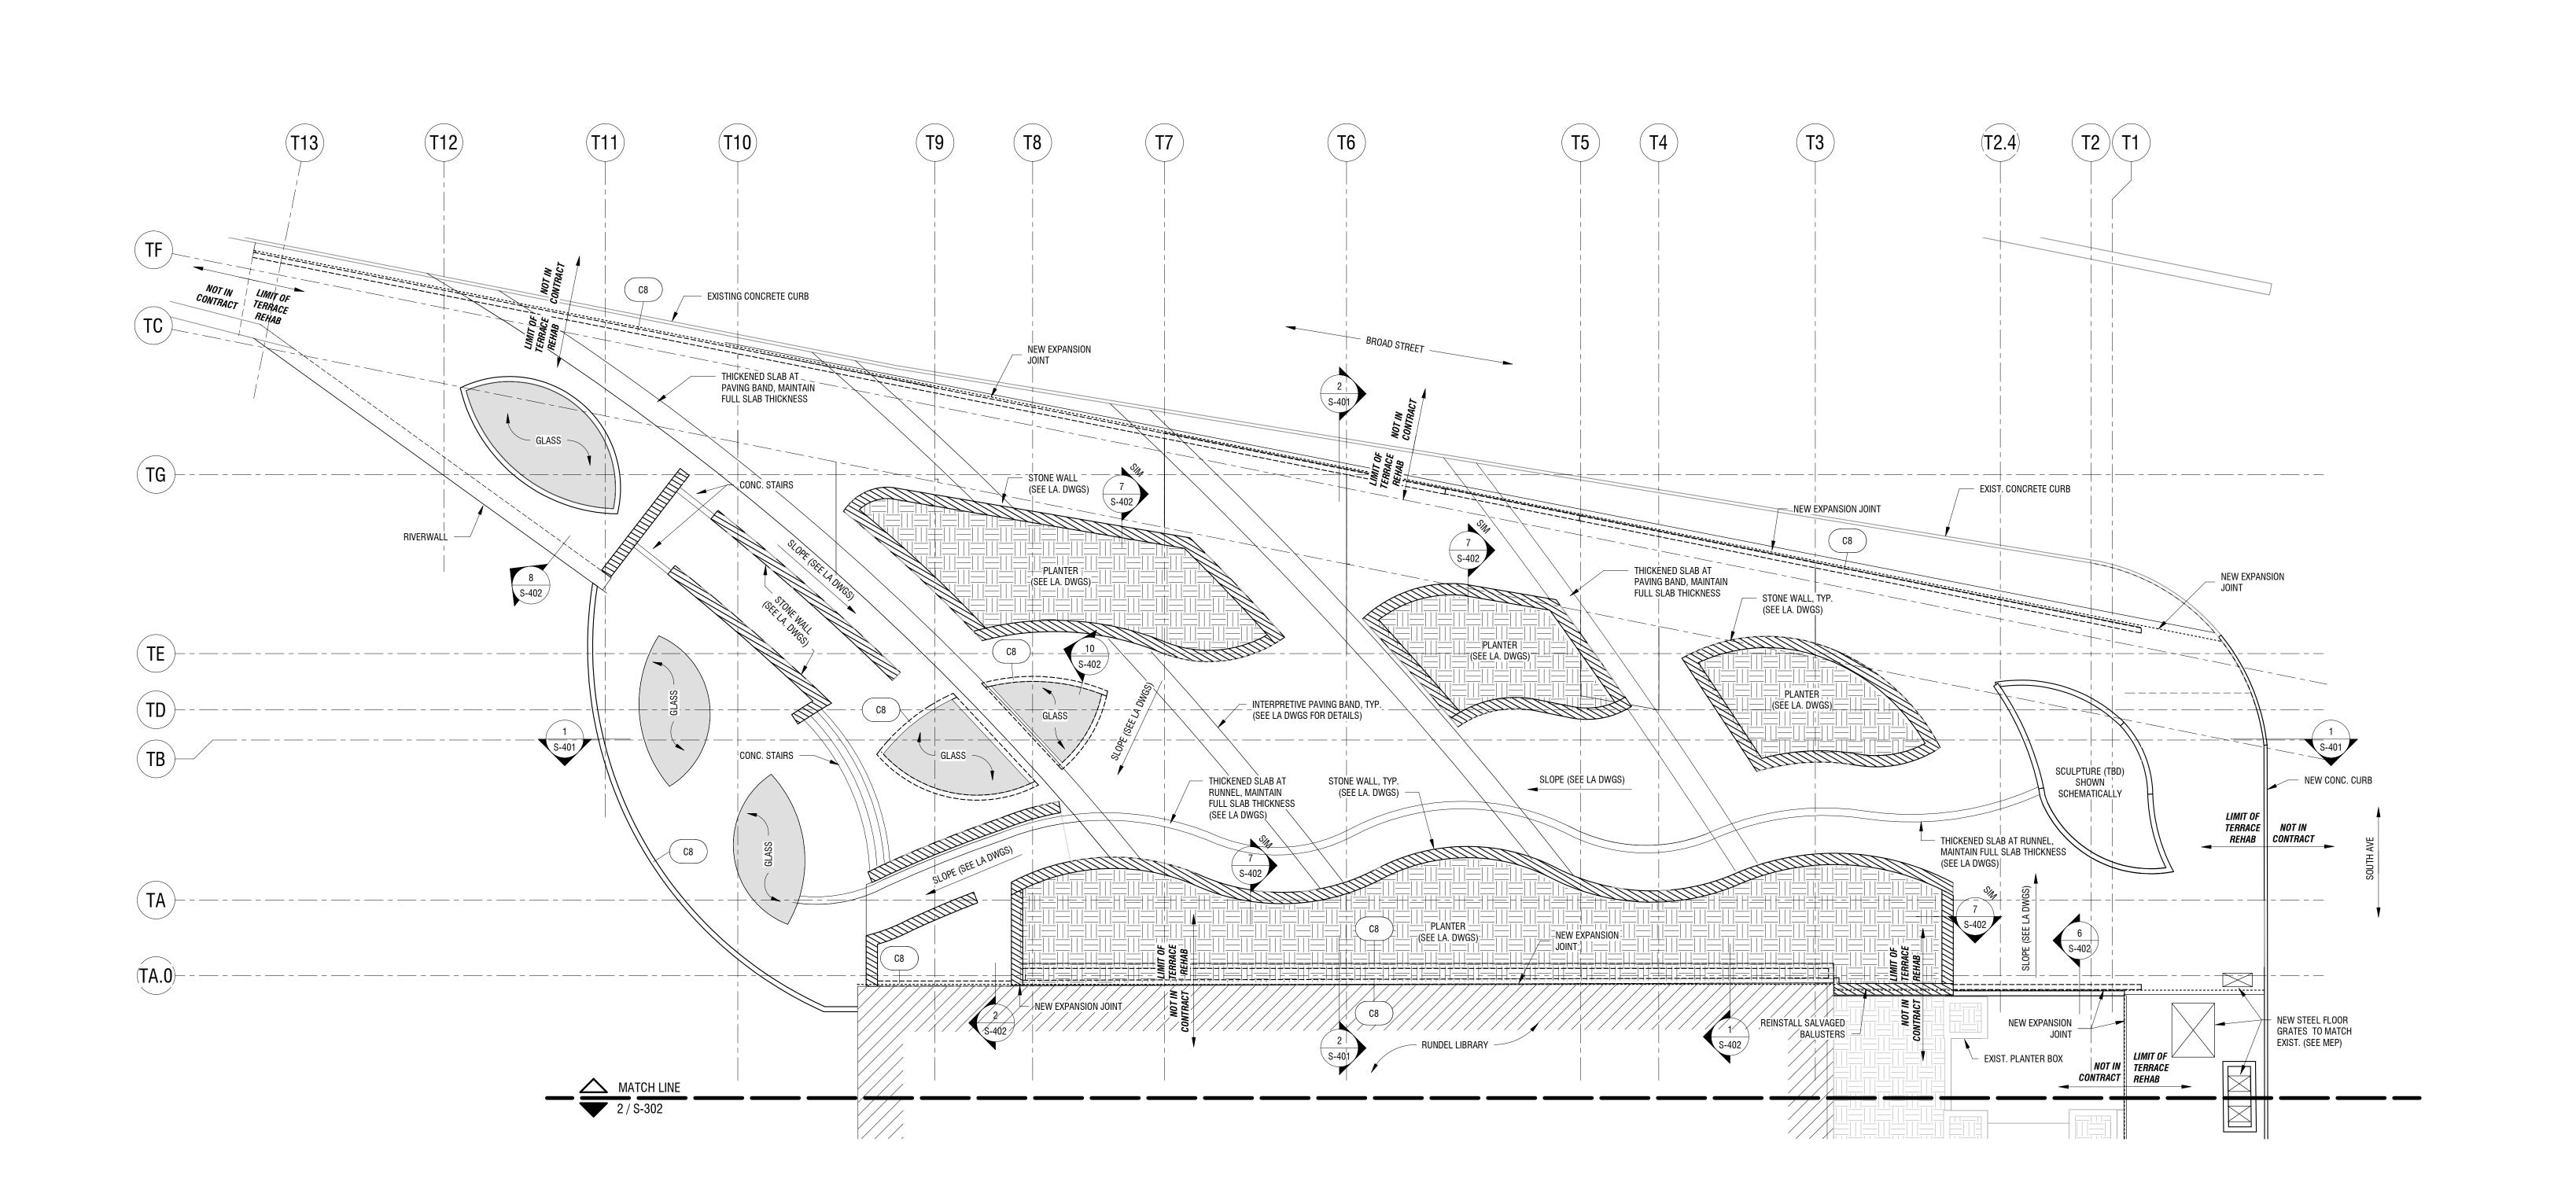
2170391 REVIEWED BY:

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DRAWING NAME:

**NORTH TERRACE SURFACE** 

DRAWING NUMBER:



NORTH TERRACE SURFACE PLAN

5. SLAB-ON-GRADE CONTROL JOINT SPACING TO BE AT 12'-0" O.C. MAX.

1. ALL ELEVATIONS ARE REFERENCED FROM FINISHED FLOOR ELEVATION 524.00' (DATUM ELEV. 0' - 0") AND ARE NOTED ON PLAN. U.N.O. 2. DO NOT SCALE DRAWINGS. SEE LANDSCAPE ARCHITECTURAL PLANS FOR DIMENSIONS NOT INDICATED ON STRUCTURAL DRAWINGS.

5. BALANCE OF SLAB REINF. FOR REENTRANT CORNERS AND OPENINGS NOT SHOWN FOR CLARITY. SEE TYPICAL DETAILS.

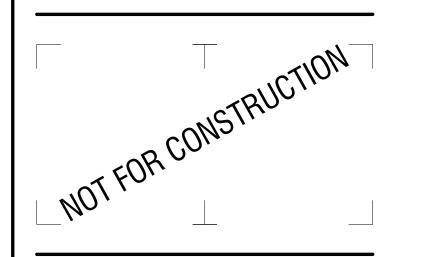
3. SECTIONS INDICATED ON PLAN ARE TYPICAL FOR SIMILAR CONDITIONS. 4. SEE M.E.P. DRAWINGS FOR THE BALANCE OF ALL EQUIPMENT, HOUSEKEEPING PADS, FLOOR PENETRATIONS, ETC. REQUIRED AT THIS LEVEL.





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Revisions

PROJECT NUMBER:

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DRAWN BY: MML
REVIEWED BY: JMG

ISSUED FOR:
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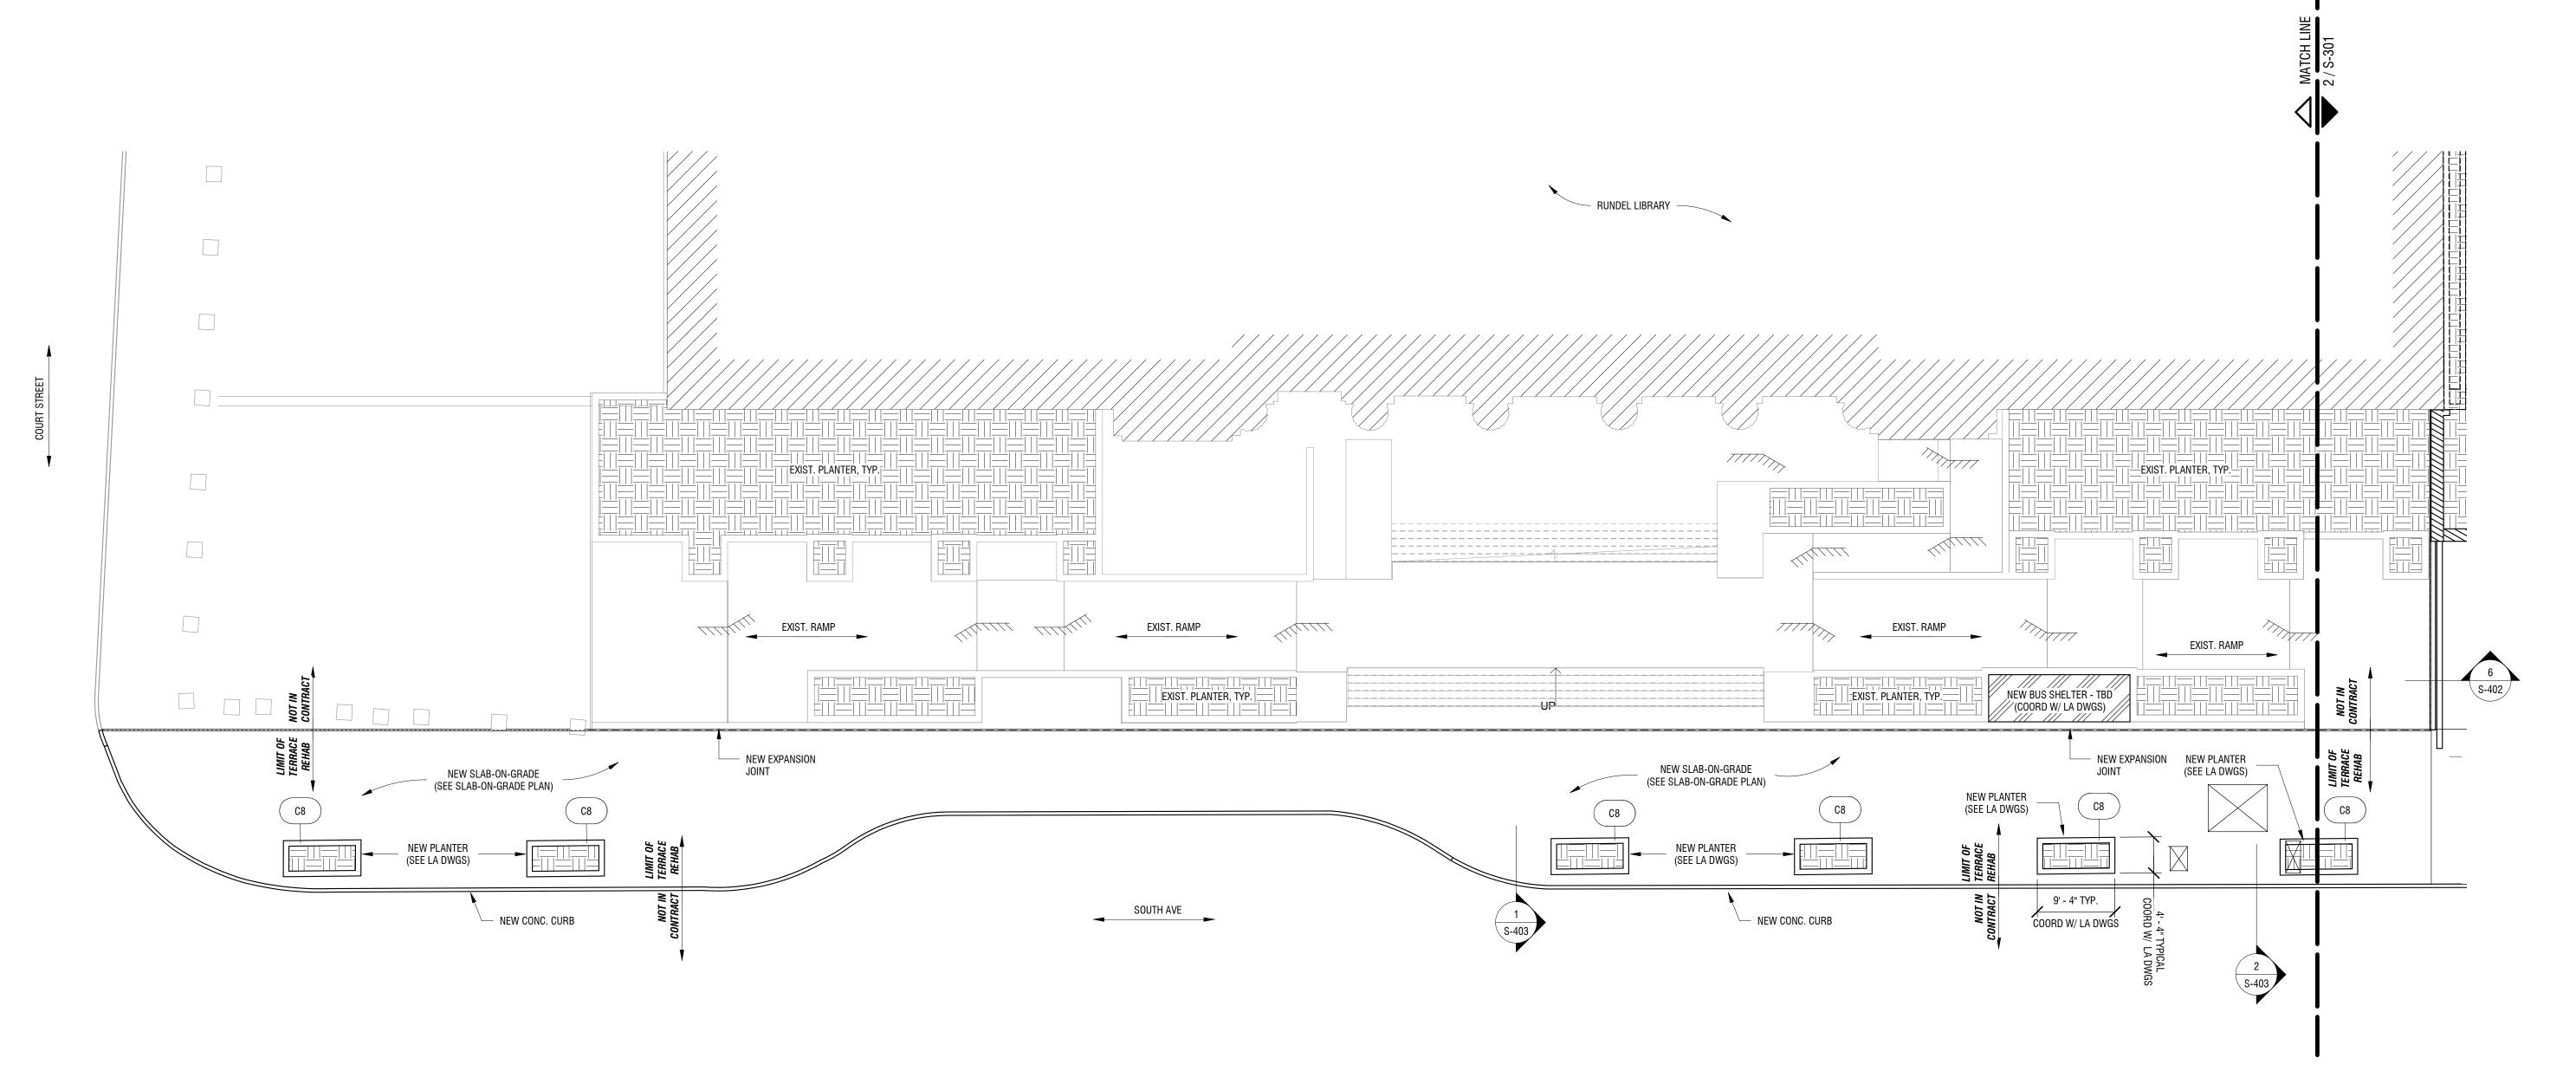
DATE:

EAST SIDEWALK -

DRAWING NUMBER:

DRAWING NAME:

**S-302** 



### <sup>2</sup> EAST SIDEWALK SURFACE PLAN

S-302 1" = 10'-0"

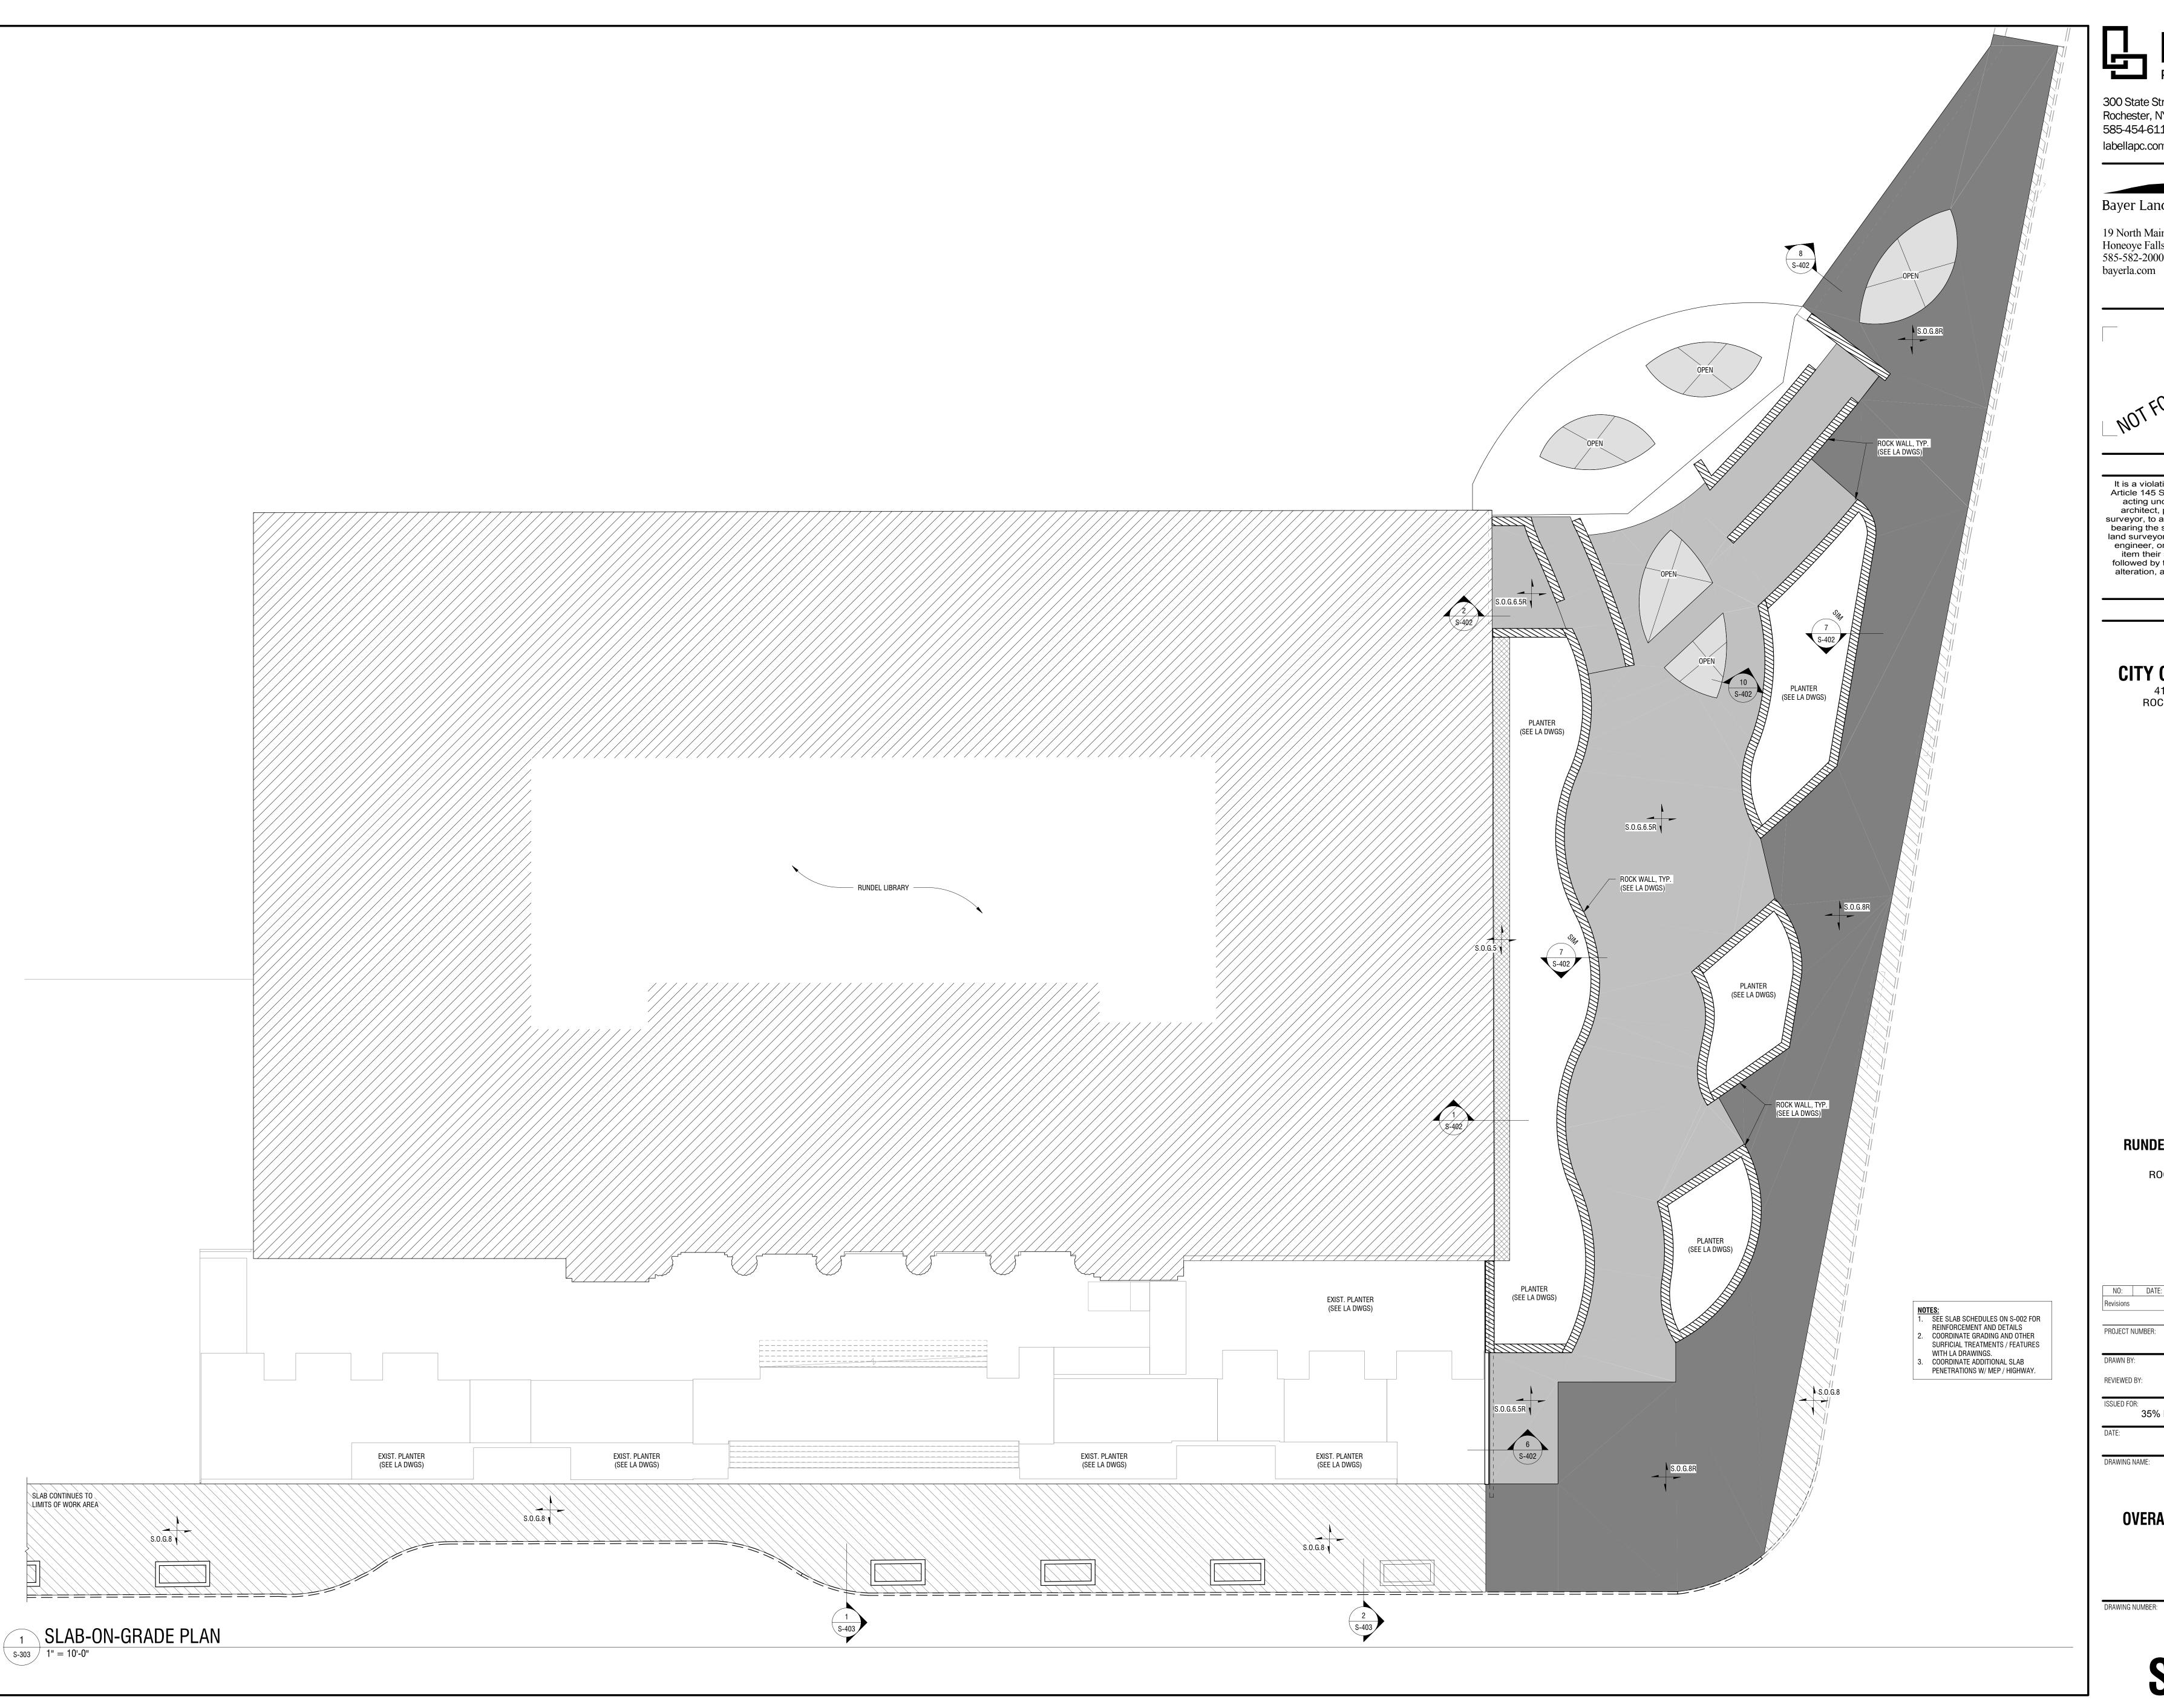
SLAB PLAN NOTES:

1. ALL ELEVATIONS ARE REFERENCED FROM FINISHED FLOOR ELEVATION 524.00' (DATUM ELEV. 0' - 0") AND ARE NOTED ON PLAN. U.N.O.

2. DO NOT SCALE DRAWINGS. SEE LANDSCAPE ARCHITECTURAL PLANS FOR DIMENSIONS NOT INDICATED ON STRUCTURAL DRAWINGS.

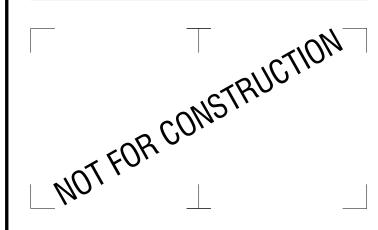
SECTIONS INDICATED ON PLAN ARE TYPICAL FOR SIMILAR CONDITIONS.
 SEE M.E.P. DRAWINGS FOR THE BALANCE OF ALL EQUIPMENT, HOUSEKEEPING PADS, FLOOR PENETRATIONS, ETC. REQUIRED AT THIS LEVEL.

5. BALANCE OF SLAB REINF. FOR REENTRANT CORNERS AND OPENINGS NOT SHOWN FOR CLARITY. SEE TYPICAL DETAILS.
5. SLAB-ON-GRADE CONTROL JOINT SPACING TO BE AT 12'-0" O.C. MAX.



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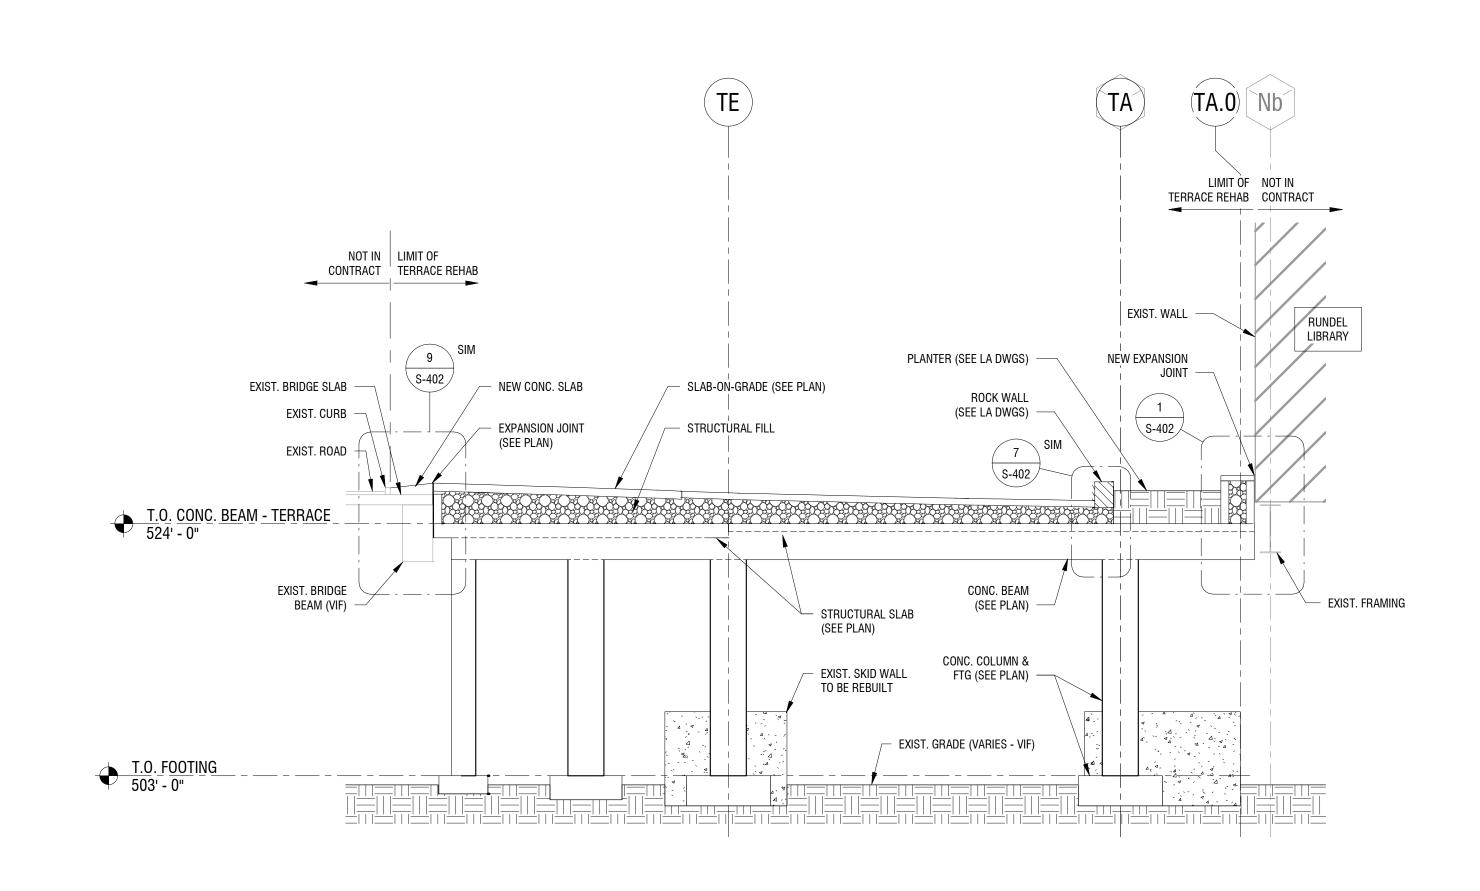
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DESCRIPTION: PROJECT NUMBER: 2170391 REVIEWED BY: 35% PRELIMINARY DESIGN DRAWING NAME:

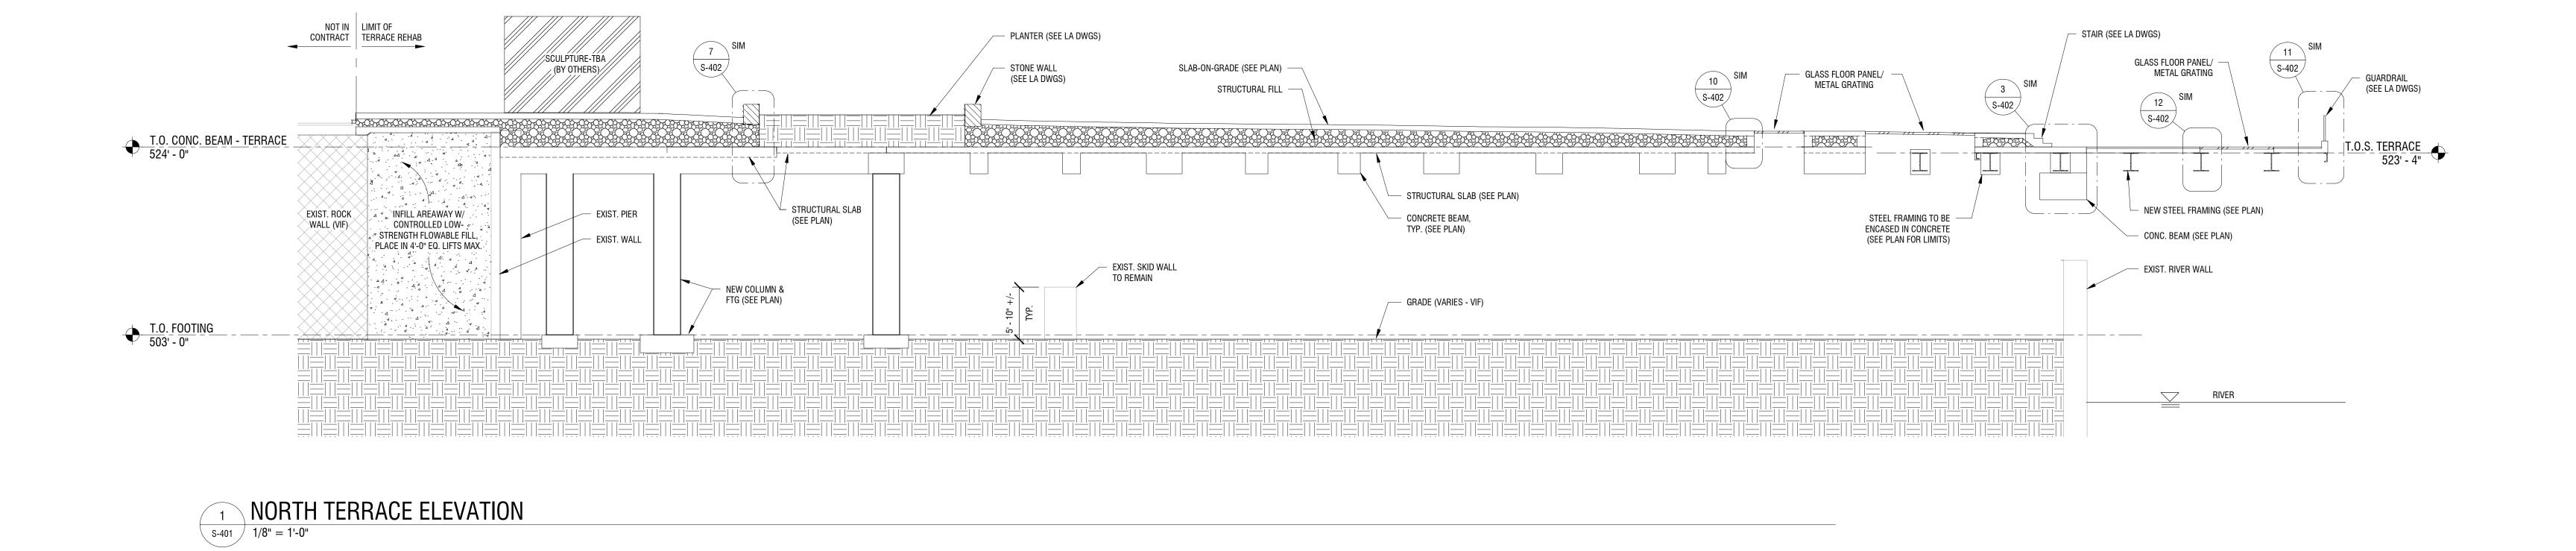
> **OVERALL SLAB-ON-GRADE PLAN**

DRAWING NUMBER:



2 NORTH TERRACE ELEVATION

1/8" = 1'-0"

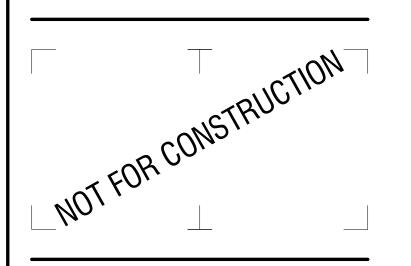


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CITY OF ROCHESTER
414 ANDREWS ST.
ROCHESTER, NY 14604

RUNDEL LIBRARY PHASE IV 115 SOUTH AVE.

ROCHESTER, NY 14604

NO: DATE: DESCRIPTION:

Revisions

PROJECT NUMBER:

2170391

DRAWN BY: MML

REVIEWED BY: JMG

ISSUED FOR:

35% PRELIMINARY DESIGN

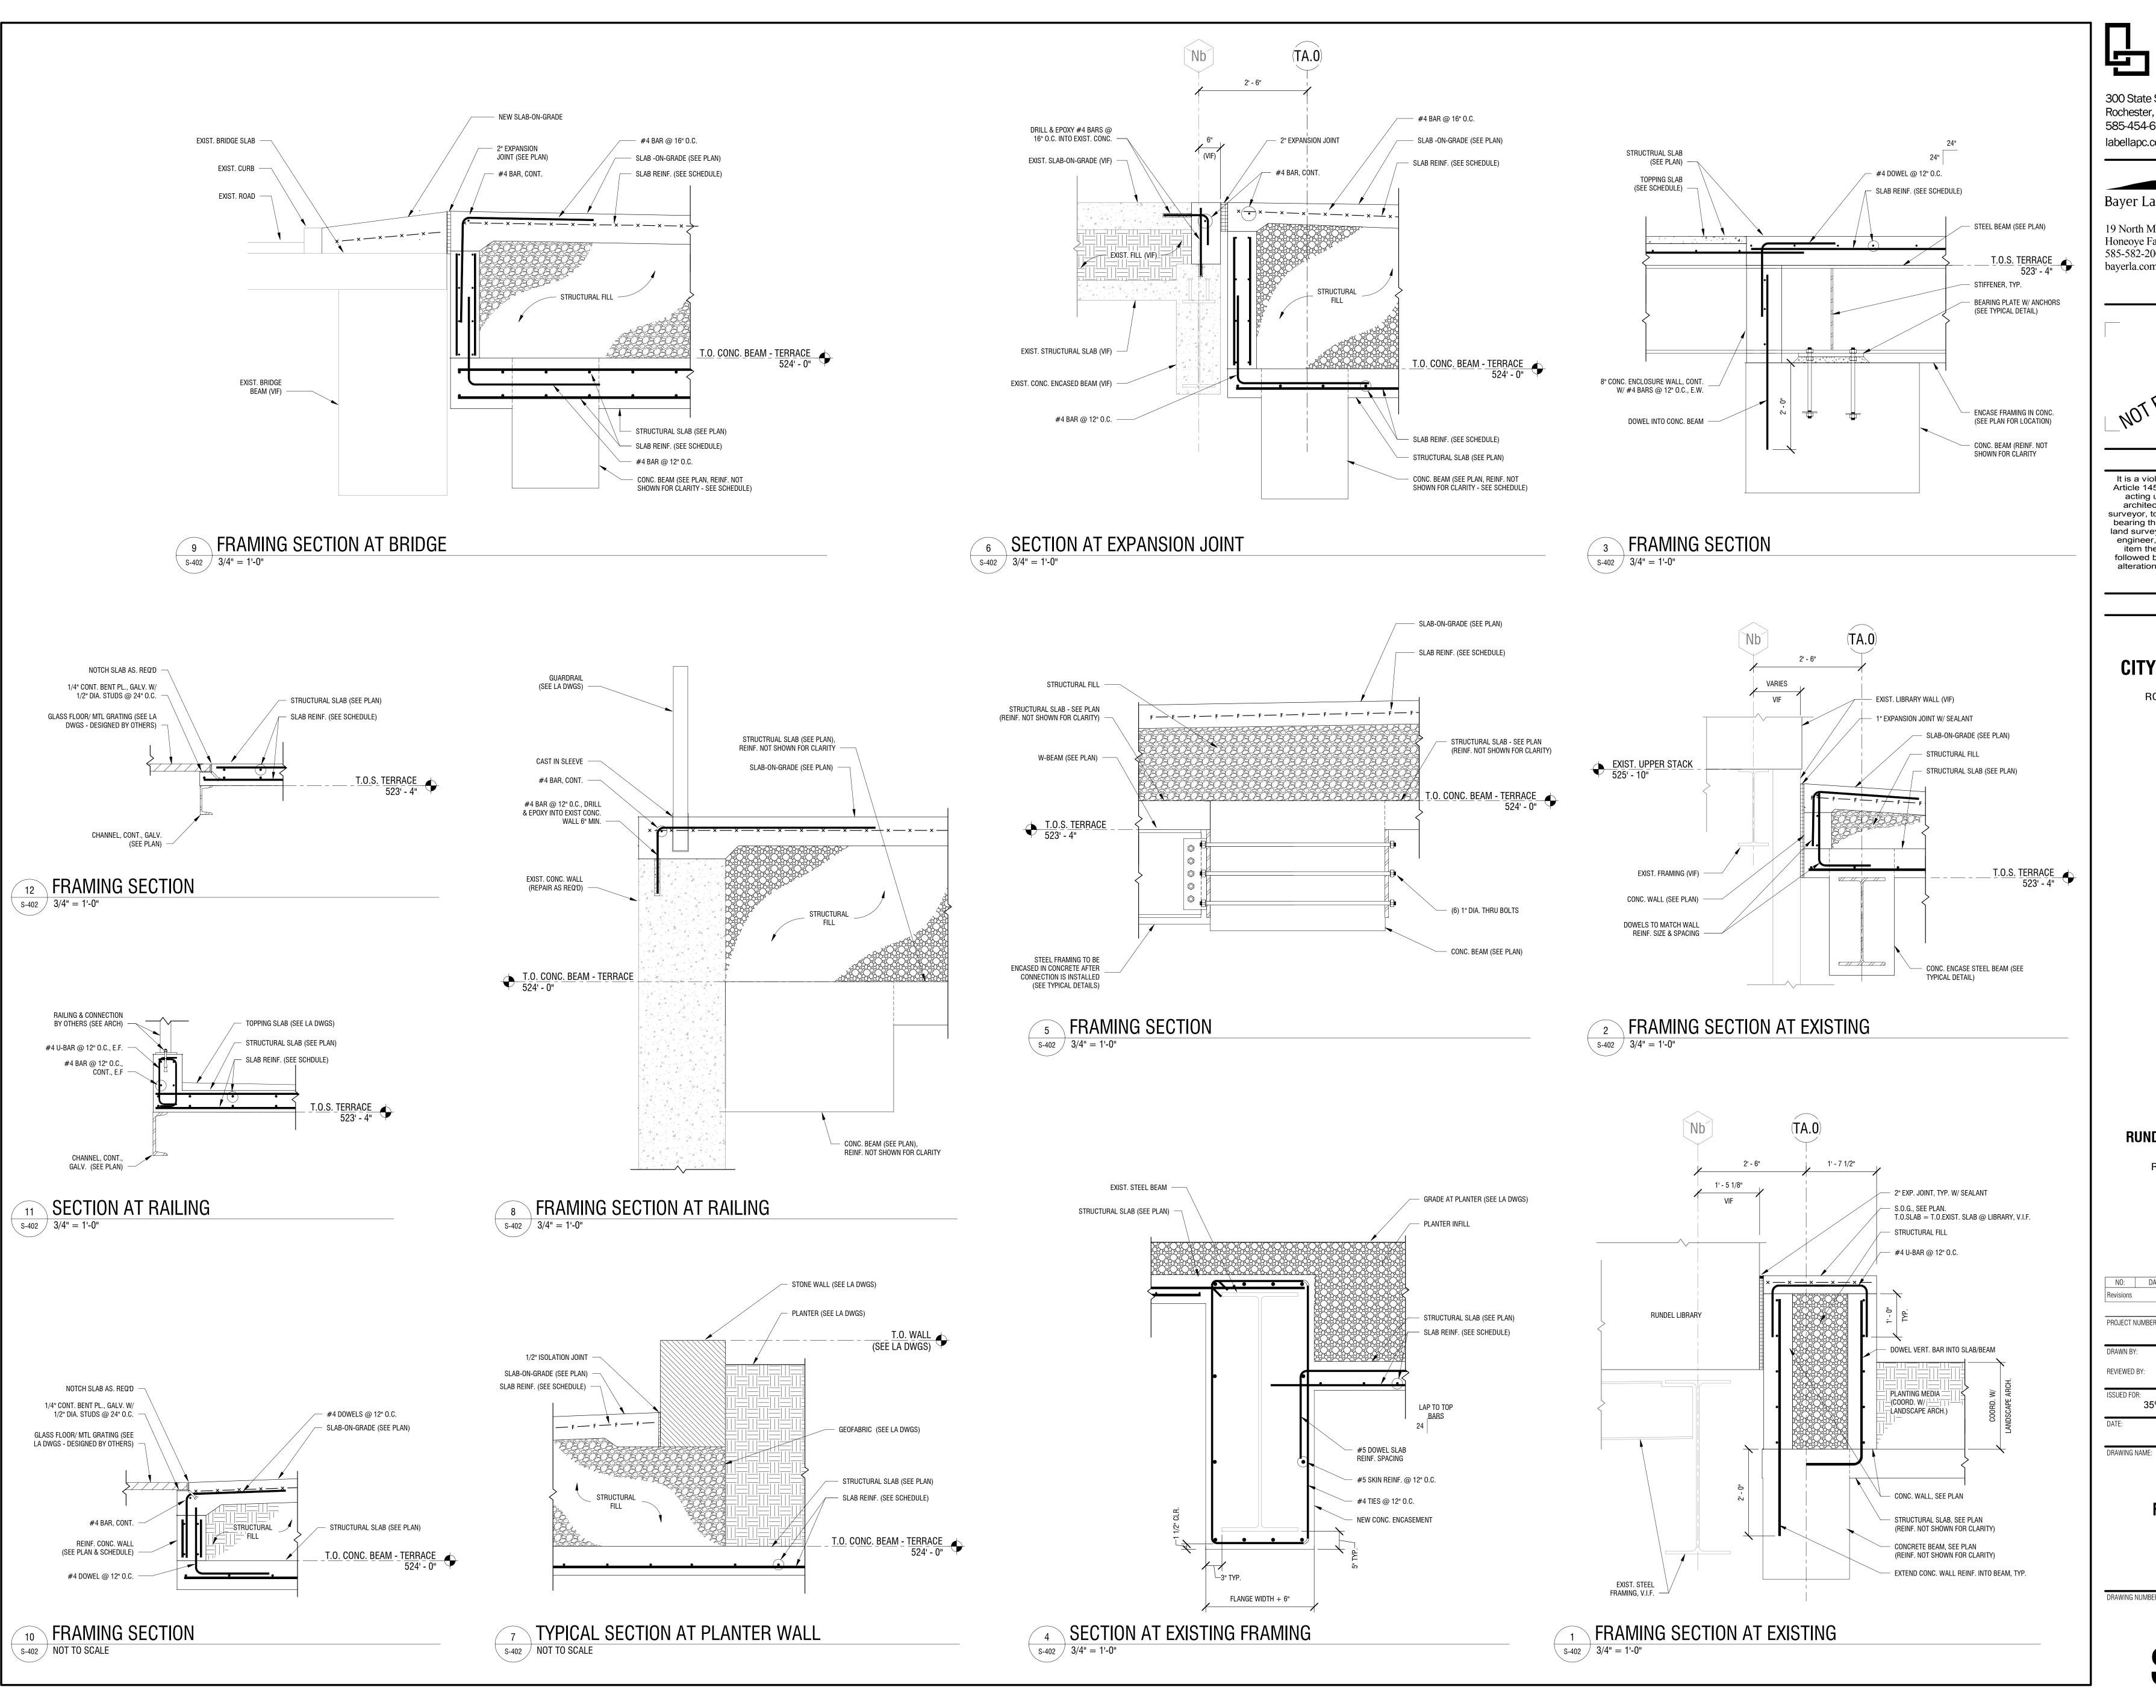
DATE: JULY 2018

DRAWING NAME:

**ELEVATIONS** 

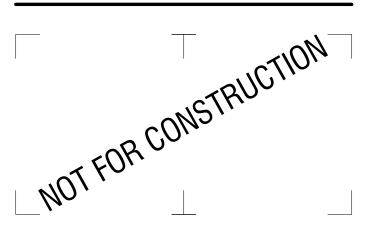
DRAWING NUM

S-401



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alteration.

**CITY OF ROCHESTER** 414 ANDREWS ST.

ROCHESTER, NY 14604

**RUNDEL LIBRARY PHASE IV** 

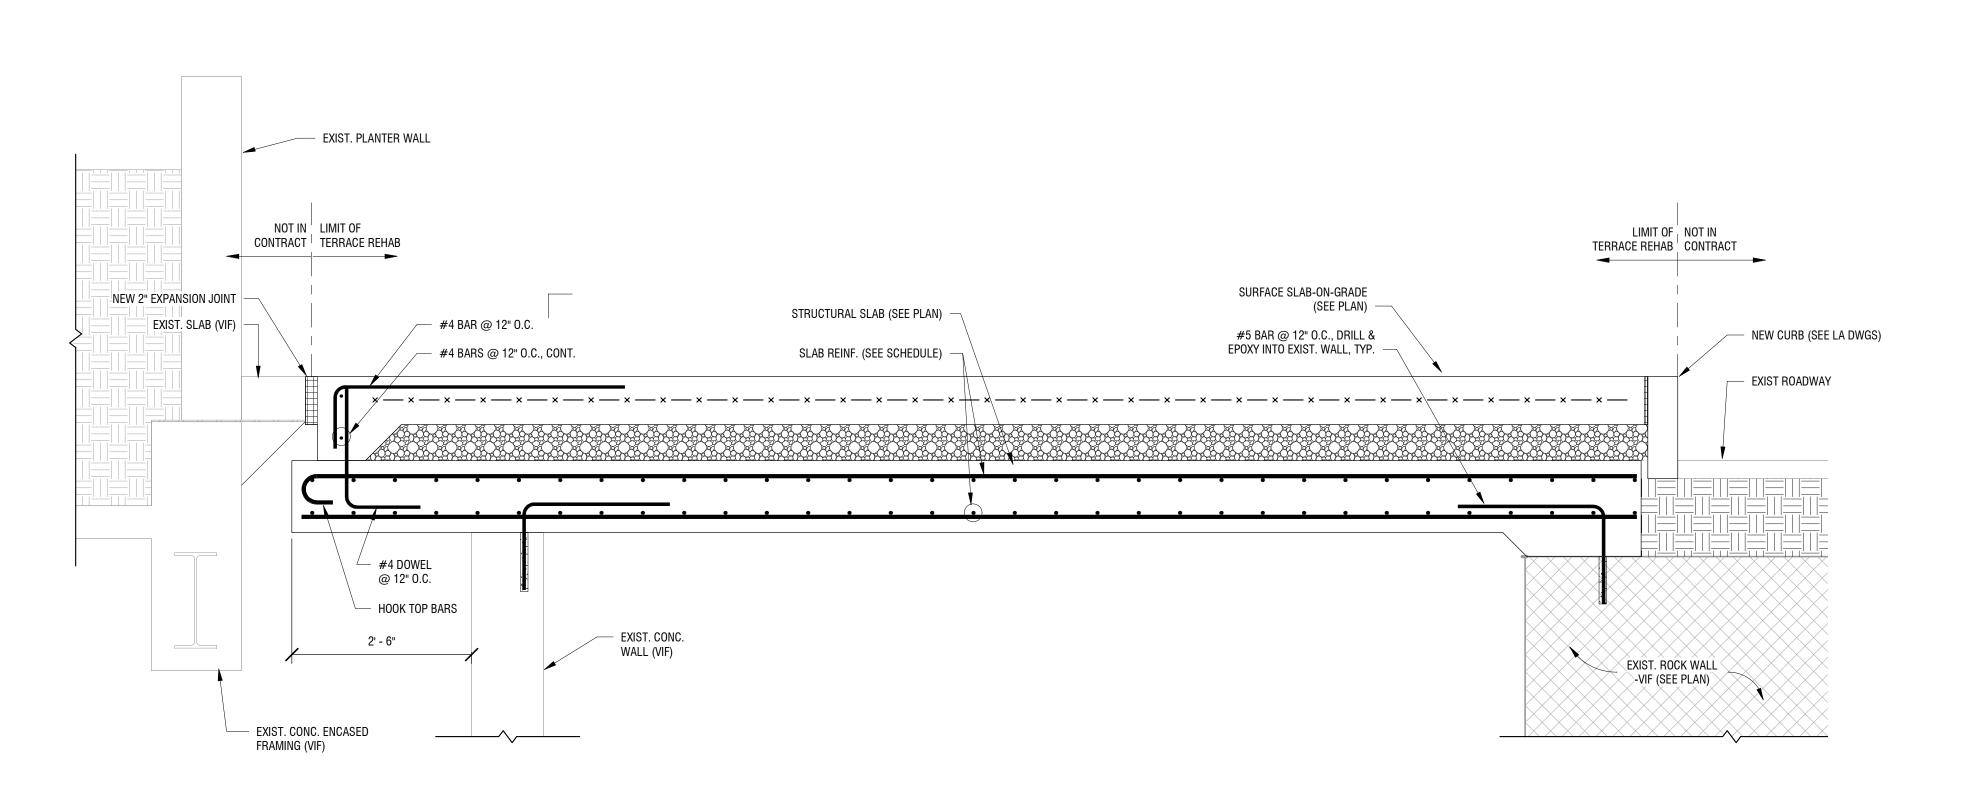
115 SOUTH AVE. ROCHESTER, NY 14604

DESCRIPTION: PROJECT NUMBER: 2170391 REVIEWED BY: ISSUED FOR: 35% PRELIMINARY DESIGN

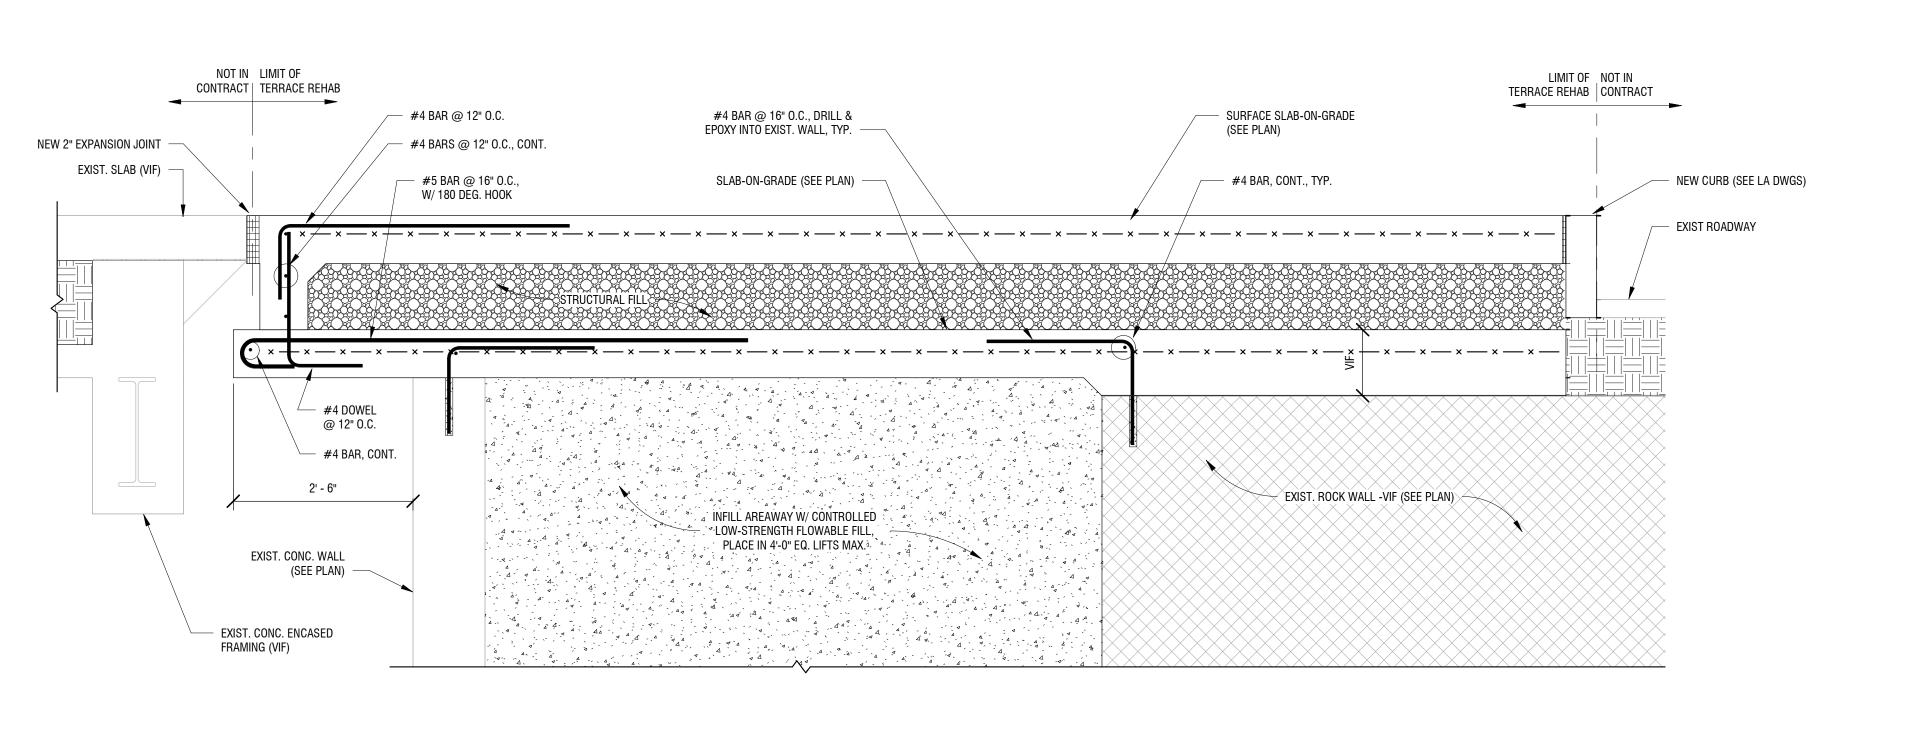
FRAMING & SLAB

**SECTIONS** 

DRAWING NUMBER:



### <sup>2</sup> SECTION AT EAST SIDEWALK

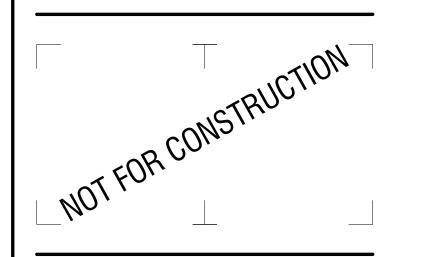


1 SECTION AT EAST SIDEWALK S-403 3/4" = 1'-0"

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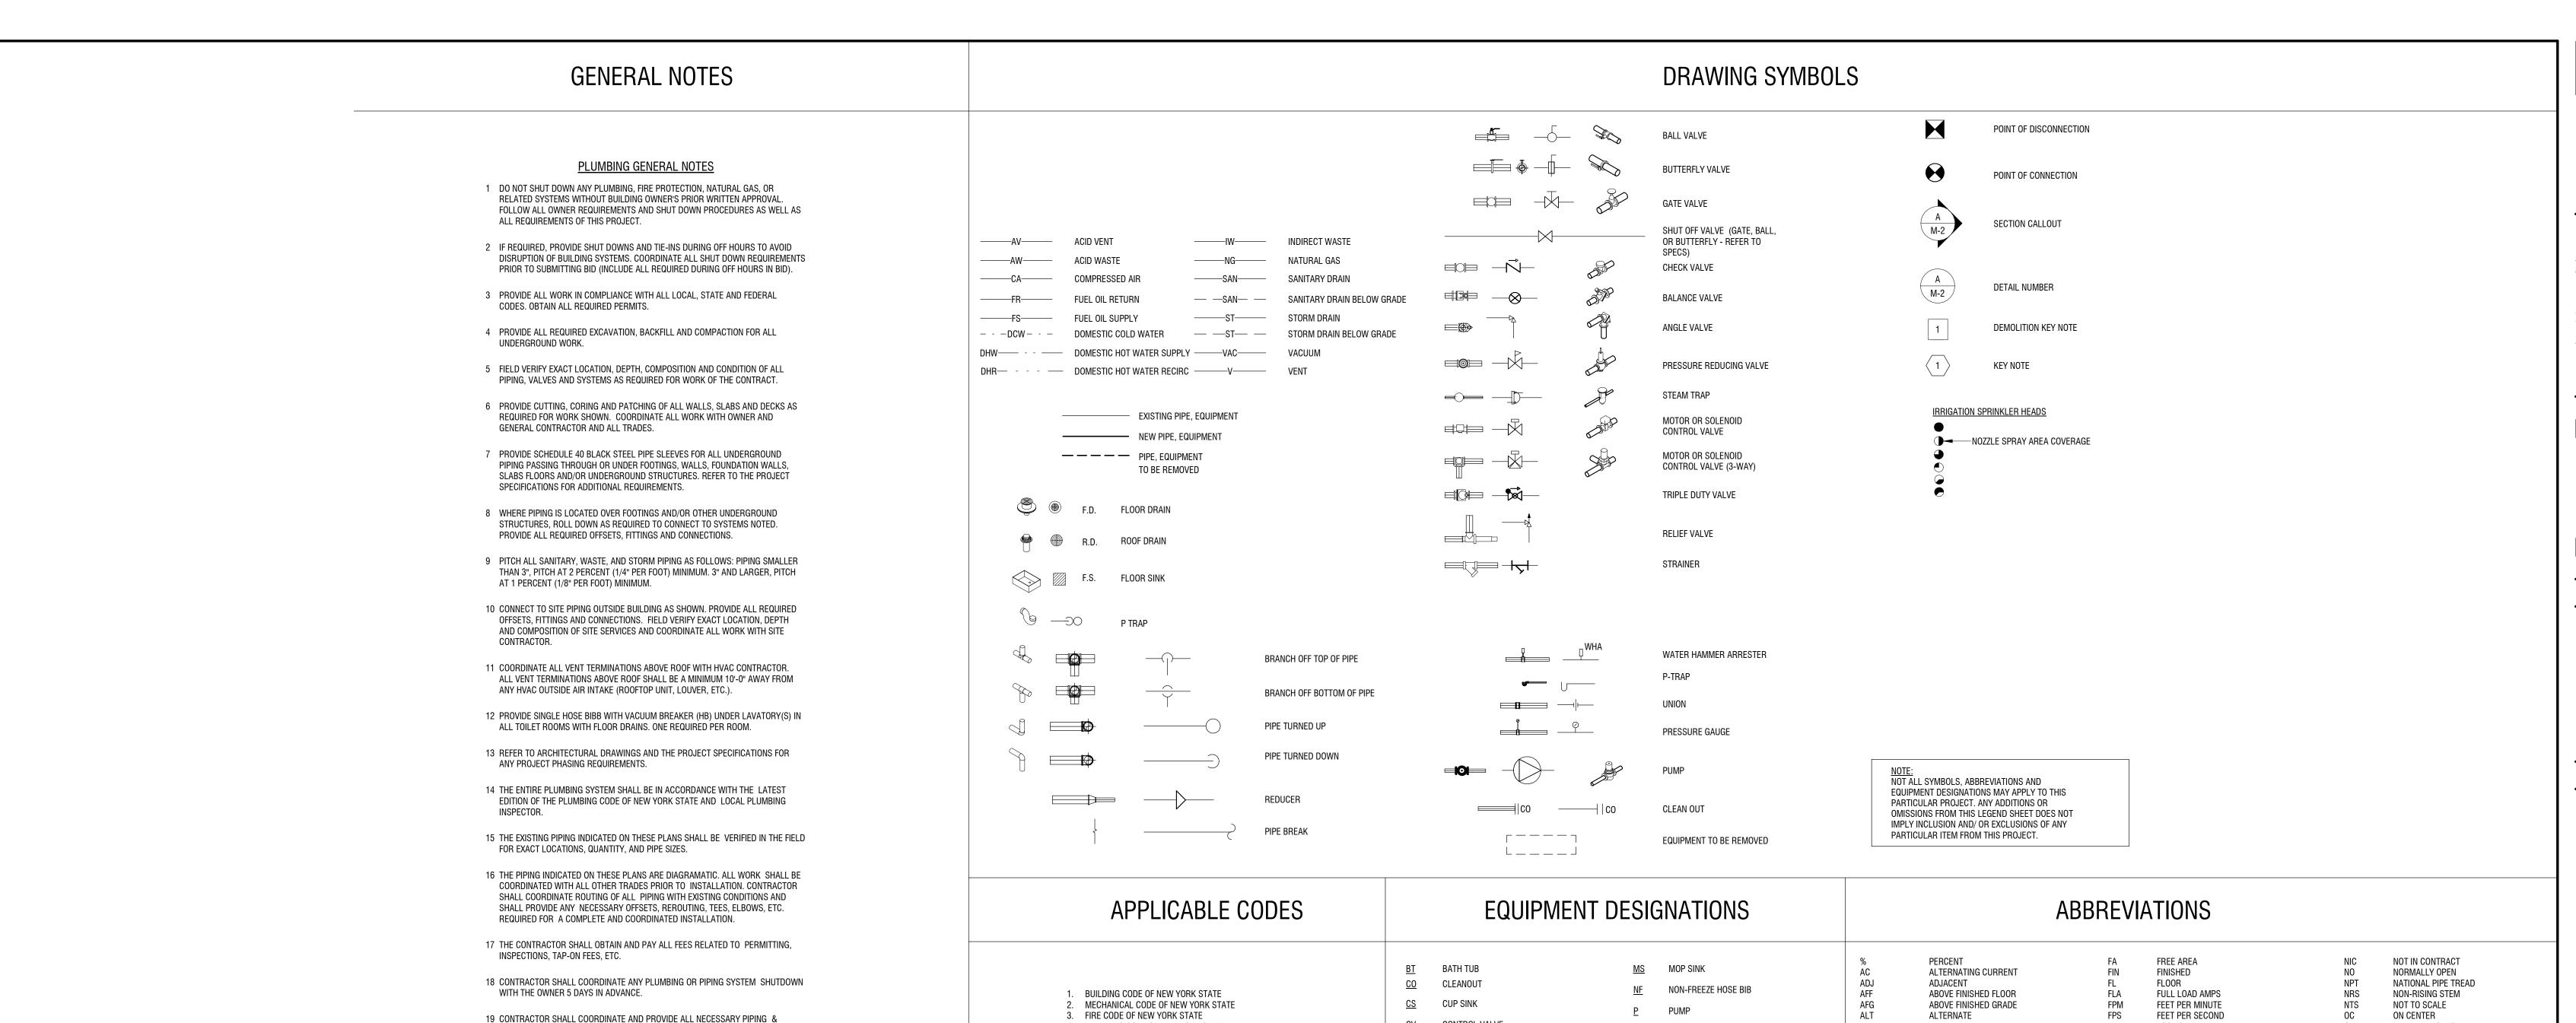
115 SOUTH AVE. ROCHESTER, NY 14604

DESCRIPTION: Revisions PROJECT NUMBER: 2170391 DRAWN BY: REVIEWED BY: 35% PRELIMINARY DESIGN

DRAWING NAME:

FRAMING & SLAB **SECTIONS** 

DRAWING NUMBER:



PLUMBING FITTINGS, PIPING, MISCELLANEOUS ITEMS REQUIRED FOR A COMPLETE

21 THE CONTRACTOR SHALL COORDINATE THE INSTALLATION OF ALL UNDER SLAB

PIPING WITH EXISTING STRUCTURAL FOUNDATIONS. UNDERGROUND UTILITY

CONTRACTOR SHALL REPAIR OR REPLACE ALL PIPING NOT IN PROPER WORKING

ORDER OR DAMAGED DURING INSTALLATION OF THE NEW UNDERSLAB PIPING.

22 ALL PLUMBING & PIPING SYSTEMS SHALL BE SUPPORTED AS REQUIRED BY THE

23 ALL PIPING PENETRATIONS THROUGH NEW, EXISTING WALL, OR FLOOR SHALL BE

SEALED TO EQUAL THE RATING OF THE NEW, EXISTING WALL OR FLOOR.

24 THE PLUMBING SYSTEM SHALL BE TESTED AS REQUIRED BY STATE AND LOCAL

25 THE ENTIRE DOMESTIC WATER SYSTEM (EXISTING/NEW) SHALL BE DISINFECTED IN

ACCORDANCE TO THE LOCAL CODE & HEALTH DEPARTMENT REQUIREMENTS.

26 THE BACKFLOW PREVENTION DEVICE SHALL BE INSTALLED PER STATE AND LOCAL

PRELIMINARY. FINAL LOCATIONS SHALL BE COORDINATED WITH ALL TRADES. ALL

VTR'S SHALL BE A MINIMUM OF 25'-0" FROM ALL FRESH AIR INTAKE OPENINGS.

28 LEAD TESTING REQUIRED BY THIS CONTRACTOR UNDER NYS HEALTH DEPARTMENT

CONSTRUCTION WATER SAMPLES TAKEN AND ANALYZED BY A NYS DOH APPROVED

SYSTEM WHERE PLUMBING FIXTURES AND SUPPLY FITTINGS ARE BEING INSTALLED

REGULATION 10NYCRR SUBPART 67-4 (LEAD TESTING IN SCHOOL DRINKING

ENVIRONMENTAL LABORATORY AT ALL AREAS OF THE WATER DISTRIBUTION

UNDER THE PLUMBING CONTRACT THAT COULD POTENTIALLY BE USED FOR

DRINKING AND/OR COOKING PURPOSES. THIS INCLUDES BUT IS NOT LIMITED TO

WATER COOLERS, LAVATORIES, HAND SINKS, CLASSROOM SINKS AND BUBBLERS.

UNDER THE DOH CODE A PASSING RESULT IS BELOW 15 PARTS PER BILLION (PPB)

OR LESS. ANY PLUMBING WORK NOT PASSING THIS TEST SHALL BE REPLACED AT

NO COST TO OWNER AND THE ABOVE POST CONSTRUCTION TESTING SHALL BE

29 CONTRACTOR SHALL INSULATE ALL PLUMBING PIPING PER SPECIFICATION.

REPEATED UNTIL THE WORK PASSES.

WATER): THIS CONTRACTOR SHALL HAVE PRE-CONSTRUCTION AND POST

CODE & PER AUTHORITY HAVING JURISDICTION REQUIREMENTS.

27 ALL (VTR'S) VENT THRU ROOF PENETRATIONS INDICATED ON PLANS ARE

CODE OR BY THE REQUIREMENTS OF THE LOCAL PLUMBING INSPECTOR.

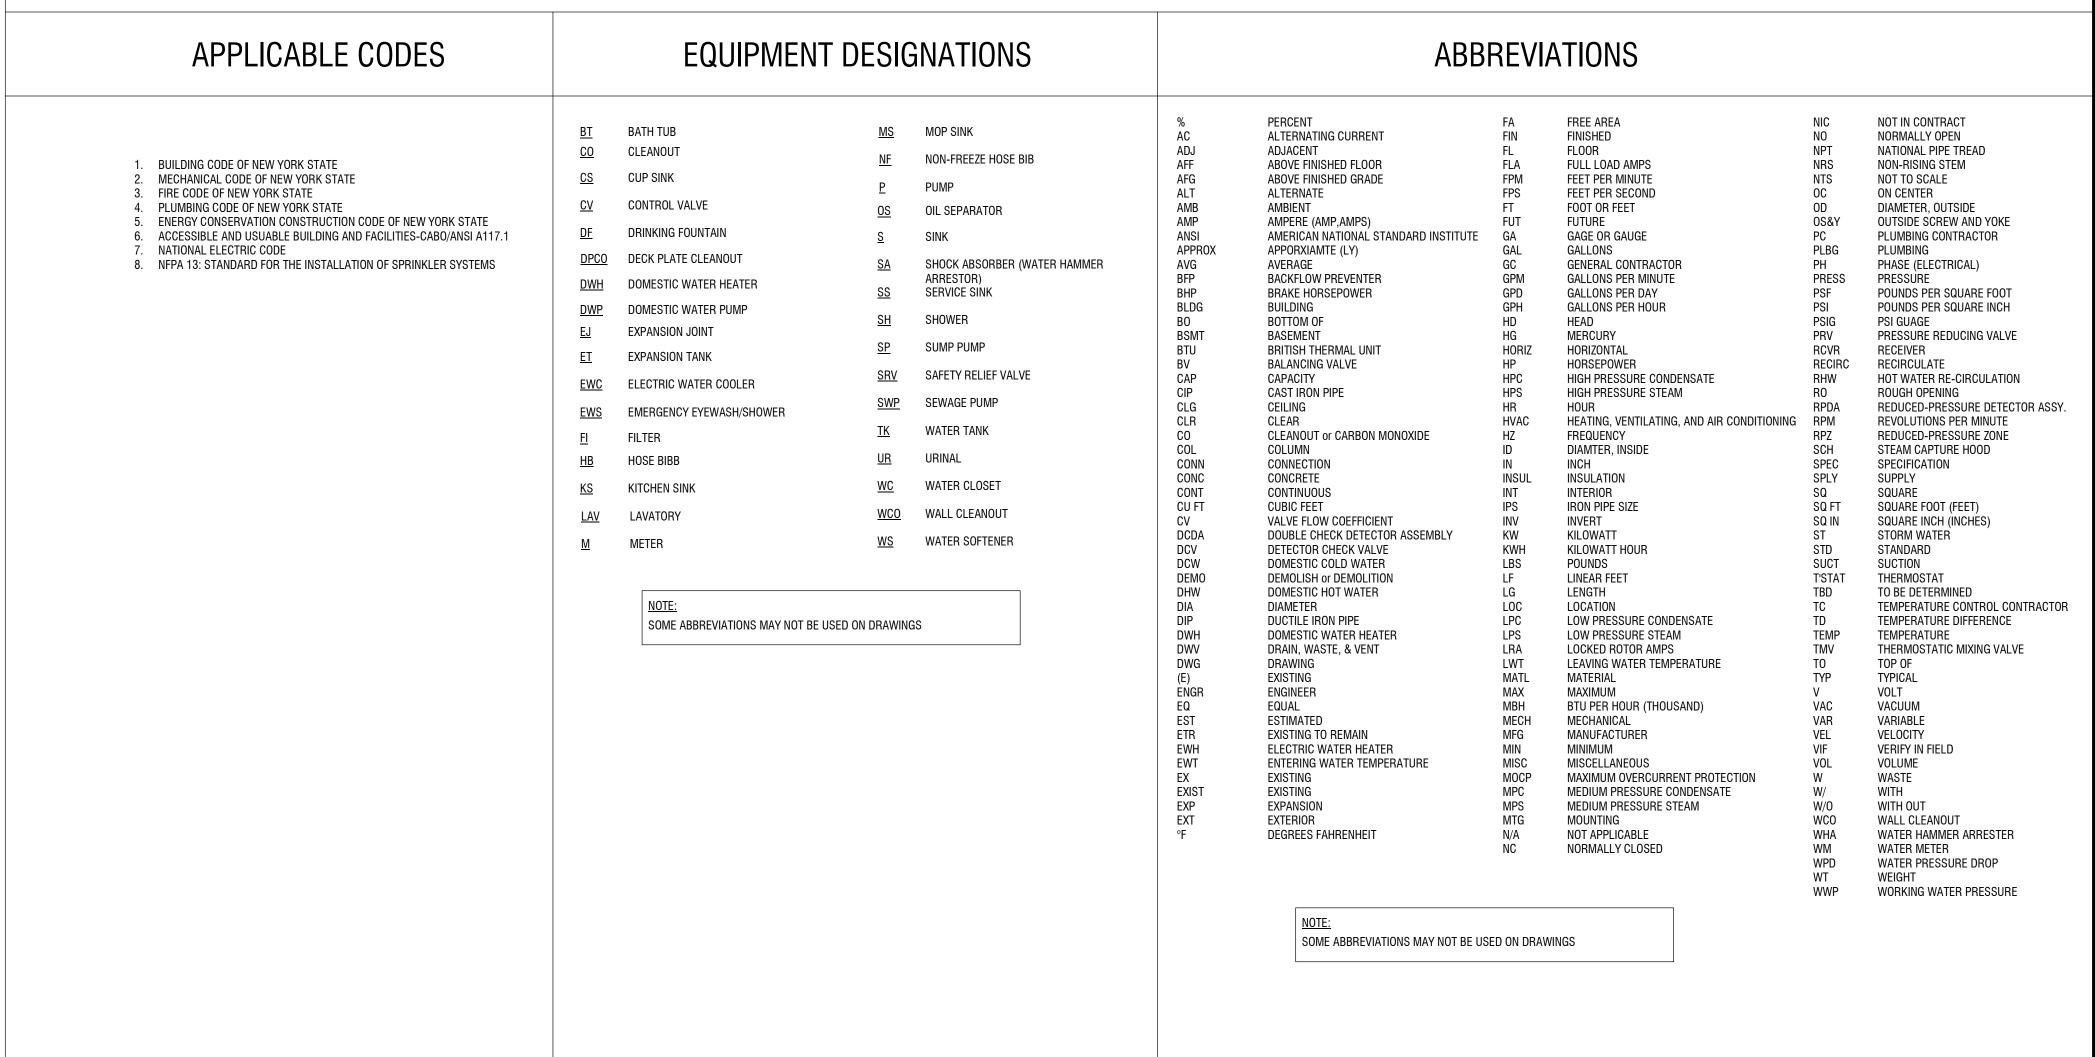
STATE AND LOCAL CODE REQUIREMENTS AND PER MANUFACTURER'S

LOCATIONS SHALL BE VERIFIED PRIOR TO ANY WORK BEING PERFORMED.

INSTALLATION OF ALL PLUMBING RELATED ITEMS.

RECOMMENDATIONS.

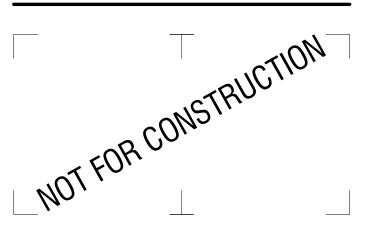
20 ALL WORK SHALL BE COORDINATED WITH THE EQUIPMENT VENDORS.



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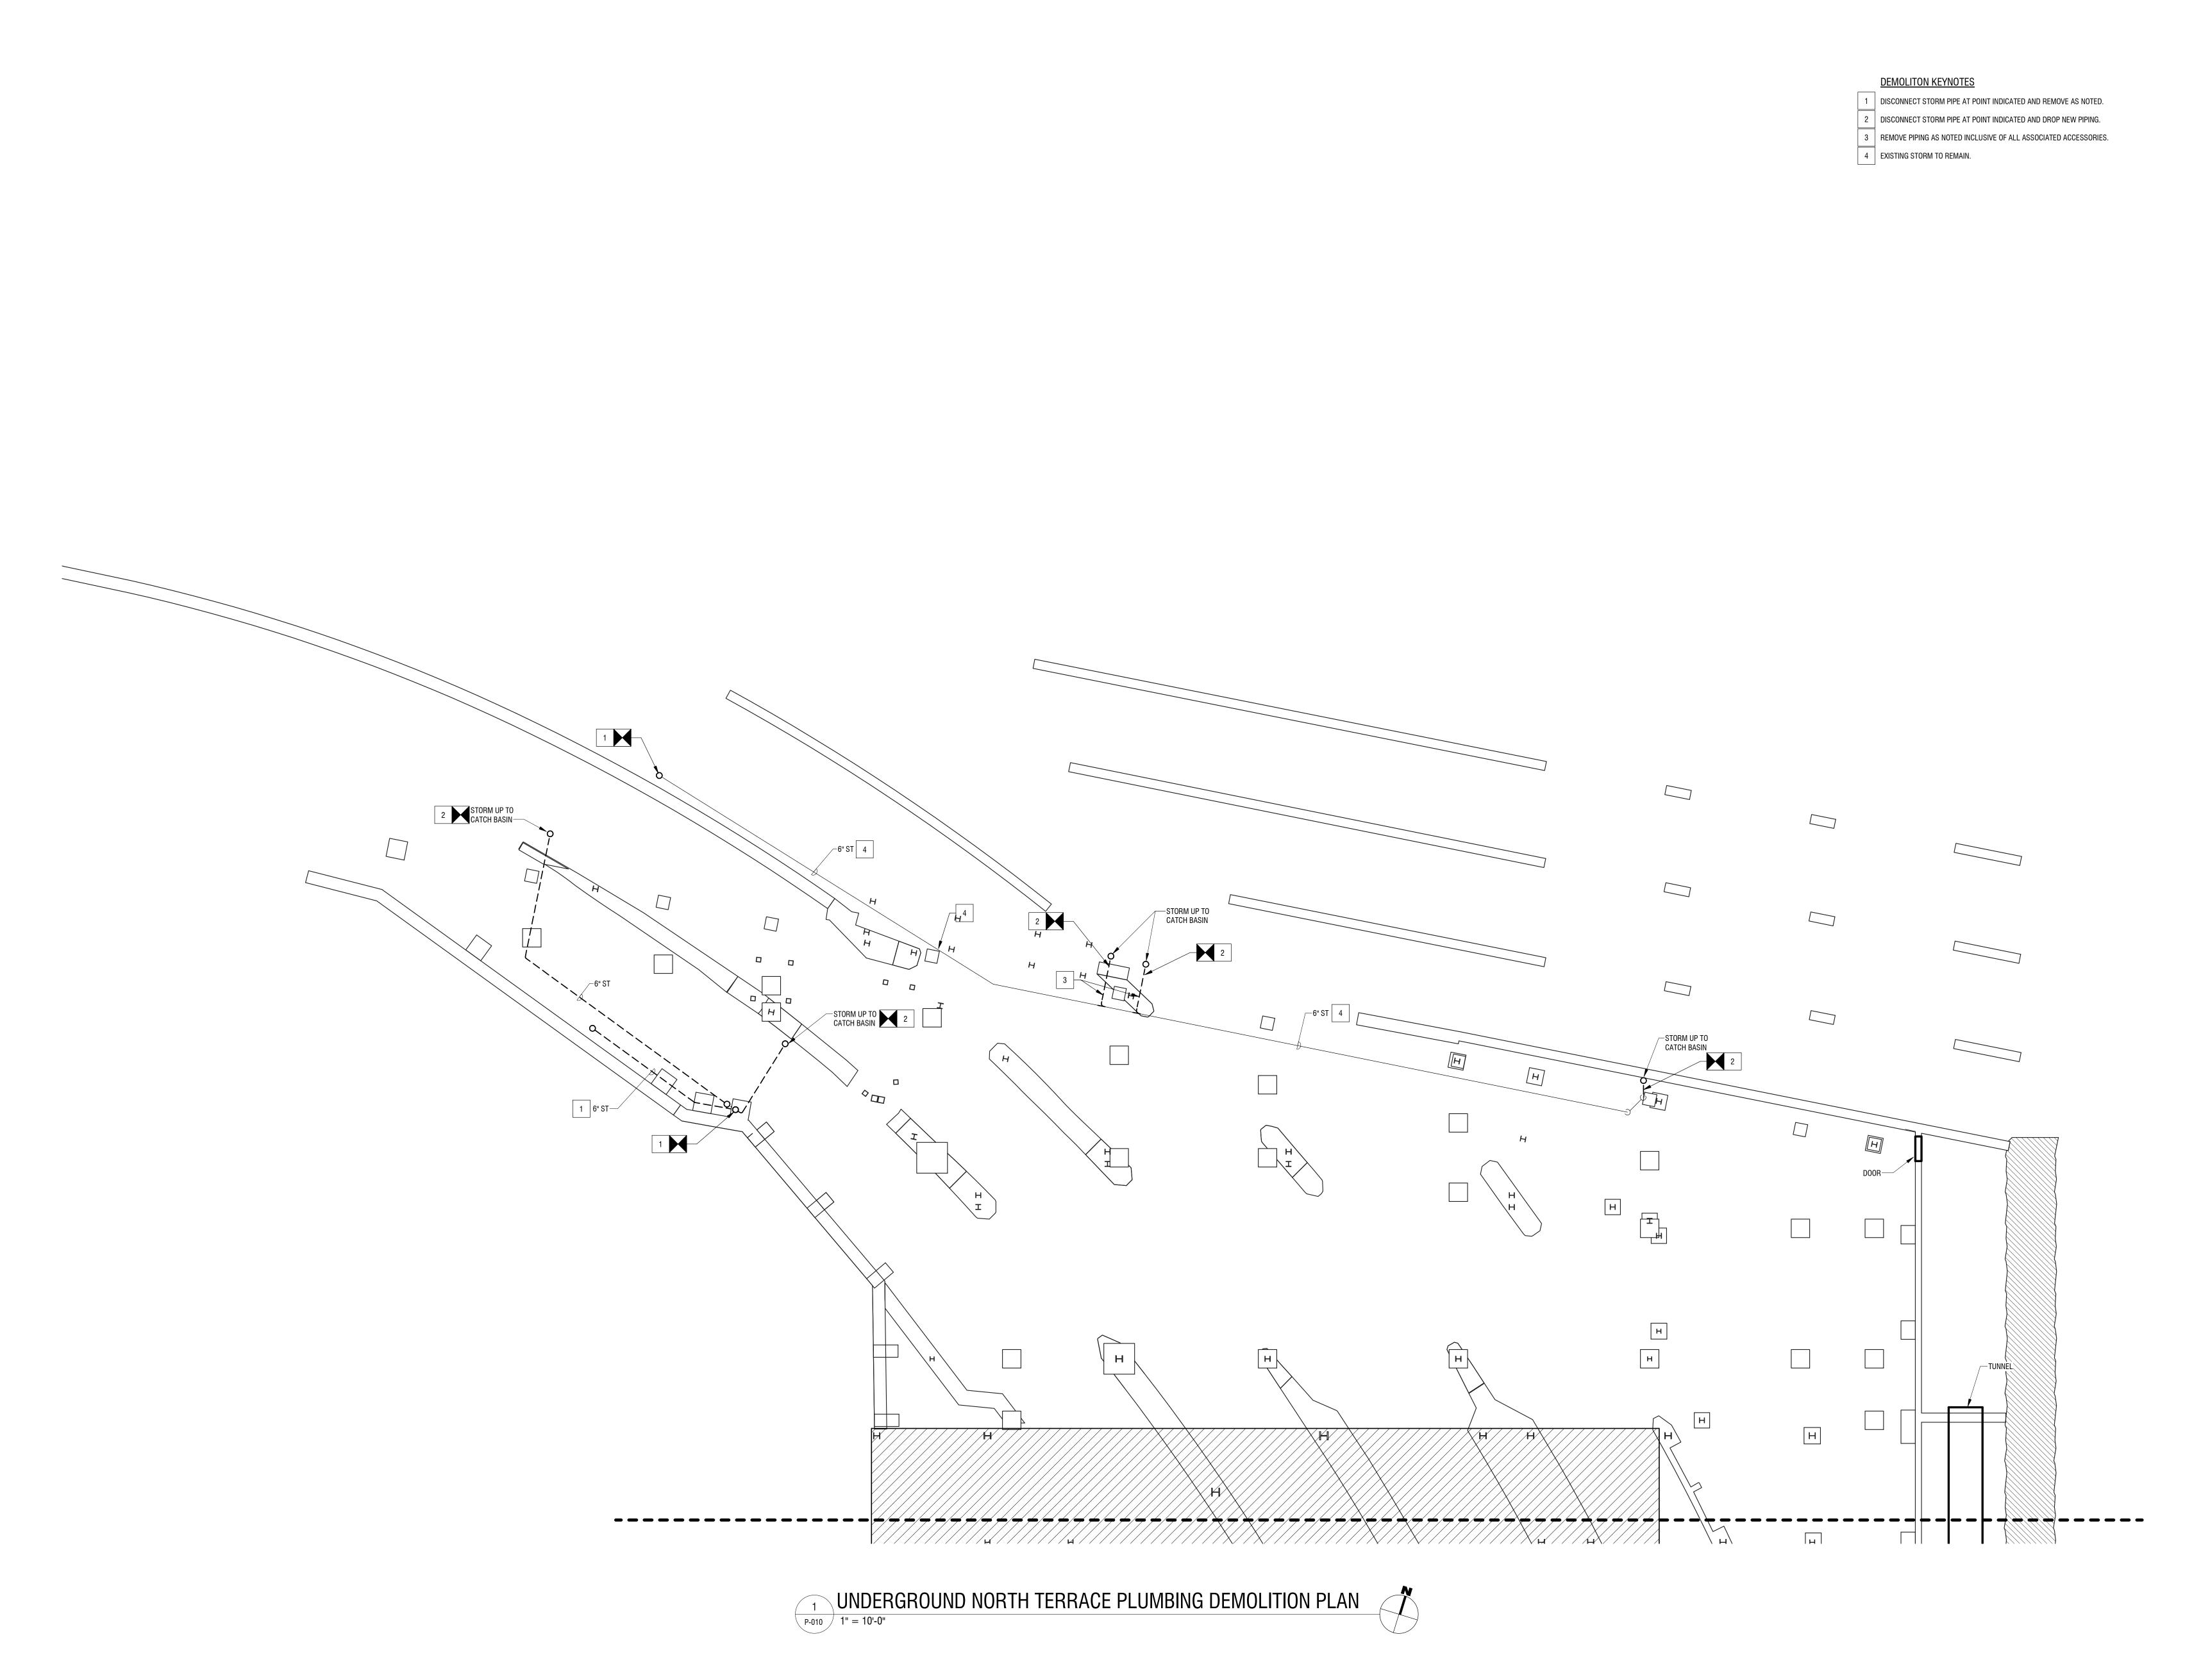
**RUNDEL LIBRARY PHASE IV** 114 SOUTH AVE.

ROCHESTER, NY 14614

DESCRIPTION: Revisions PROJECT NUMBER: 2170391 REVIEWED BY: 35% PRELIMINARY DESIGN

PLUMBING LEGEND SHEET

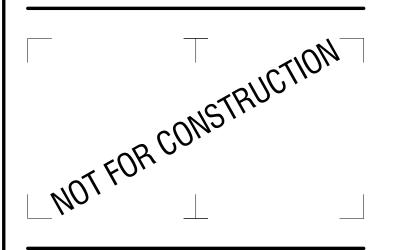
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PROJECT NUMBER:

2170391

DRAWN BY:

MJB

REVIEWED BY:

DWM

ISSUED FOR:

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DATE:

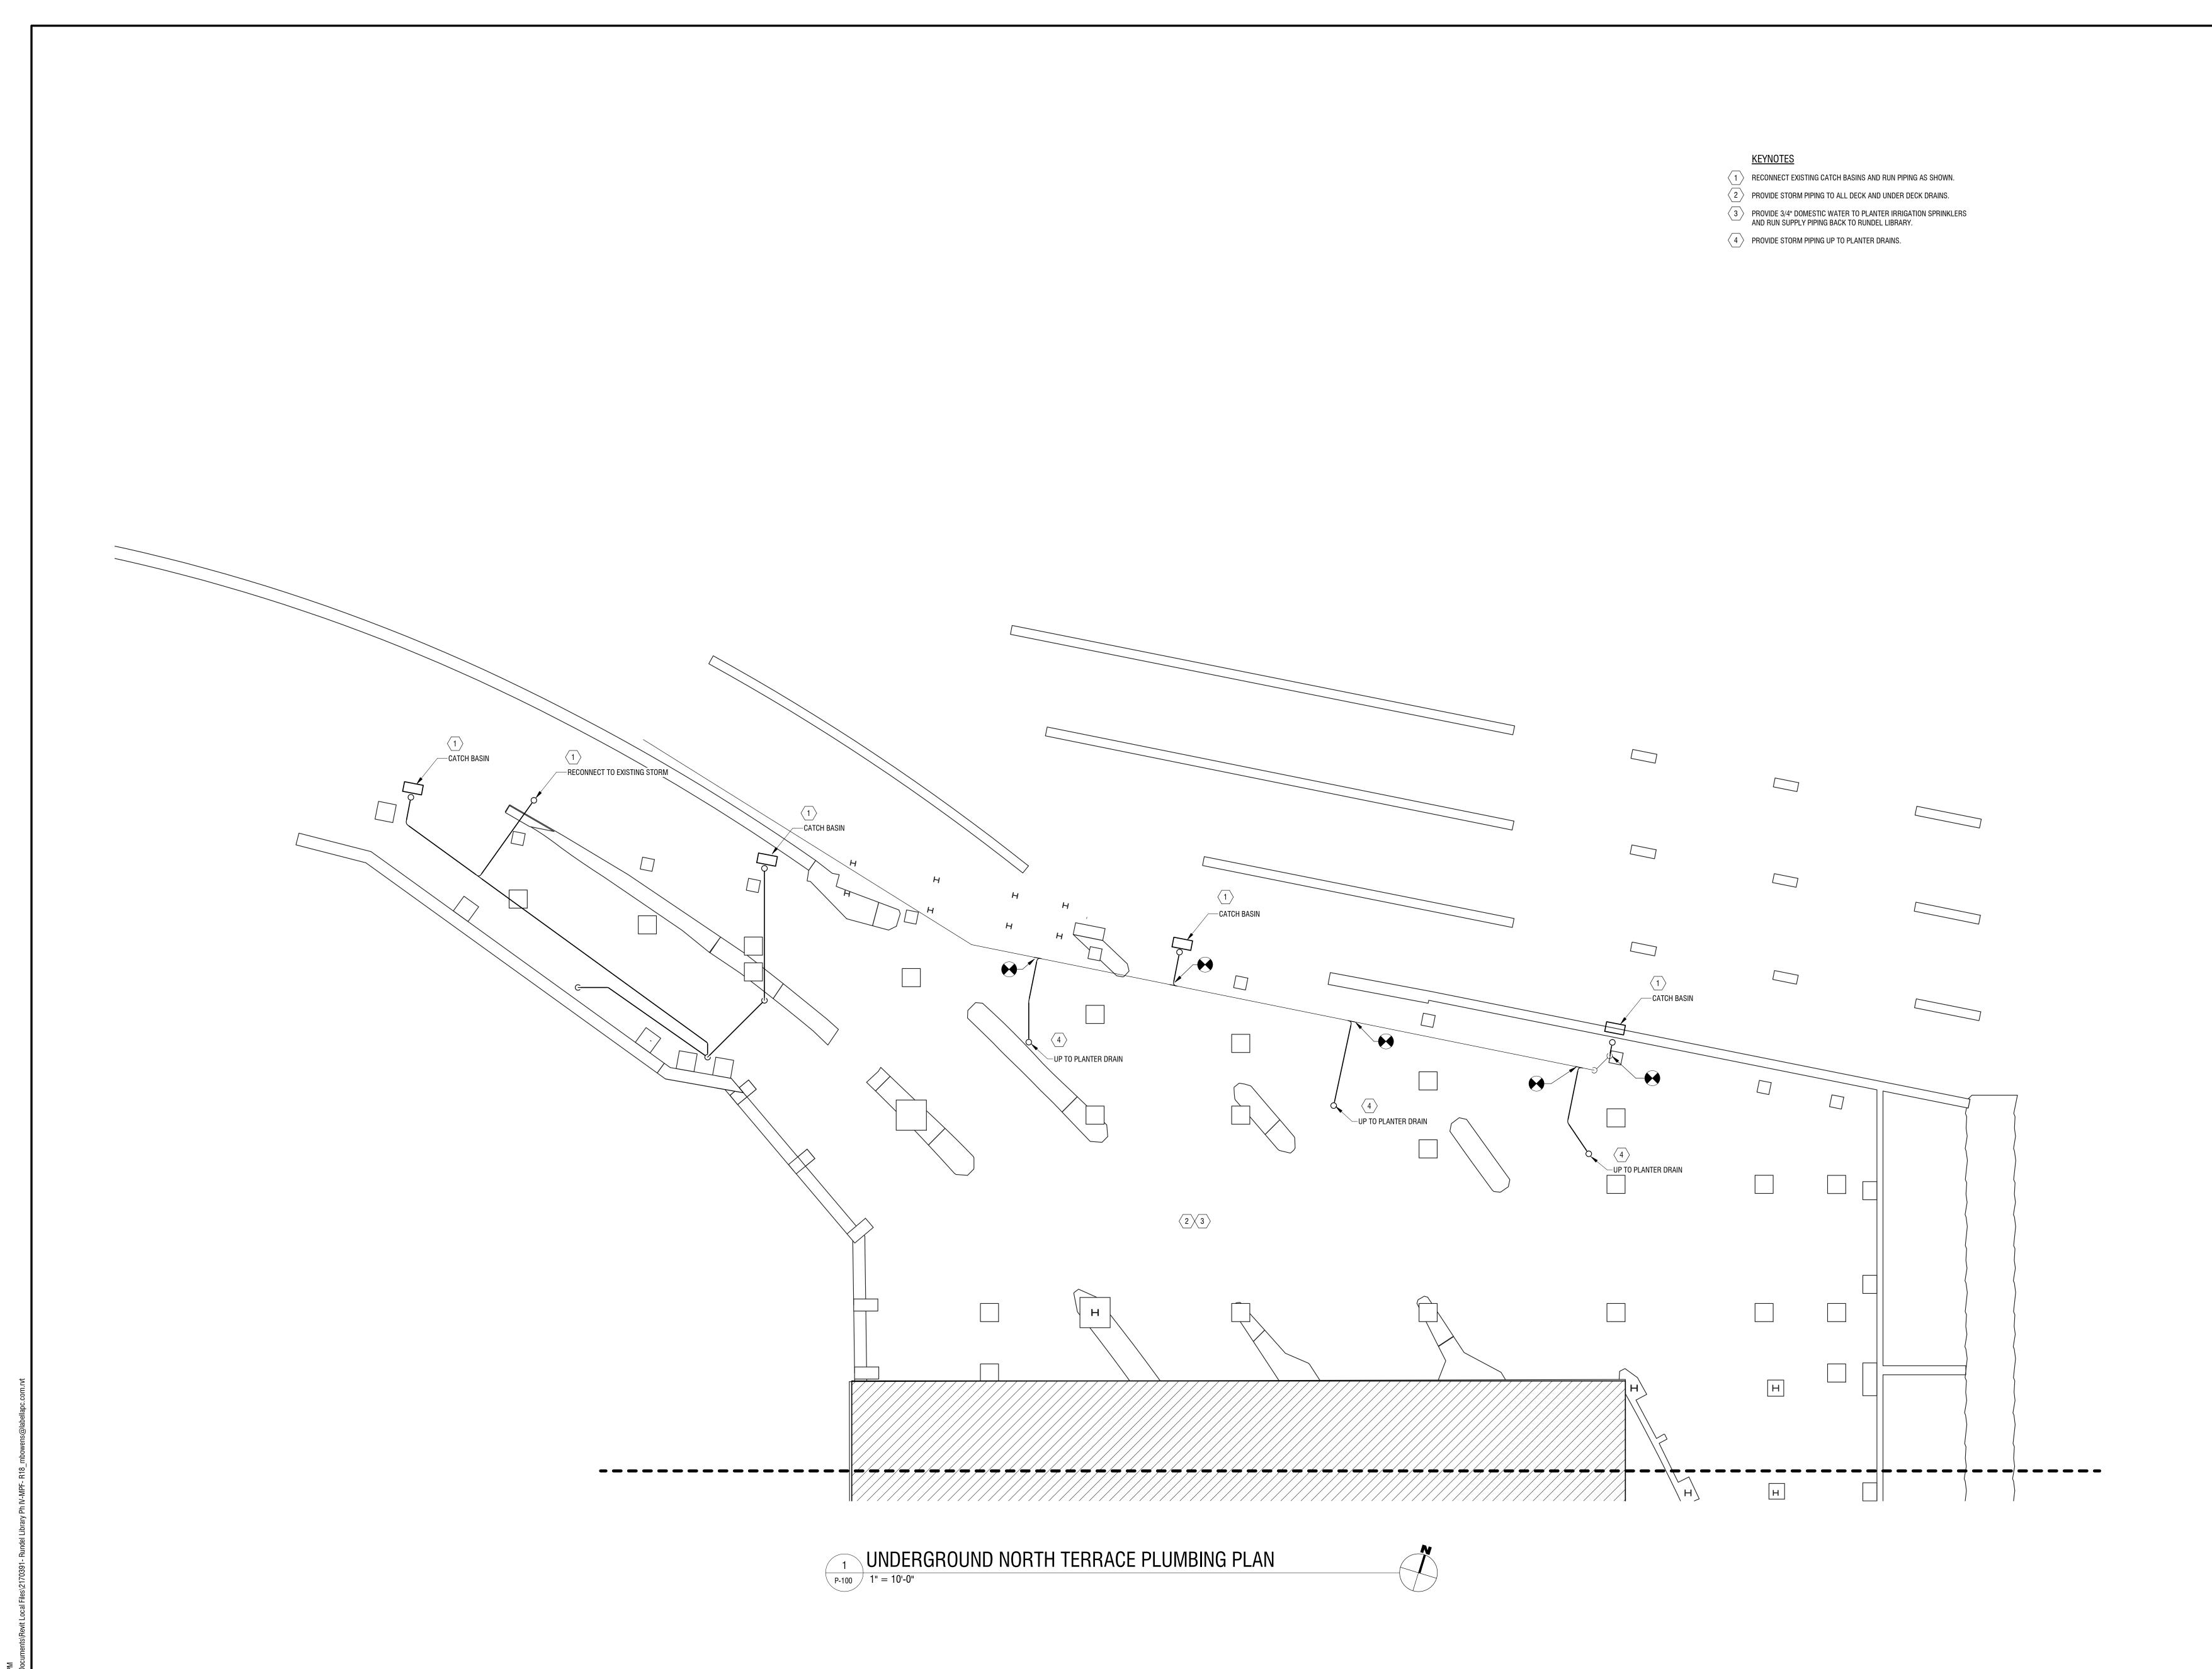
JULY 2018

DRAWING NAME:

UNDERGROUND NORTH TERRACE PLUMBING DEMOLITION PLAN

DRAWING NUMBER:

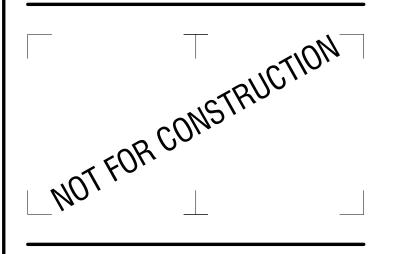
P-010





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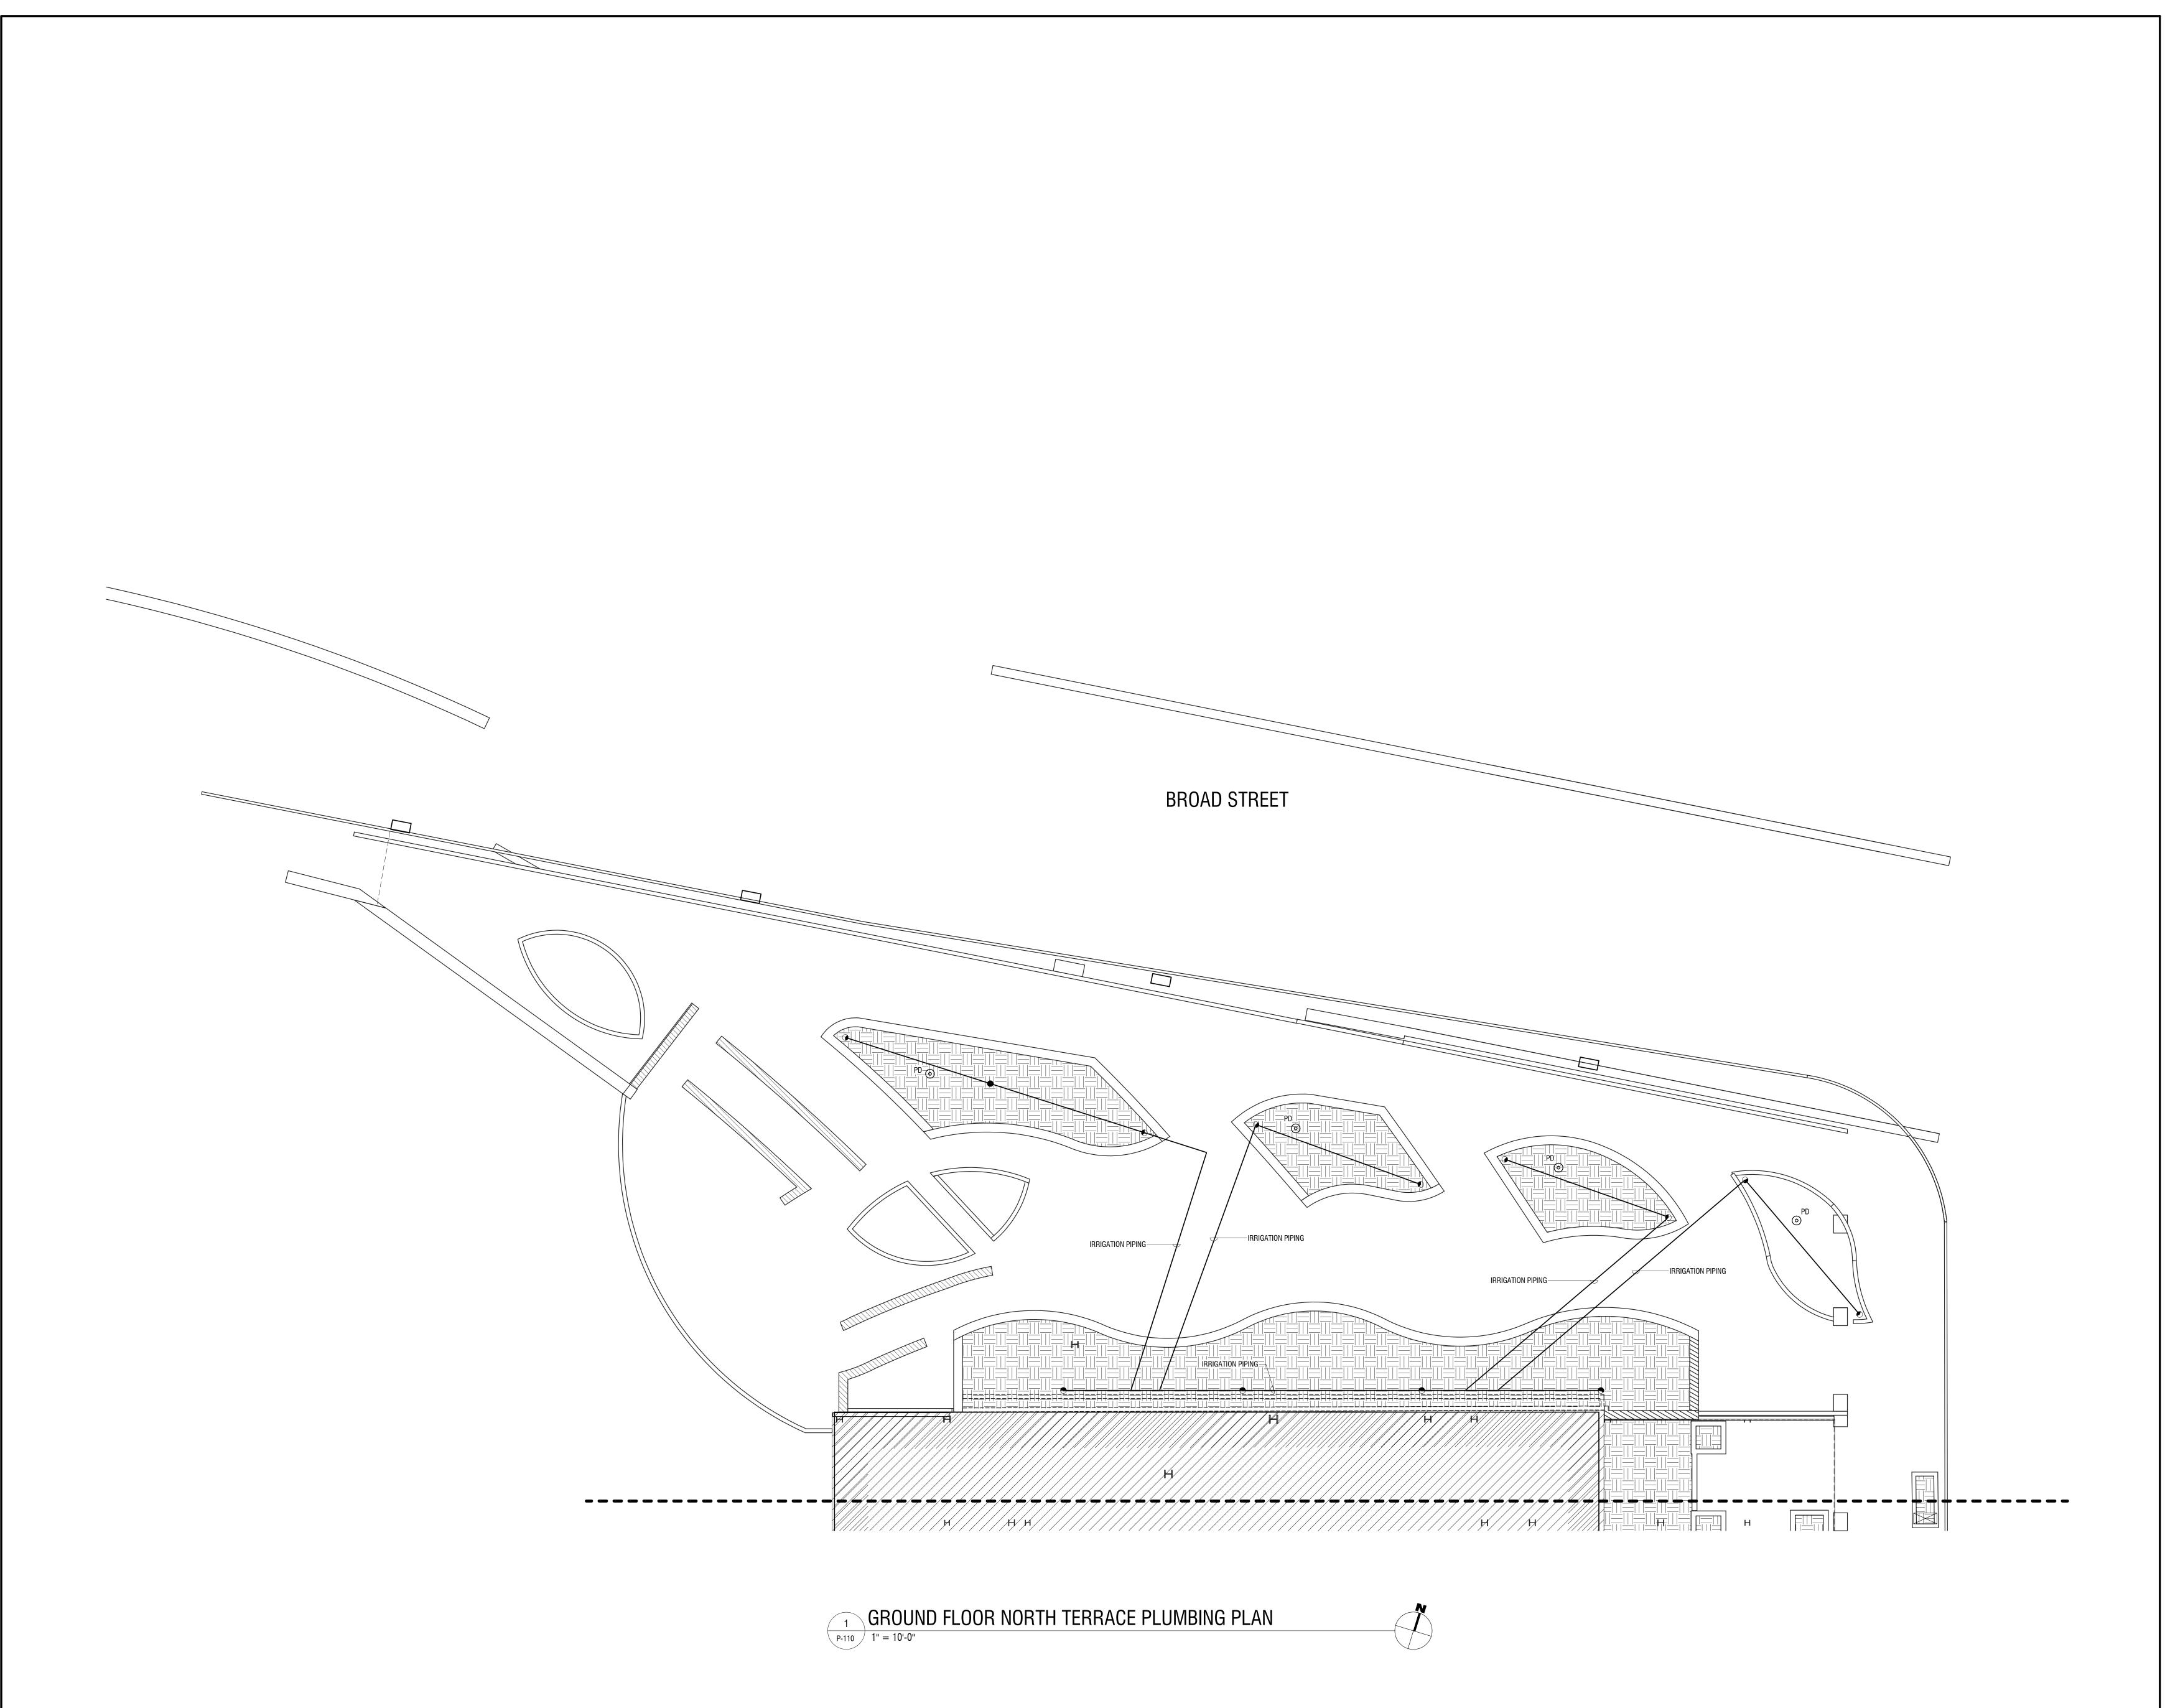
114 SOUTH AVE. ROCHESTER, NY 14614

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DRAWN BY:		MJB
REVIEWED E	3Y:	DWM
ISSUED FOF	==	RELIMINARY DESIGN
DATE:		JULY 2018

UNDERGROUND NORTH TERRACE PLUMBING PLAN

DRAWING NUMBER:

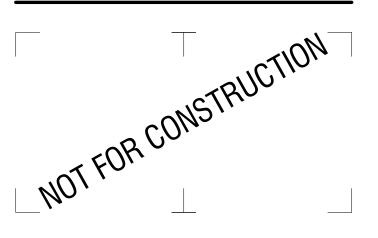
P-100





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PROJECT NUMBER:

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DRAWN BY: MJB

REVIEWED BY: DWM

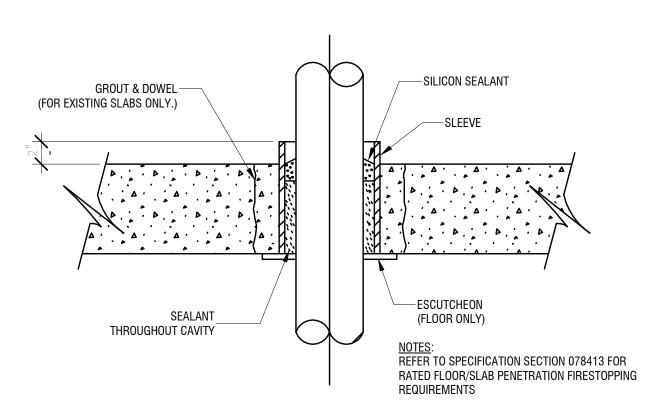
SUED FOR:
35% PRELIMINARY DESIGN

JULY 201

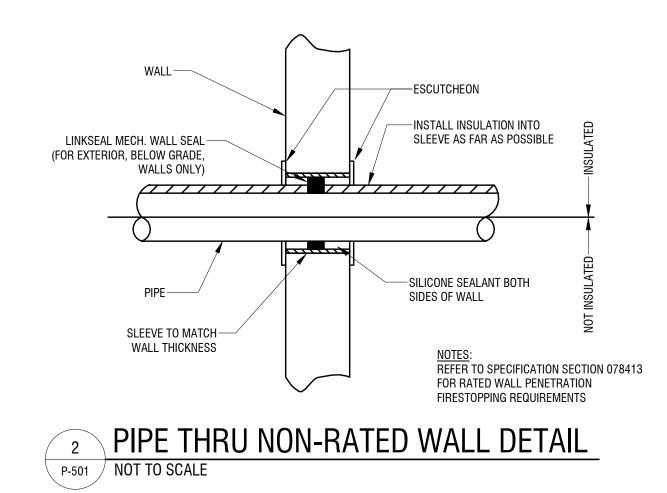
GROUND FLOOR NORTH TERRACE PLUMBING PLAN

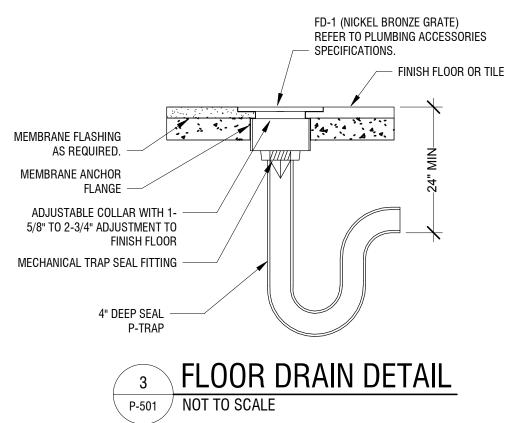
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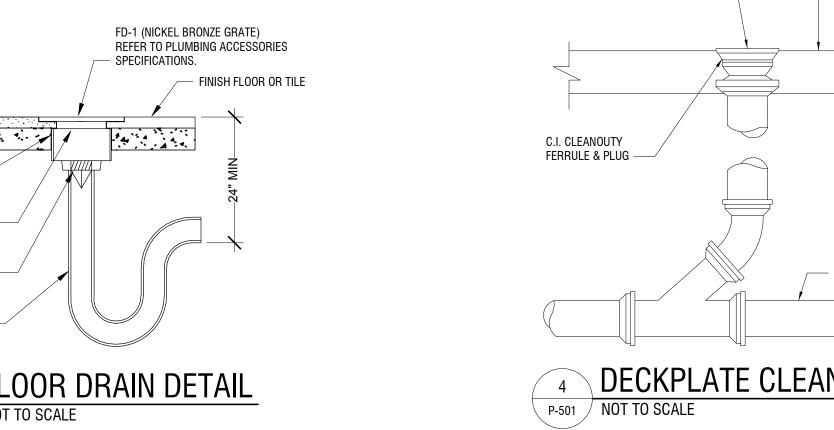
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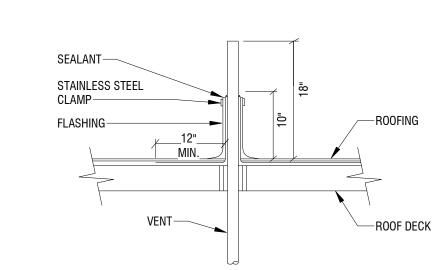


PIPE THRU FLOOR/SLAB DETAIL P-501 NOT TO SCALE

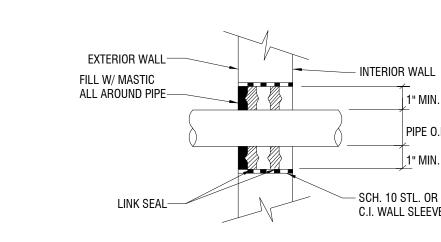




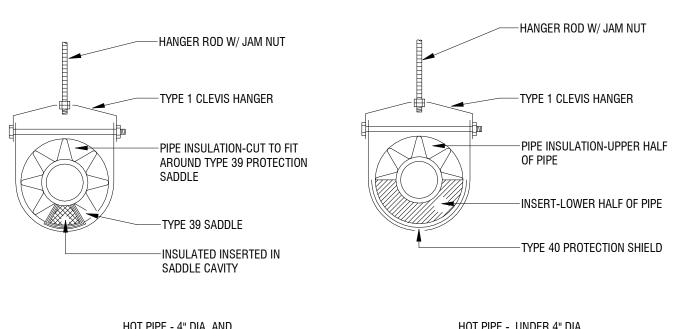




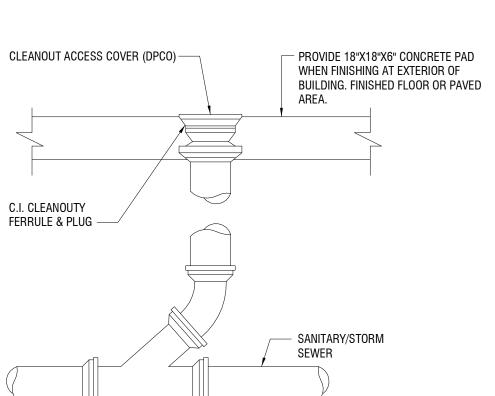
5 VENT THROUGH ROOF DETAIL
P-501 NOT TO SCALE



6 EXTERIOR/FOUNDATION WALL SLEEVE DETAIL
P-501 NOT TO SCALE



HOT PIPE - 4" DIA. AND LARGER (60 F & HIGHER) HOT PIPE - UNDER 4" DIA. COLD PIPE - ALL SIZES 7 PIPE HANGER WITH INSULATION DETAIL
P-501 NOT TO SCALE



4 DECKPLATE CLEANOUT

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Rochester, NY 14614

19 North Main Street

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**CITY OF ROCHESTER** 414 ANDREWS ST. ROCHESTER, NY 14604

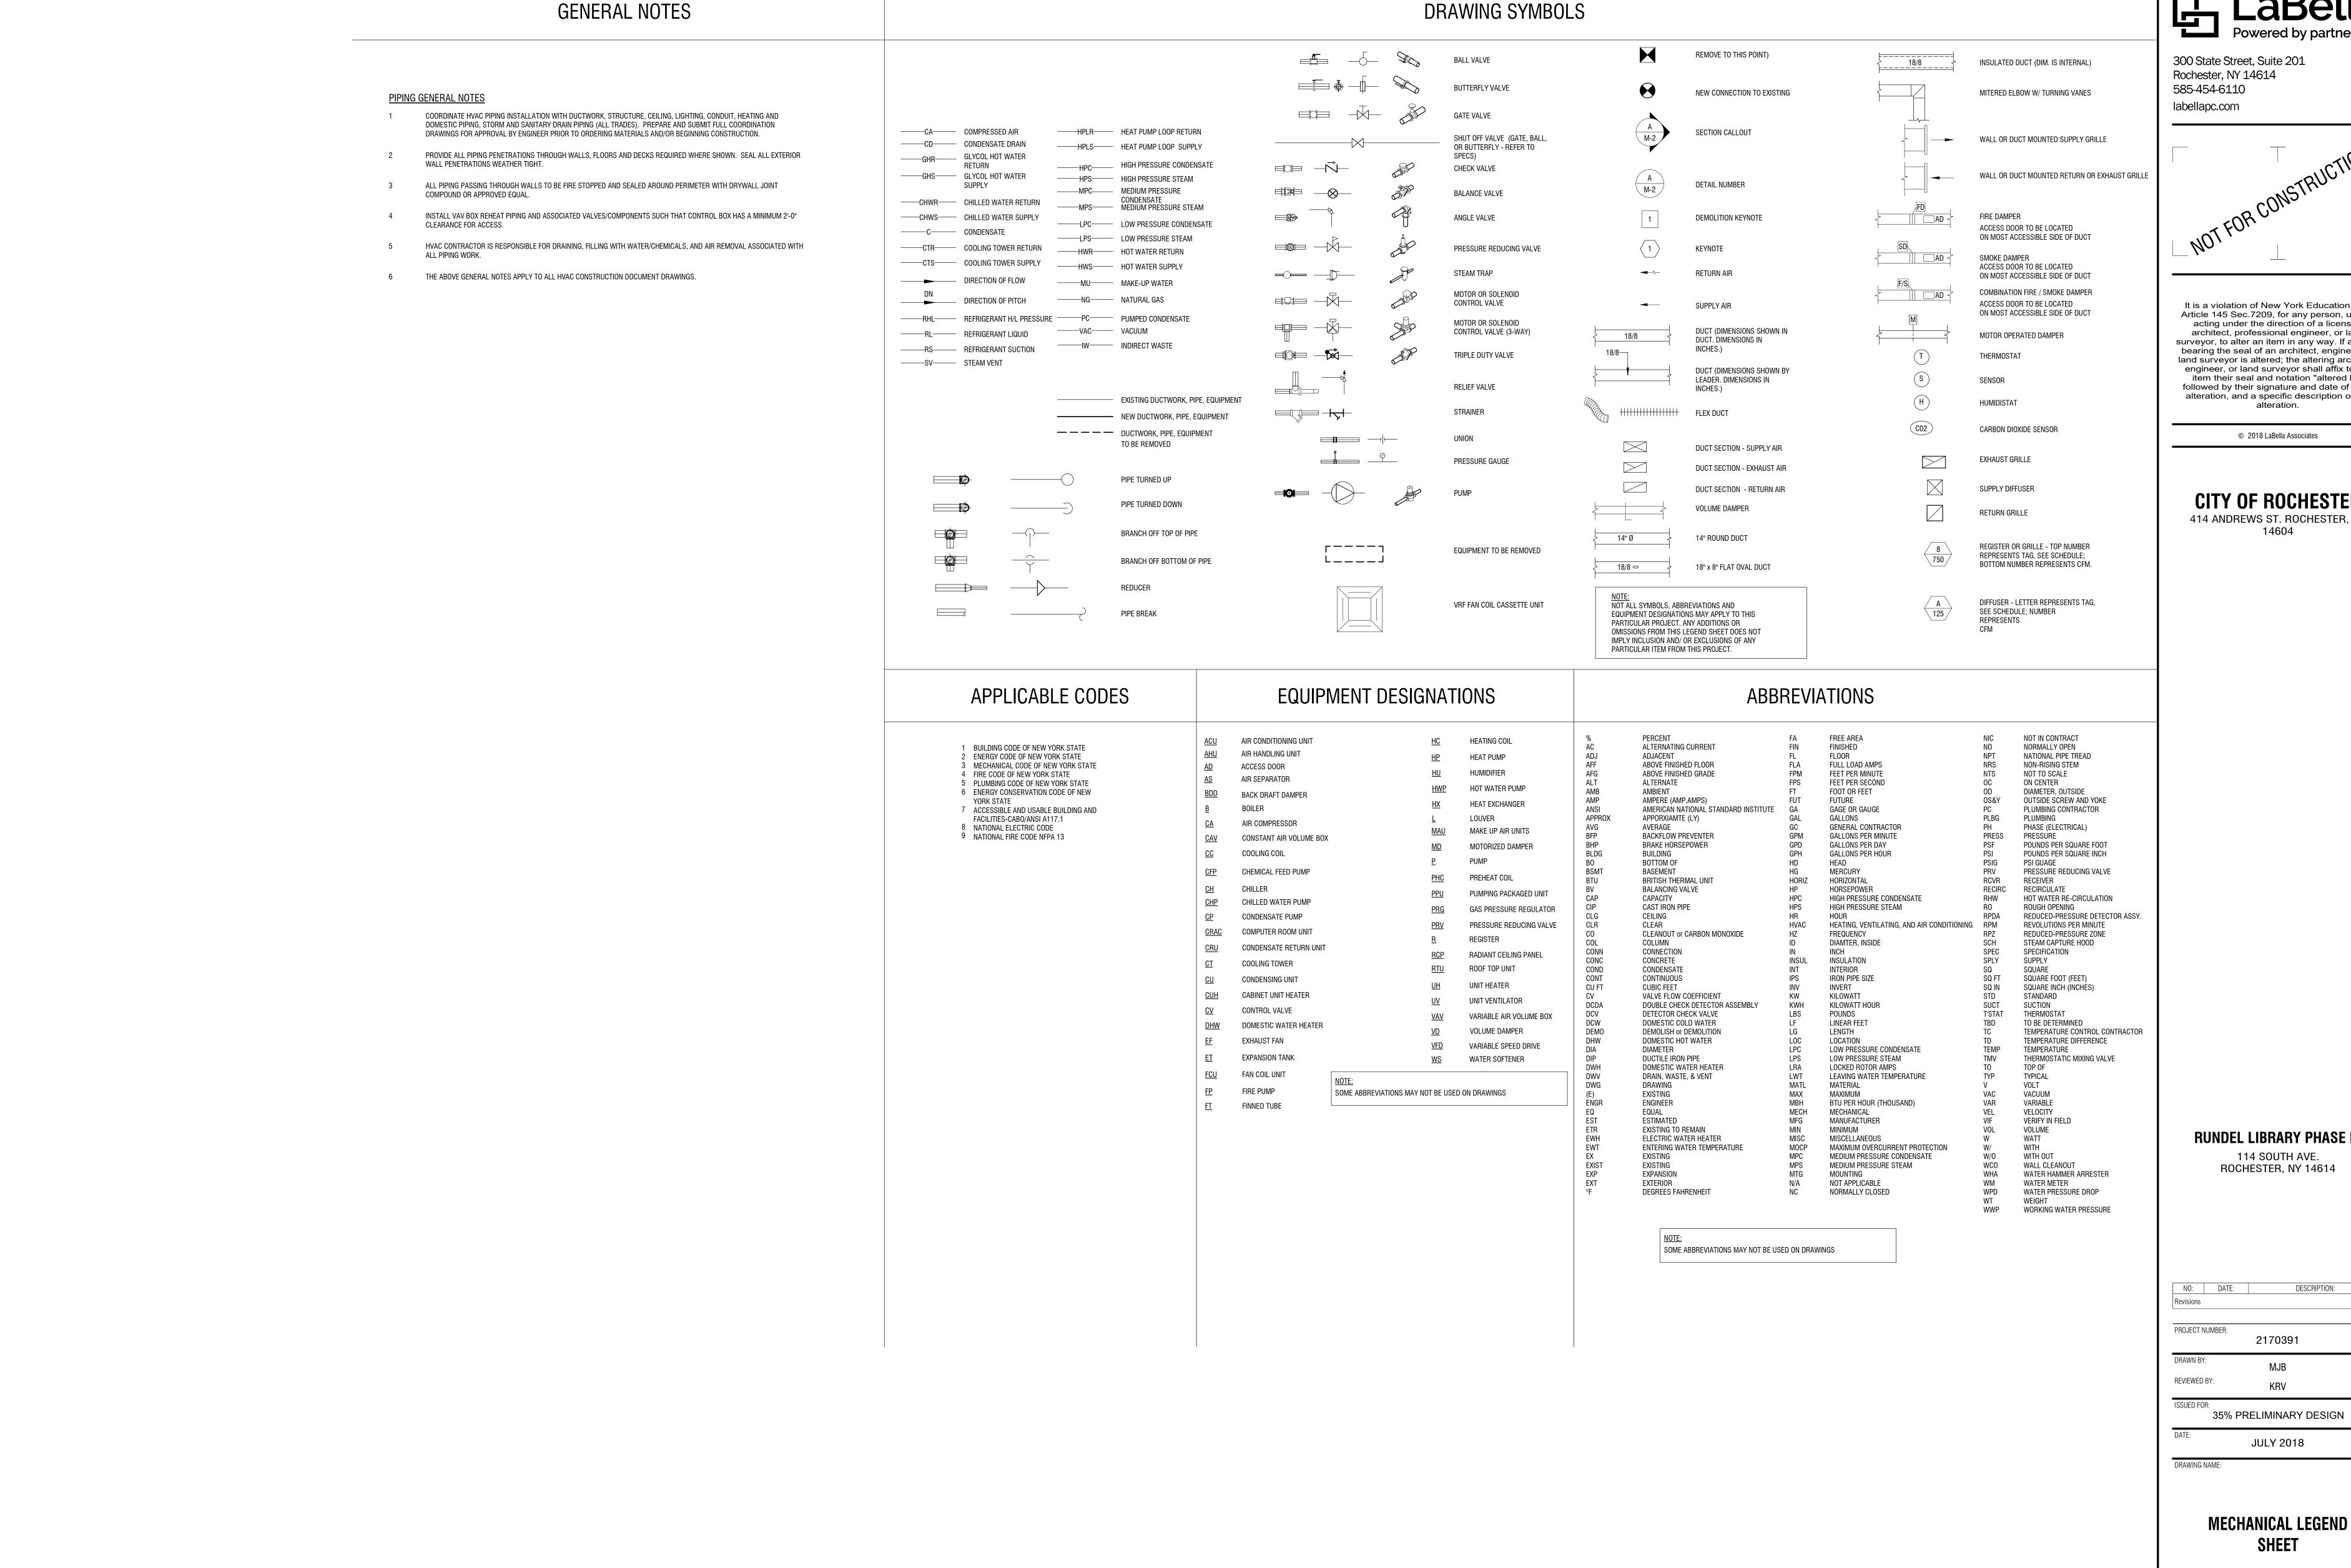
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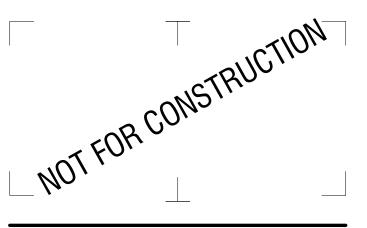
DESCRIPTION: PROJECT NUMBER: 2170391 REVIEWED BY:

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**PLUMBING DETAILS** 



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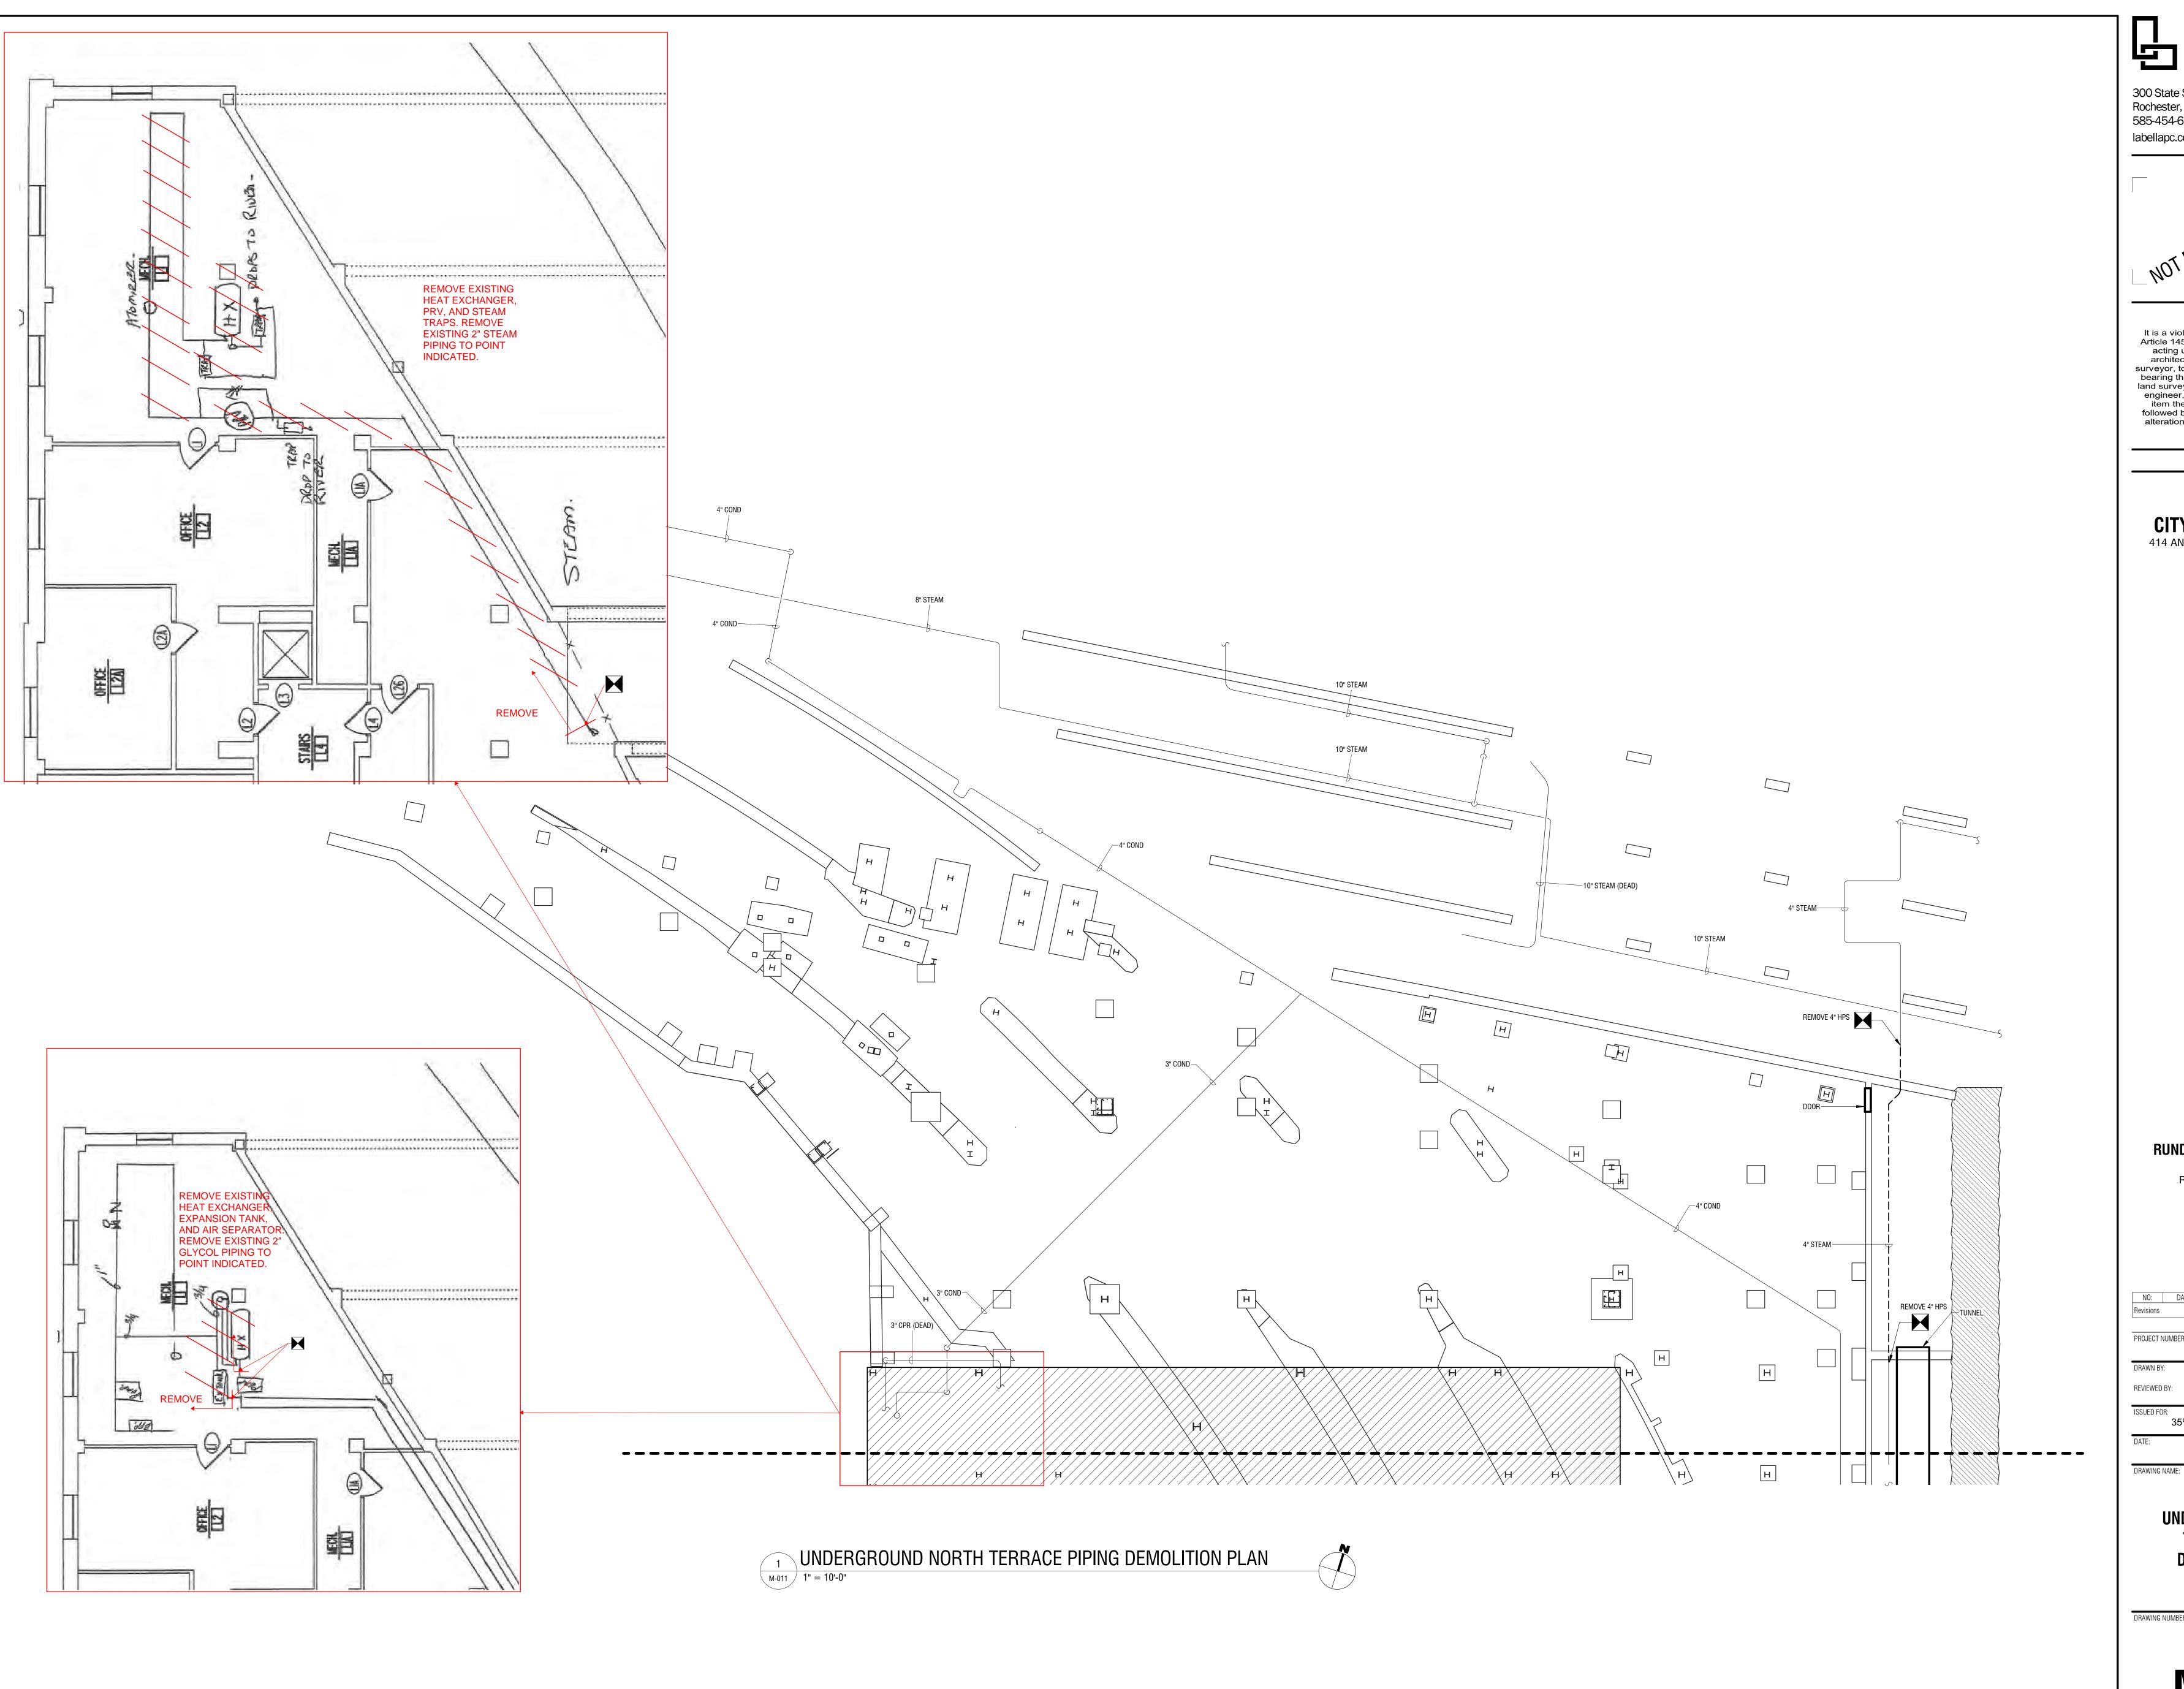


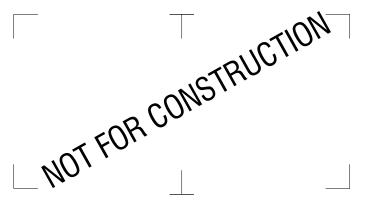
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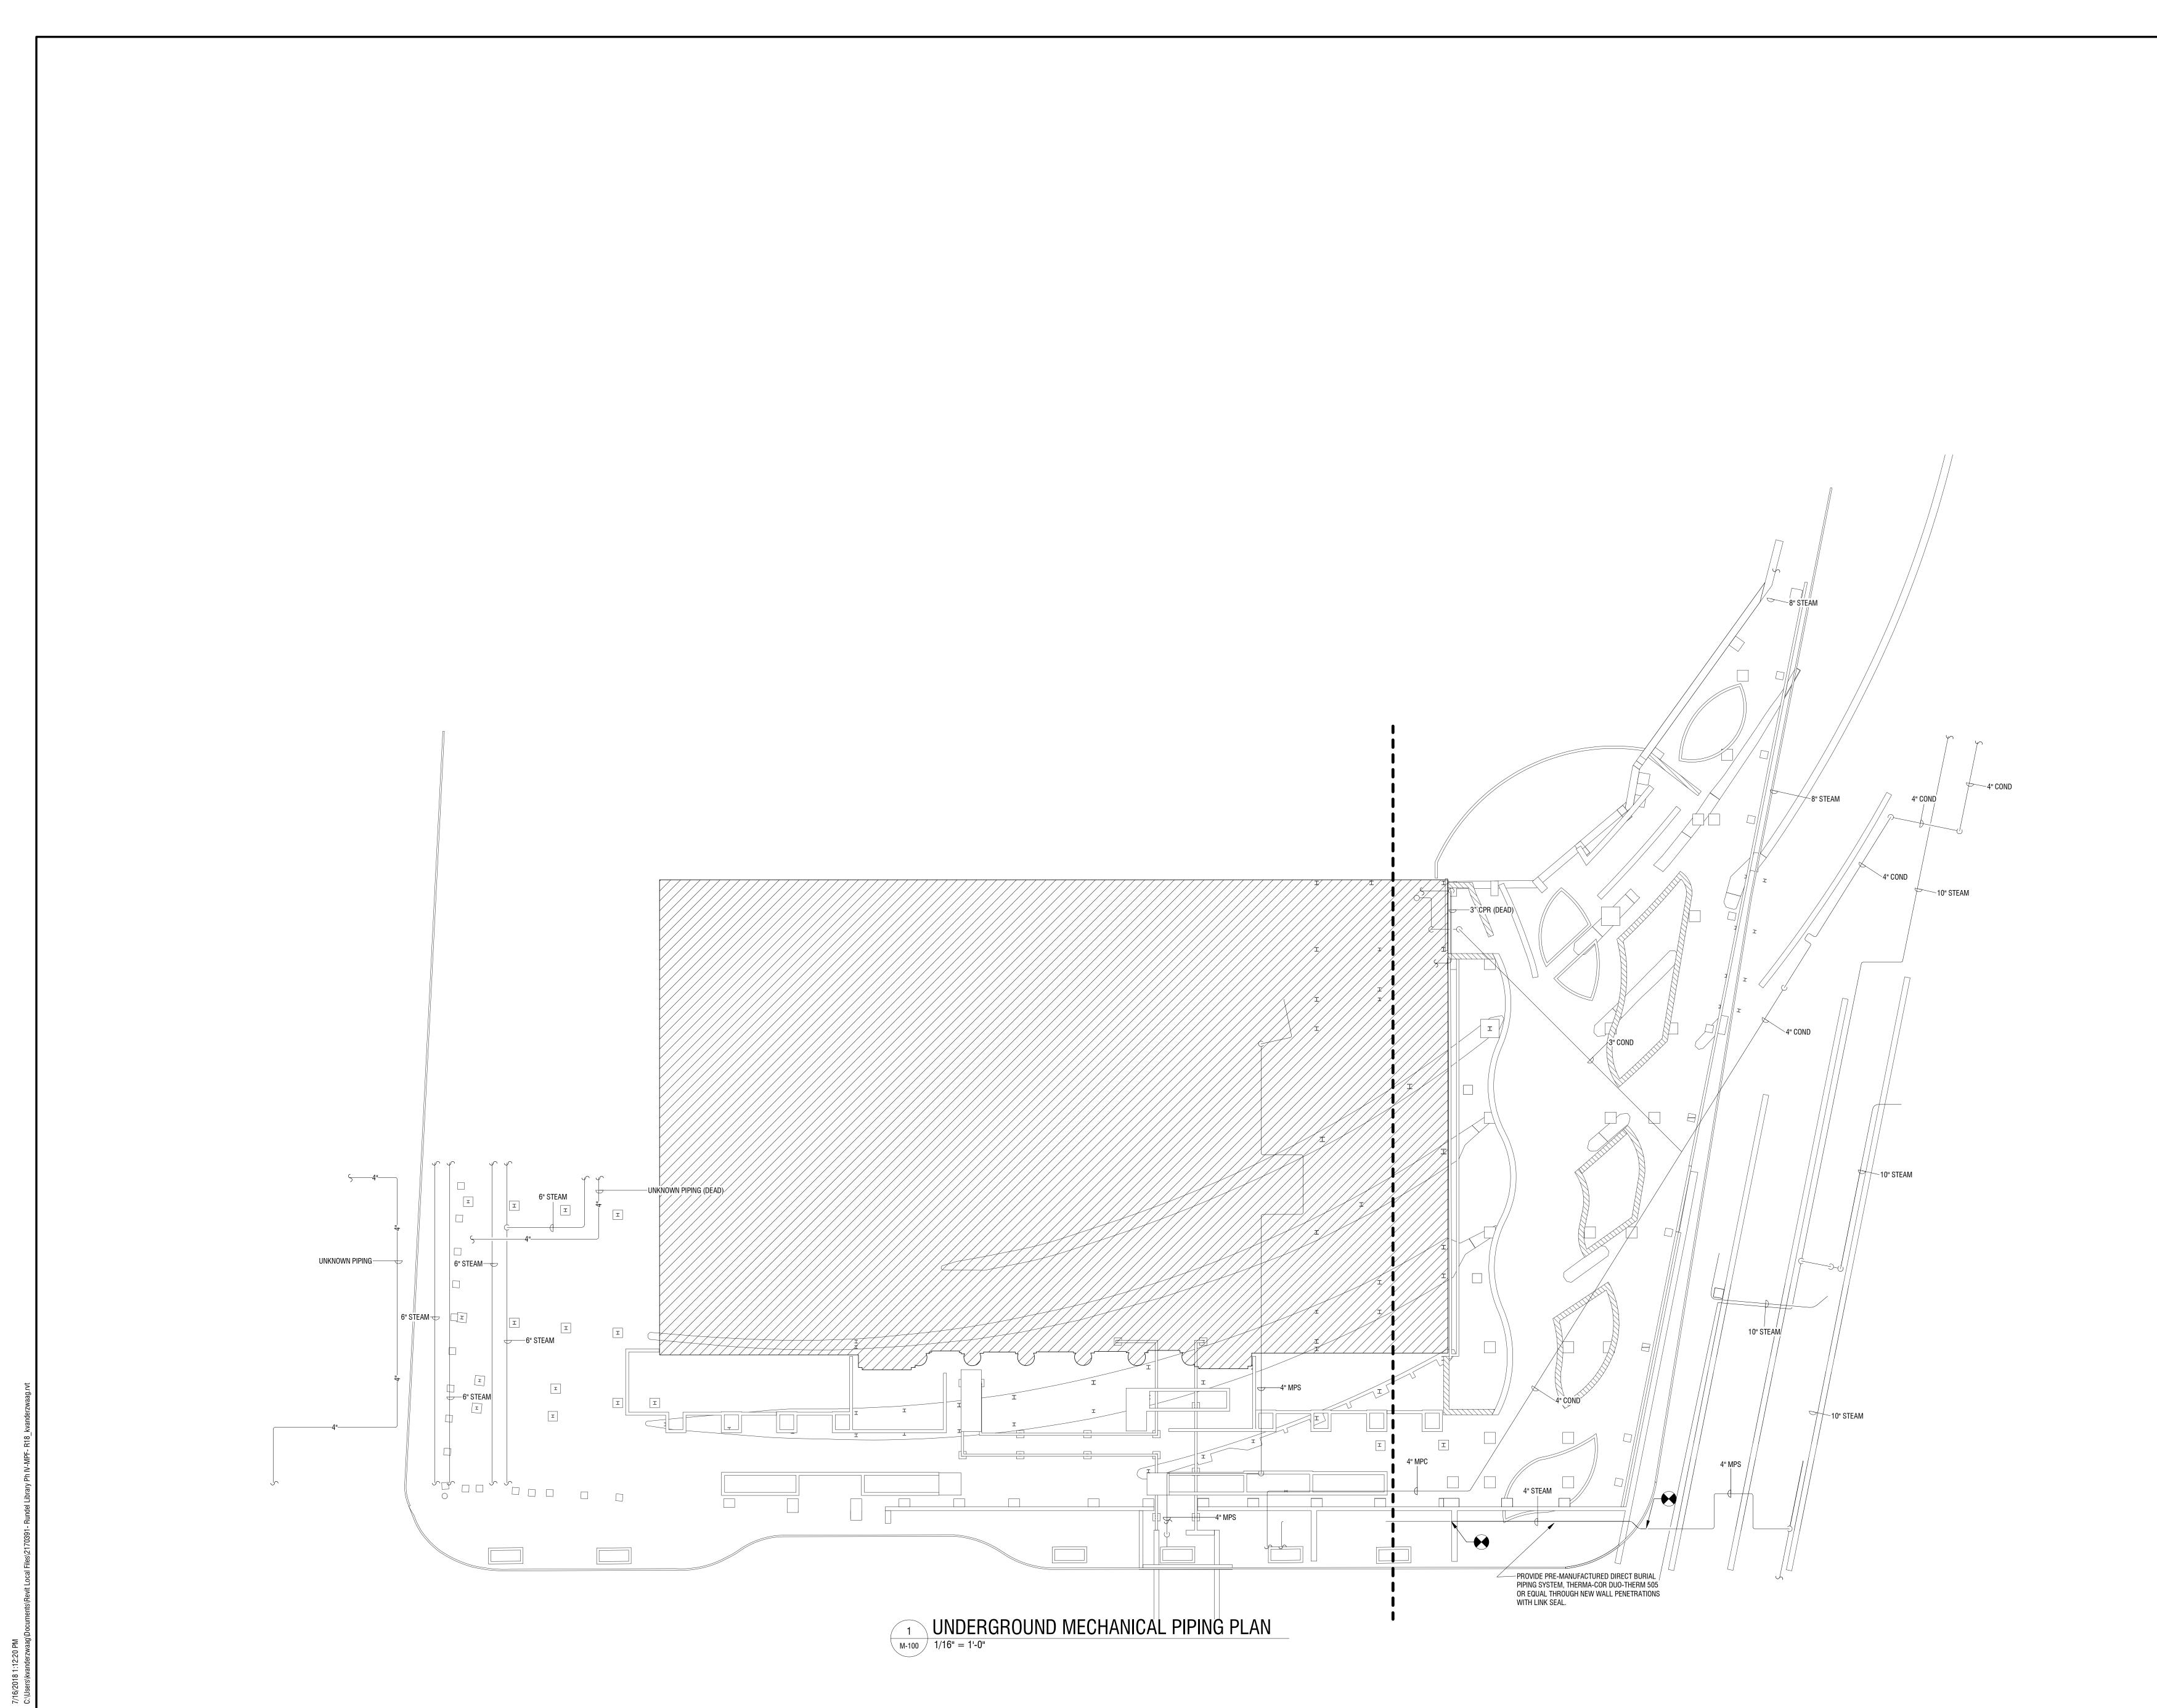
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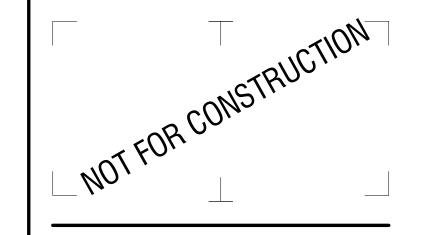
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	5	DECORPTION
NO:	DATE:	DESCRIPTION:
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PROJECT N	IUMBER:	0.1.7000.1
		2170391
DRAWN BY		MJB
		IVIJD
REVIEWED	BY:	KRV
ISSUED FO	• • •	
	35% PF	RELIMINARY DESIGN
DATE:		JULY 2018
		JULI 2010

**UNDERGROUND NORTH TERRACE PIPING DEMOLITION PLAN** 







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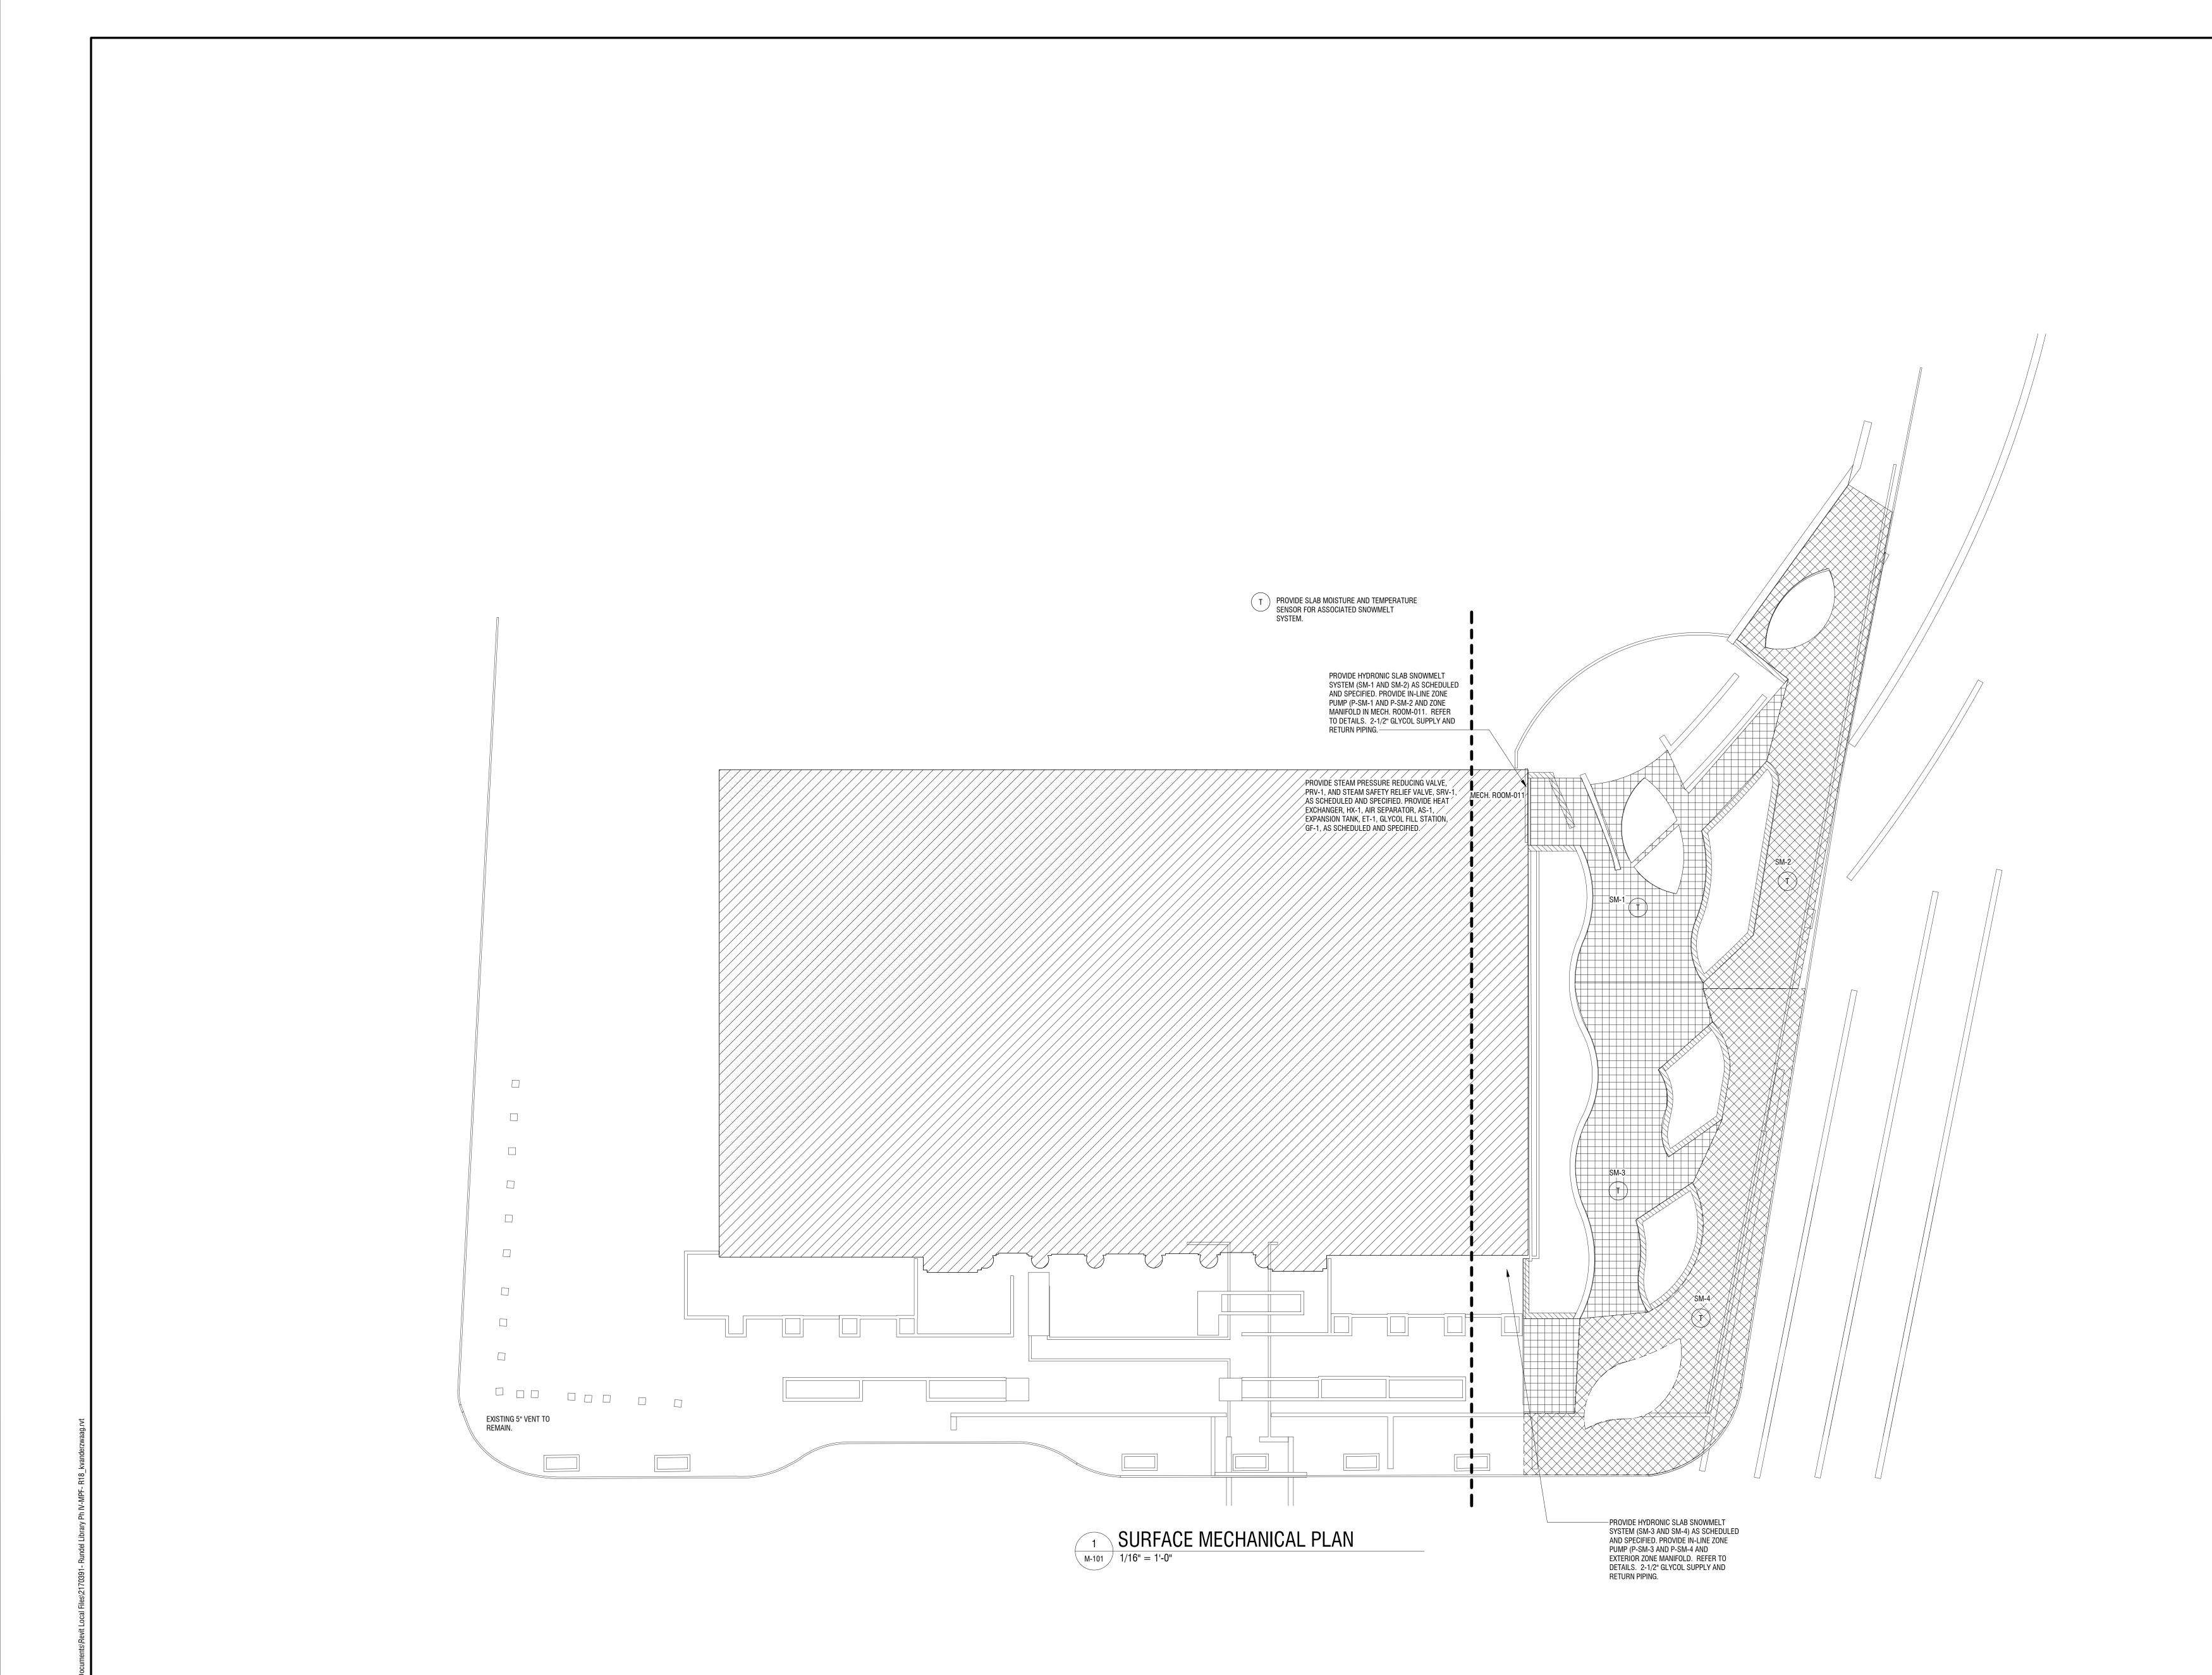
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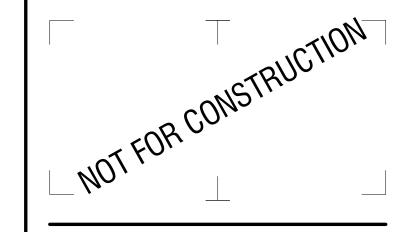
NO:	DATE:	DESCRIPTION:
Revisions		
PROJECT N	UMBER:	2170391
		2170391
DRAWN BY:		MJB
REVIEWED	BY:	
		KV
ISSUED FOR		
	35% PR	RELIMINARY DESIGN
DATE:		JULY 2018
		JULI ZUIO
DRAWING N	JAME:	

UNDERGROUND MECHANICAL PIPING PLAN

DRAWING NUMBER:







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NO: DATE: DESCRIPTION:

Revisions

PROJECT NUMBER:

2170391

DRAWN BY: Author

REVIEWED BY: Approver

ISSUED FOR:

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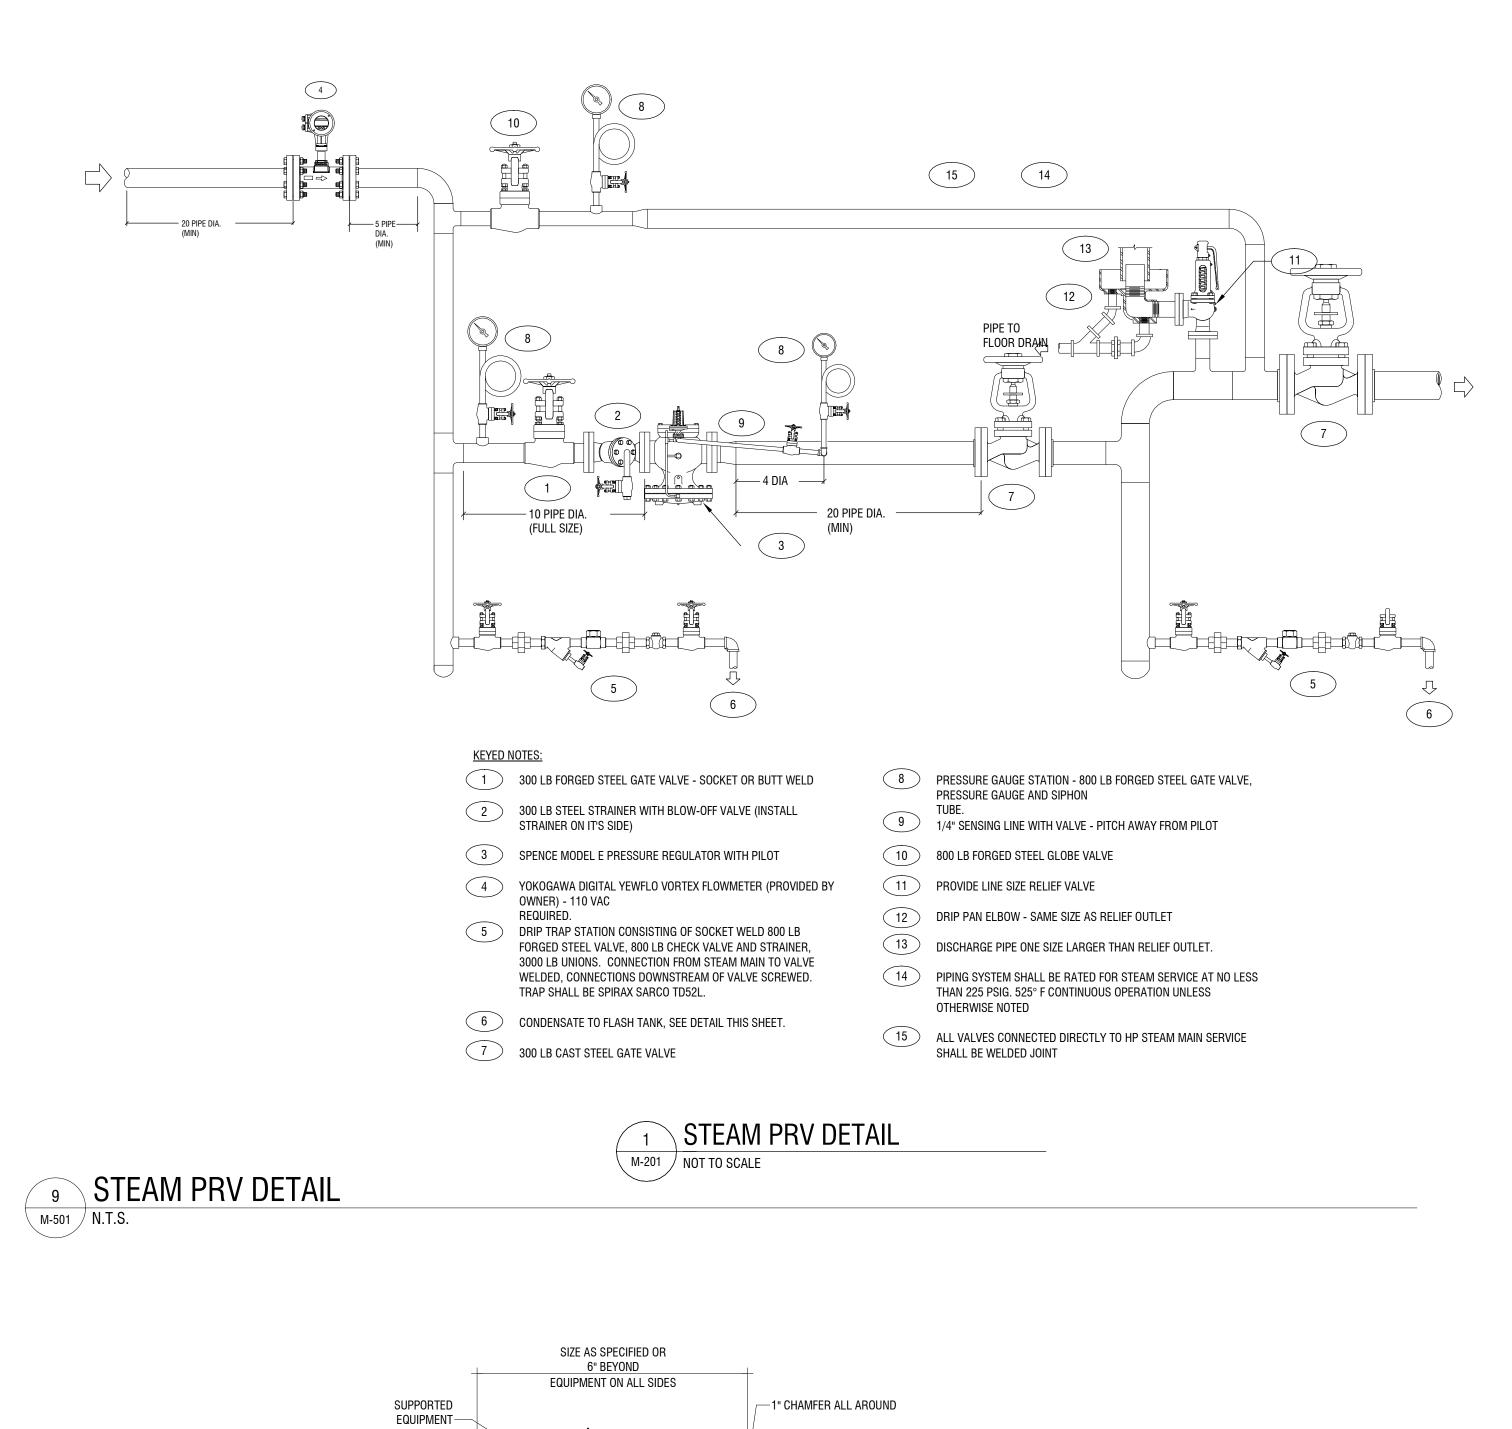
DATE:

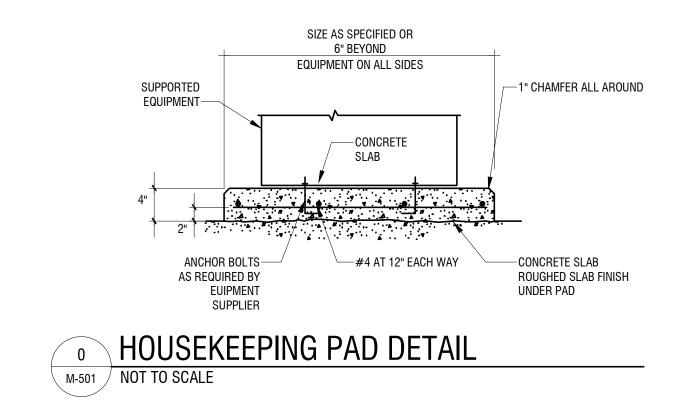
JULY 2018

DRAWING NAME:

SURFACE MECHANICAL

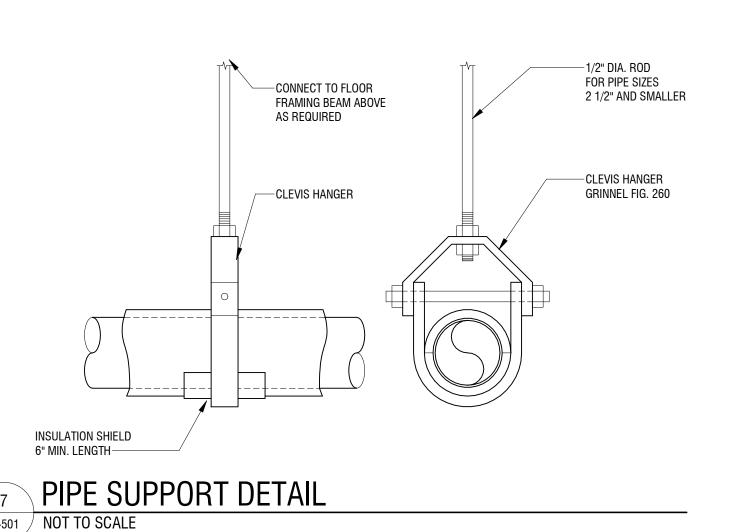
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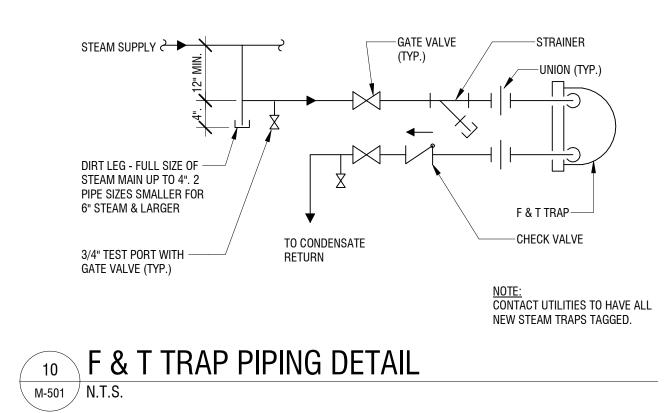


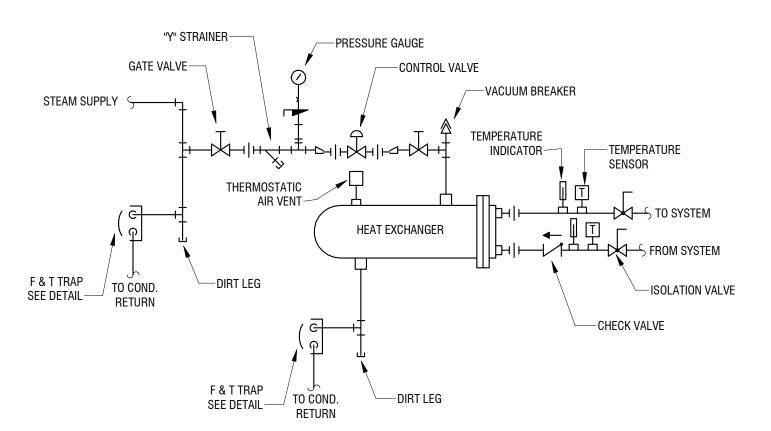


ALL THREAD ROD —NUT (TOP & BOTTOM) -WASHER (TOP & BOTTOM) -CLEVIS HANGER -INSULATION — INSULATION PROTECTIVE SHEETMETAL SHIELD

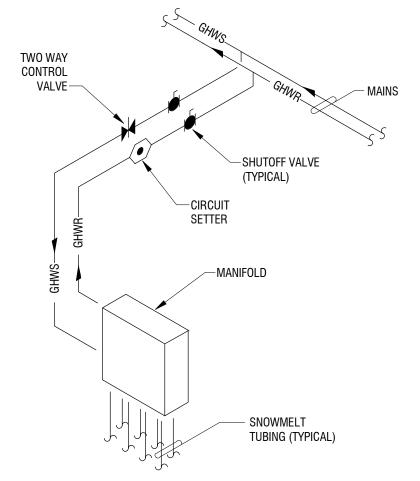
#### 8 PIPE CLEVIS HANGER DETAIL M-501 NOT TO SCALE



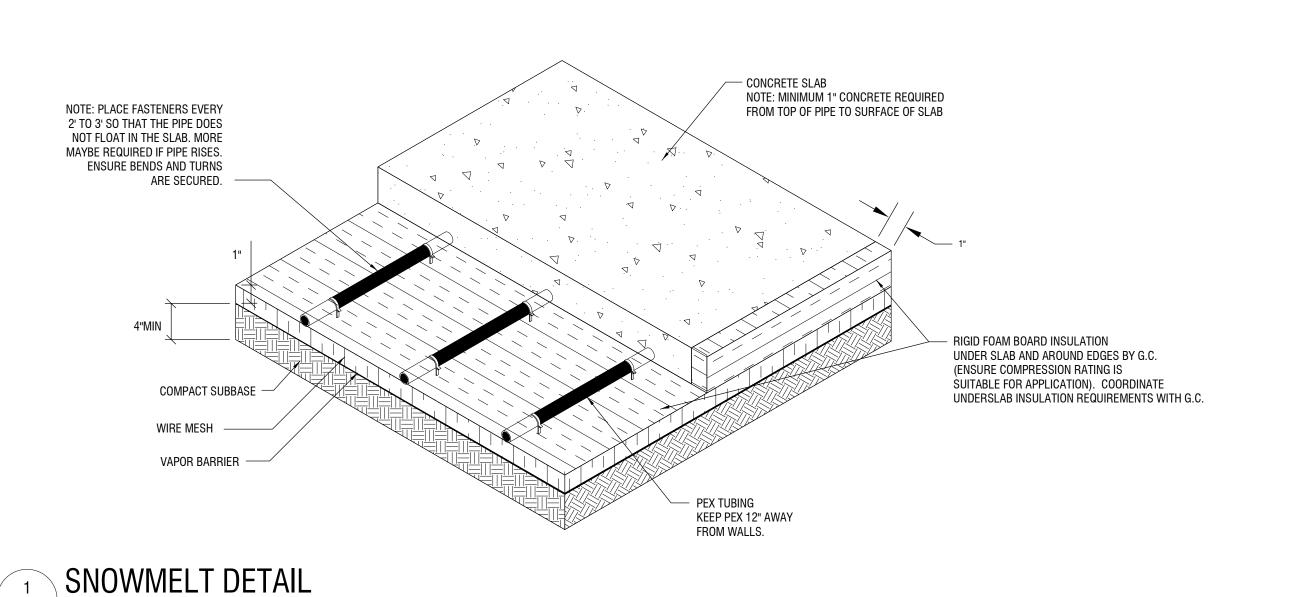


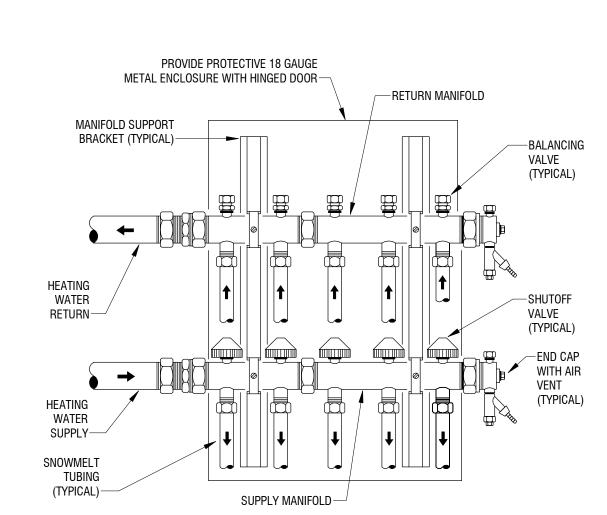


#### 6 SHELL AND TUBE HEAT EXCHANGER PIPING DETAIL M-501 12" = 1'-0"

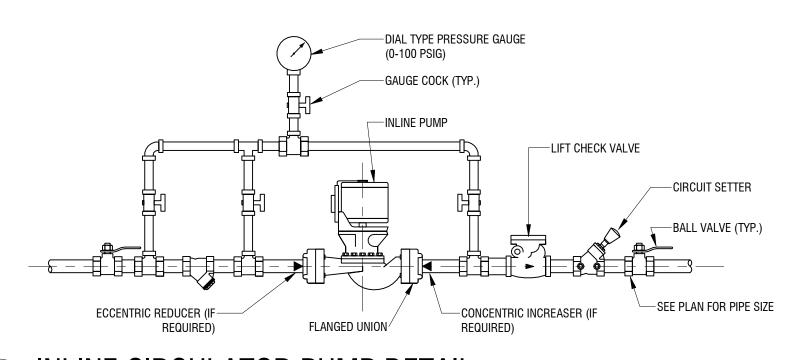


# 5 SNOWMELT HEATING MANIFOLD PIPING DETAIL M-501 1/8" = 1'-0"

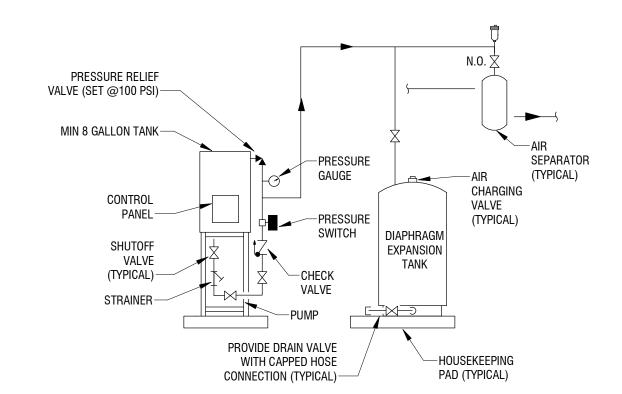




#### SNOWMELT TUBING MANIFOLD DETAIL 4 SNOW! M-501 1/8" = 1'-0"



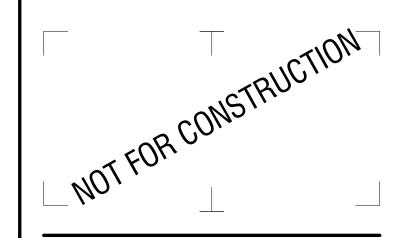
3 INLINE CIRCULATOR PUMP DETAIL
M-501 N.T.S.



2 GLYCOL FEED SYSTEM/EXP. TANK DETAIL

M-501 1" = 10'-0"

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**RUNDEL LIBRARY PHASE IV** 

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DESCRIPTION: Revisions PROJECT NUMBER: 2170391 DRAWN BY: REVIEWED BY: ISSUED FOR: 35% PRELIMINARY DESIGN

**MECHANICAL DETAILS** 

DRAWING NUMBER:

DRAWING NAME:

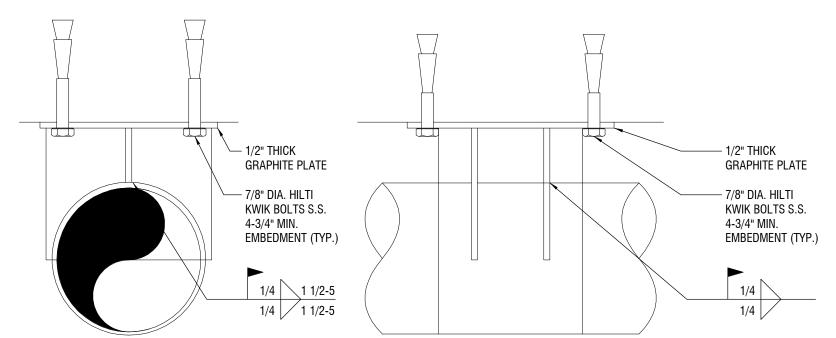
DRILL 4 HOLES — 1/2" GRAPHITE PLATES— (BONDED TO STEEL COMPONENTS) PIPING INSULATION -AS SPECIFIED. -PIPE ANCHOR DETAIL
M-502 N.T.S.

M-502 N.T.S.

— 7/8" DIA. HILTI KWIK BOLTS S.S., 4-3/4" MIN EMBEDMENT (TYP.) 1/4 1 1/2-5 1/4 1 1/2-5 — CARBON STEEL CRADLE ASSEMBLY 1/4 1 1/2-5 - INSULATION SUPPORT SHIELD - A307 ZINC PLATED BOLTS - PIPING INSULATION - AS SPECIFIED.

3 INSULATED PIPE SUPPORT DETAIL

M-502 N.T.S.



SIDE VIEW **ELEVATION VIEW** <u>NOTE:</u> CERAMIC INSULATE ALL EXPOSED METALS.

— 7/8" DIA. HILTI KWIK BOLTS S.S.. 4-3/4" MIN. EMBEDMENT (TYP.) — 1/2" THICK PLATE GRAPHITE PLATE. — 7/8" DIA THREADED STUD W/ NUT. FIELD WELD THREADED STUD TO BASE PLATE. — PIPE GUIDE ANVIL SIDE VIEW **ELEVATION VIEW** <u>NOTE:</u> CERAMIC INSULATE ALL EXPOSED METALS. 1 PIPE GUIDE DETAIL

DESCRIPTION: Revisions PROJECT NUMBER: 2170391 DRAWN BY: REVIEWED BY: ISSUED FOR: 35% PRELIMINARY DESIGN DRAWING NAME:

**RUNDEL LIBRARY PHASE IV** 

114 SOUTH AVE.

ROCHESTER, NY 14614

300 State Street, Suite 201

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**CITY OF ROCHESTER** 

414 ANDREWS ST. ROCHESTER, NY

— 0.016" EMBOSSED ALUMINUM JACKET WITH MOISTURE

BARRIER

Rochester, NY 14614

585-454-6110

labellapc.com

**MECHANICAL DETAILS** 

DRAWING NUMBER:

**M-502** 

GRADE (EXISTING OR PROPOSED SURFACE) FOR SURFACE RESTORATION REFER TO DETAILS ON C-SERIES DRAWINGS TRENCH FINAL BACKFILL MATERIAL: SHALL BE SUBBASE: MATERIAL REFER TO CIVIL DRAWINGS FOR DETAIL REGARDING EXCAVATION, BACKFILL, AND SURFACE WHERE PLANS CALL FOR LOOSE-FILL RESTORATION. INSULATION (AT PLASTIC PIPE CROSSINGS), REPLACE SAND WITH 6" MIN. LOOSE-FILL INSULATION, COMPACTED. REFER TO DWG. M2.1 REFER TO SPECIFICATION 232750 FOR - REQUIREMENTS. BED PRE-INSULATED, JACKETED PIPING IN MIN. 6" OF COMPACTED, CUSHION SAND. COVER TOP AND SIDES OF PIPING WITH — MIN. 6" COMPACTED, CUSHION SAND. DETECTABLE WARNING TAPE — CORE-DRILLED PENETRATION THROUGH LEAK DETECTION EXISTING CONCRETE WALL -← WIRE (TYP.) HDPE JACKET (AS CALCIUM SILICATE OR PART OF CELLULAR GLASS INSULATION. PRE-INSULATED PIPING REFER TO SPECIFICATIONS SYSTEM) FOR MINIMUM INSULATION THICKNESS (TYP.) AIR GAP — WITH SPIDER POLYISOCYANURATE OR POLYURETHANE FOAM INSULATION. REFER TO 10 GAUGE — STEEL CONDUIT SPECIFICATIONS FOR MINIMUM INSULATION THICKNESS (TYP.) PRE-ENGINEERED -SEAL SYSTEM

PRE-INSULATED UNDERGROUND PIPING DETAIL

M-502 N.T.S.

1. TYPICAL CROSS SECTION SHOWN. REFER TO PLAN FOR ROUTING OF STEAM LINE. 2. FOLLOW MANUFACTURER'S INSTALLATION AND BURIAL DETAILS. 3. REFER TO STRUCTURAL DRAWINGS FOR ANCHOR DESIGN AND 4. PROVIDE SAFE OPERATION, EXCAVATION, PROTECTION (AS REQUIRED). REFER TO CIVIL SPECIFICATIONS AND DETAILS. 5. BEDDING AND BACKFILL MATERIAL INSTALLED AND COMPACTED IN

NOTES: 1. TOTAL SLAB THICKNESS TO BE 6-1/2". 2. TOTAL SLAB THICKNESS TO BE 8".

	PUMP SCHEDULE (P)														
No.	Service	Location	Flow (GPM)	Head (ft)	Motor Size (HP)	Motor Speed (RPM)	Туре	Electric Data	Effic. %	Weight (Lbs.)	Manufacturer	Model	Notes		
P-SM-1	SM-1	RUNDEL MECH. RM.	36.8	-	1.0	1800	IN-LINE ECM	115 / 1 / 60	77	40	GRUNDFOS	MAGNA3 40-180	1		
P-SM-2	SM-2	RUNDEL MECH. RM.	40.1	-	1.0	1800	IN-LINE ECM	115 / 1 / 60	74	40	GRUNDFOS	MAGNA3 40-180	1		
P-SM-3	SM-3	RUNDEL CLOSET	38.5	-	1.0	1800	IN-LINE ECM	115 / 1 / 60	68	40	GRUNDFOS	MAGNA3 40-180	1		
P-SM-4	SM-4	RUNDEL CLOSET	30.9	-	1.0	1800	IN-LINE ECM	115 / 1 / 60	68	40	GRUNDFOS	MAGNA3 40-180	1		

NOTES:
1. PROVIDE WITH COMBINATION DISCONNECT AND STARTER.

			STE/	M PRES	SSURE F	REDUC	ING VA	LVE SCHEDULE					
No.	Service Inlet Pressure (PSIG) Inlet Temperature (PSIG) Outlet Pressure (PSIG) Size (Inches) Size (Inches) Size (Inches) Maximum Noise (dBA) Manufacturer Accessories Size Notes												
PRV-1	SNOWMELT	60	307	15	4"	2400	80	SPENCE ENGINEERING CO.	MUFFLING ORIFICE PLATE	2"	1		

NOTES: 1. RELIEF VALVE SET PRESSURE SHALL BE 20 PSIG.

	STEAM SAFET	Y RELI	EF VALVE	SCH	EDULE
No.	Service	Set Pressure (PSIG)	Orifice Area (Sq. In.)	Size	Manufacturer
SRV-1	RUNDEL SNOWMELT	20	2.935	4"	SPENCE ENGINEERING CO.

NOTES: 1. RELIEF VALVE SET PRESSURE SHALL BE 20 PSIG.

			GLYCO	L FILL STATION	ON SCHE	DULE (G	F)				
No.	LOCATION	Service	Tank Volume (Gal.)	System Fluid	Line Size (in.)	Pump HP	Electric	Weight (LBS)	Manufacturer	Model	Notes
GF-1	RUNDEL MECH. ROOM - 011	SNOWMELT LOOP	50	40% PROPYLENE GLYCOL	3/4"	1/3	115/1/60	600	J.L. WINGERT	GL50-E1	1

NOTES:
1. ELECTRIC CONTRACT TO PROVIDE A RECEPTACLE FOR POWER.

		AIR SE	<b>EPARA</b>		DULE	(AS)		
No.	Location	Service	GPM	Water PD (ft.)	Line Size	Manufacturer	Model	Notes
AS-1	RUNDEL MECH. ROOM - 011	SNOWMELT	200	1.0	4"	SPIROVENT	VDT400	1

NOTES: 1. PROVIDE COMBINATION AIR ELIMINATOR/DIRT SEPARATOR.

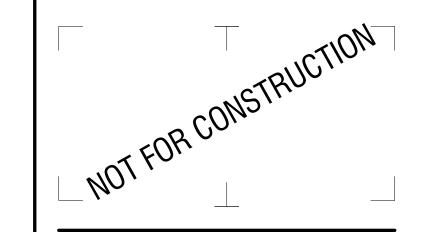
			EXF	PANSION TA	NK SCHED	ULE (ET	)				
No. LOCATION Service Type Orientation System Volume (Gal.) Acceptance Volume (Gal.) Acceptance Volume (Gal.) Tank Diameter Tank Height Weight (LBS) Ma								Manufacturer	Model	Notes	
ET-1	RUNDEL MECH. ROOM - 011	SNOWMELT LOOP	DIAPHRAGM	VERTICAL					BELL & GOSSET		1
				·					·		

NOTES: 1. MOUNT ON HOUSEKEEPING PAD.

							HEAT I	EXCHAN	NGER S	CHED	ULE (H	HX)									
No	Logation	Contino	Type	SHELL SIDE (40% PROPYLENE GLYCOL)					TUBE SIDE (15 PSI STEAM)			Hoot Transfer (MDU)	Number of	Effective	Number of	Mainlet (lb - )	Manufacture	Model	Notes		
No.	Location	Service	туре	Flow (GPM)	EWT	LWT	PD (ft)	Connections (in.)	Flow (LB/HR)	ET	LT	PD (ft)	Connections (in.)	Heat Transfer (MBH)	Passes	(SF)	Tubes	weight (ibs.)	Manufacturer	Model	Notes
HX-1	RUNDEL MECH. ROOM - 011	SNOWMELT LOOP	SHELL AND TUBE	200	95	120	14	5/5	2423	249	249	15	4/2	2300	1/2	64.2	110	150	BELL & GOSSETT	QWU 123-22	

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**RUNDEL LIBRARY PHASE IV** 

114 SOUTH AVE. ROCHESTER, NY 14614

NO: DATE: DESCRIPTION:

Revisions

PROJECT NUMBER:

2170391

DRAWN BY: Author

REVIEWED BY: Approver

ISSUED FOR:

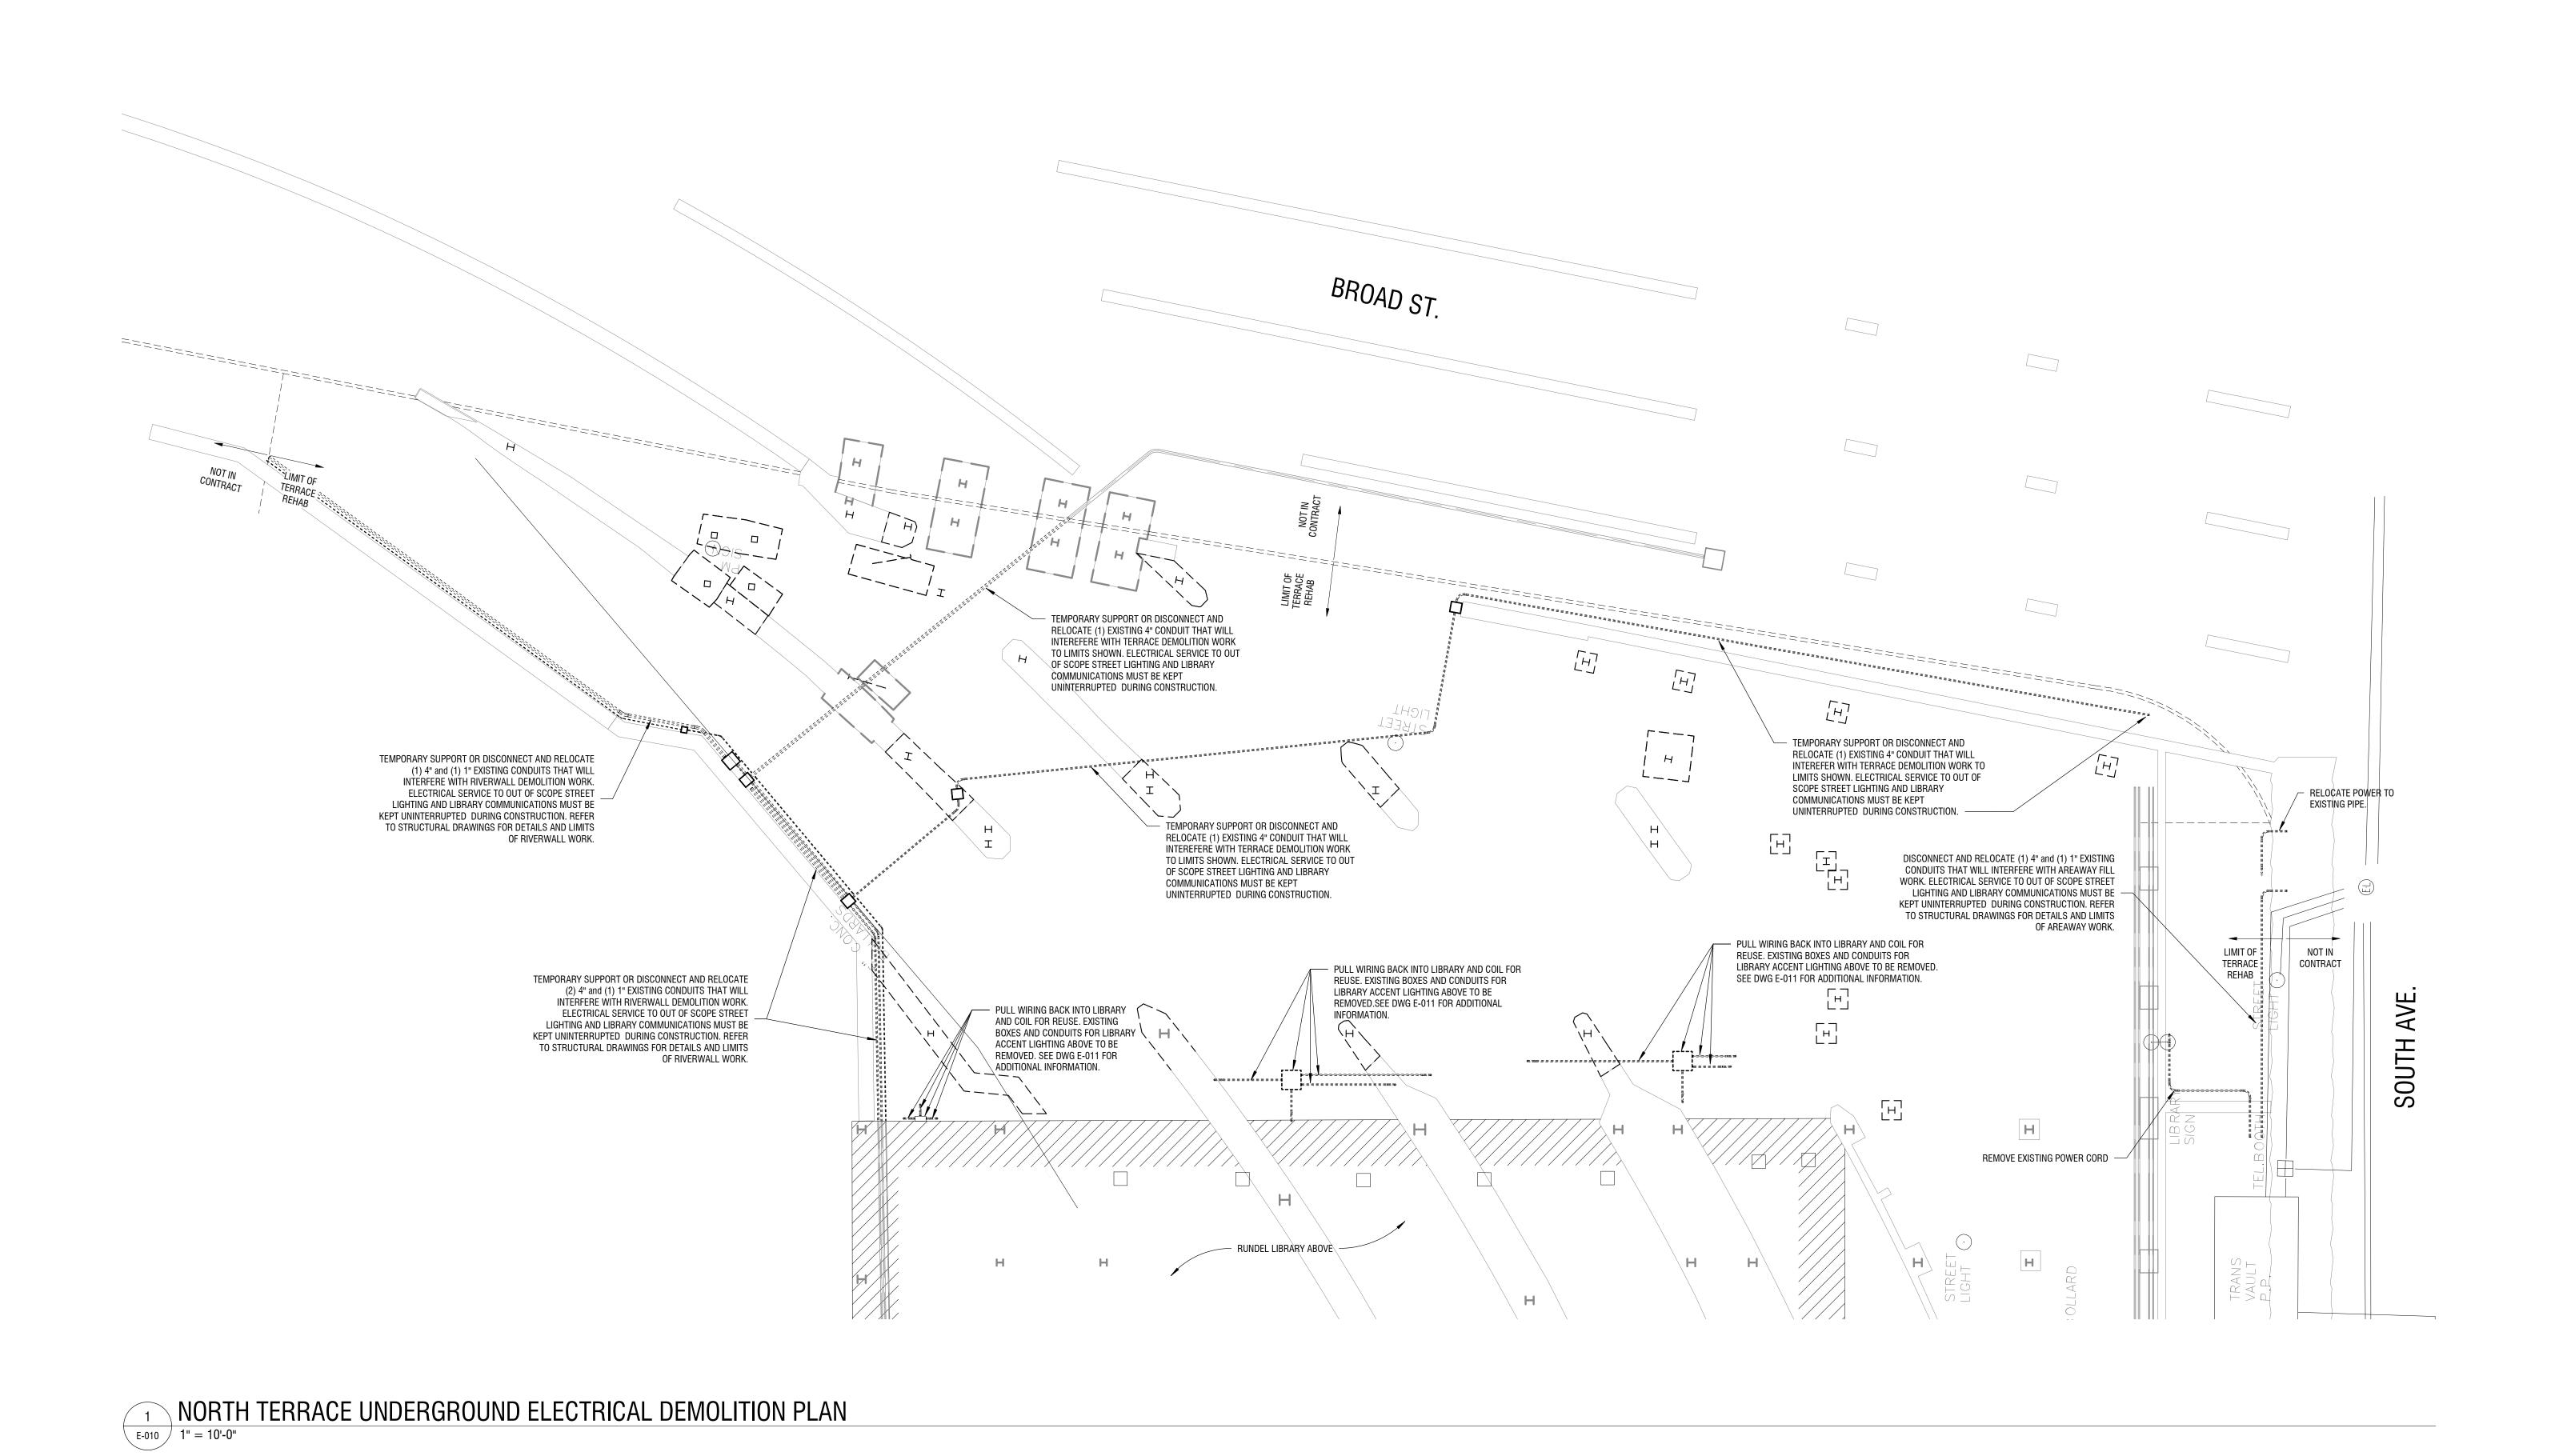
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DATE:

JULY 2018

**MECHANICAL SCHEDULES** 

DRAWING NUMBE

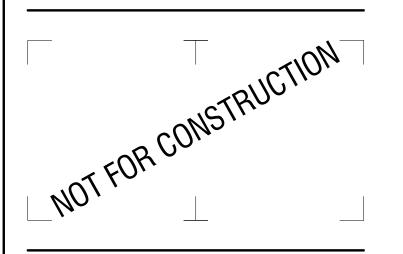


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JULY 2018

DRAWING NAME:

NORTH TERRACE
UNDERGROUND
ELECTRICAL DEMOLITION
PLAN

DRAWING NUMBE

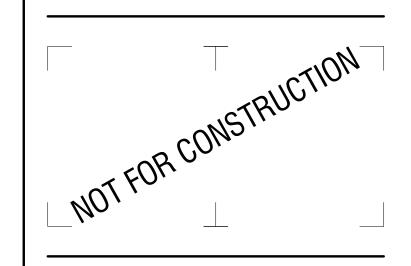
NORTH TERRACE SURFACE ELECTRICAL DEMOLITION PLAN

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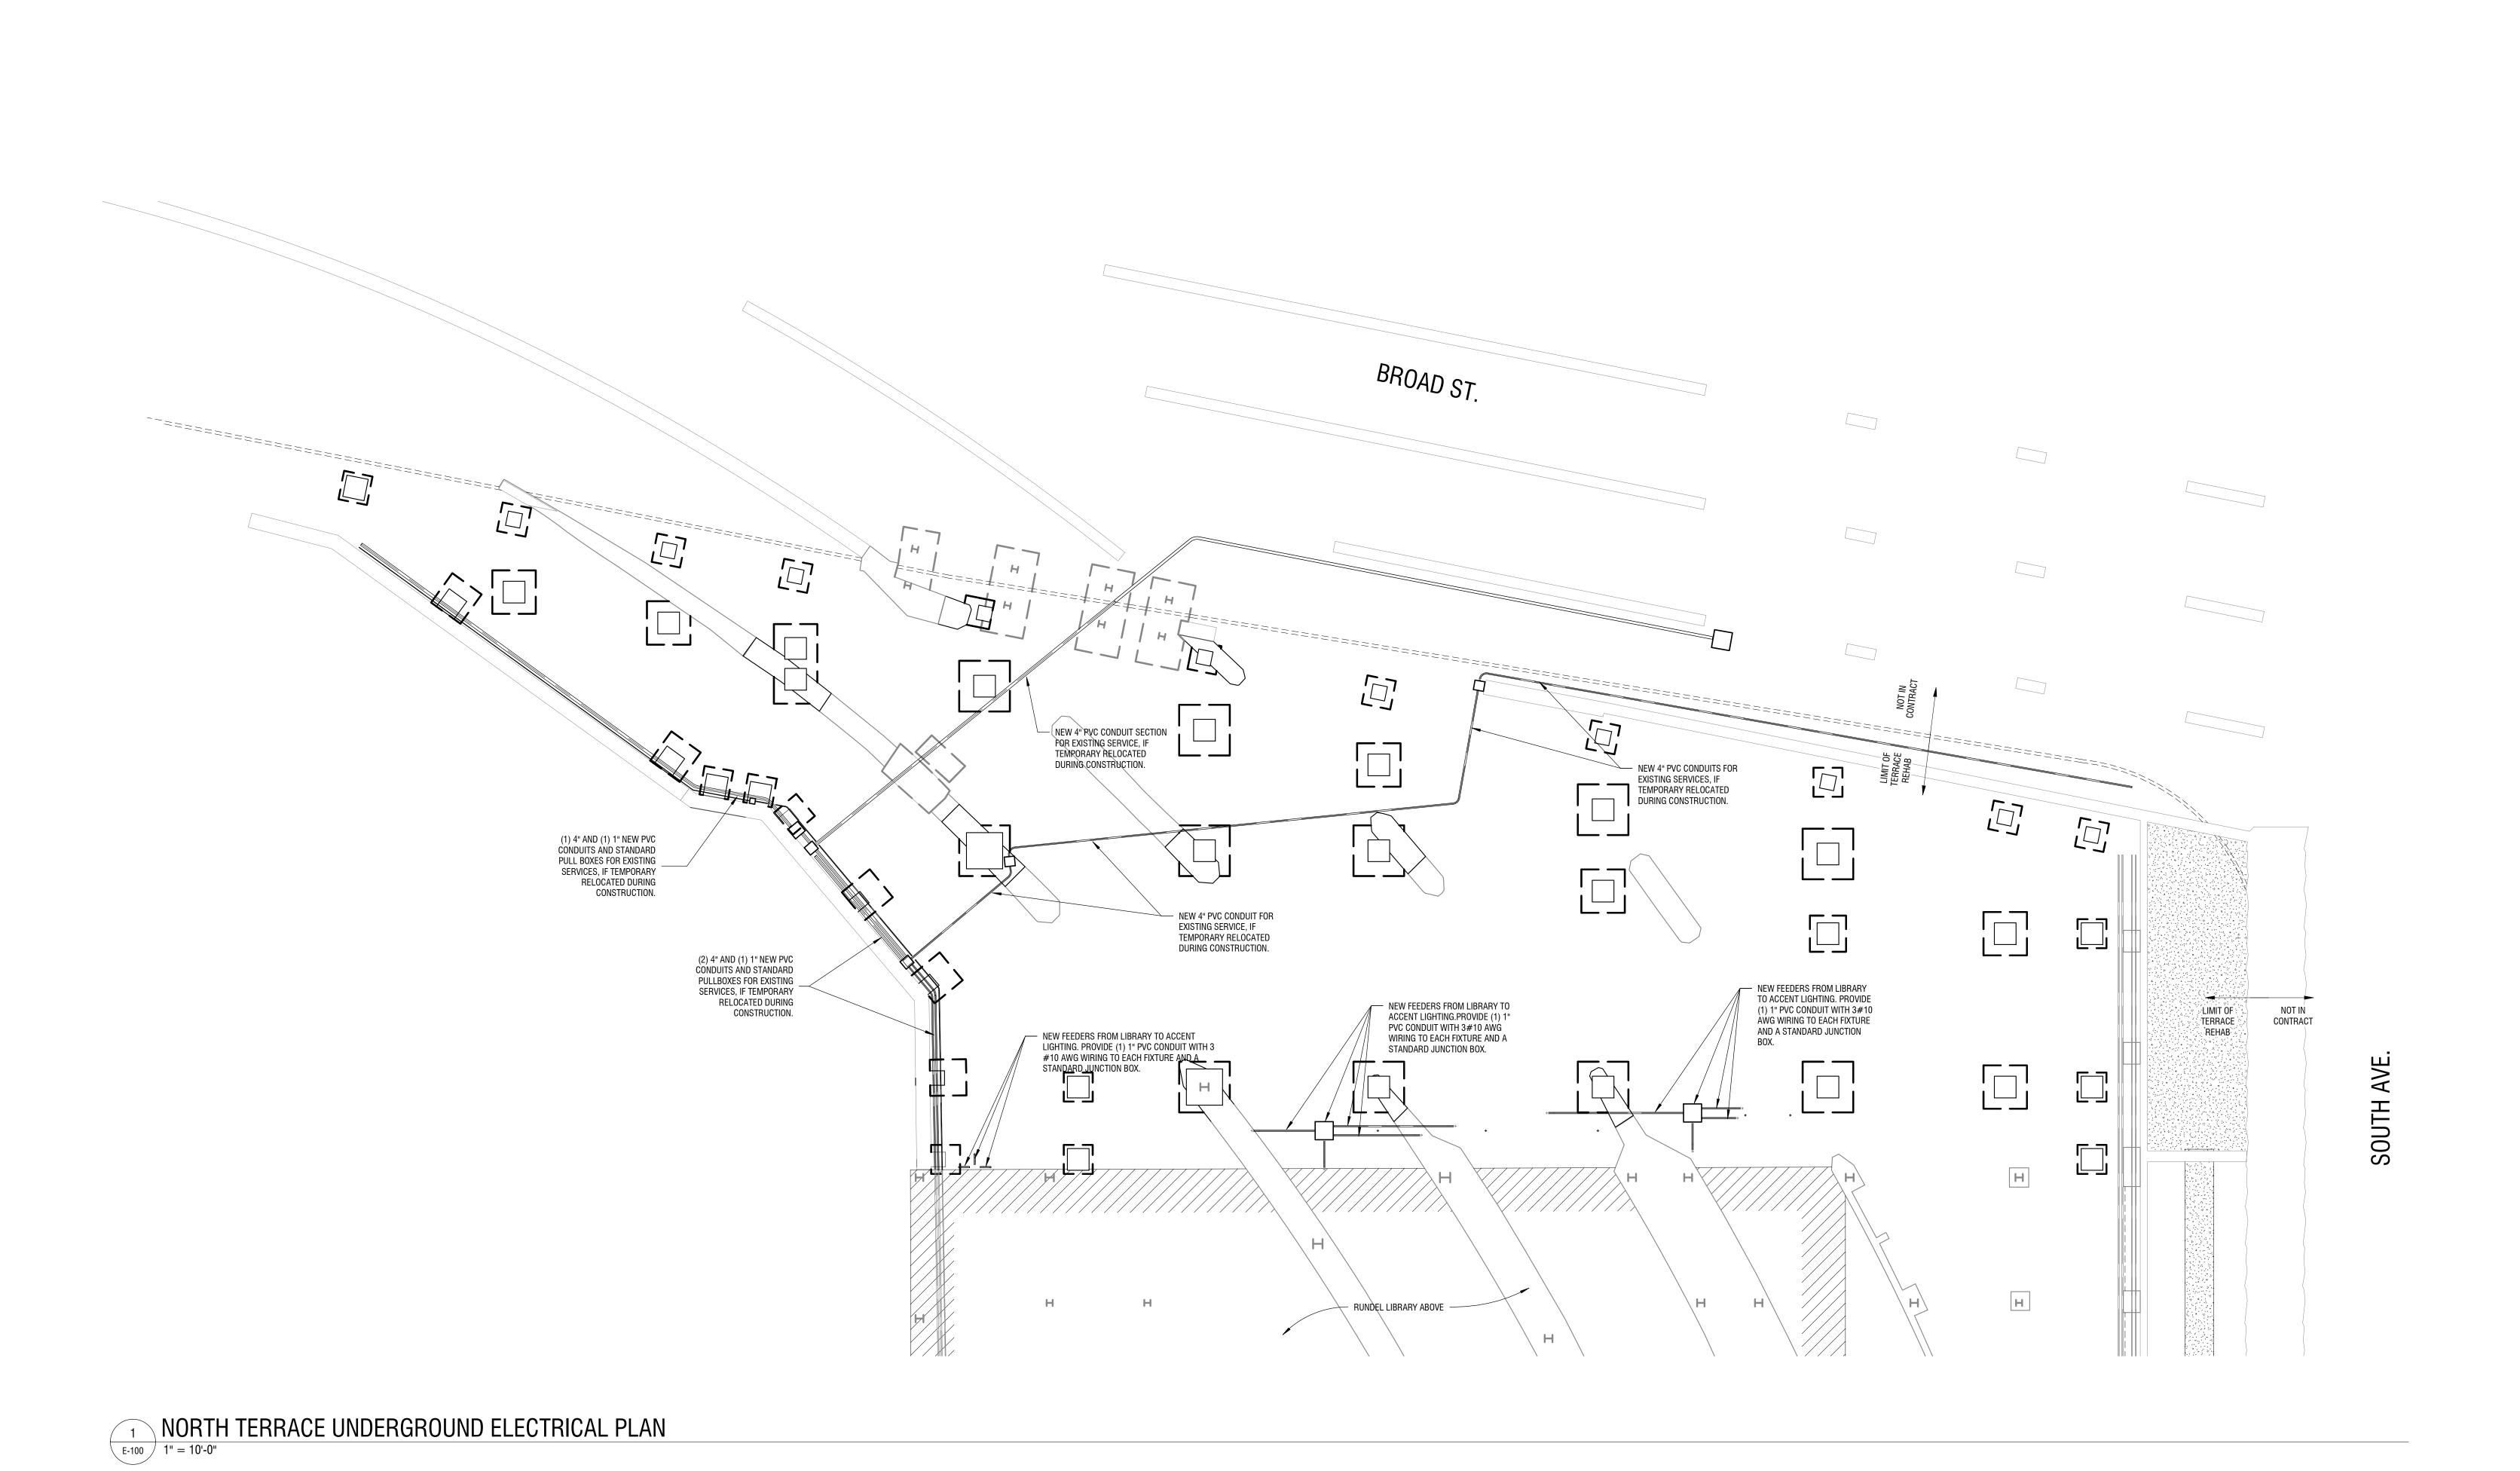
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NORTH TERRACE SURFACE ELECTRICAL DEMOLITION PLAN

DRAWING NUMBER:

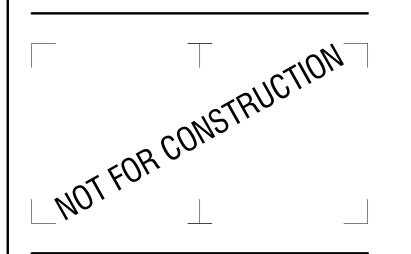


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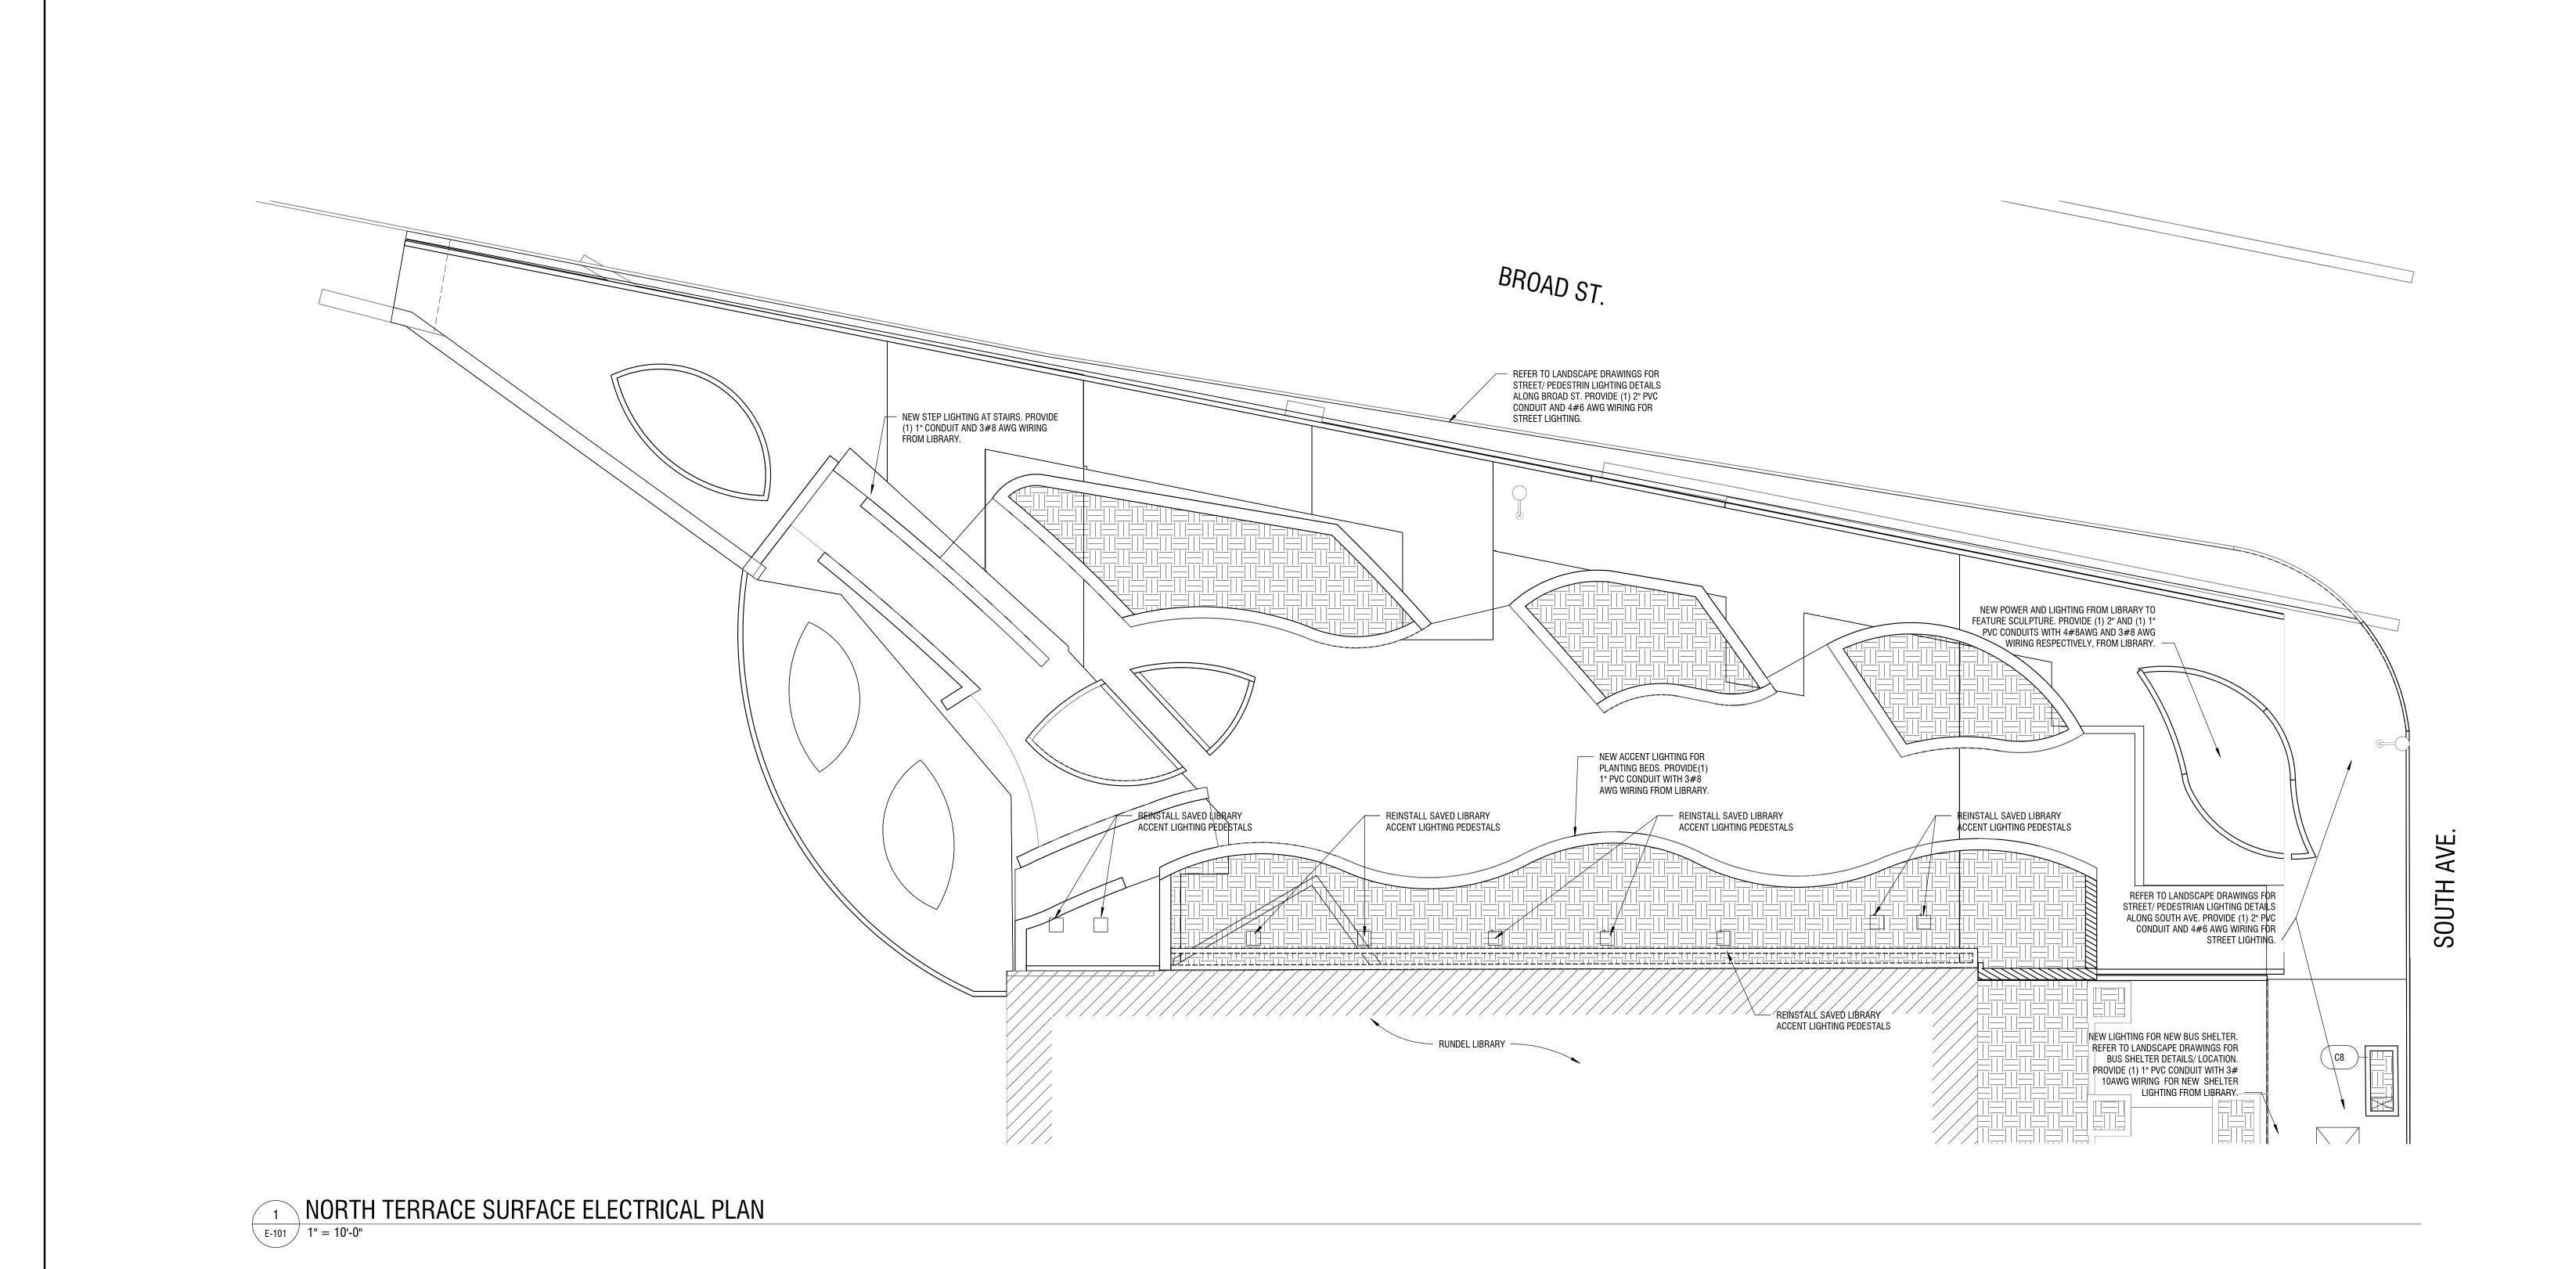
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NORTH TERRACE UNDERGROUND ELECTRICAL PLAN

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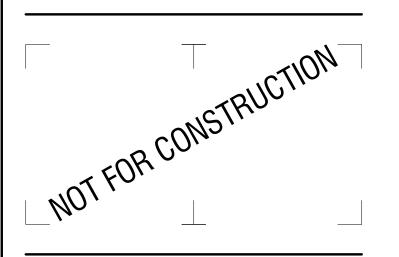


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