

Neighborhood and Business Development 30 Church St. Rm. 125-B Rochester, NY 14614 www.cityofrochester.gov

Project Review Committee (PRC) Agenda

Date: Wednesday, February 16, 2022

Time: 4:00 p.m.

Location: https://www.youtube.com/c/CityofRochesterVideos

Case Number:	1
File Number:	SP-016-21-22
Case Type:	Major Site Plan Review
Address:	101-113 Franklin St, 106 Pleasant St, 317, and 325 Andrews St
Zoning:	CCD-B Center City Base District
Quadrant	Southwest
Applicant:	Eugenio Marlin, Ibero-American Development Corporation
Request:	To construct a six-story, 14,800 square foot, mixed-use building with a 36-space parking area. When completed the building will offer 76 dwelling units and 2,810 square feet of commercial space. Work scope includes a new curb cut and the resubdivision of the subject properties.
Review Requirement:	120-191D(3)(c)[2] Applications in the CCD that include major deviations from the design criteria.
Enforcement:	No
SEQR:	Unlisted
Lead Agency:	Manager of Zoning
Contact:	Anna Keller, siteplanreview@cityofrochester.gov

Case Number:	2
File Number:	SP-012-21-22
Case Type:	Minor Site Plan Review
Address:	242, 246 Ormond St, and 3 Leopold St
Zoning:	M-1 Industrial District
Quadrant	Northeast
Applicant:	John Cooper, Rochester Storage QOZ, LLC
Request:	To establish a self-service storage operation consisting of 130 containers to be used as individual storage units and to be placed on the project site (not within a fully enclosed building). Proposal includes resubdividing the subject properties.
Review Requirement:	120-191D(3)(a)[10]Projects involving or abutting a designated landmark or those involving or abutting a site listed or eligible for listing on the State or National Register of Historic Places.
Enforcement:	No
SEQR:	Unlisted
Lead Agency:	Manager of Zoning
Contact:	Anna Keller, siteplanreview@cityofrochester.gov














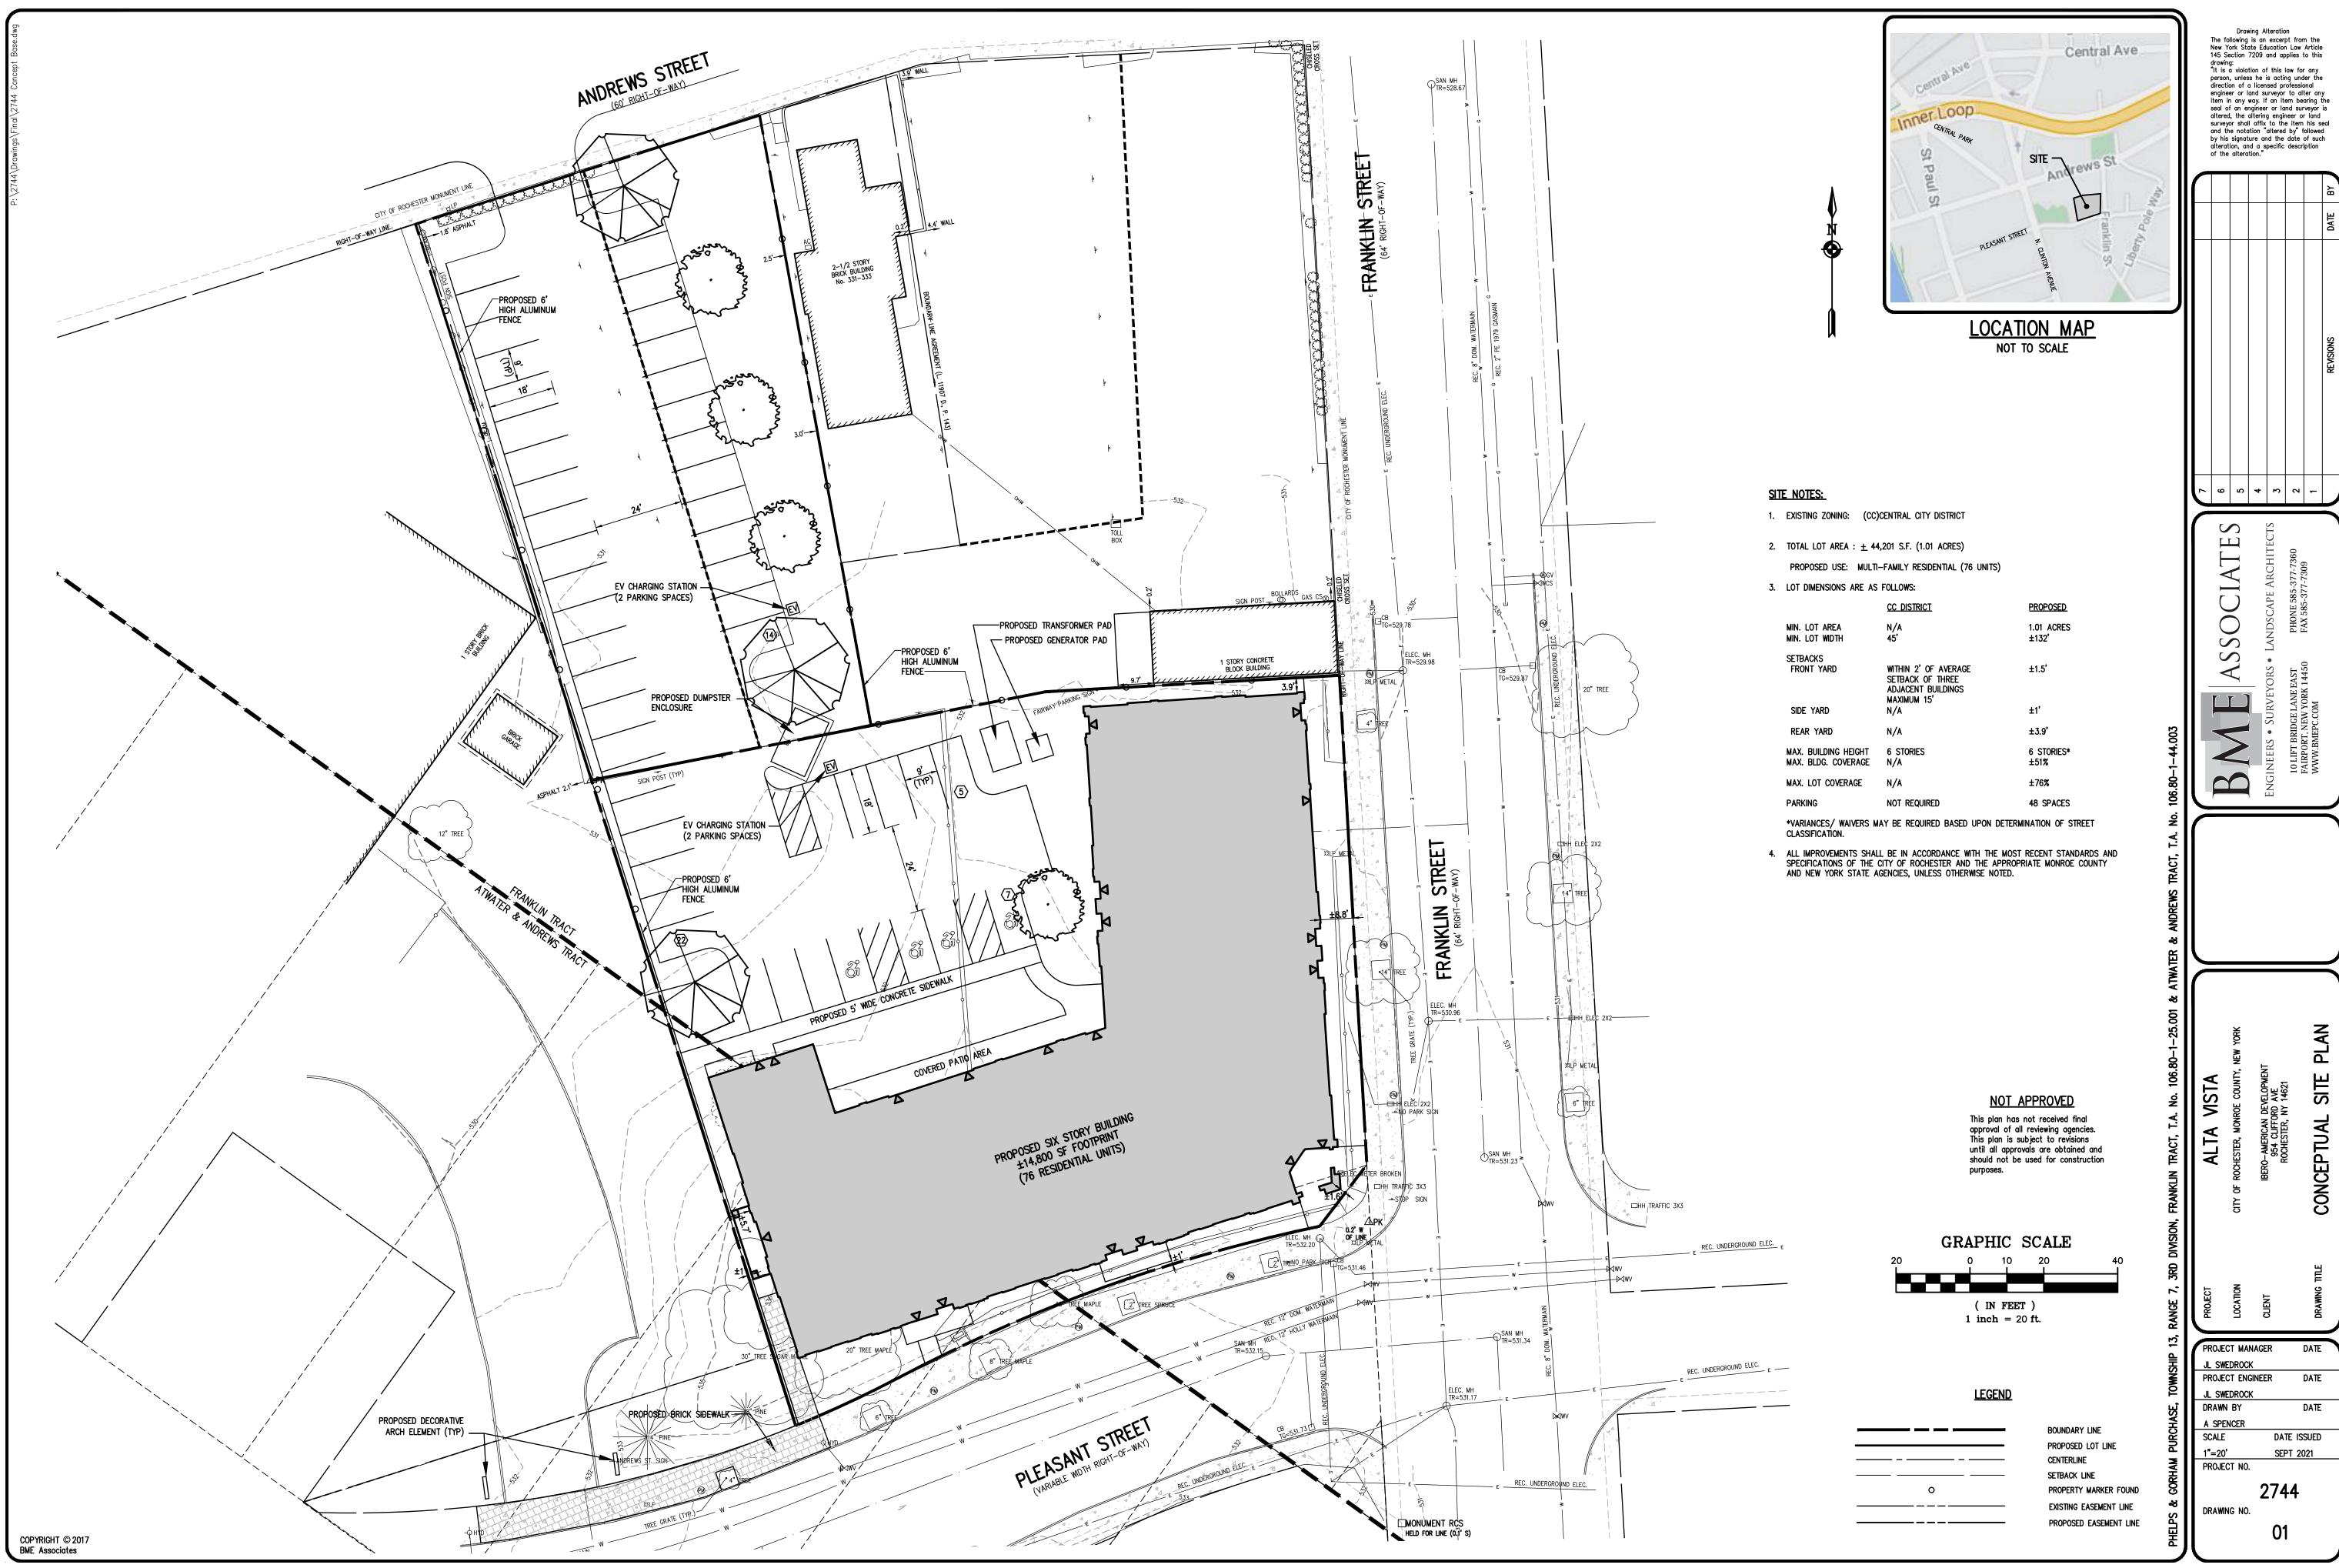

Drawing Alteration
The following is an excerpt from the
New York State Education Law Article
145 Section 7209 and applies to this

CONCEPTUAL

DATE ISSUED

Project Review Committee (PRC) Referral

Addresses	101-113 Franklin St, 106 Pleasant St, 317, and 325 Andrews St	
Reason for Referral	In accordance with 120-181G(1), all major site plans shall be referred to the PRC for review and	
	recommendation.	
Next Steps	• PRC to review deviations from design requirements and provide recommendation to MOZ.	
	MOZ to review PRC recommendation and issue a site plan determination accordingly.	

Definitions

YARD, FRONT

An open space extending the full width of the lot between a main front building line and the front lot line, unoccupied and unobstructed by buildings or structures from the ground upward, the depth of which shall be the least distance between the front lot line and the front of the main front building line. On corner lots, the front yard shall be any yard that fronts on a street. In the case of uses or parcels without a principal structure, the front yard shall be a line drawn parallel to a front lot line a distance equal to the depth of the required front yard setback.

LOT, DOUBLE-FRONTAGE

A lot having frontage on two nonintersecting streets.

LOT LINE, FRONT

in the case of a double-frontage lot, each property line separating the lot from a street shall be considered the "front lot line."


Major Deviation

Code Section	Requirement	Proposal	
120-66D(1)(e)[1][b]	Front yard setback shall be: City street: shall	Project site is considered a 'double-frontage	
	be within two feet of the average setback of	lot' as it has frontage on two nonintersecting	
	three adjacent buildings on either side of the	streets (Pleasant St, Franklin St, and Andrews	
	building to a maximum of 15 feet.	St). The property line separating the project	
		site from Andrews St is considered a front lot	
		line. The building line is approximately 240 feet	
		from the Andrews St front lot line. The	
		maximum front setback requirement for the	
		district is 15 feet.	

Minor Deviations

Code Section	Requirement	Proposal
120-66D(1)(a)[1]	Buildings shall exhibit a vertical mass on the	Material layout does not reinforce vertical
	street frontage.	fenestration pattern.
120-66D(2)(b)[1][a]	Window coverage. City and district streets.	See attached window calculation sheet.
	All first floor building facades shall be a	
	minimum 40% and a maximum 75% window	
	coverage.	
120-66D(2)(b)[2]	All other floors on building facades shall be a	See attached window calculation sheet.
	minimum 25% and a maximum 60% window	
	coverage.	
120-66D(2)(b)[3]	All other facades shall be a minimum 20%	See attached window calculation sheet.
	window coverage.	
120-66E(1)(a)[2]	Building parking shall be located in the rear	The property line separating the project site
	yard and be hard surfaced.	from Andrews St is considered a front lot line.
		The unobstructed space between the building

		and the Andrews St front lot line is considered a front yard. The proposed parking lot is located in the front yard.
120-66E(1)(a)[7]	Parking lots shall have one paved pedestrian walkway to each street frontage sidewalk a minimum six feet and a maximum eight feet wide. Pedestrian walks shall be hard surfaced and equal in material and pattern to the adjacent sidewalk.	A paved pedestrian walkway to the Andrews St frontage is not proposed.

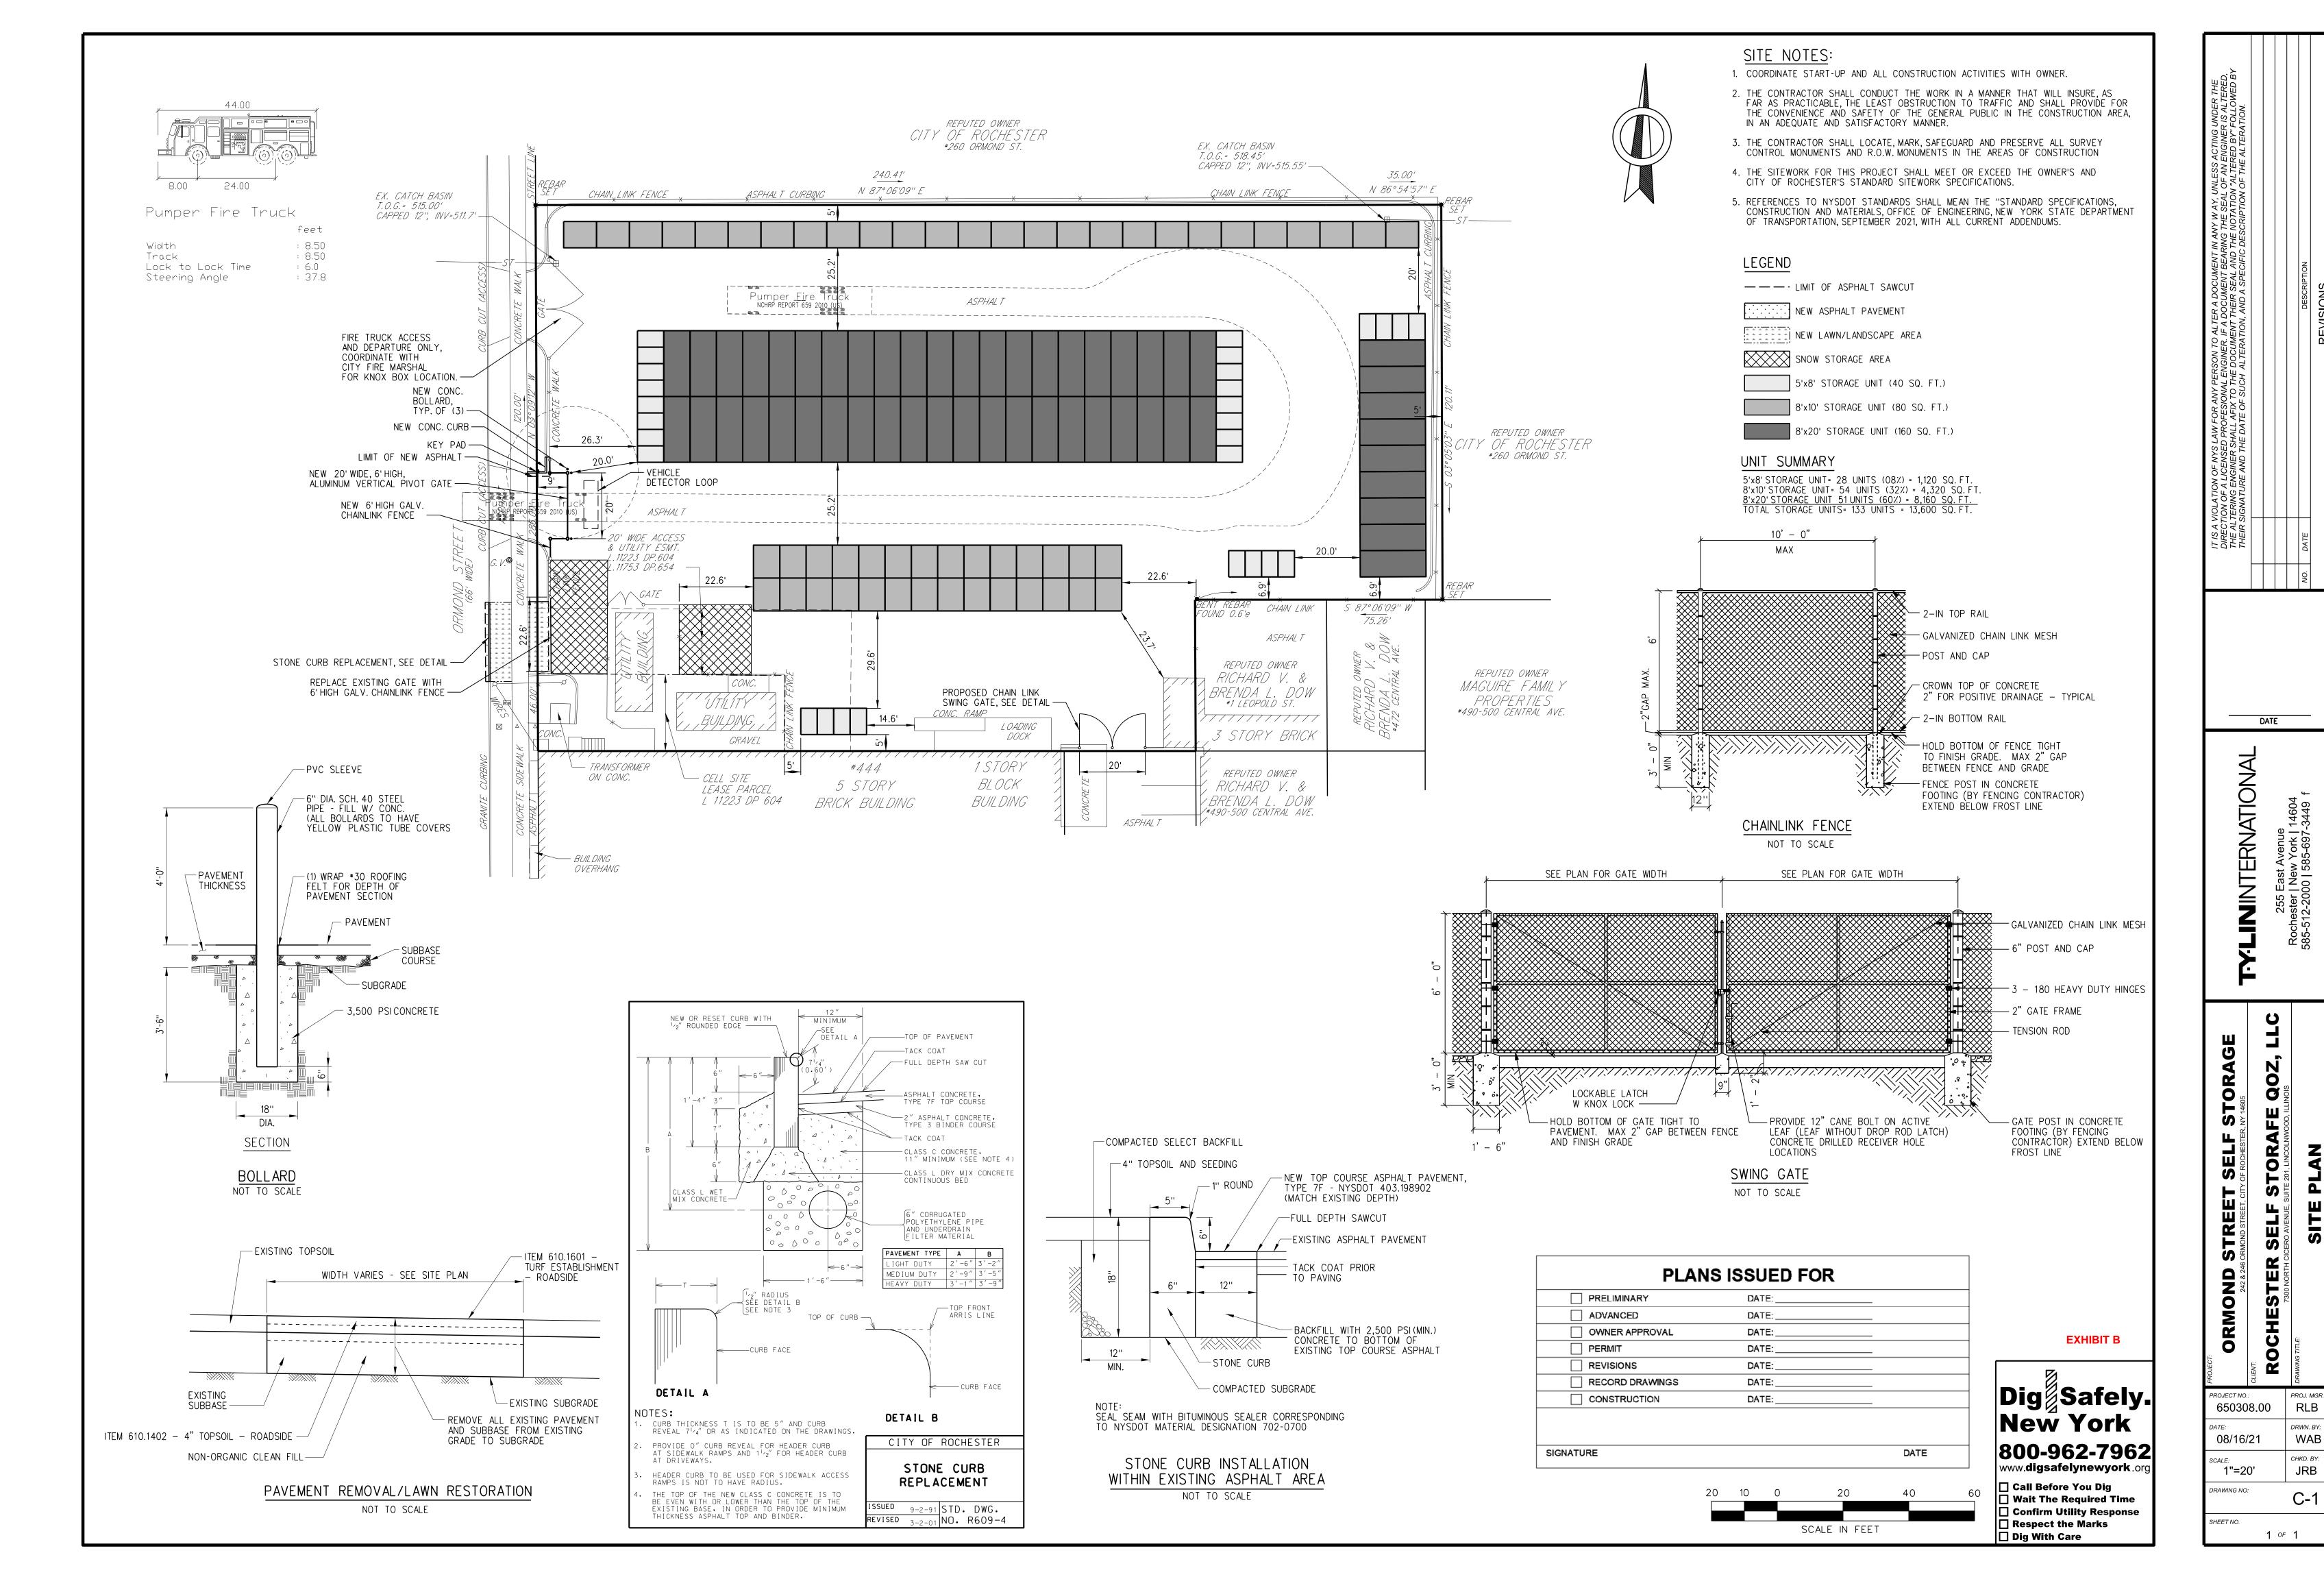



Neighborhood and Business Development 30 Church Street, Room 125-B Rochester, New York 14614 www.cityofrochester.gov

Project Review Committee (PRC) Comments

Date: February 16, 2022

Time: 4:00 p.m.

Location: https://www.youtube.com/c/CityofRochesterVideos

Topic: 101-113 Franklin St, 106 Pleasant St and 317 and 325 Andrews St

Members Present: Dave Beinetti, Architect, President / Principal, SWBR Architects

Roger Brown, Urban Design Specialist / Architect

Donna Clements, City Engineer Designee

Matt Vanderwall, Manager of Code Enforcement Designee

James Yarrington, Architect, Adjunct Professor, RIT Director of Campus

Planning, Design and Construction Services

Staff: Marcia Barry, Manager of Zoning Designee

Kate Powers, Senior City Planner

Action: Held, additional information required

Findings

In accordance with 120-181D, the PRC shall review all major site plans referred to it by the Manager of Zoning and make a recommendation to approve, approve subject to conditions or deny the application. The major site plan review application, SP-016-21-22 at 101-113 Franklin St was reviewed by the PRC at their 2/16/22 meeting.

This project proposes to redevelop four parcels of vacant, City-owned land into a six-story, 14,800 square foot, mixed-use building with a 36-space parking lot. When completed, the building will offer 76 dwelling units and 2,810 square feet of commercial space. The subject properties are located in the Center City Base District (CCD-B). The design intent of the CCD-B district is to preserve the design character of the public realm, maintain and enhance the existing diversity and variety in the public realm, promote street-level activity and uses, and create green streets and mid-block corridors to enhance pedestrian circulation. The project site is both a corner lot and a double frontage lot with frontage on Andrews St, Franklin St, and Pleasant St. The project site is proximate to the proposed redevelopment of the Inner Loop North transformation project.

Comments

Massing

The material layout does not reinforce a vertical fenestration pattern.

Requests:

1) Revise building design accordingly.

Transparency

It is necessary for the proposed project to align with the purpose of the zoning district by designing the building and configuring the site with the public realm in mind. The PRC recommends providing

PRC Comments SP-016-21-22 101-113 Franklin St, 106 Pleasant St and 317 and 325 Andrews St Page 2

transom windows above current proposed windows and doors on all first floor facades and/or increasing the size of the proposed doors.

Requests:

- 1) Transparency requirements for all first floor facades must be met.
- 2) Transparency requirements for all facades facing the landmark site must be met.

Commercial Entrance

The project site is adjacent to St Joseph's Park, a landmark site. The project plans include a 2,810 square foot commercial, multi-purpose room intended to be used for special events occurring at the adjacent landmark park. The PRC stated that the detailing of the proposed building, specifically the façade that faces the landmark site is important due to the proximity and relationship to the landmark site. Given that a new commercial space is proposed in the CCD-B district pedestrian access is needed to strengthen and maintain street-level activity and pedestrian circulation.

Requests:

- 1) Provide renderings that demonstrate how the proposed building, specifically the west façade relates to the adjacent landmark site. Be sure to include any other improvements that strengthen the connection between the two structures.
- 2) Provide an entrance to the commercial space with direct pedestrian access from the street.

Design

Additional detailing is requested on the tower situated on the Corner of Franklin St and Pleasant St. This tower should serve as a prominent architectural feature of the proposed building.

The PRC is unable to comment on the brick pilasters with the provided renderings and thus requests new renderings in order to determine if their massing is satisfactory or whether a modification or alternative is preferable.

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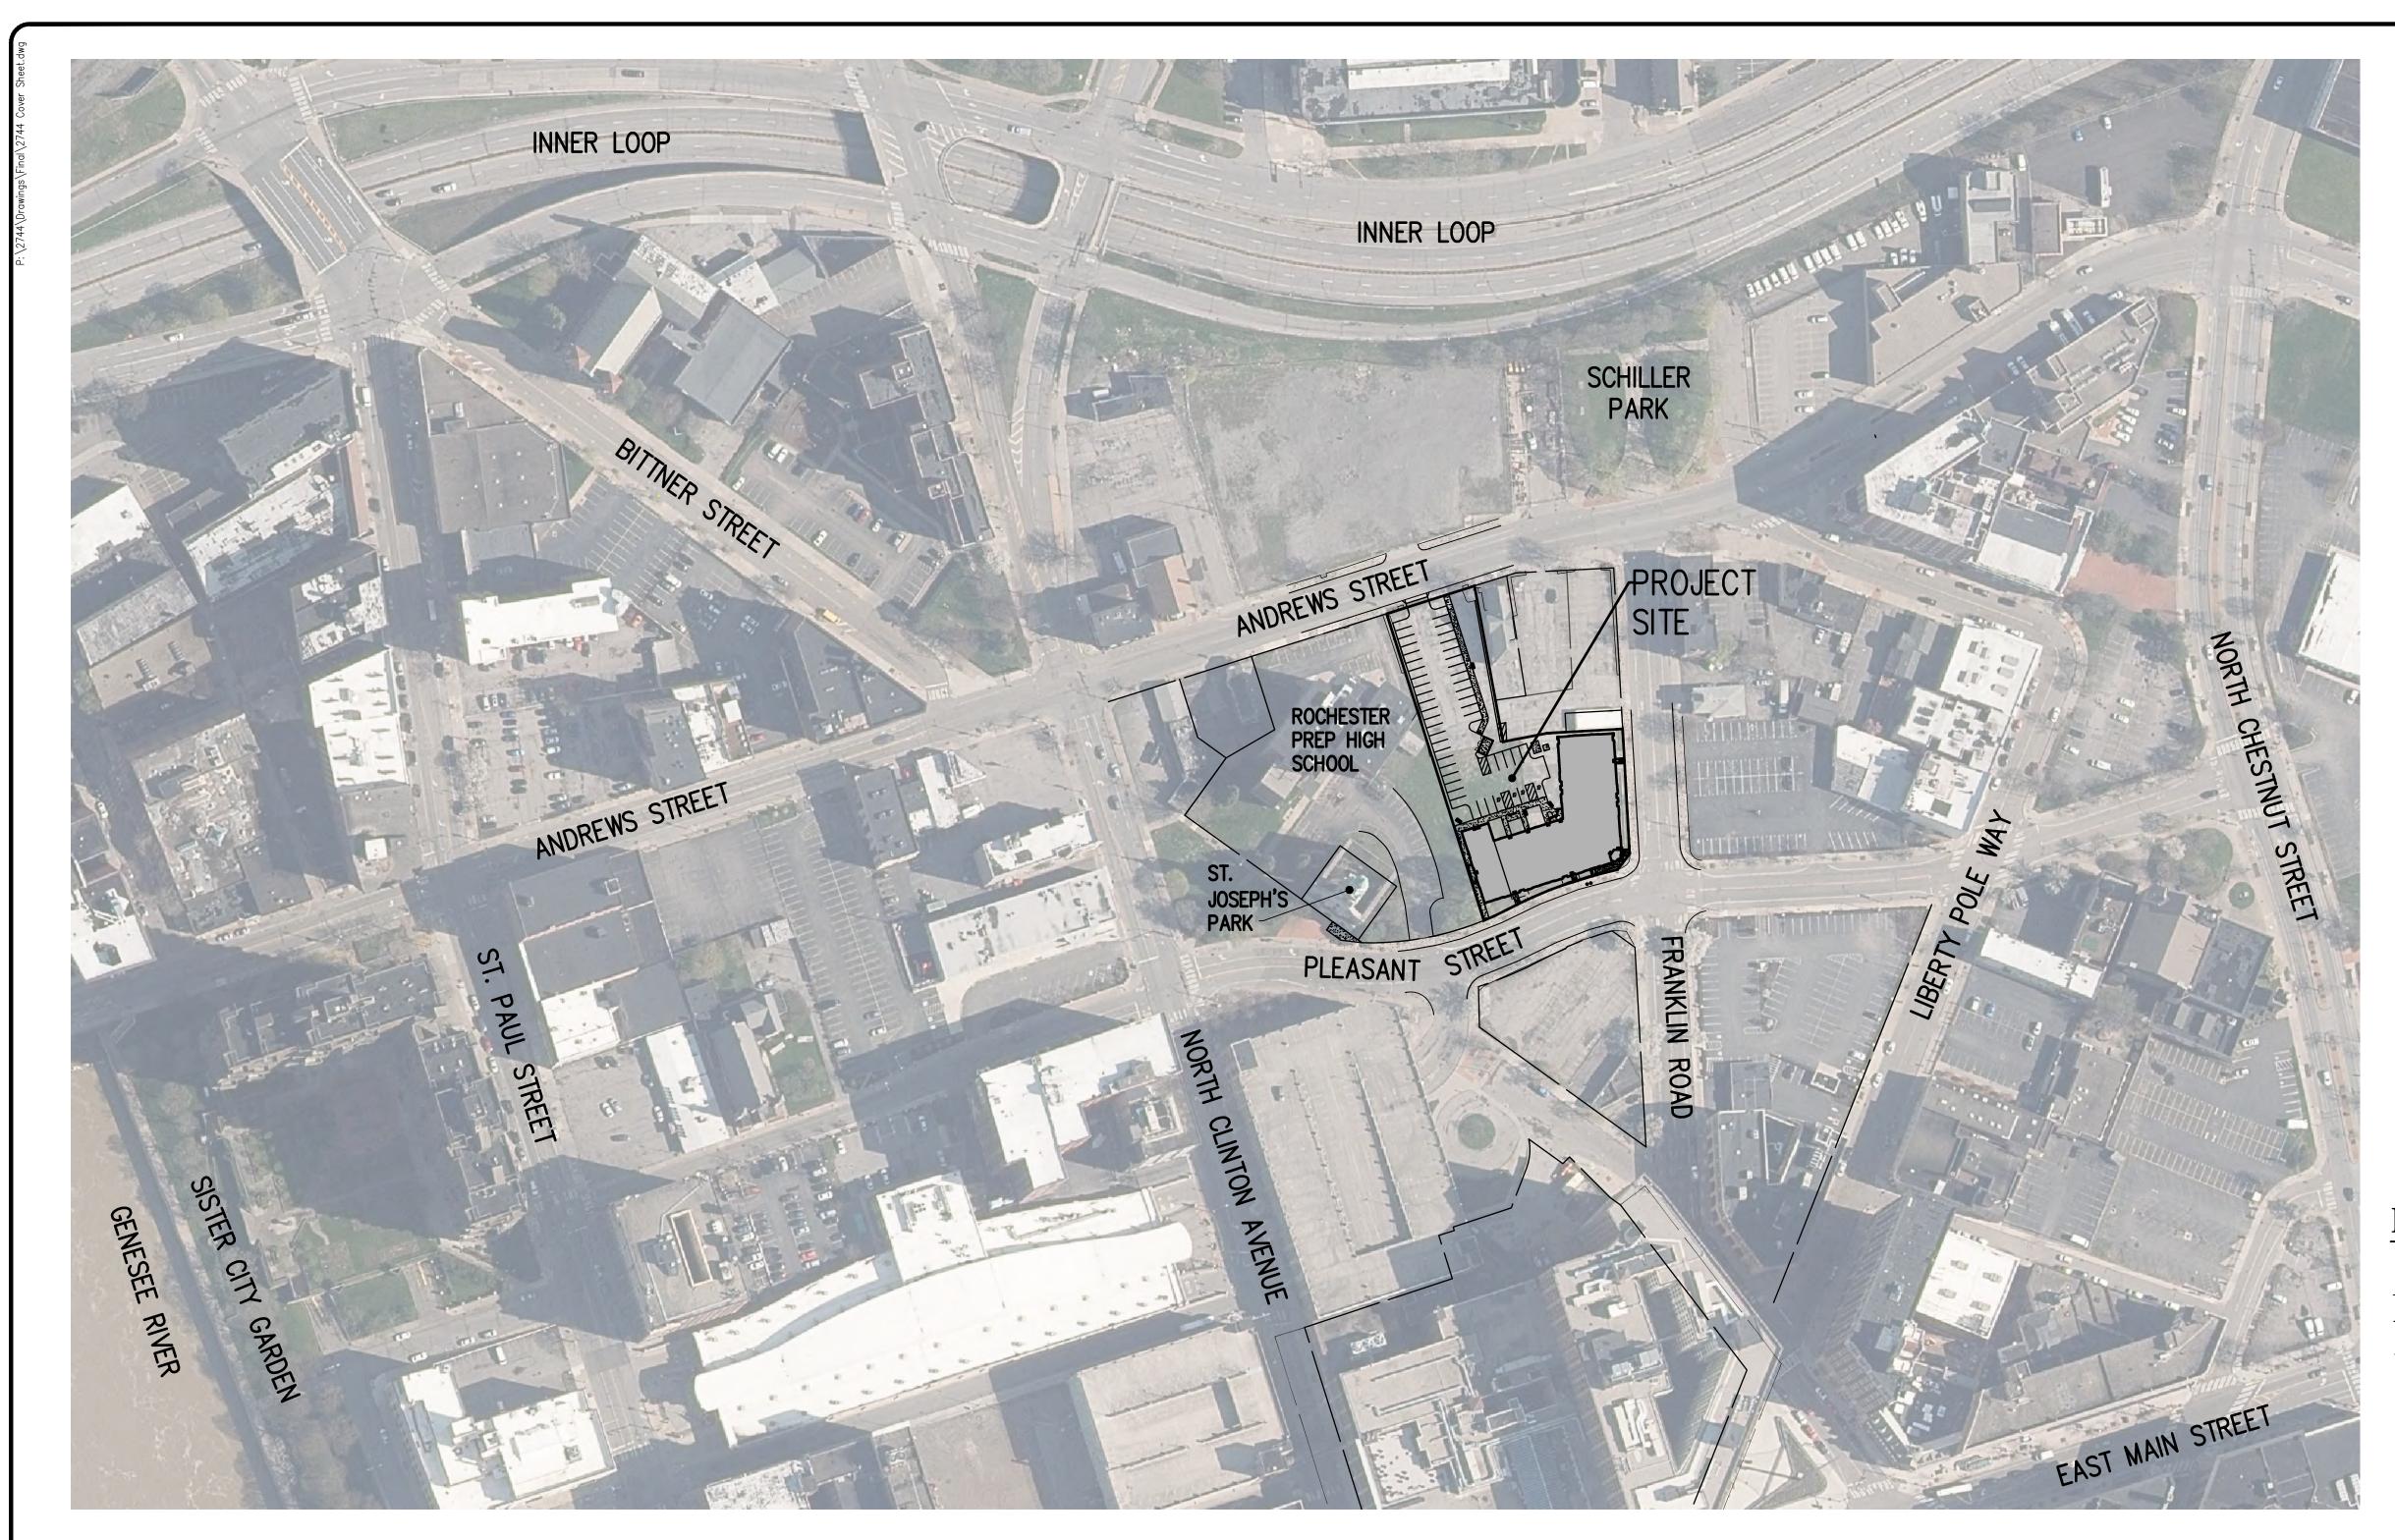
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ALTA VISTA AT ST. JOSEPH'S PARK

(317, 325 Andrews Street & 101-113 Franklin Street & 106 Pleasant Street)

CITY OF ROCHESTER, MONROE COUNTY, NEW YORK STATE

PREPARED FOR:

ALTA VISTA HOUSING LLC

954 CLIFFORD AVE. ROCHESTER, NY 14621



CITY OF ROCHESTER

LOCATION MAP

NOT TO SCALE


DWG. No.	TITLE
2744-03	COVER SHEET
2744-04	SITE PLAN
2744-05	CONSOLIDATION PLAT
2744-06	EXISTING CONDITIONS / DEMOLITION PLAN
2744-07	UTILITY PLAN
2774-08	GRADING PLAN
2274-09	CONSTRUCTION EROSION CONTROL PLAN
2774-10	LANDSCAPE PLAN
2774-11	LIGHTING PLAN
2744-12	DETAIL SHEET (SHEET 1 OF 5)
2744-13	DETAIL SHEET (SHEET 2 OF 5)
2744-14	DETAIL SHEET (SHEET 3 OF 5)
2744-15	DETAIL SHEET (SHEET 4 OF 5)
2744-16	DETAIL SHEET (SHEET 5 OF 5)
2744-17	SIDEWALK DETOUR PLAN

SCALE: 1"=100'

DRAWING NUMBER: 2744_03 DATED: DECEMBER 07, 2021 LAST REVISED: MARCH 4, 2022



10 LIFT BRIDGE LANE EAST PHONE 585-377-73
FAIRPORT, NEW YORK 14450 FAX 585-377-7309
WWW.BMEPC.COM

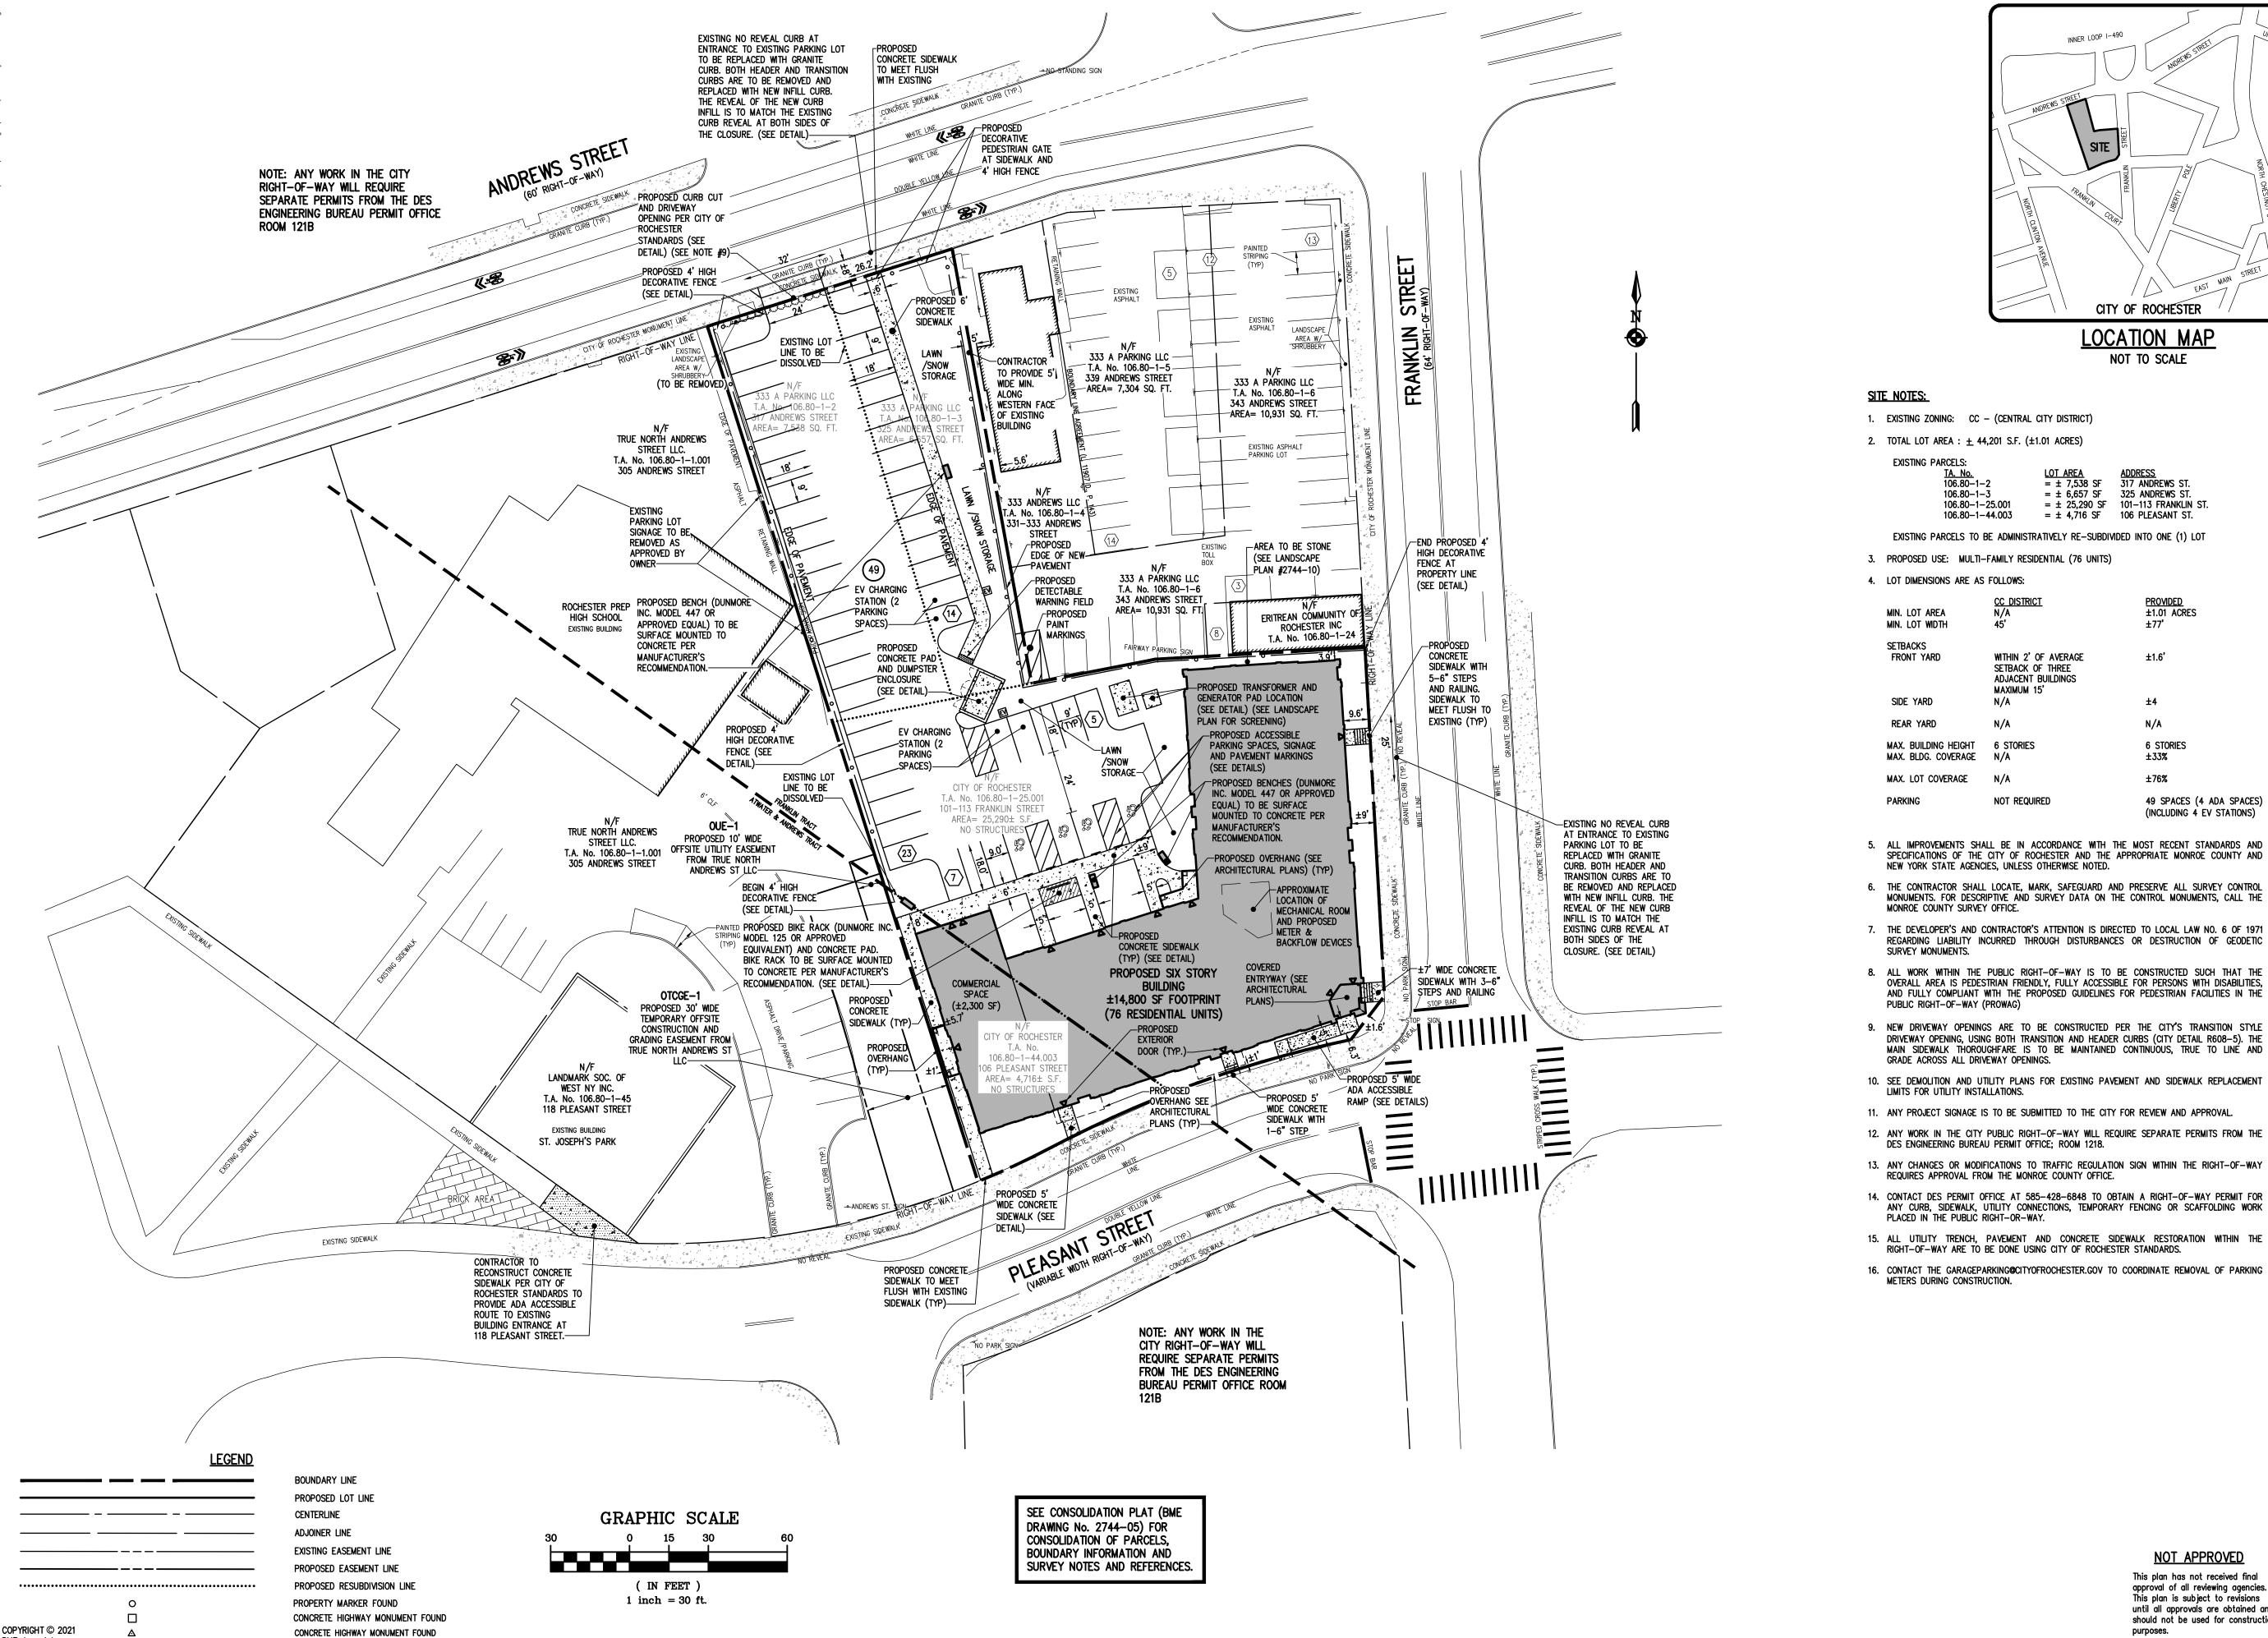

INNER LOOP 1-490

LOCATION MAP NOT TO SCALE

CITY OF ROCHESTER

1. EXISTING ZONING: CC - (CENTRAL CITY DISTRICT)

2. TOTAL LOT AREA: \pm 44,201 S.F. (\pm 1.01 ACRES)

ING PARCELS:		
<u>TA. No.</u>	LOT AREA	<u>ADDRESS</u>
106.80-1-2	$= \pm 7,538 \text{ SF}$	317 ANDREWS ST.
106.80-1-3	$= \pm 6,657 \text{ SF}$	325 ANDREWS ST.
106.80-1-25.001	$= \pm 25,290 \text{ SF}$	101-113 FRANKLIN ST
106.80-1-44.003	$= \pm 4,716 \text{ SF}$	106 PLEASANT ST.

EXISTING PARCELS TO BE ADMINISTRATIVELY RE-SUBDIVIDED INTO ONE (1) LOT

3. PROPOSED USE: MULTI-FAMILY RESIDENTIAL (76 UNITS)

4. LOT DIMENSIONS ARE AS FOLLOWS:

MIN. LOT AREA MIN. LOT WIDTH	N/A 45'	±1.01 ACRES ±77'
SETBACKS FRONT YARD	WITHIN 2' OF AVERAGE SETBACK OF THREE ADJACENT BUILDINGS MAXIMUM 15'	±1.6'
SIDE YARD	N/A	±4
REAR YARD	N/A	N/A
MAX. BUILDING HEIGHT MAX. BLDG. COVERAGE	6 STORIES N/A	6 STORIES ±33%
MAX. LOT COVERAGE	N/A	±76%
PARKING	NOT REQUIRED	49 SPACES (4 ADA SPACES) (INCLUDING 4 EV STATIONS)


- 5. ALL IMPROVEMENTS SHALL BE IN ACCORDANCE WITH THE MOST RECENT STANDARDS AND SPECIFICATIONS OF THE CITY OF ROCHESTER AND THE APPROPRIATE MONROE COUNTY AND NEW YORK STATE AGENCIES, UNLESS OTHERWISE NOTED.
- 6. THE CONTRACTOR SHALL LOCATE, MARK, SAFEGUARD AND PRESERVE ALL SURVEY CONTROL MONUMENTS. FOR DESCRIPTIVE AND SURVEY DATA ON THE CONTROL MONUMENTS, CALL THE MONROE COUNTY SURVEY OFFICE.
- 7. THE DEVELOPER'S AND CONTRACTOR'S ATTENTION IS DIRECTED TO LOCAL LAW NO. 6 OF 1971 REGARDING LIABILITY INCURRED THROUGH DISTURBANCES OR DESTRUCTION OF GEODETIC SURVEY MONUMENTS.
- 8. ALL WORK WITHIN THE PUBLIC RIGHT-OF-WAY IS TO BE CONSTRUCTED SUCH THAT THE OVERALL AREA IS PEDESTRIAN FRIENDLY, FULLY ACCESSIBLE FOR PERSONS WITH DISABILITIES, AND FULLY COMPLIANT WITH THE PROPOSED GUIDELINES FOR PEDESTRIAN FACILITIES IN THE PUBLIC RIGHT-OF-WAY (PROWAG)
- 9. NEW DRIVEWAY OPENINGS ARE TO BE CONSTRUCTED PER THE CITY'S TRANSITION STYLE DRIVEWAY OPENING, USING BOTH TRANSITION AND HEADER CURBS (CITY DETAIL R608-5). THE MAIN SIDEWALK THOROUGHFARE IS TO BE MAINTAINED CONTINUOUS, TRUE TO LINÉ AND GRADE ACROSS ALL DRIVEWAY OPENINGS.
- 10. SEE DEMOLITION AND UTILITY PLANS FOR EXISTING PAVEMENT AND SIDEWALK REPLACEMENT LIMITS FOR UTILITY INSTALLATIONS.
- 11. ANY PROJECT SIGNAGE IS TO BE SUBMITTED TO THE CITY FOR REVIEW AND APPROVAL.
- 12. ANY WORK IN THE CITY PUBLIC RIGHT-OF-WAY WILL REQUIRE SEPARATE PERMITS FROM THE DES ENGINEERING BUREAU PERMIT OFFICE; ROOM 1218.
- REQUIRES APPROVAL FROM THE MONROE COUNTY OFFICE.
- 14. CONTACT DES PERMIT OFFICE AT 585-428-6848 TO OBTAIN A RIGHT-OF-WAY PERMIT FOR ANY CURB, SIDEWALK, UTILITY CONNECTIONS, TEMPORARY FENCING OR SCAFFOLDING WORK PLACED IN THE PUBLIC RIGHT-OR-WAY.
- 15. ALL UTILITY TRENCH, PAVEMENT AND CONCRETE SIDEWALK RESTORATION WITHIN THE RIGHT-OF-WAY ARE TO BE DONE USING CITY OF ROCHESTER STANDARDS.
- 16. CONTACT THE GARAGEPARKING@CITYOFROCHESTER.GOV TO COORDINATE REMOVAL OF PARKING METERS DURING CONSTRUCTION.

NOT APPROVED

This plan has not received final approval of all reviewing agencies. This plan is subject to revisions until all approvals are obtained and should not be used for construction

Drawing Alteration The following is an excerpt from the New York State Education Law Article 145 Section 7209 and applies to this drawing: "It is a violation of this law for any

person, unless he is acting under the direction of a licensed professional engineer or land surveyor to alter any item in any way. If an item bearing th seal of an engineer or land surveyor is altered, the altering engineer or land surveyor shall affix to the item his seal and the notation "altered by" followed by his signature and the date of such alteration, and a specific description of the alteration."

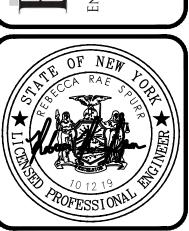



PROJECT MANAGER JL. SWEDROCK

PROJECT ENGINEER RR. SPURR DRAWN BY VJ. SCHLAGETER SCALE DATE ISSUED

DECEMBER 07, 202 PROJECT NO.


DRAWING NO.

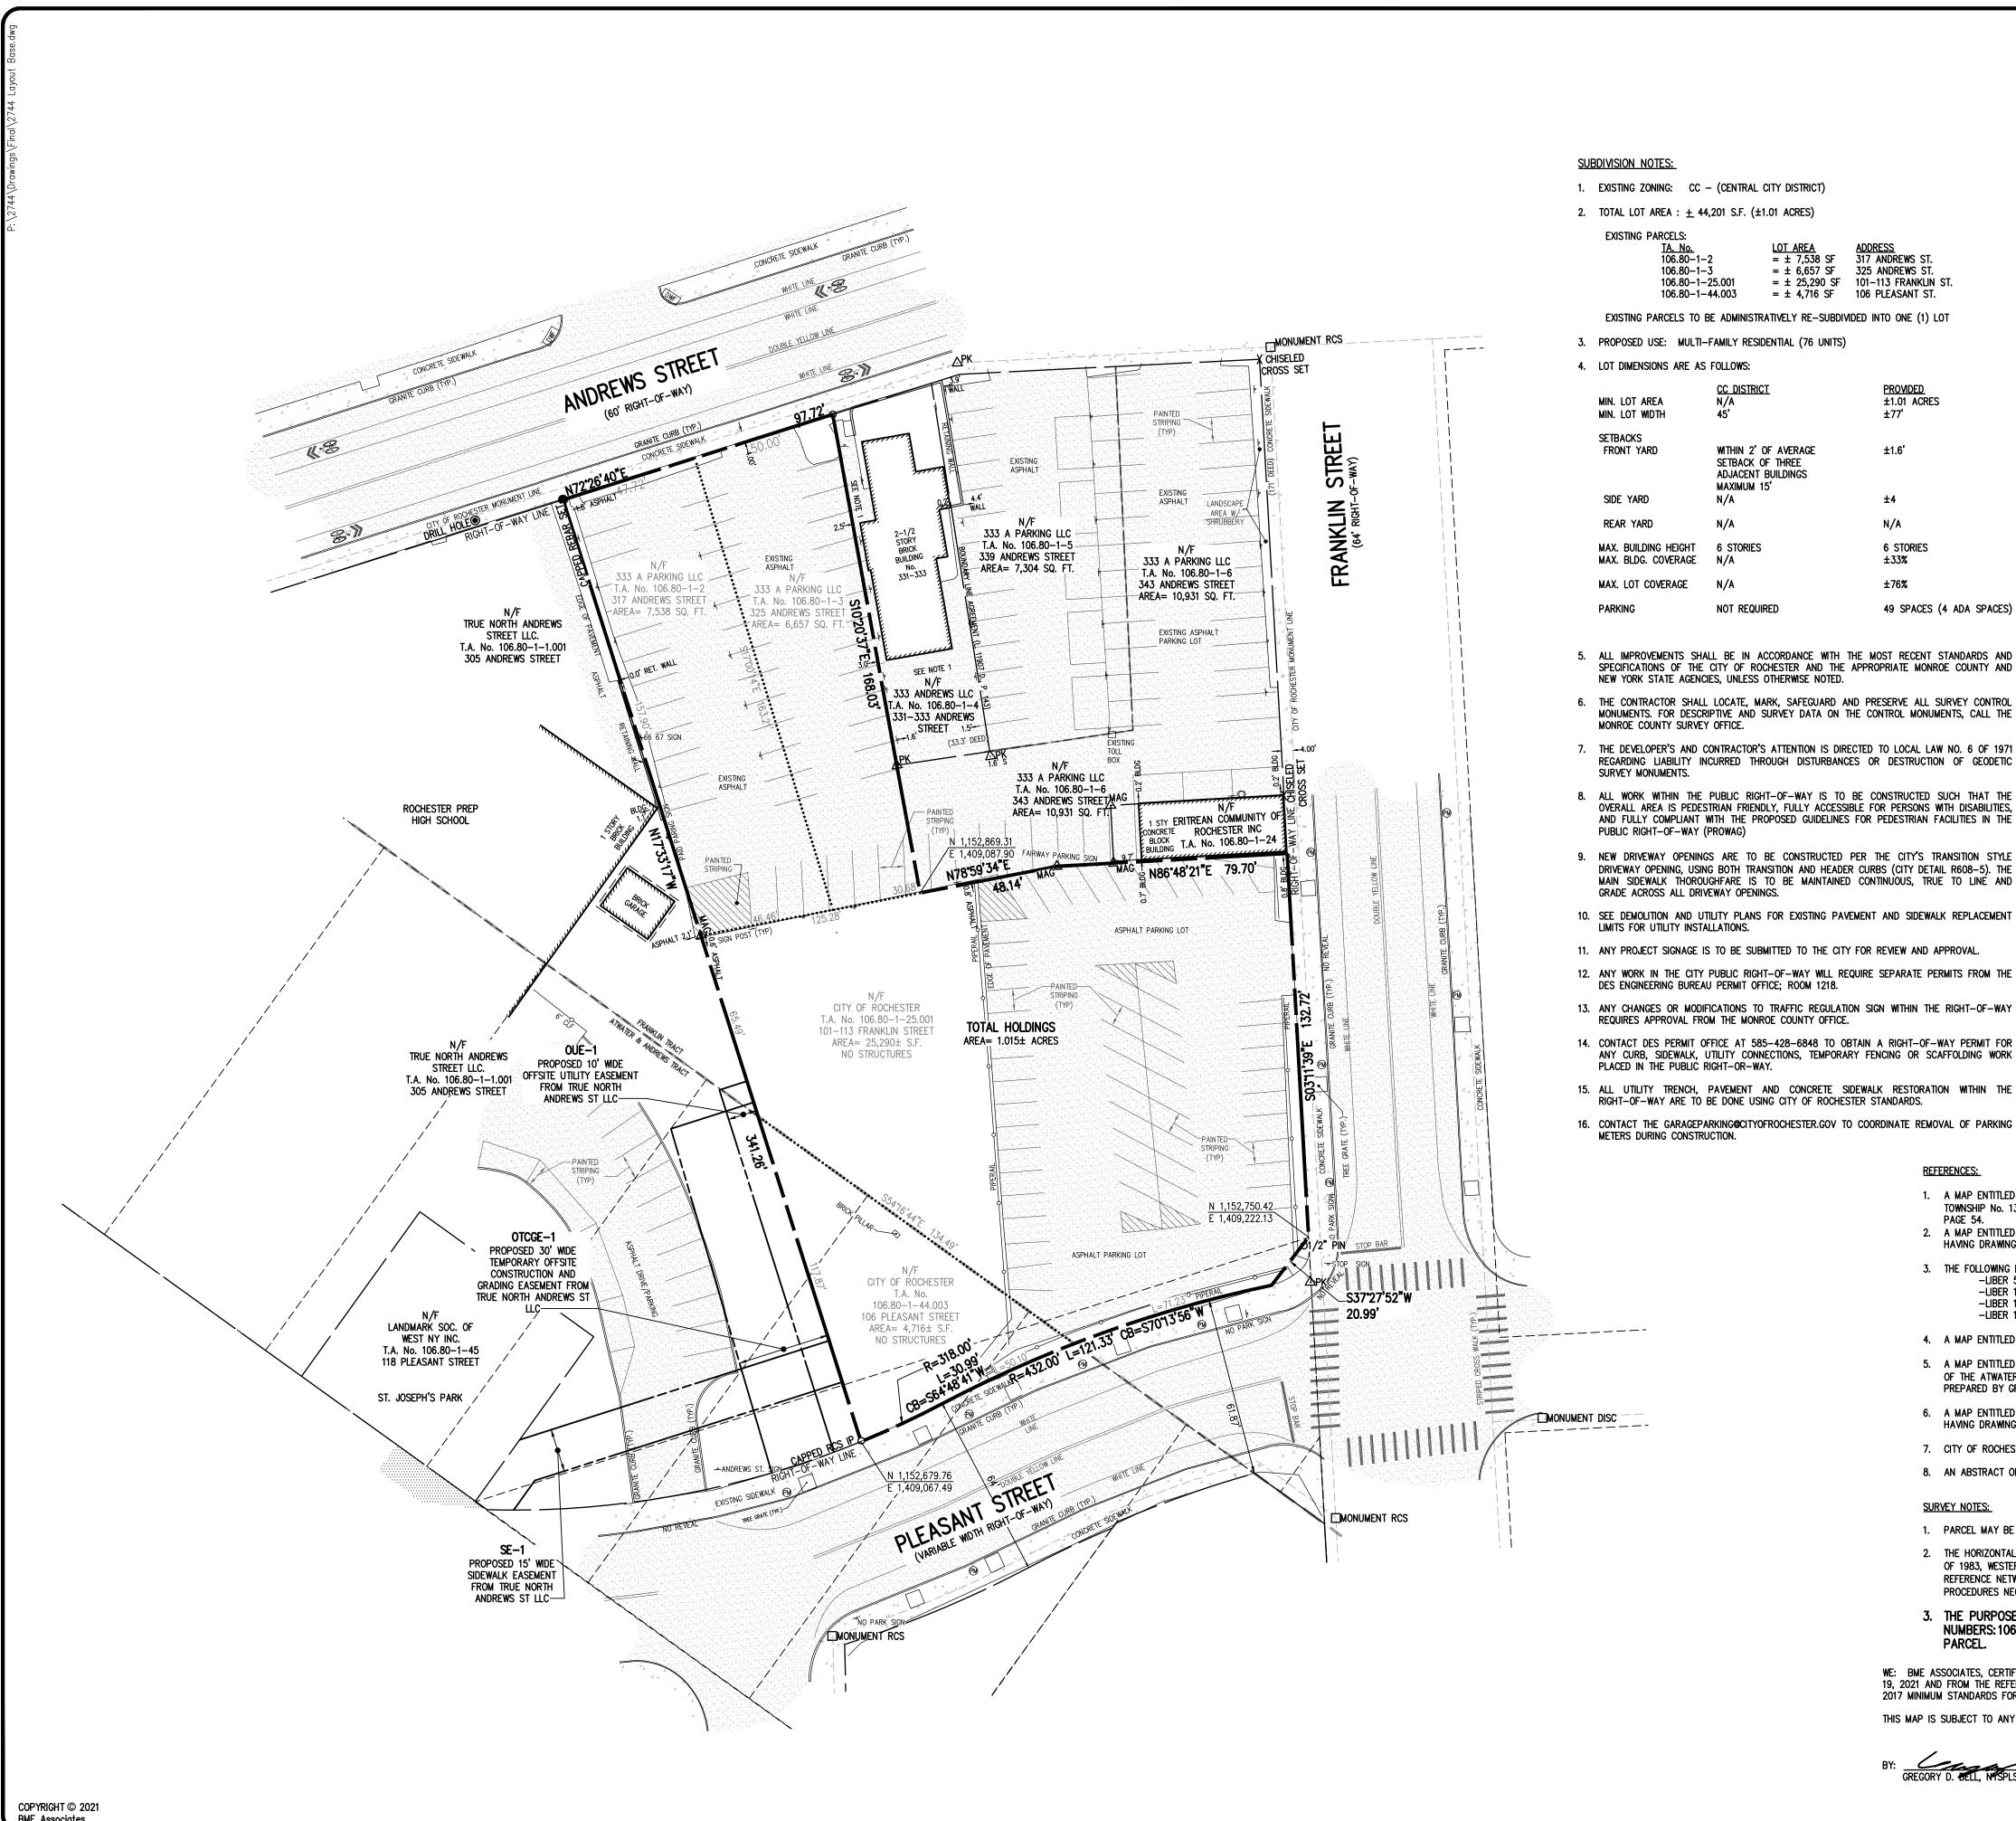

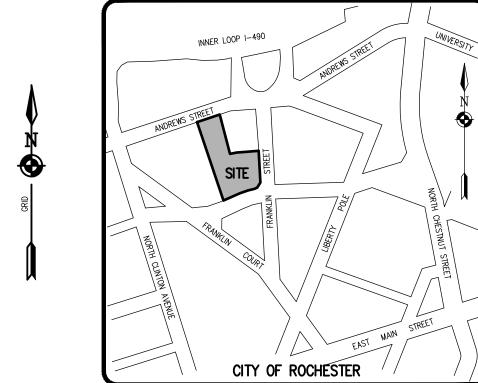

LOCATION MAP NOT TO SCALE

<u>LEGEND</u>

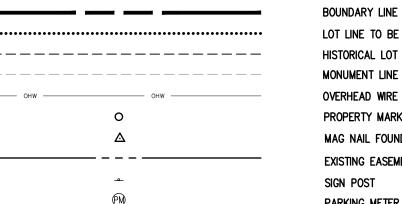

LOT LINE TO BE DISSOLVED HISTORICAL LOT LINE MONUMENT LINE OVERHEAD WIRE PROPERTY MARKER FOUND MAG NAIL FOUND EXISTING EASEMENT LINE

PARKING METER

GRAPHIC SCALE (IN FEET) 1 inch = 30 ft.

The following is an excerpt from the New York State Education Law Article 145 Section 7209 and applies to this

drawing:
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alteration, and a specific description of the alteration."

REFERENCES: 1. A MAP ENTITLED "MAP OF THE SUBDIVISION OF LOTS 4, 5, 6 & 7 IN THE 3RD DIVISION IN THE ORIGINAL TOWNSHIP No. 13, IN THE 7TH RANGE." AS FILED IN THE MONROE COUNTY CLERK'S OFFICE AT LIBER 2 OF MAPS,

2. A MAP ENTITLED "317, 325, 339 & 343 ANDREWS ST., MAP OF A SURVEY," PREPARED BY BME ASSOCIATES, HAVING DRAWING No. 8901-246, DATED APRIL 17, 2020.

3. THE FOLLOWING DEEDS RECORDED IN THE MONROE COUNTY CLERK'S OFFICE:

-LIBER 5779, PAGE 162 -LIBER 11024, PAGE 376 -LIBER 11754, PAGE 502

- 4. A MAP ENTITLED "STREET STUDY MAP No. 1B," PREPARED BY V.W. JUDSON, DATED DECEMBER 1, 1920.
- 5. A MAP ENTITLED "PLAN OF LAND IN ROCHESTER, MONROE COUNTY, NEW YORK, BEING PARTS OF LOTS 79 & 80 OF THE ATWATER & ANDREWS TRACT, T. 13,-R.7-D3, SURVEYED FOR SOCONY VACUUM OIL COMPANY, INC.," PREPARED BY GRAY & SMITH, SURVEYORS, DATED FEBRUARY 8, 1936.
- 6. A MAP ENTITLED "317, 325, 339 & 343 ANDREWS ST., MAP OF A SURVEY," PREPARED BY BME ASSOCIATES, HAVING DRAWING No. 8901-246, DATED APRIL 2018.
- 7. CITY OF ROCHESTER DISTRICT MAP (DISTRICT 14, MAP 1).

-LIBER 11759, PAGE 473

8. AN ABSTRACT OF TITLE WAS NOT PROVIDED FOR THE COMPLETION OF THIS SURVEY.

SURVEY NOTES:

- 1. PARCEL MAY BE BENEFITED BY THE RIGHT TO USE THE PAVEMENT AREAS SHOWN HEREON.
- 2. THE HORIZONTAL DATUM SHOWN HEREON IS REFERENCED TO THE NEW YORK STATE PLANE COORDINATE SYSTEM OF 1983, WESTERN ZONE, NAD 83 (2011)(EPOCH 2010) UTILIZING GPS OBSERVATIONS FROM THE NYSDOT REFERENCE NETWORK STATION (NYPF 0032). PERIMETER AND/OR TIES TO MONUMENTS WERE MADE USING PROCEDURES NECESSARY TO ACHIEVE A HORIZONTAL ACCURACY OF 1 PART IN 10,000 (1:10,000) OR BETTER.
- 3. THE PURPOSE OF THIS PLAT IS TO COMBINE FOUR PARCELS, HAVING TAX ACCOUNT NUMBERS: 106.80-1-25.001, 106.80-1-2, 106.80-1-3 AND 106.80-1-44.003, INTO ONE

WE: BME ASSOCIATES, CERTIFY THAT THIS MAP WAS PREPARED FROM THE NOTES OF AN INSTRUMENT SURVEY COMPLETED BY US ON OCTOBER 19, 2021 AND FROM THE REFERENCES NOTED HEREON. THIS MAP OR PLAT AND THE SURVEY UPON WHICH IT WAS BASED MEETS THE GVLSA 2017 MINIMUM STANDARDS FOR A SURVEY MAP.


THIS MAP IS SUBJECT TO ANY FACTS THAT MAY BE REVEALED BY SOURCES OTHER THAN THOSE REFERENCED HEREON.


CONSOLIDATION

PROJECT MANAGER JL. SWEDROCK PROJECT SURVEYOR

DRAWN BY JT GILMORE SCALE DATE ISSUED 1"=30' FEBRUARY 23, 2022 PROJECT NO.

DRAWING NO.

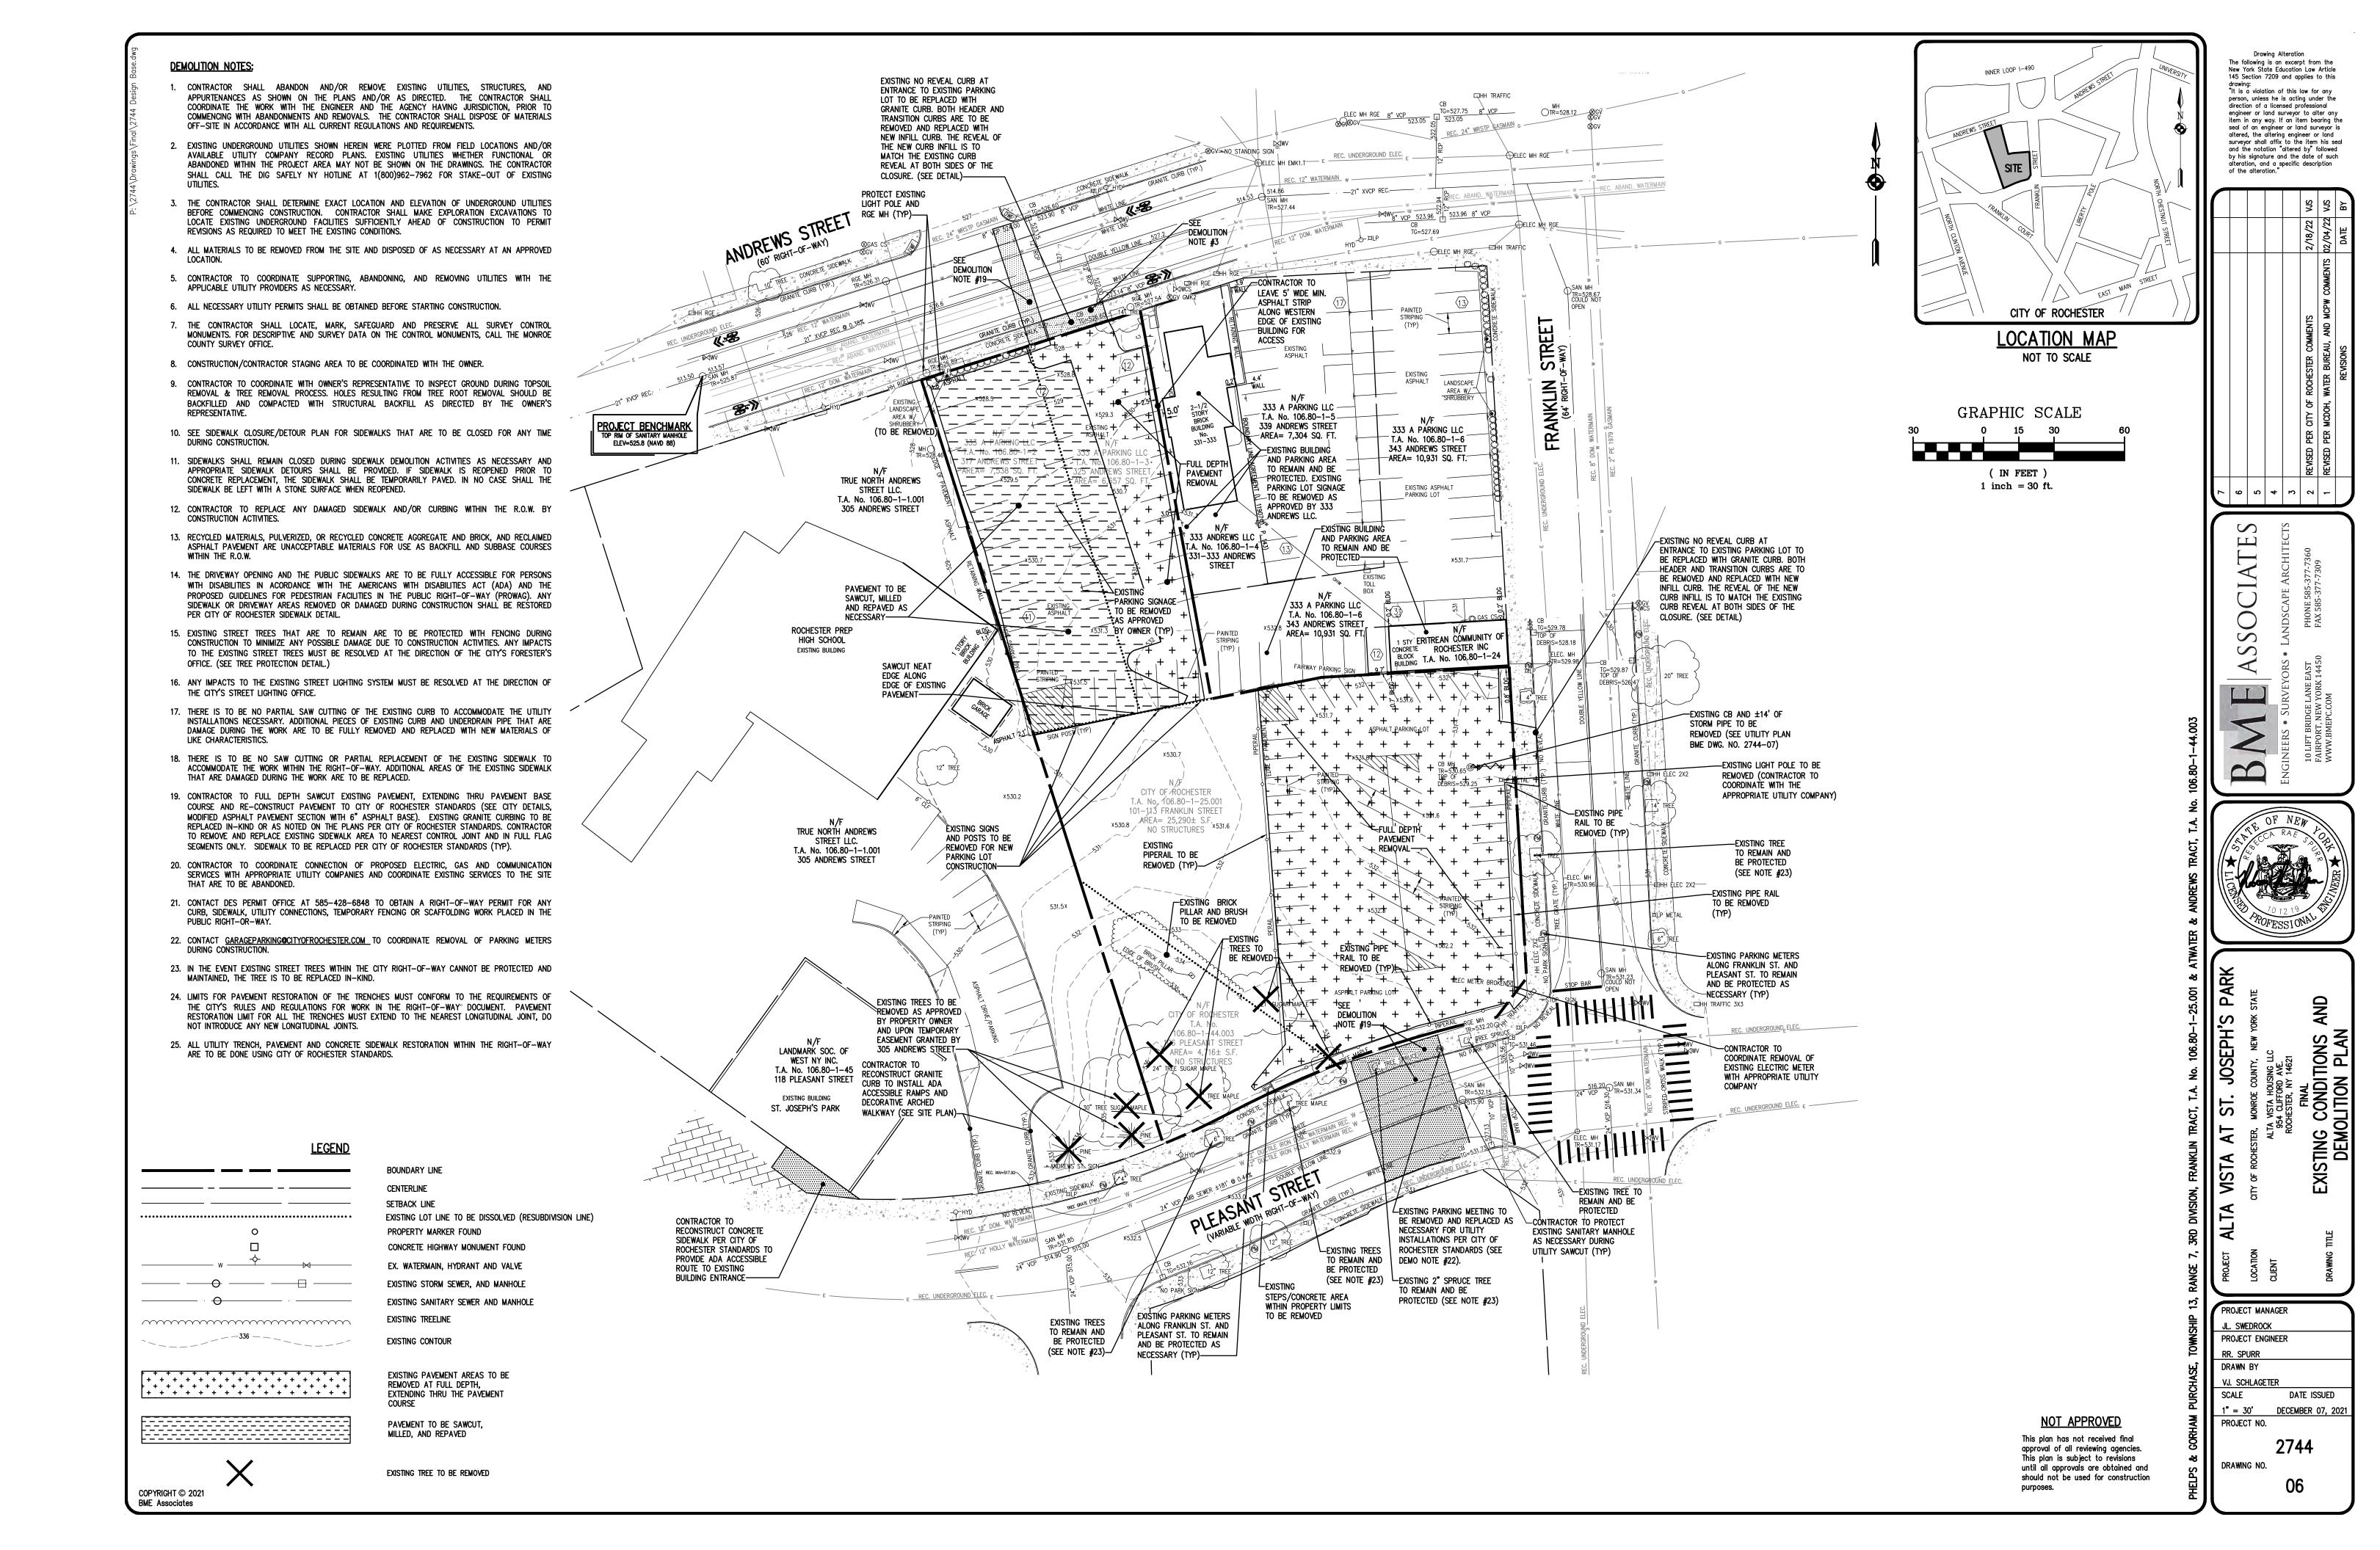

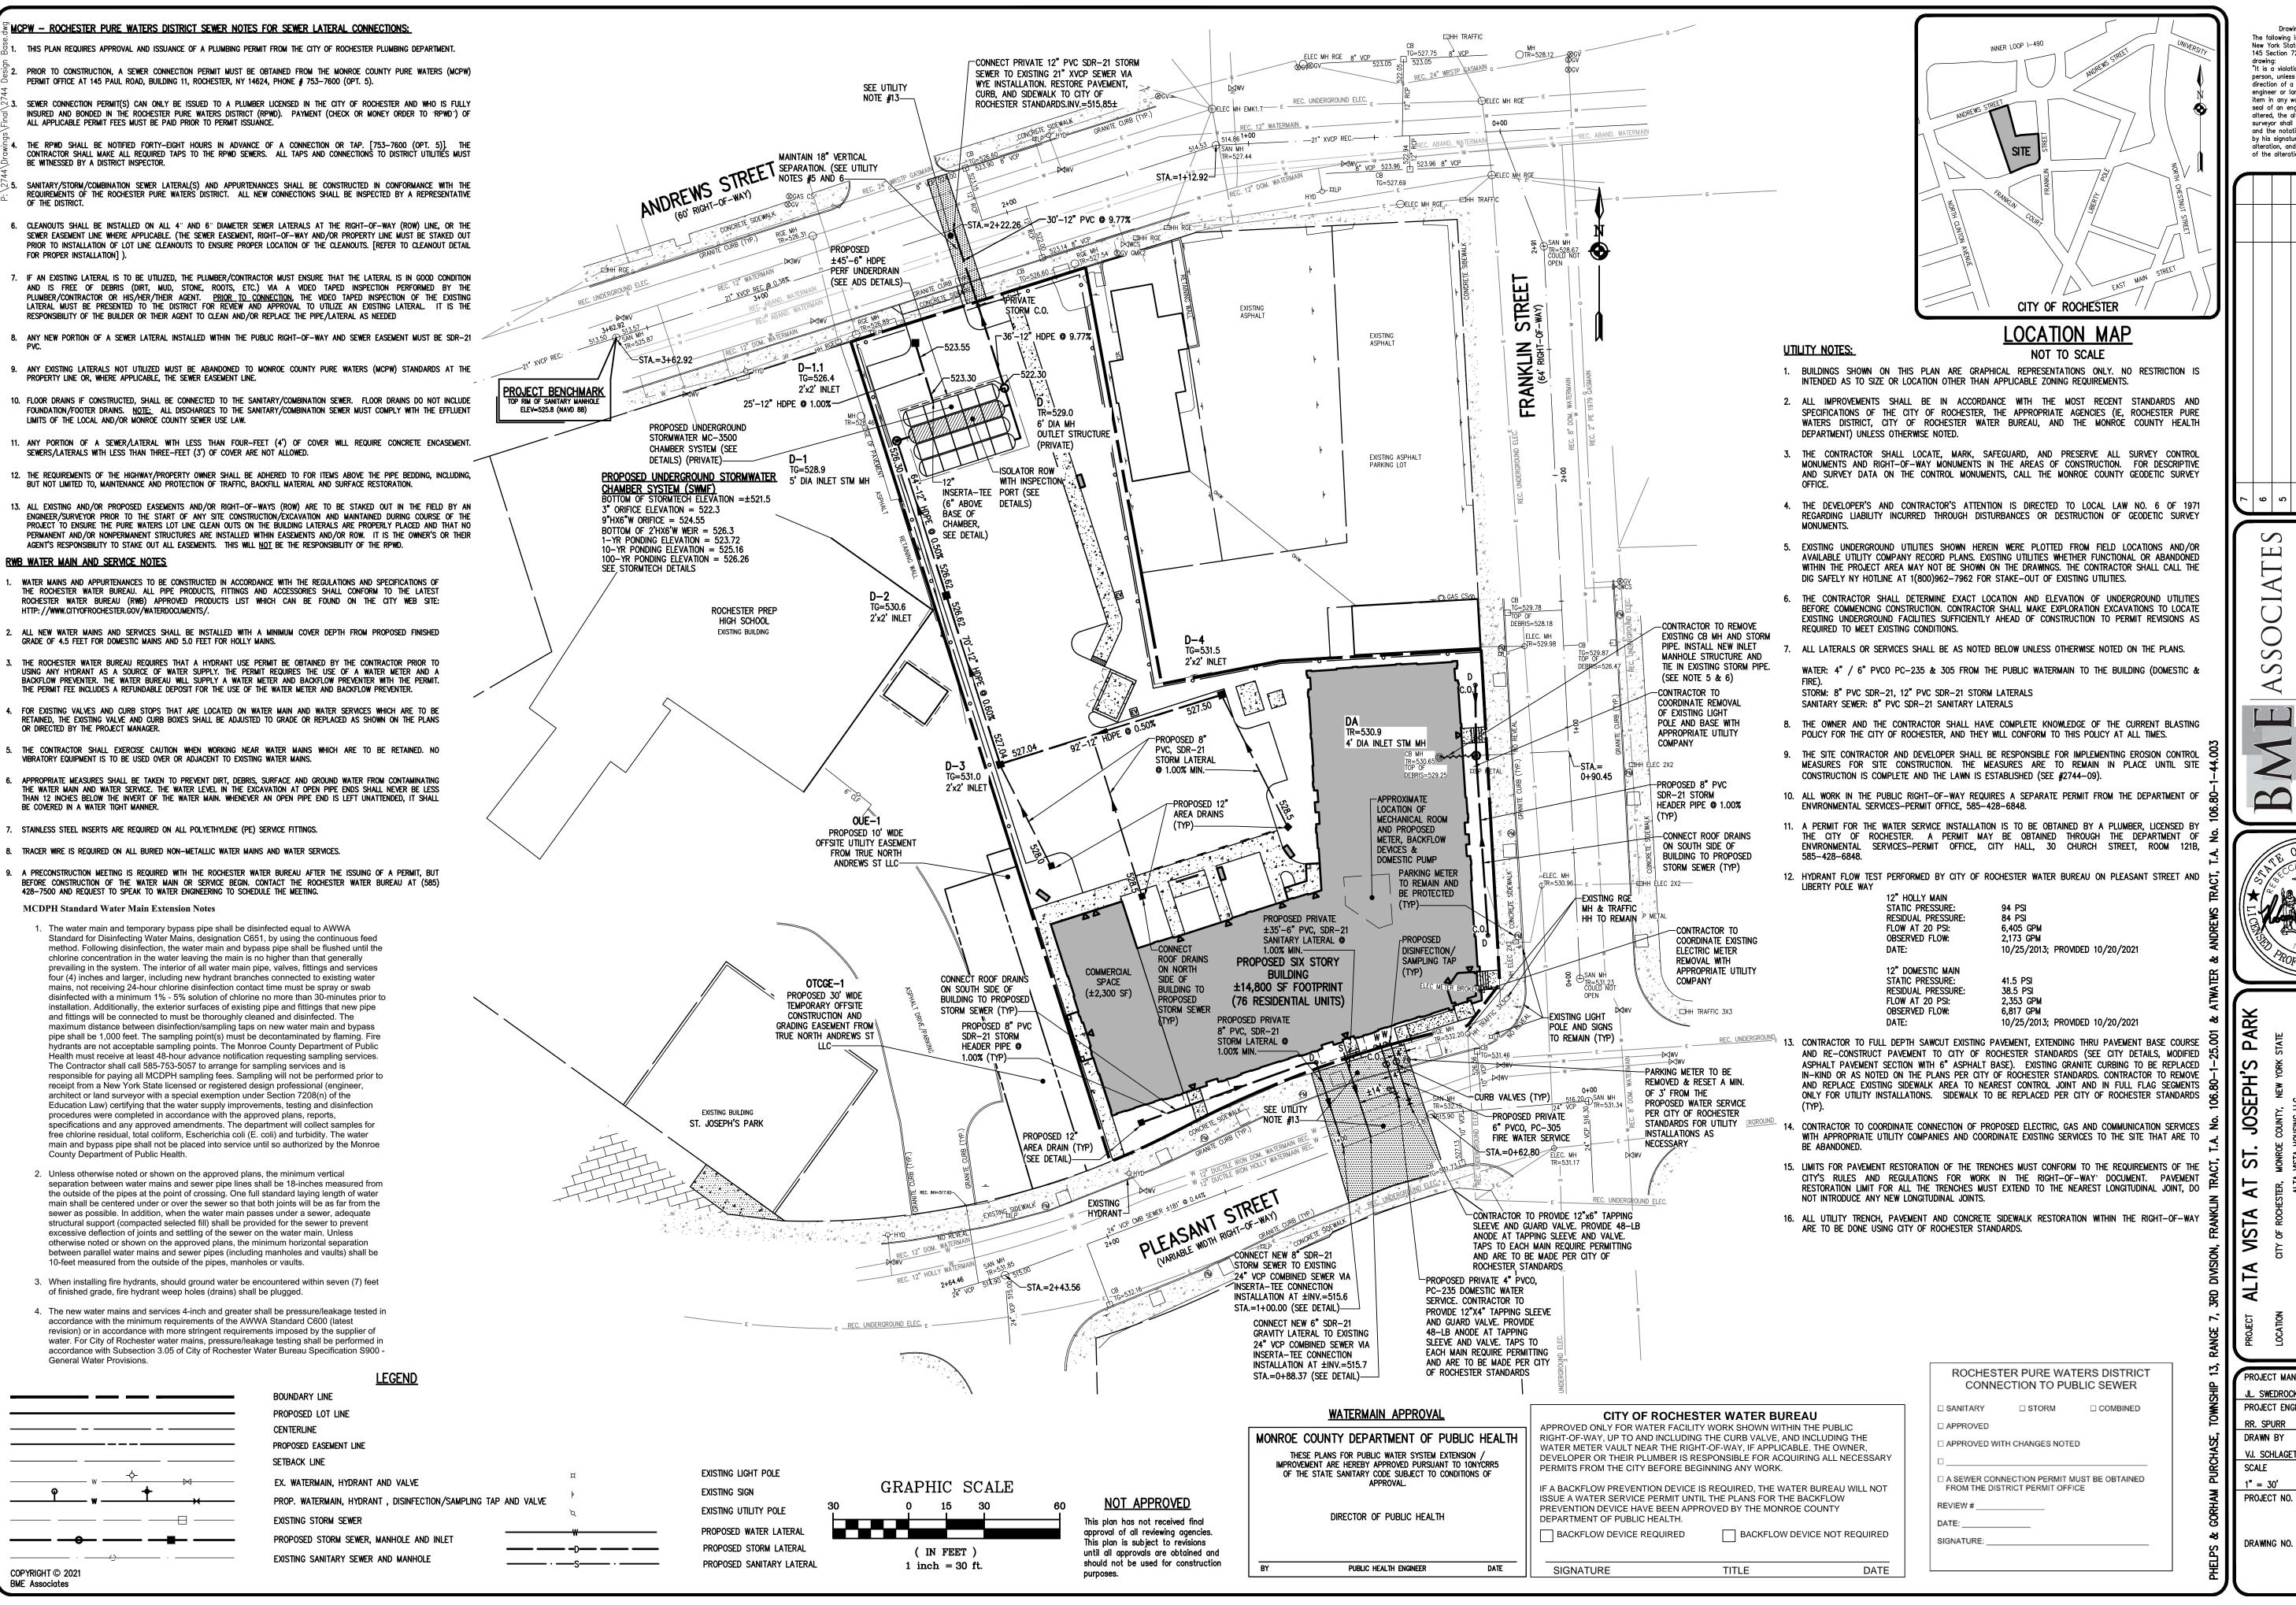


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5 3 2 REVISED PER CITY OF ROCHESTER COMMENTS 2/18/22 VJS 1 REVISED PER MCDOH, WATER BUREAU, AND MCPW COMMENTS 02/04/22 VJS	REVISIONS
AENTS AND MCPW COMMENTS	
2/18/22 VJS 02/04/22 VJS	DATE
NAS VAS	В



PROJECT MANAGER JL. SWEDROCK PROJECT ENGINEER VJ. SCHLAGETER DATE ISSUED DECEMBER 07, 202



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2	REVISED PER CITY OF ROCHESTER COMMENTS	2/18/22 VJ	γ.
1	REVISED PER MCDOH, WATER BUREAU, AND MCPW COMMENTS 02/04/22 VJS	02/04/22	γ.
	REVISIONS	DATE	В
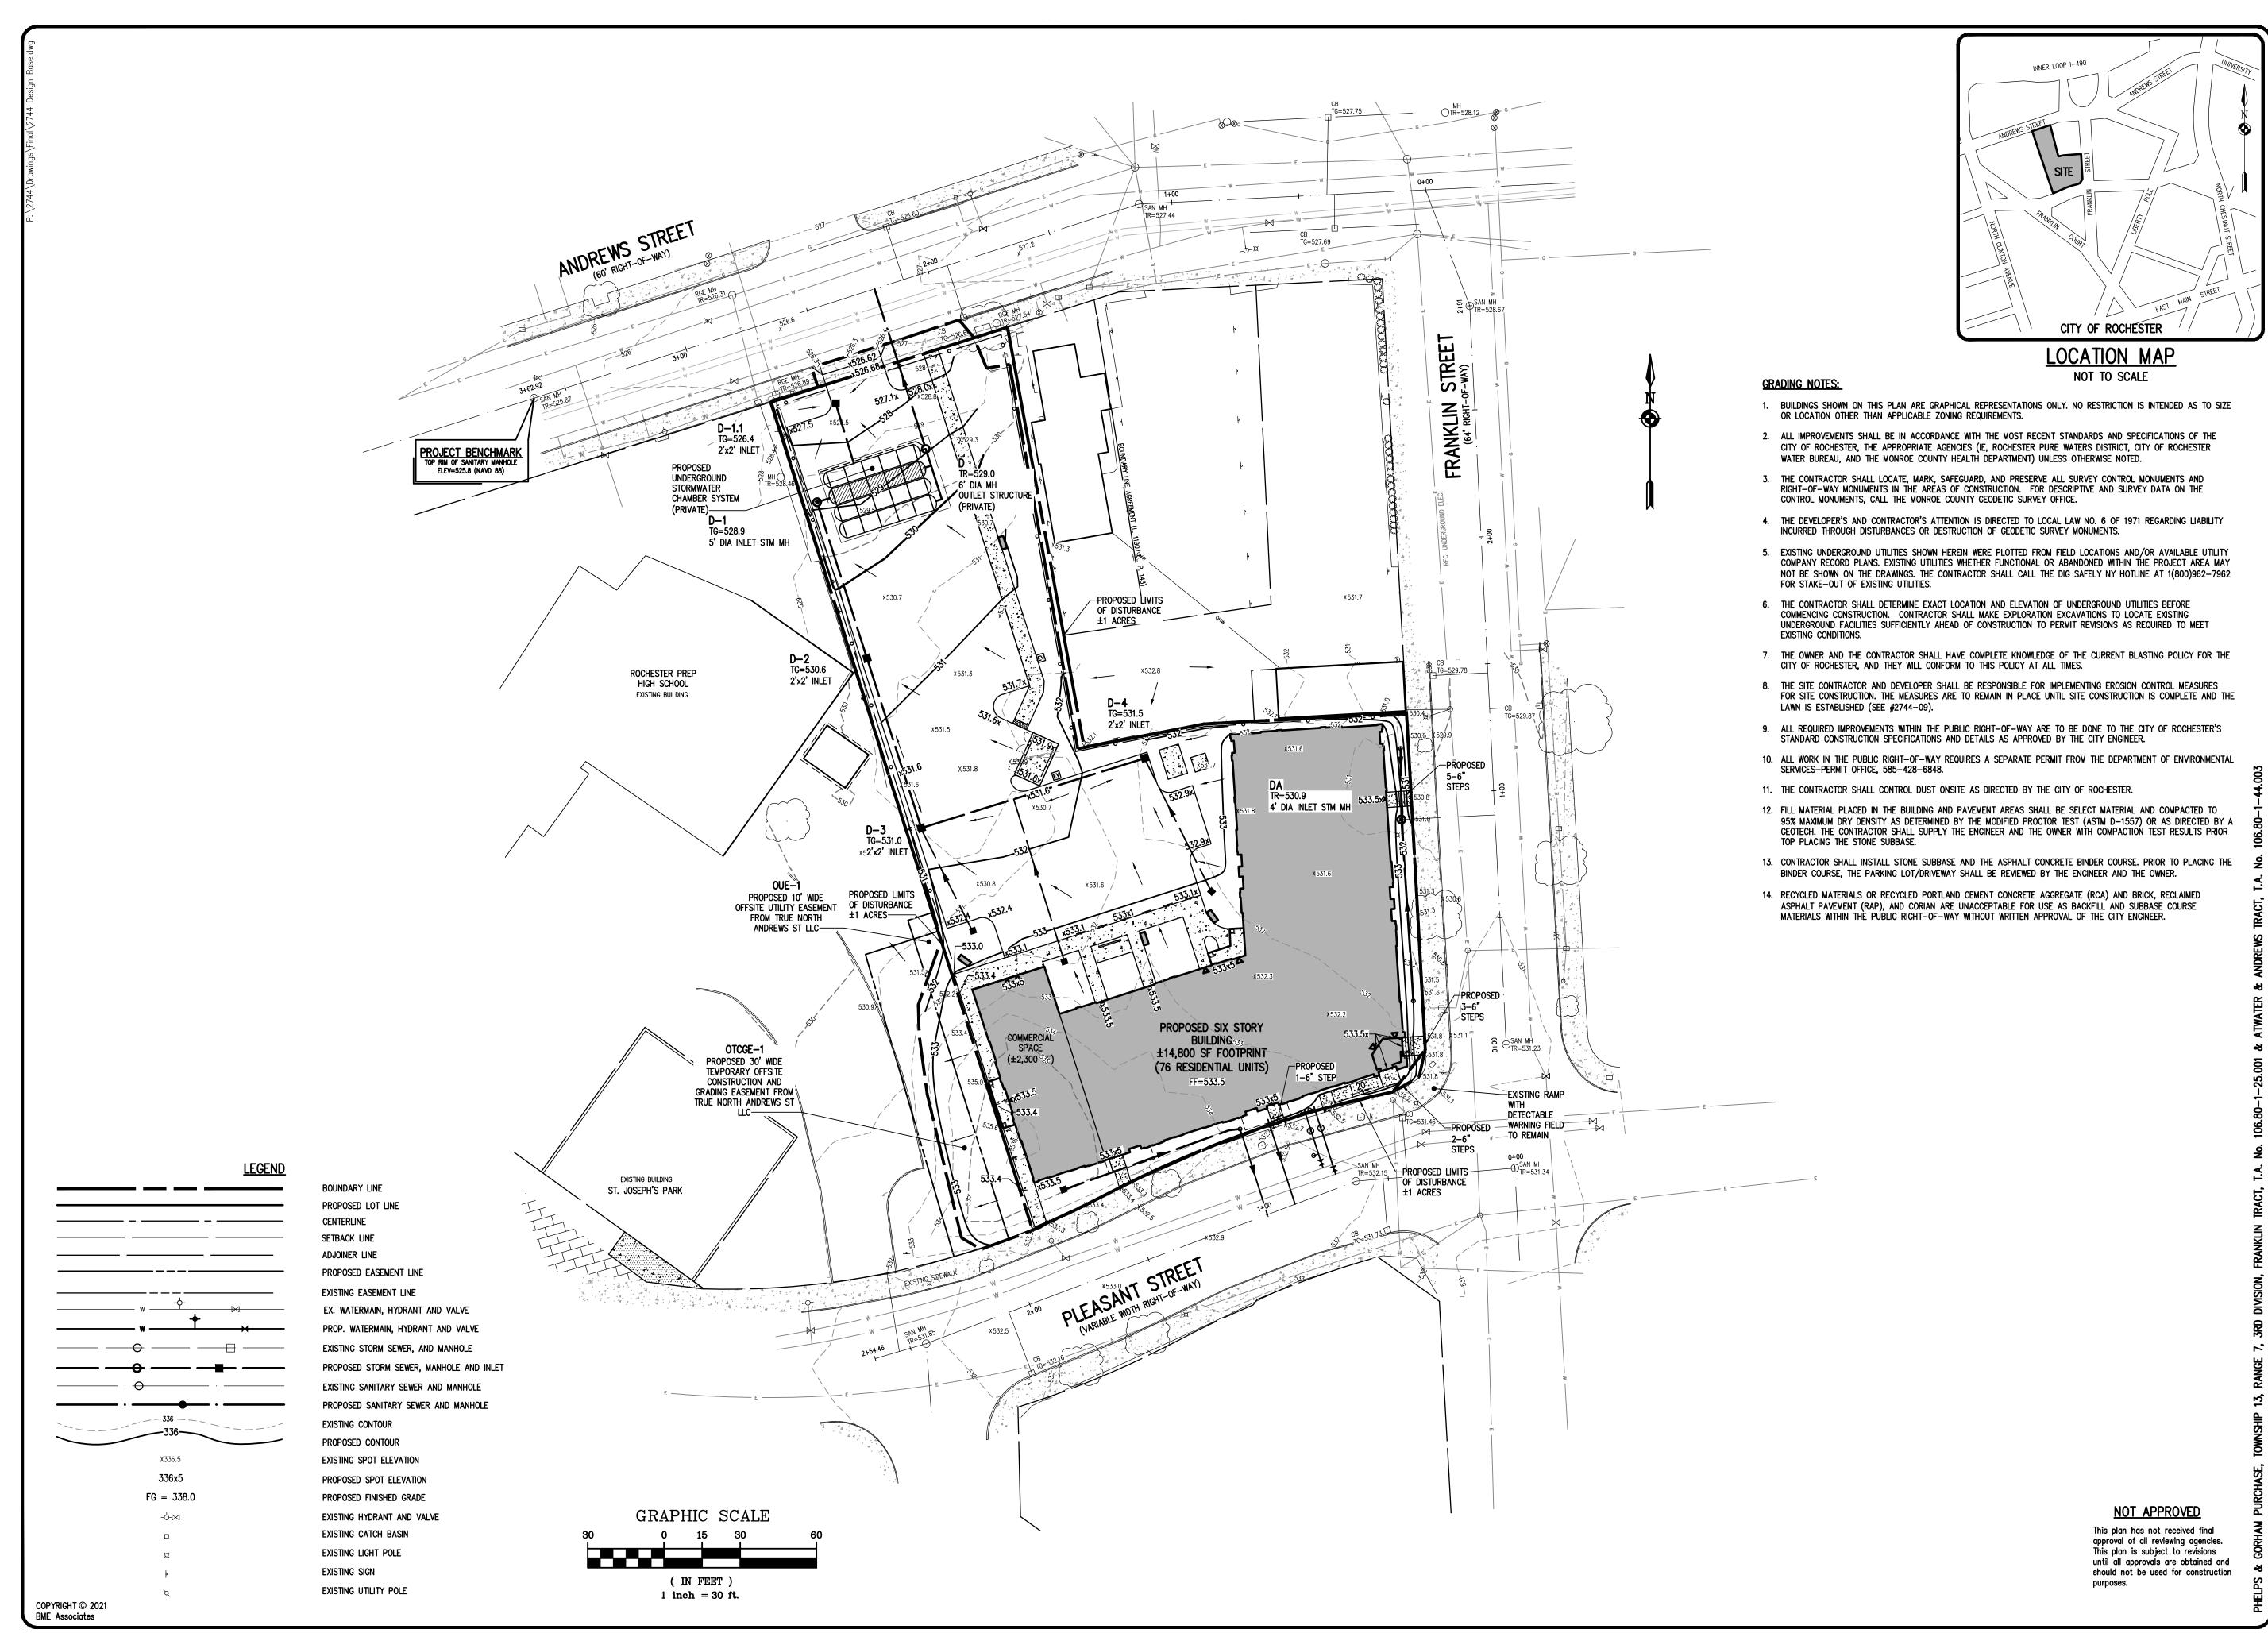
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PROJECT MANAGER PROJECT ENGINEER DRAWN BY VJ. SCHLAGETER SCALE DATE ISSUED

DECEMBER 07, 202 PROJECT NO.

DRAWING NO.

CONSTRUCTION EROSION CONTROL NOTES: 1. THE CONSTRUCTION ACTIVITIES FOR THIS PROJECT REQUIRE THE PREPARATION OF AN EROSION AND SEDIMENT CONTROL PLAN ONLY. THE PROJECT PLANS CONSIST OF THE GRADING PLAN, THE CONSTRUCTION EROSION CONTROL PLAN AND DETAIL SHEETS, AND THE CITY OF ROCHESTER DESIGN AND CONSTRUCTION SPECIFICATIONS REGARDING STORMWATER 2. THE OWNER IS RESPONSIBLE FOR IMPLEMENTING THE REQUIRED CONSTRUCTION EROSION CONTROL PLAN. THE OWNER'S CONTRACTOR, SUB-CONTRACTOR AND ALL OTHERS ASSOCIATED WITH THE IMPLEMENTATION OF THE PLAN SHALL BE FAMILIAR WITH THE PLAN AND THE CONDITIONS OF THE CITY OF ROCHESTER FOR STORMWATER DISCHARGES FROM 3. THE OWNER'S CONTRACTOR/REPRESENTATIVE SHALL IDENTIFY AT LEAST ONE INDIVIDUAL TO BE TRAINED FROM THEIR COMPANY THAT WILL BE RÉSPONSIBLE FOR IMPLEMENTATION OF THE COSNITRUCTION EROSION CONTROL PLAN. THE OWNER/OPERATOR SHALL ENSURE THAT AT LEAST ONE OF THE TRAINED INDIVIDUALS IS ON SITE ON A DAILY BASIS WHEN SOIL DISTURBANCE ACTIVITIES ARE BEING PERFORMED. 4. FOR DISTURBANCES LESS THAN 5 ACRES, IN AREAS WHERE SOIL DISTURBANCE ACTIVITY HAS TEMPORARILY OR PERMANENTLY CEASED, THE APPLICATION OF SOIL STABILIZATION MEASURES MUST BE INITIATED BY THE END OF THE NEXT BUSINESS DAY AND COMPLETED WITHIN 14 DAYS. FROM THE DATE THE CURRENT SOIL DISTURBANCE ACTIVITY CEASED. IF THE SEASON PREVENTS THE ESTABLISHMENT OF TEMPORARY GROUNDCOVER, THE DISTURBED AREAS SHALL BE MULCHED WITH STRAW OR EQUIVALENT MATERIAL. 5. THE OWNER'S CONTRACTOR SHALL BE RESPONSIBLE FOR THE ESTABLISHMENT, MAINTENANCE, CLEANING, REPAIR AND REPLACEMENT OF EROSION CONTROL MEASURES DURING SITE CONSTRUCTION. 6. ALL DISTURBED AREAS TO BE RECLAIMED WITH A MINIMUM OF 6" TOPSOIL. 7. TEMPORARY SEEDING OF DISTURBED AREAS SHALL BE PROVIDED AS FOLLOWS: THE SURFACE TWO INCHES OF SOIL SHOULD BE LOOSENED BY DISKING, RAKING, OR BACK-BLADING WITH A BULLDOZER. IMMEDIATELY FERTILIZE WITH 300 LBS PER ACRE (OR 7 LBS. PER 1000 SQ. FT.) OF 10-10-10 FERTILIZER. IMMEDIATELY SEED WITH THE FOLLOWING MIX: ANNUAL RYEGRASS PERENNIAL RYEGRASS WHITE CLOVER (+ INOCULANT) SEED SHOULD HAVE A GERMINATION RATE OF AT LEAST 85 PERCENT AND MINIMAL INERT MATERIAL. 8. DISTURBED AREAS SHALL BE STABILIZED USING PERMANENT LAWN SEEDING MIX UPON COMPLETION OF GRADING AND CONSTRUCTION: LBS/ACRE % BY PURITY % GERM PERENNIAL RYE GRASS RED FESCUE KENTUCKY BLUEGRASS SEEDING RATE: 6.0 LBS PER 1,000 SQ FT. MULCH: STRAW OR WOOD FIBER MULCH USED WITH HYDROSEEDING METHOD, AT TWO TONS PER ACRE WITH TACKIFIER STARTING FERTILIZER: 5-10-10 AT 20 LBS PER 1,000 SQ. FT 9. ALL SEEDED AREAS ARE TO BE MONITORED FOR GERMINATION AND EROSION. ERODED AREAS ARE TO BE BACKFILLED, FINE GRADED AND RE-SEEDED. AREAS THAT FAIL TO GERMINATE A MINIMUM OF 80% SHALL BE RE-SEEDED. 10. ANY EXCAVATIONS THAT MUST BE DEWATERED SHALL BE PUMPED INTO AN APPROVED FILTERING DEVICE BEFORE ENTERING AN ACTIVE DRAINAGE SYSTEM OR DISPERSED TO AN UNDISTURBED AREA. 11. THE OWNER SHALL BE RESPONSIBLE FOR REMOVING EXISTING EROSION CONTROL MEASURES THAT ARE LOCATED WITHIN ESTABLISHED AREAS. MATERIALS ARE TO BE DISPOSED OF PROPERLY. 12. CONTRACTOR TO INSTALL PROPOSED PERIMETER SECURITY FENCE/CONSTRUCTION FENCE AS NECESSARY AND AS DETERMINED IN THE FIELD AROUND THE PERIMETER OF THE SITE. **LEGEND** X336.5 EXISTING SPOT ELEVATION FG = 338.0

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PROPOSED LOT LINE

EXISTING CONTOUR

PROPOSED CONTOUR

PROPOSED SPOT ELEVATION

PROPOSED FINISHED GRADE

PROPOSED INLET PROTECTION

PROPOSED LIMIT OF DISTURBANCE

PROPOSED SILT FENCE

DRAINAGE FLOW DIRECTION

EX. WATERMAIN, HYDRANT AND VALVE PROP. WATERMAIN, HYDRANT AND VALVE EXISTING STORM SEWER, AND MANHOLE

PROPOSED STORM SEWER, MANHOLE AND INLET


GRAPHIC SCALE


(IN FEET)

1 inch = 30 ft.

EXISTING SANITARY SEWER AND MANHOLE PROPOSED SANITARY SEWER AND MANHOLE

CENTERLINE SETBACK LINE ADJOINER LINE

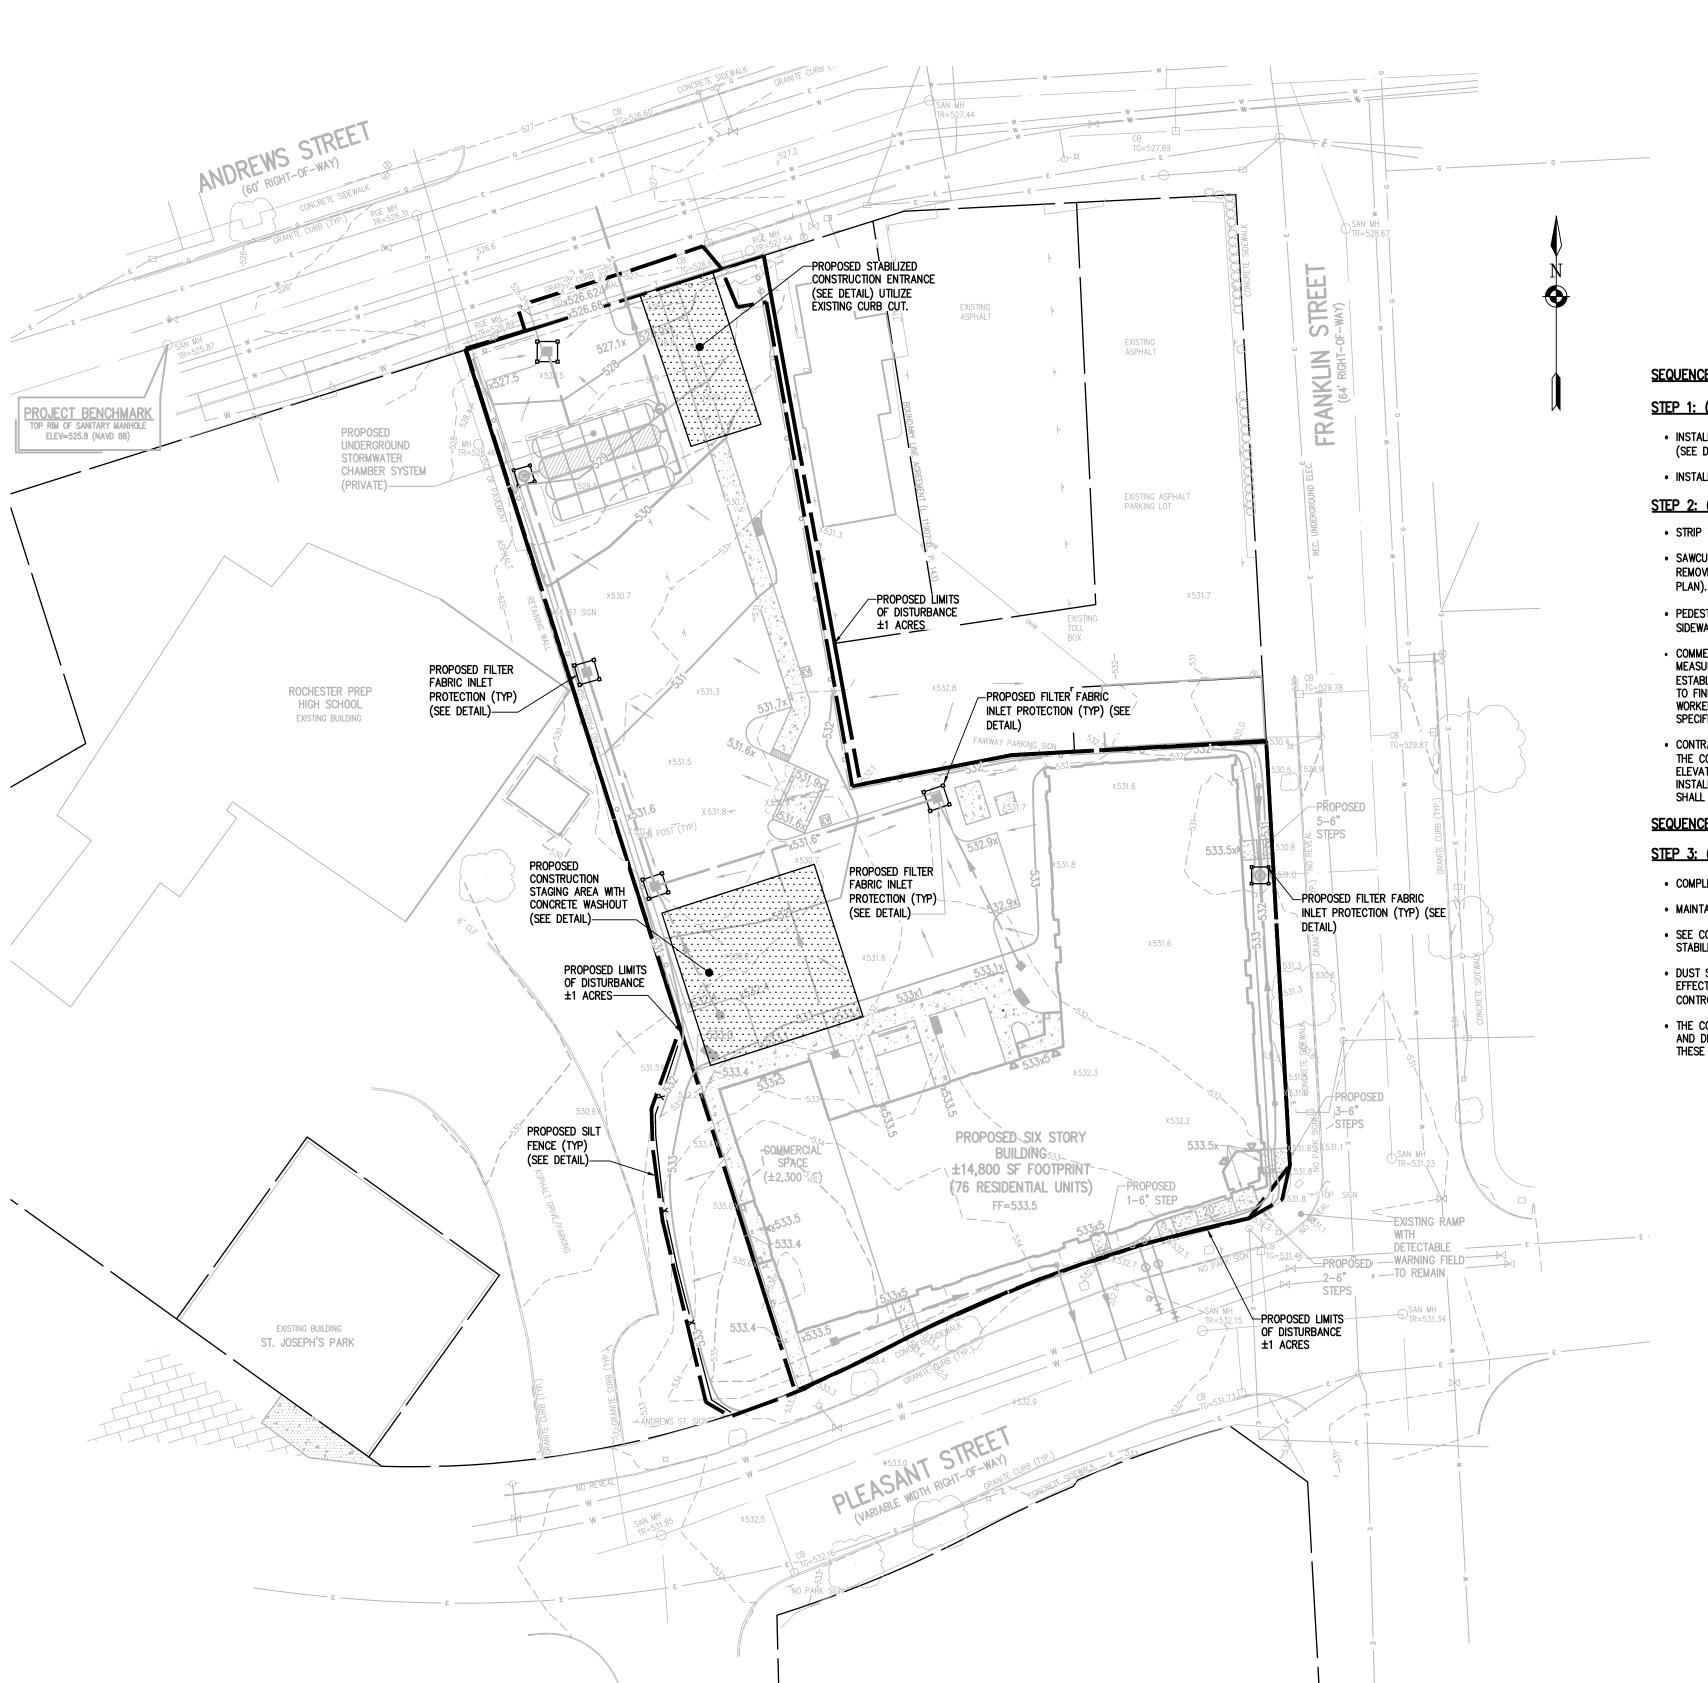

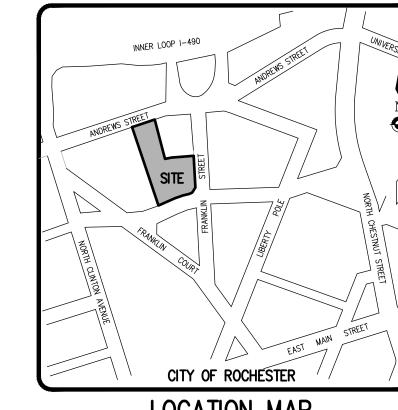

SEQUENCE OF CONSTRUCTION STEPS:

STEP 1: (SITE PREPARATION AND DEMOLITION)

- INSTALL AND MAINTAIN PERIMETER SECURITY FENCE, STABILIZED CONSTRUCTION ENTRANCE
- INSTALL PERIMETER SILT FENCE

STEP 2: (CONSTRUCTION ACTIVITY)

- STRIP TOPSOIL FROM THE SITE AND REMOVE FROM SITE.
- SAWCUT AND REMOVE EXISTING ASPHALT FROM THE SITE AS REQUIRED. CONTRACTOR TO REMOVE EXISTING STRUCTURES, UTILITIES, FENCE, SIGNAGE, SIDEWALK ETC. (SEE DEMOLITION
- PEDESTRIAN AND VEHICLE ACCESS IS TO BE MAINTAINED TO ADJACENT PROPERTIES (SEE
- COMMENCE GRADING OPERATIONS. INSTALL ADDITIONAL EROSION CONTROL MEASURES. MEASURES ARE TO BE MAINTAINED BY THE CONTRACTOR UNTIL GROUND COVER HAS BEEN ESTABLISHED AND REMOVAL IS APPROVED BY THE CITY/GOVERNING AGENCY. CONTRACTOR TO FINE GRADE, SEED, AND MULCH AREAS DISTURBED AREAS WITHIN 7 DAYS IF NOT WORKED WITHIN 7 DAYS. SEED WITH SEED MIX AS INDICATED, AND PROVIDE MULCH AS
- CONTRACTOR MAY INSTALL UTILITIES AND LATERALS DURING GRADING OPERATIONS. IT IS THE CONTRACTOR'S RESPONSIBILITY TO STABILIZE THE SITE AND VERIFY GRADING ELEVATIONS PRIOR TO UTILITY CONSTRUCTION. THE STORMTECH CHAMBER SYSTEM TO BE INSTALLED PRIOR TO STABILIZATION OF THE SITE. ADDITIONAL EROSION CONTROL MEASURES

STEP 3: (STABILIZATION & MONITORING)

- COMPLETE INSTALLATION OF UNDERGROUND UTILITIES.
- DUST SHALL BE CONTROLLED DURING CONSTRUCTION BY THE CONTRACTOR TO MINIMIZE EFFECT ON THE ADJACENT PROPERTIES. THE CONTRACTOR SHALL IMPLEMENT DUST CONTROL MEASURES AS NEEDED AND/OR AS DIRECTED BY THE CITY OR OWNER.

- (SEE DETAIL), AND CONSTRUCTION STAGING AREA

- PLAN). CONTRACTOR TO PREPARE SITE AS NECESSARY.
- SIDEWALK CLOSURE PLAN).
- SPECIFIED IN THE CONSTRUCTION EROSION CONTROL NOTES.
- SHALL BE PROVIDED AS SHOWN IN THE PLANS, OR AS DIRECTED.

SEQUENCE OF CONSTRUCTION STEPS:

- MAINTAIN SILT FENCE
- SEE CONSTRUCTION EROSION CONTROL NOTES FOR REQUIRED SEED MIXES AND WINTER SITE
- AND DRAINAGE CHANNELS FREE OF MUD, DIRT, AND DEBRIS. THE CONTRACTOR WILL CLEAN THESE AREAS AS NECESSARY OR AS REQUIRED BY THE OWNER OR CITY OF ROCHESTER.

Drawing Alteration The following is an excerpt from the New York State Education Law Article

145 Section 7209 and applies to this

person, unless he is acting under the direction of a licensed professional

engineer or land surveyor to alter any item in any way. If an item bearing th

seal of an engineer or land surveyor is altered, the altering engineer or land surveyor shall offix to the item his seal

by his signature and the date of such alteration, and a specific description of the alteration."

PROJECT MANAGER PROJECT ENGINEER DRAWN BY SCALE

DECEMBER 07, 202 PROJECT NO.

DRAWING NO.


NOT APPROVED

This plan has not received final approval of all reviewing agencies.

purposes.

This plan is subject to revisions

until all approvals are obtained and should not be used for construction

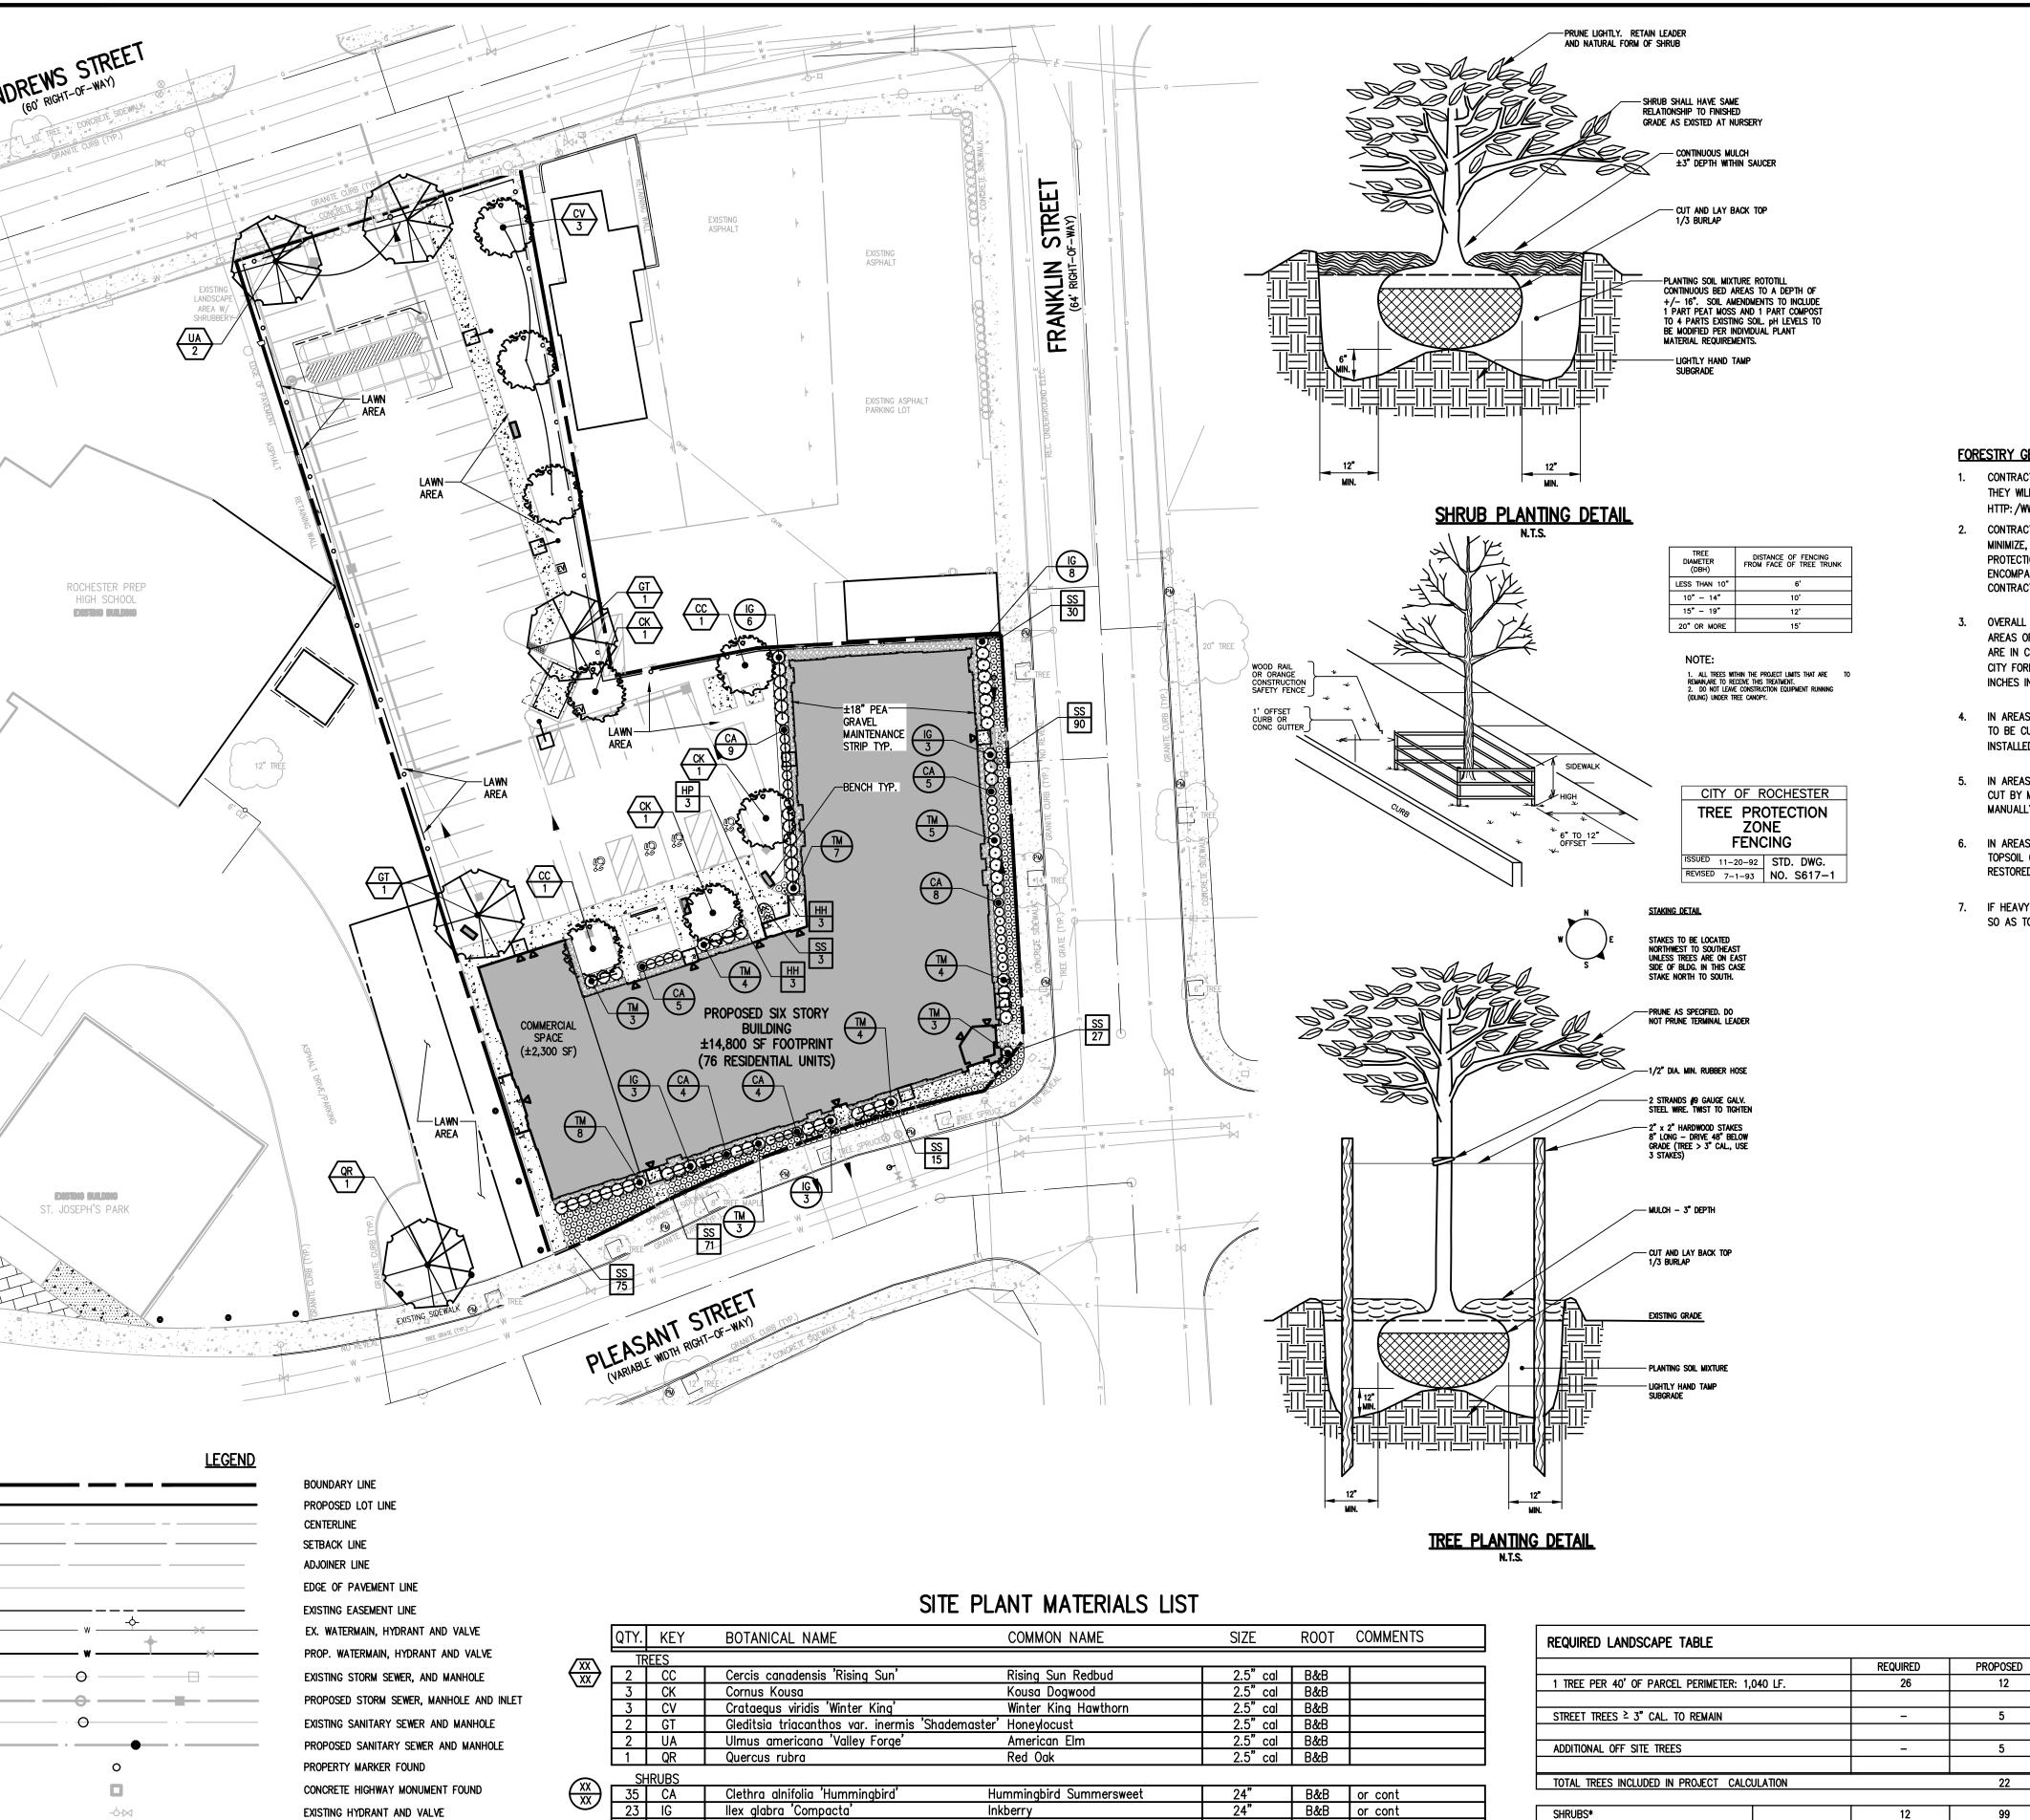

<u>Dense Yew</u>

Coral Bells

Little Bluestem

Happy Returns Daylily

41 TM Taxus X media 'Densiformis'

6 HH Hemerocallis 'Happy Returns'

Heuchera 'Southern Comfort

311 SS Schizachyrium scoparium 'Prairie Blues'

EXISTING CATCH BASIN EXISTING LIGHT POLE

EXISTING UTILITY POLE

EXISTING GAS SERVICE

EXISTING SIGN

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B&B or cont

cont. spacing @ 24"


cont. spacing @ 24"

cont. spacing @ 24"

*(MAY SUBSTITUTE 3 SHRUBS PER TREE)

THE PROJECT PROVIDES 22 TREES + 99 SHRUBS WHICH EXCEEDS THE LANDSCAPE REQUIREMENT.

TOTAL SHRUBS

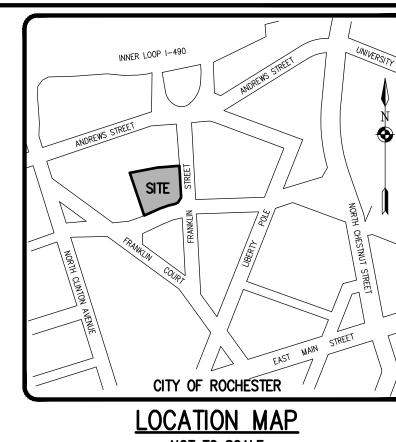

NOT TO SCALE

FORESTRY GENERAL NOTES:

- 1. CONTRACTOR IS TO BE AWARE OF AND FAMILIAR WITH REQUIREMENTS OF SECTIONS 89.9 TREES AND 89.12 PENALTIES OF CITY CODE AS THEY WILL BE STRICTLY ADHERED TO. CITY CODE CAN BE FOUND ON CITY OF ROCHESTER'S WEB SITE AT HTTP:/WWW.CITYOFROCHESTER.GOV/SERVICES, UNDER 'CITY CHARTER AND CODE ONLINE.'
- CONTRACTOR IS TO PROVIDE PROTECTION FOR ALL EXISTING TREES WITHIN PROJECT LIMITS THROUGHOUT COURSE OF PROJECT TO MINIMIZE, AS MUCH AS POSSIBLE, ANY DAMAGE FROM OCCURRING TO EXISTING TREES AS RESULT OF CONTRACTOR'S OPERATIONS. TREE PROTECTION IS TO CONSIST OF ORANGE CONSTRUCTION SAFETY FENCING OR WOOD RAILS PLACED AROUND AND COMPLETELY ENCOMPASSING EACH EXISTING TREE AND IS TO BE IN PLACE BEFORE ANY WORK IS STARTED PER SECTION S617 TREE PROTECTION AND
- OVERALL EXISTING TREE ROOT SYSTEM MUST REMAIN STRUCTURALLY ADEQUATE FOR EXISTING TREE TO WITHSTAND HEAVY WINDSTORMS. IN AREAS OF CURB/CONCRETE, GUTTER/PAVEMENT WORK, ANY EXISTING TREE ROOTS THAT ARE 2 INCHES OR LARGER IN DIAMETER AND ARE IN CONFLICT WITH SUCH WORK, MUST BE INSPECTED BY CITY FORESTRY BEFORE CUTTING CAN OCCUR. CONTRACTOR MUST CONTACT CITY FORESTRY AT (585) 428-7581 TO MAKE ARRANGEMENTS FOR SUCH INSPECTION. EXISTING TREE ROOTS THAT ARE SMALLER THAN 2 INCHES IN DIAMETER ARE TO BE CUT CLEANLY WITH SHARP IMPLEMENTS.
- 4. IN AREAS OF SIDEWALK CONSTRUCTION, EXISTING TREE ROOTS THAT ARE LOCATED UNDER AREA OF SIDEWALK CONSTRUCTION ARE NOT TO BE CUT. IF ANY OF EXISTING TREE ROOTS ARE 2 INCHES OR LARGER IN DIAMETER, SUB BASE COURSE MATERIAL IS NOT TO BE INSTALLED WITHIN 1 FOOT OF EXISTING TREE ROOT(S), AND CONCRETE IS TO BE POURED OVER EXISTING TREE ROOT(S).
- 5. IN AREAS OF DRIVEWAY, DRIVEWAY APPROACHES AND SIDEWALK ACCESS RAMP CONSTRUCTION, EXISTING TREE ROOTS ARE NOT TO BE CUT BY MEANS OF MECHANICAL TREE ROOT CUTTING MACHINES. IF ANY OF EXISTING TREE ROOTS MUST BE CUT, THEY ARE TO BE CUT MANUALLY WITH SHARP IMPLEMENTS.
- 6. IN AREAS WHERE EXISTING TREE ROOTS BECOME EXPOSED BY CONSTRUCTION ACTIVITIES, THEY ARE TO BE COVERED WITH MULCH, TOPSOIL OR MOISTENED BURLAP, AND WATERED STARING IMMEDIATELY AFTER EXPOSURE AND CONTINUING UNTIL EXCAVATED AREA IS
- 7. IF HEAVY EQUIPMENT MUST BE DRIVEN ON TREE LAWN OVER TREE ROOT ZONE, PLYWOOD MUST BE PLACED ON GROUND/TREE LAWN AREA SO AS TO DISPERSE COMPACTION AND PREVENT SOIL RUTTING.


- 1. ALL PLANTS SHALL MEET OR EXCEED THE MINIMUM REQUIREMENTS AS NOTED IN THE LATEST EDITION OF THE AMERICAN STANDARD FOR NURSERY STOCK BY THE AMERICAN NURSERY & LANDSCAPE ASSOCIATION,
- 2. THE CONTRACTOR SHALL BE RESPONSIBLE FOR HIS OWN QUANTITY TAKEOFFS.
- 3. THE CONTRACTOR SHALL BE RESPONSIBLE FOR VERIFYING UNDERGROUND UTILITIES PRIOR TO THE START OF CONSTRUCTION.
- 4. ALL TREES SHALL BE LOCATED A MINIMUM DISTANCE OF FIVE FEET (5') FROM THE HORIZONTAL LINE OF
- 5. ALL TREES SHALL BE LOCATED A MINIMUM DISTANCE OF TEN FEET (10') FROM THE HORIZONTAL LINE OF OVERHEAD UTILITIES TO THE PLANT BALL.
- 6. PLANTING SOIL MIXTURE SHALL HAVE A RATIO BY VOLUME OF FOUR PARTS TOPSOIL TO ONE PART PEAT.
- SOIL AMENDMENTS TO BE MODIFIED PER INDIVIDUAL PLANT MATERIAL REQUIREMENTS.
- 7. STAKE TREES IMMEDIATELY AFTER PLANTING. REFER TO DETAIL.
- 8. PROVIDE ALL PLANTING BEDS WITH A CONTINUOUS 3" LAYER OF MULCH. MULCH SHALL BE PROVIDED AS
- FOR BUILDING FOUNDATION PLANTING BEDS, PROVIDE A 3" LAYER OF WASHED COBBLES 1"-3" IN SIZE. PROVIDE WEED BARRIER MATERIAL BETWEEN SOIL AND MULCH LAYER.
- FOR ALL OTHER LANDSCAPE PLANTING BEDS PROVIDE SHREDDED HARDWOOD MULCH PER DETAILS.
- 9. SEED ALL AREAS NOT PAVED, PLANTED OR SPECIFIED OTHERWISE WITH LAWN SEED.

A. LAWN SEED MIXTURE SHALL BE PROVIDED AS FOLLOWS: % BY WEIGHT % BY PURITY % GERM

'REPELL', 'CITATION' & 'MORNING STAR' PERENNIAL RYE GRASS 'JAMESTOWN II', 'FORTRESS', 'ENSYLVA RED FESCUE 'BARON' & 'MIDNIGHT' KENTUCKY BLUEGRASS

SEEDING RATE: 6.0 LBS PER 1,000 SF. MULCH: STRAW AT TWO TONS PER ACRE, OR WOOD FIBER MULCH USED WITH A HYDROSEEDING APPLICATION METHOD, WITH TACKIFIER. STARTING FERTILIZER: 5:10:10 AT 20 LBS PER 1,000 SF.

- PLEASE REFER TO BME DRAWING # 2744-09 / CONSTRUCTION EROSION CONTROL PLAN FOR FURTHER SEEDING REQUIREMENTS IE. : TEMPORARY SEEDING AND SPECIALIZED SEED MIXES.
- 10. PROPOSED PLANT MATERIALS SHALL BE FIELD LOCATED, AND THE CONTRACTOR SHALL PERFORM A ROUGH STAKEOUT OF PLANTINGS FOR REVIEW AND APPROVAL BY LANDSCAPE ARCHITECT PRIOR TO PLANTING. 11. THE CONTRACTOR SHALL BE RESPONSIBLE FOR CARE AND MAINTENANCE OF PLANT MATERIALS AND
- SEEDED AREAS UNTIL FINAL ACCEPTANCE. ONCE THE LANDSCAPING IS ACCEPTED BY THE OWNER, THE LANDSCAPE MAINTENANCE IS TO BE PROVIDED BY OWNER/ OWNER REPRESENTATIVE FOR THE (1) ONE YEAR MAINTENANCE GUARANTEE PERIOD.
- 12. ANY PROPOSED DEVIATION TO THE LANDSCAPING PLAN MUST FIRST BE REVIEWED AND APPROVED BY THE PLANNING BOARD CHAIRMAN AND THE DIRECTOR OF ENGINEERING AND PLANNING PRIOR TO THE INSTALLATION OF THE PROPOSED LANDSCAPING CHANGES.
- 13. IN THE EVENT EXISTING STREET TREES WITHIN THE CITY RIGHT-OF-WAY CANNOT BE PROTECTED AND MAINTAINED, THE TREE IS TO BE REPLACED IN-KIND.

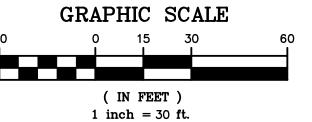


L. SWEDROCK DRAWN BY SCALE PROJECT NO.


The following is an excerpt from the New York State Education Law Article 145 Section 7209 and applies to this person, unless he is acting under the direction of a licensed professional engineer or land surveyor to alter any item in any way. If an item bearing the seal of an engineer or land surveyor is altered, the altering engineer or land surveyor shall affix to the item his seal by his signature and the date of such alteration, and a specific description of the alteration."

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PROJECT MANAGER PROJECT ENGINEER DATE ISSUED **DECEMBER 07, 2021**



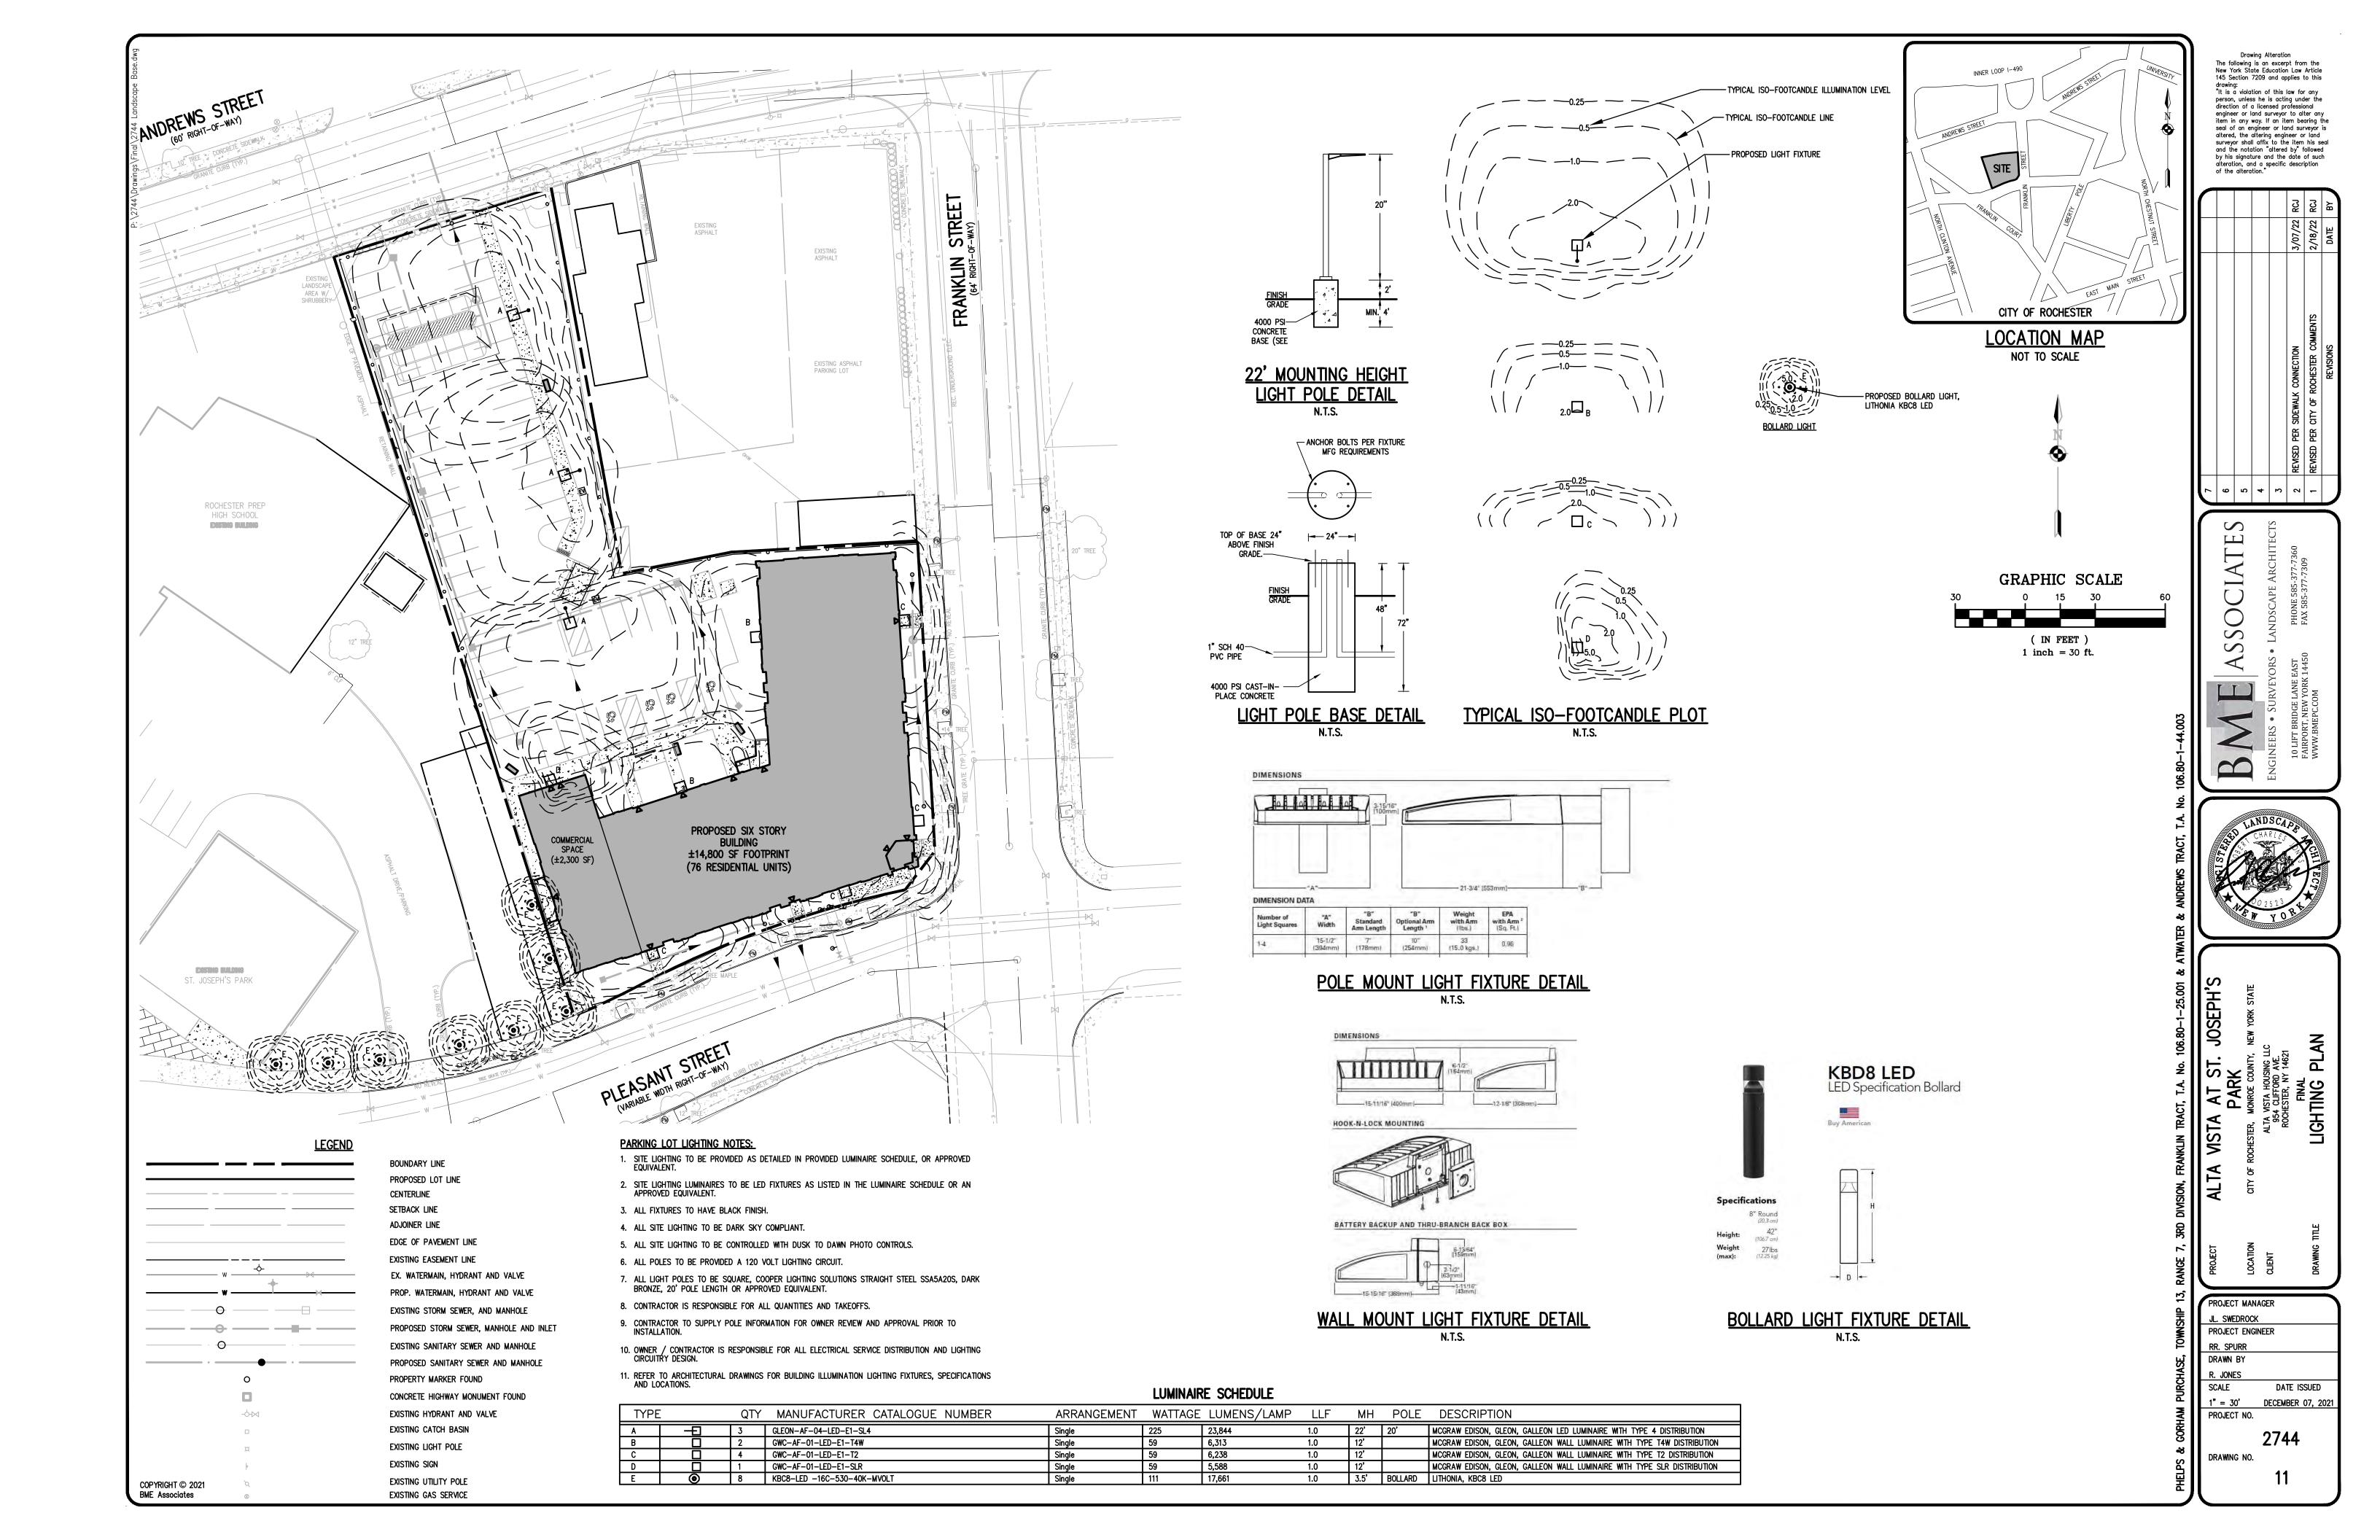


Drawing Alteration The following is an excerpt from the New York State Education Law Article 145 Section 7209 and applies to this drawing:
"It is a violation of this law for any person, unless he is acting under the direction of a licensed professional engineer or land surveyor to alter any item in any way. If an item bearing th

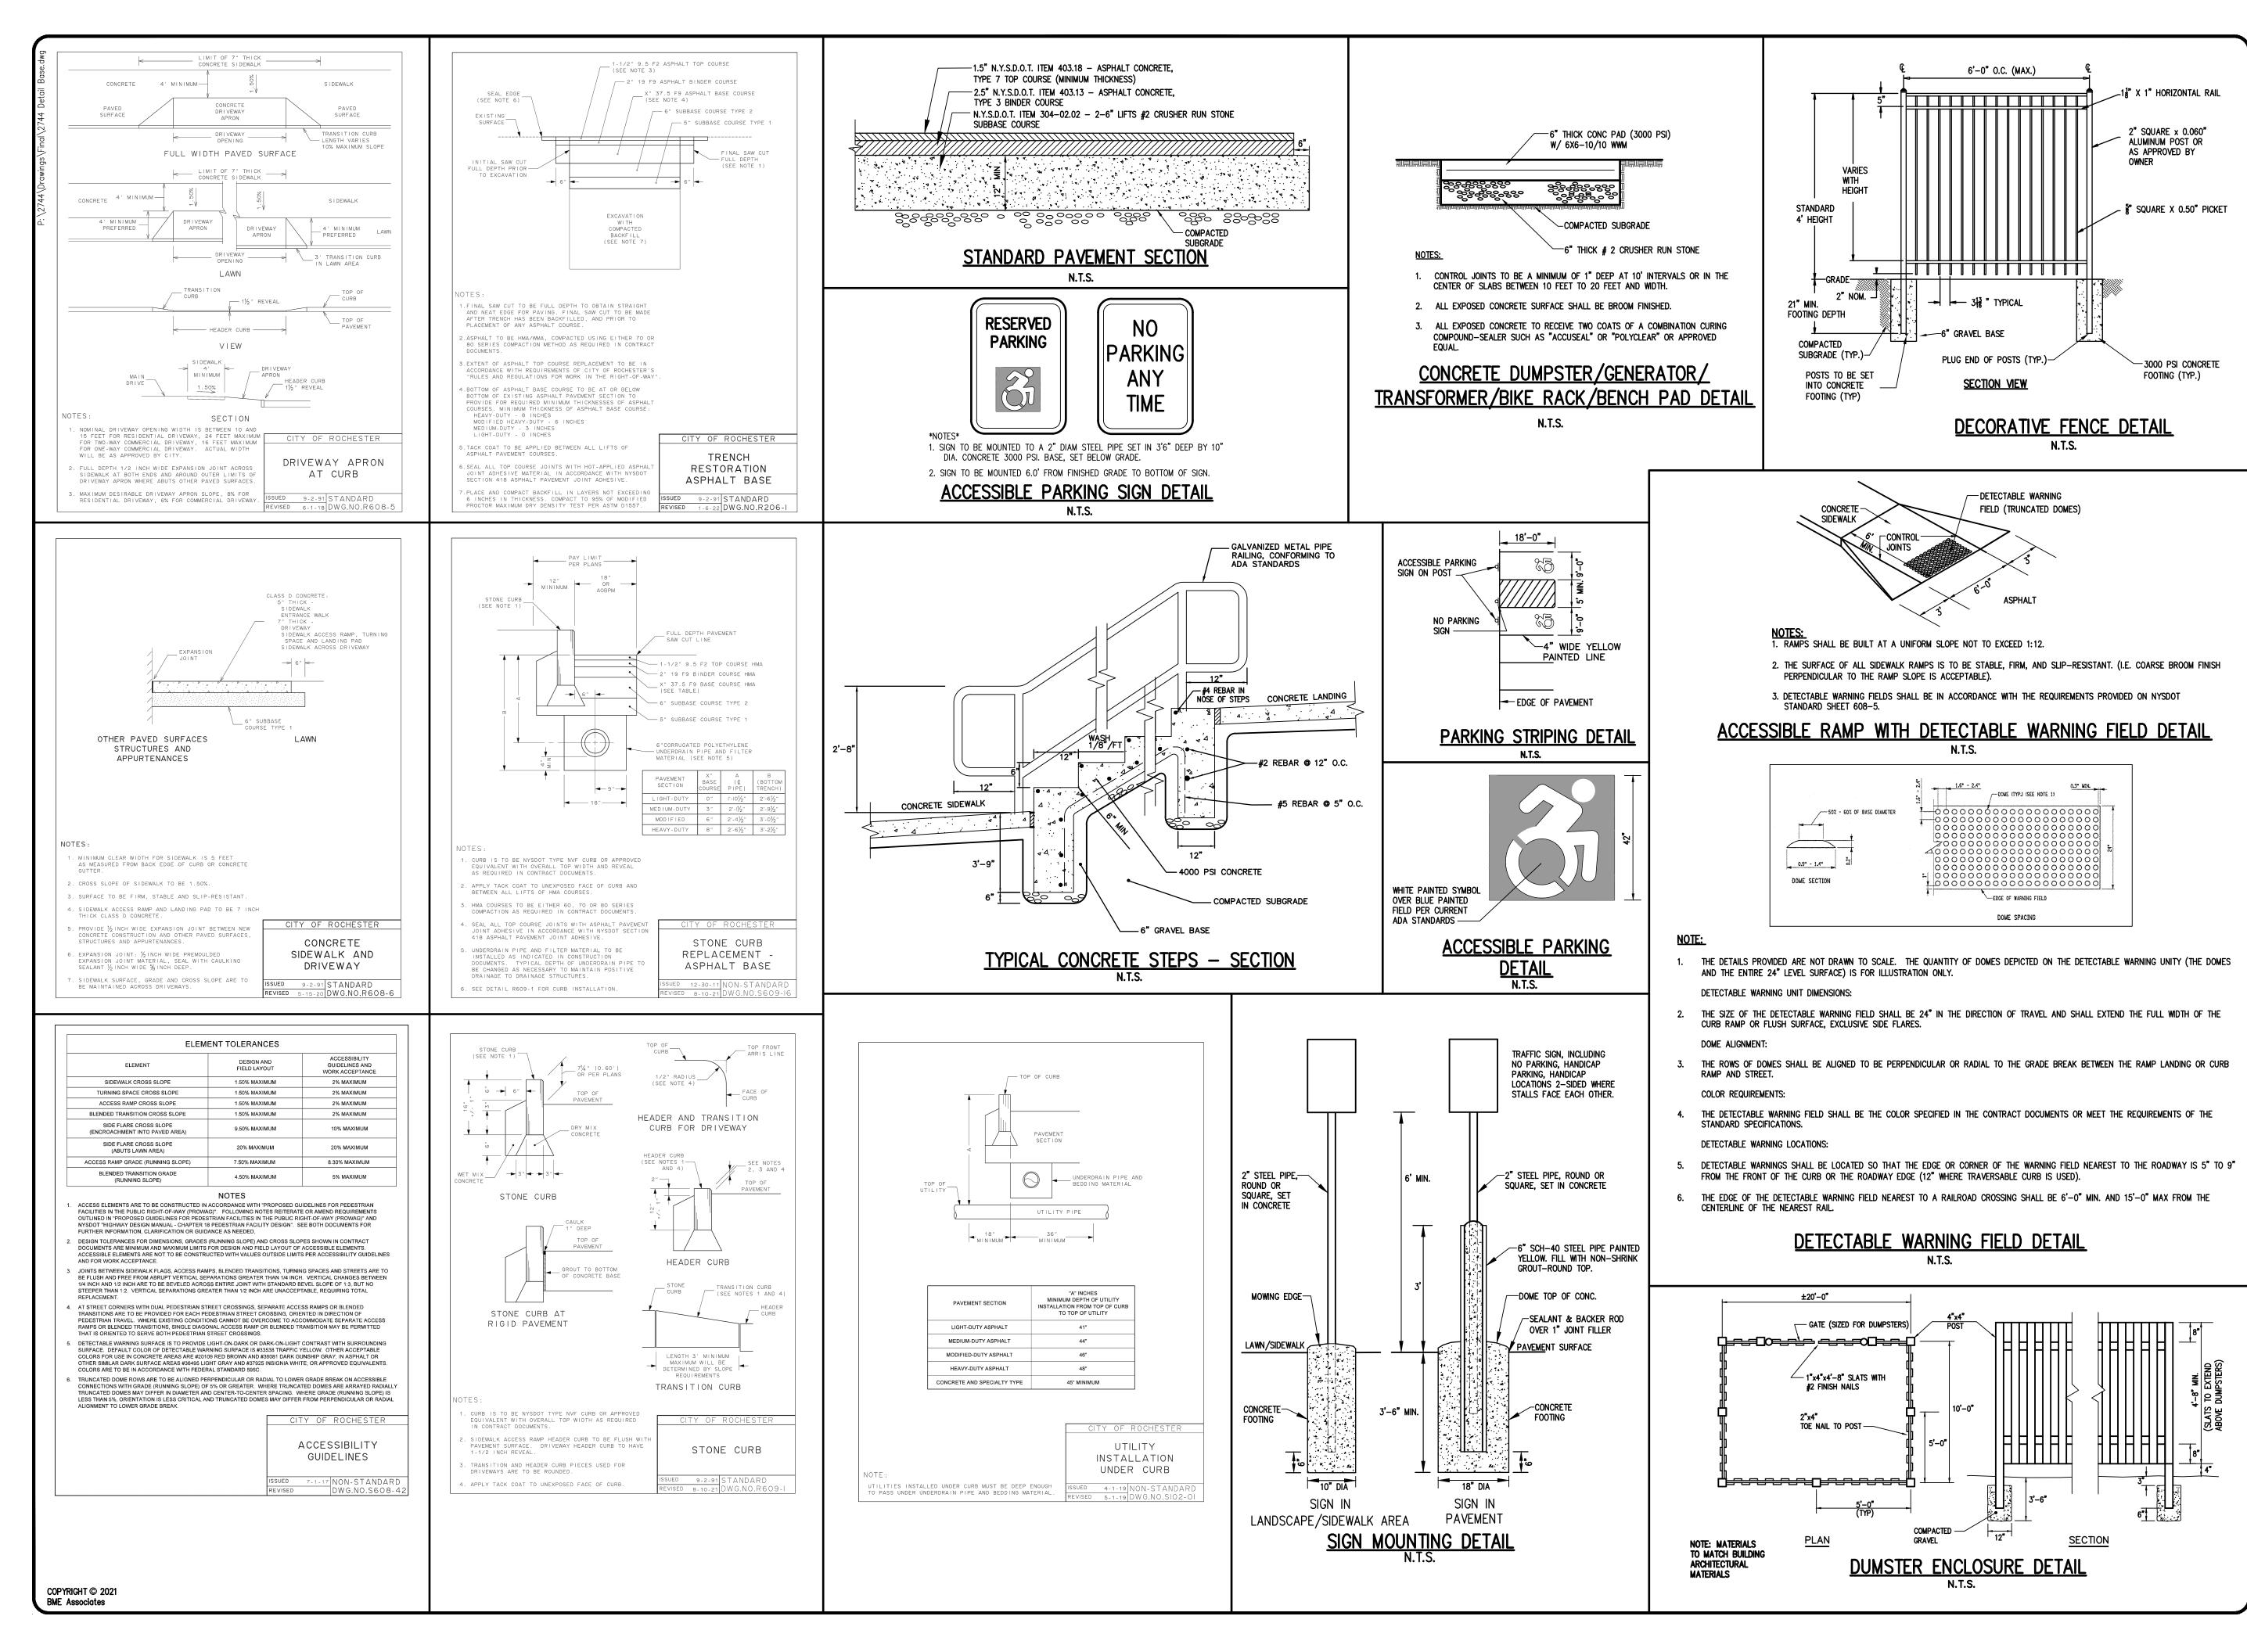seal of an engineer or land surveyor is altered, the altering engineer or land surveyor shall offix to the item his seal and the notation "altered by" followed by his signature and the date of such alteration, and a specific description of the alteration."

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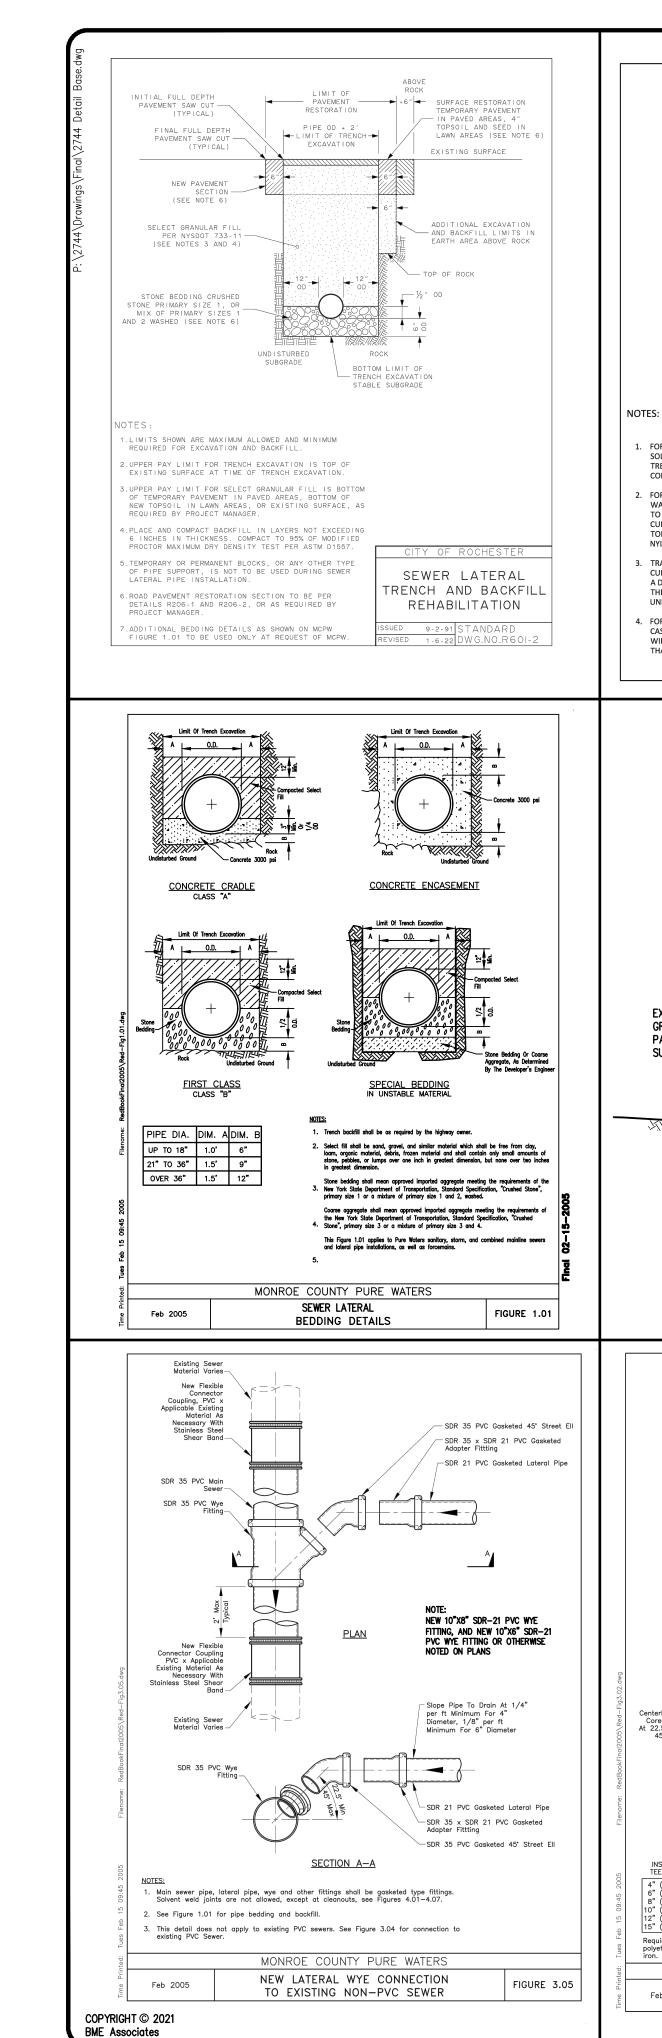
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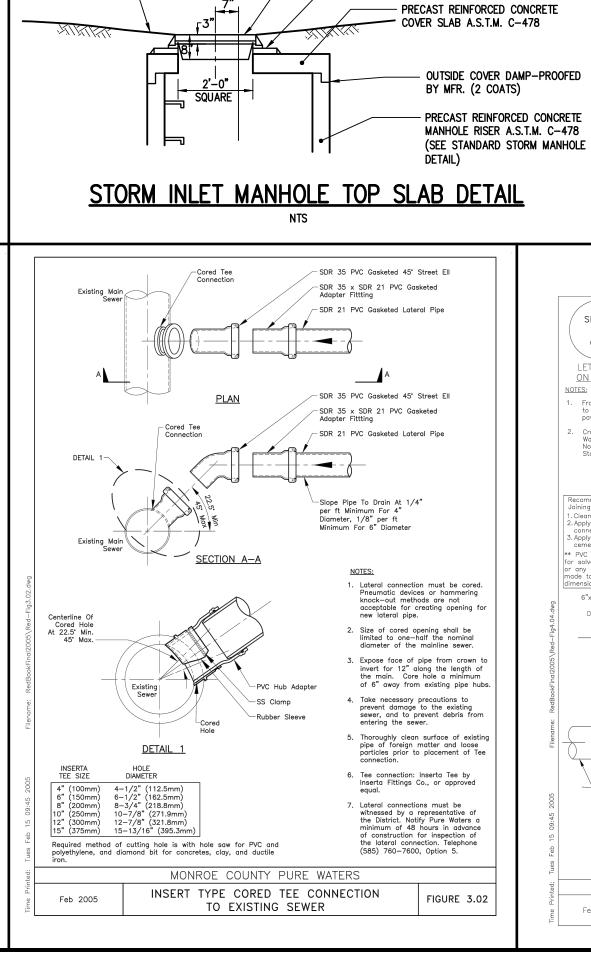
PROJECT MANAGER JL. SWEDROCK PROJECT ENGINEER RR. SPURR DRAWN BY VJ. SCHLAGETER SCALE DATE ISSUED DECEMBER 07, 202

PROJECT NO.

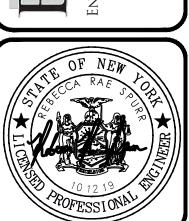DRAWING NO.

(SHEET 1 of 5)





CURB/VALVE BOX

— PLASTIC WATER SERVICE PIPE

USE TAP SPLICE CONNECTOR FOR CONNECTING WATER SERVICE TRACER WIRE TO WATER MAIN TRACER WIRE -

CITY OF ROCHESTER

PLASTIC

WATER SERVICE TRACER WIRE

INSTALLATION

REVISED 4-19-18 DWG.NO.S901-9

#4 REBAR

N.Y.S.D.O.T. GALVANIZED

GRATE WITH INTERMEDIATE

STANDARD FRAME & COVER

- GRADE RINGS - MAX. 8" SET

RETICULINE FRAME AND

Support #1

SET IN MORTAR

IN MORTAR

1-13-06 NON-STANDARD

SEE DETAIL S901-11

PLASTIC WATER MAIN PIPE

TYPE C FRAME PLAN

Member

MONROE COUNTY PURE WATERS

FRAME AND GRATE

Outline of Frame -

TYPE C CATCH BASIN

PLAN

• •

Square

SECTION A-A

Floor Precast Integrally with Walls

Grate

TYPE C GRATE PLAN

Typical Detail for City Of Rochester Street Improvement Projects.

Other Use Requires
RPWD Approval.
Former City of Rocheste
Std. Dwg. No. R655–2

FIGURE 6.07

- #3 Rebar

 \wedge

ANCHOR DETAIL

Fiber Reinforcement and #3 Rebar Top and Bottom all Sides

x 3" Wide Keyway all Walls

TRACER WIRE -

NYLON ZIP CABLE TIES AT MAXIMUM

FOR OPEN CUT INSTALLATION, TRACER WIRE IS TO BE #12 AWG

SOLID COPPER WITH 30 MIL BLUE HMWPE INSULATION. FOR TRENCHLESS INSTALLATION, TRACER WIRE IS TO BE #12 AWG SOLID COPPER CLAD STEEL CORE WITH 45 MIL BLUE HDPE INSULATION.

FOR NEW PLASTIC WATER SERVICE PIPE CONNECTED TO PLASTIC

WATER MAIN PIPE, WATER SERVICE TRACER WIRE IS TO BE SPLICED TO WATER MAIN TRACER WIRE AND EXTENDED UP TO TOP OF CURB/VALVE BOX. WATER SERVICE TRACER WIRE IS TO RUN ALONG

TOP OF AND BE SECURED TO PLASTIC WATER SERVICE PIPE WITH NYLON ZIP CABLE TIES PLACED AT MAXIMUM 8 FEET INTERVALS.

TRACER WIRE SHALL TRAVEL UP THE INSIDE THE WATER SERVICE

CURB/VALVE BOX WITH ENOUGH EXTRA TRACER WIRE TO EXTEND

A DISTANCE OF 4 FEET BEYOND THE TOP OF THE CURB/VALVE BOX

HE EXTRA TRACER WIRE SHALL BE COILED AND STORED ON THE

UNDERSIDE OF THE CURB BOX COVER WITHIN THE CURB BOX.

CAST/DUCTILE IRON WATER MAIN PIPE, WATER SERVICE TRACER WIRE IS TO BE CONNECTED TO CORPORATION STOP WITH BRASS

THAW WIRE NUT COMPRESSION ASSEMBLY WITH SET SCREW.

3'-0" SQUARE -

<u>PLAN</u>


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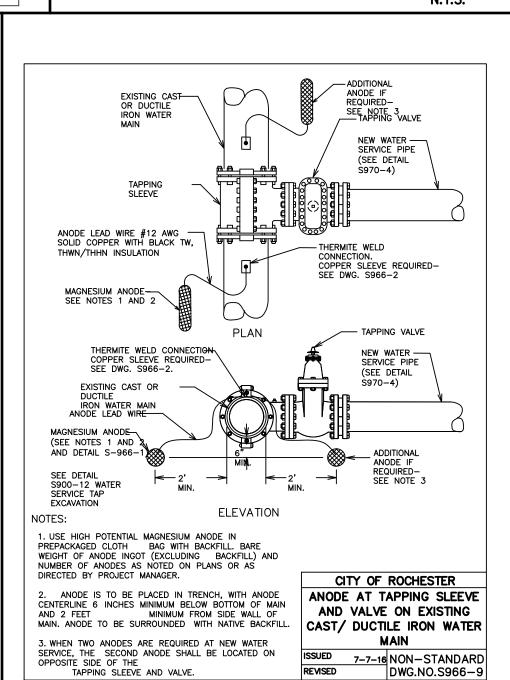
GROUND OR


PAVEMENT


SURFACE -

8' INTERVALS.



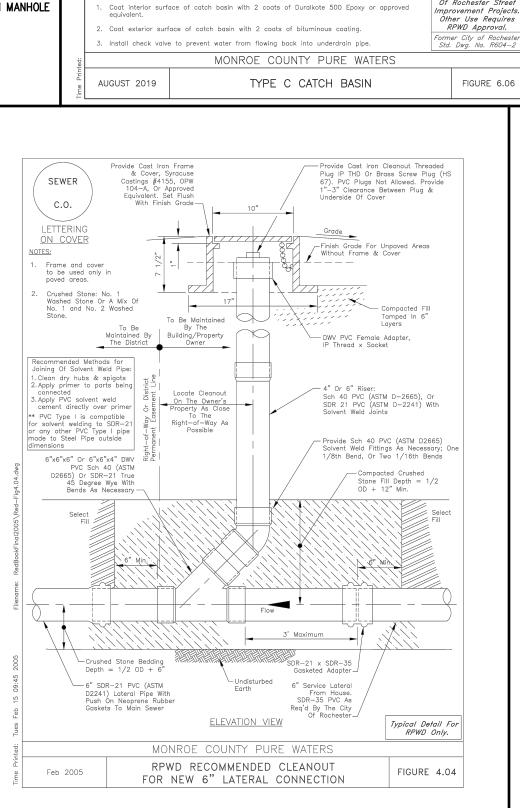

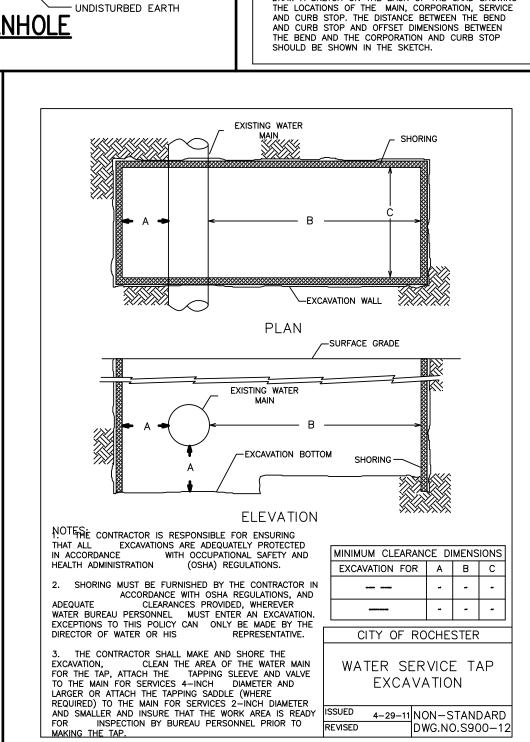

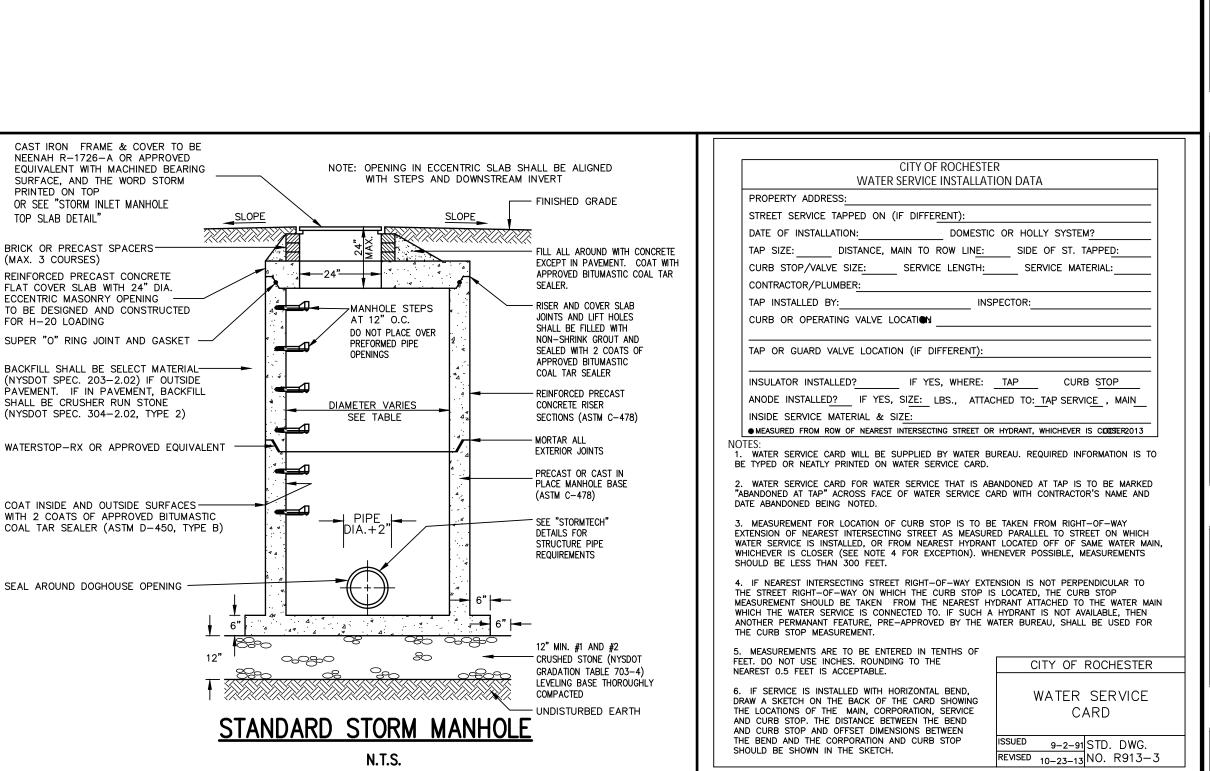



Drawing Alteration The following is an excerpt from the New York State Education Law Article 145 Section 7209 and applies to this drawing: "It is a violation of this law for a alterati of the

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					VJS	NJS	BY

ALTA VISTA AT ST. JOSEF	CITY OF ROCHESTER, MONROE COUNTY, NI	ALTA VISTA HOUSING LLC 954 CLIFFORD AVE. ROCHESTER. NY 14621	_
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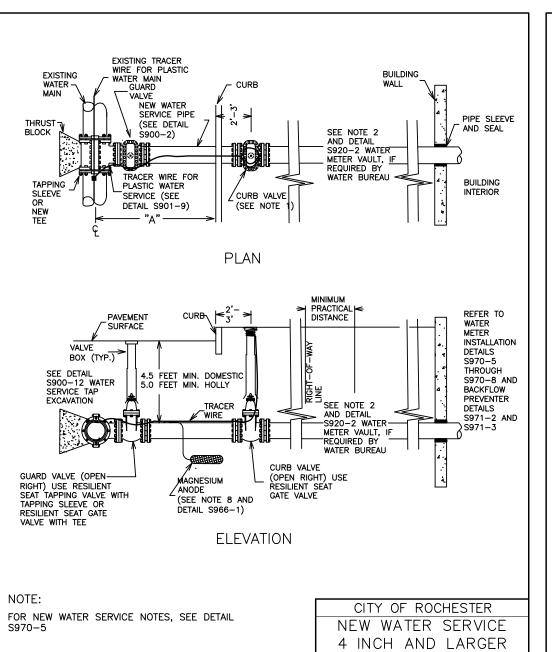


8-11-11 NON-STANDARD

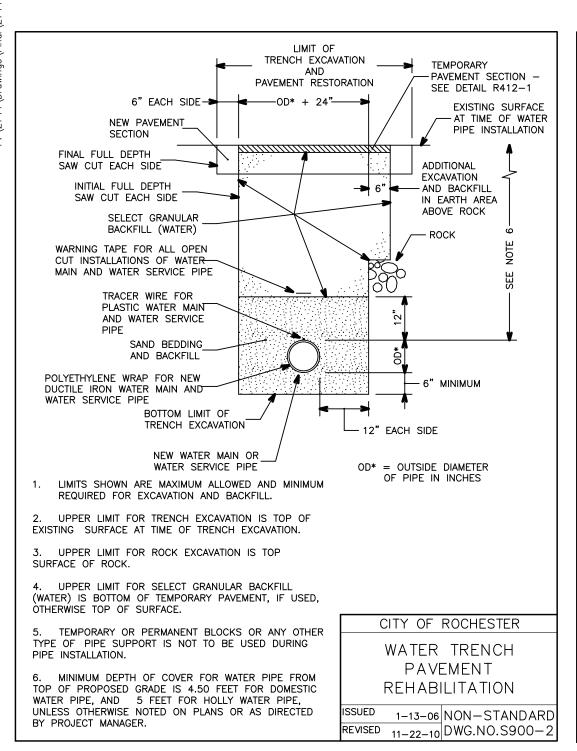ISSUED 1-13-06 NON-STANDARD

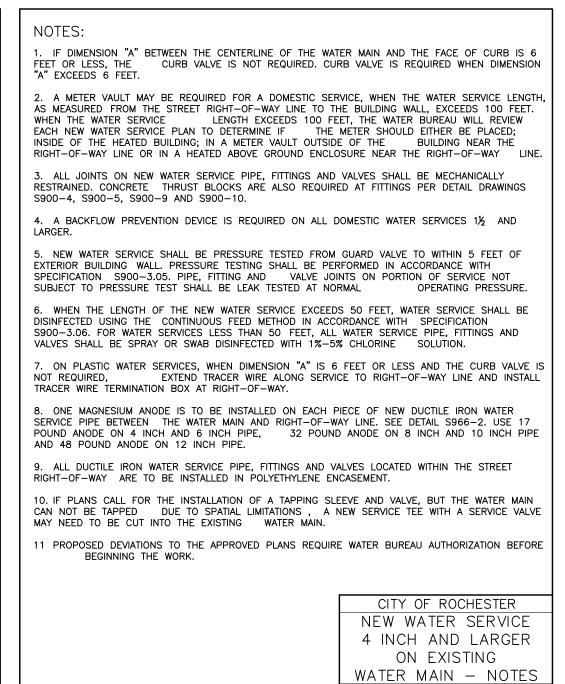REVISED 6-1-09 DWG.NO.S900-5

DWG.NO.S970-5





ON EXISTING


WATER MAIN


8-8-11 NON-STANDARD

DWG.NO.S970-4

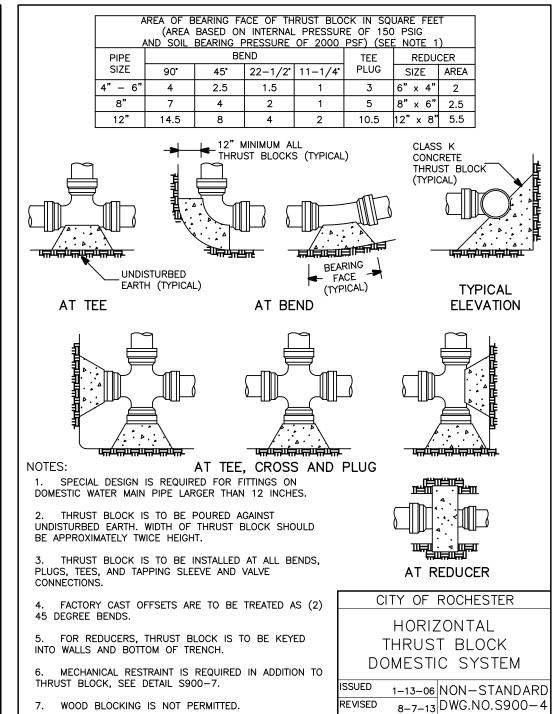

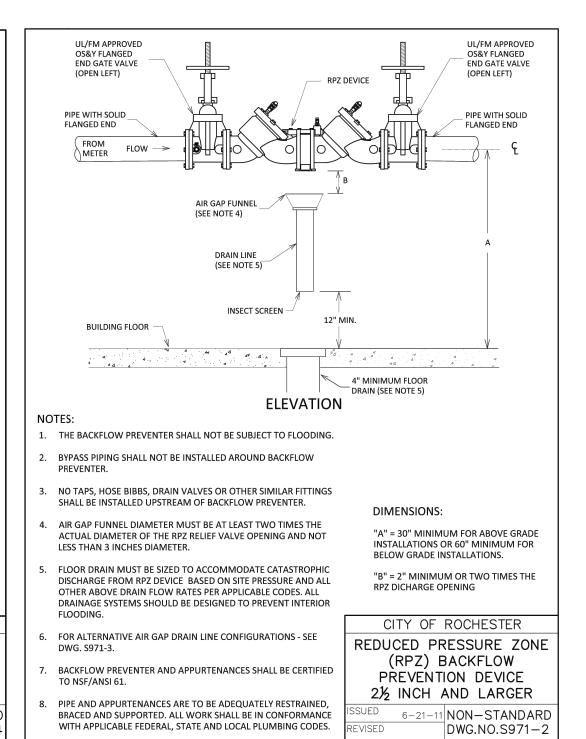

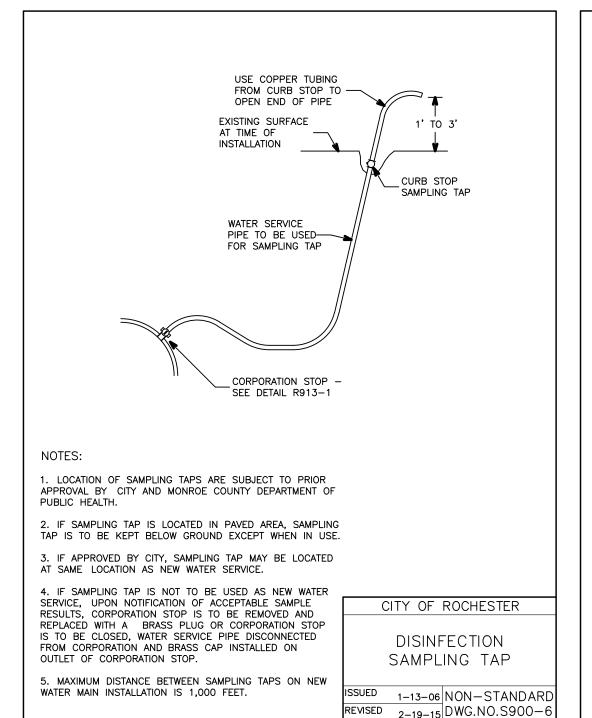


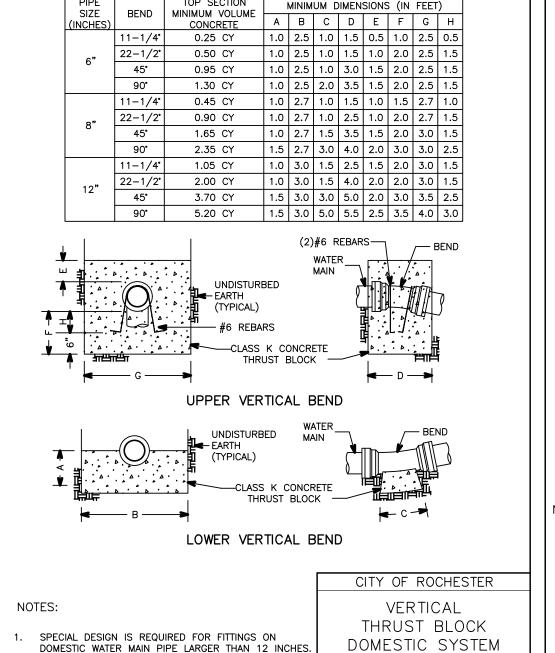



DOMESTIC WATER MAIN PIPE LARGER THAN 12 INCHES

MECHANICAL RESTRAINT IS REQUIRED IN ADDITION TO

THRUST BLOCK, SEE DETAIL S900-7.

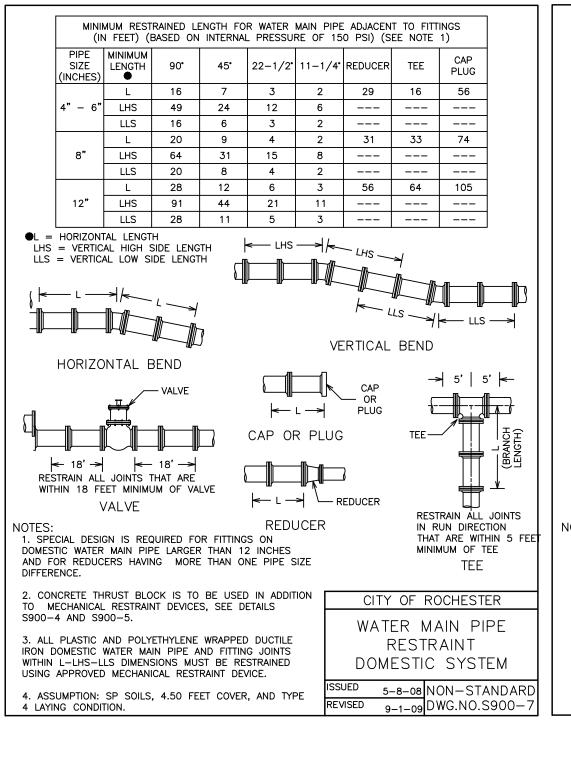

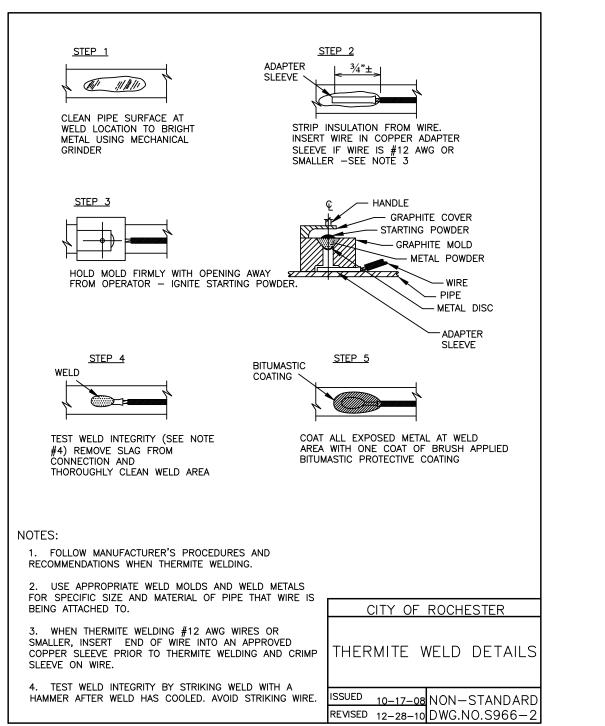

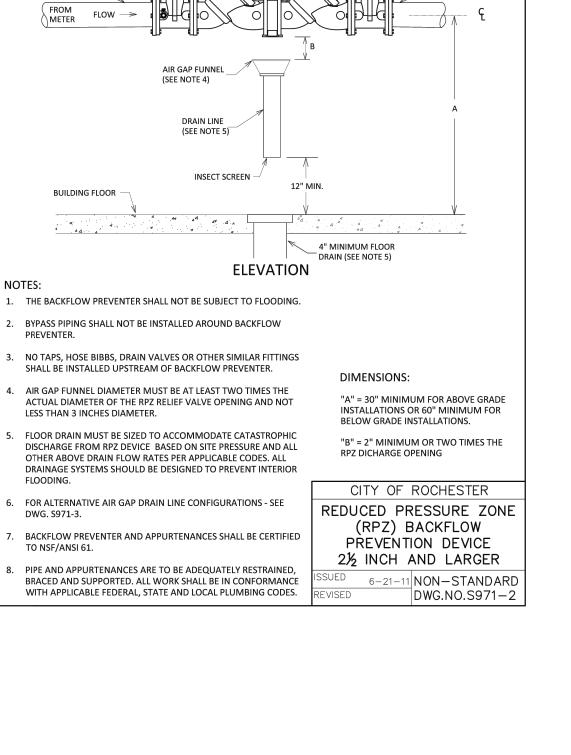



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PROJECT MANAGER JL. SWEDROCK PROJECT ENGINEER RR. SPURR


DRAWN BY VJ. SCHLAGETER SCALE DATE ISSUED


DECEMBER 07, 202 PROJECT NO.


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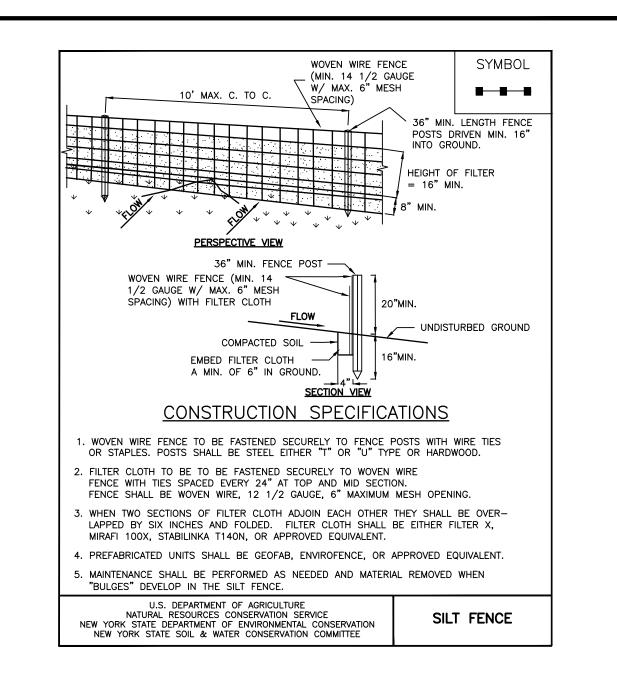
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(SHEET 3 of 5)





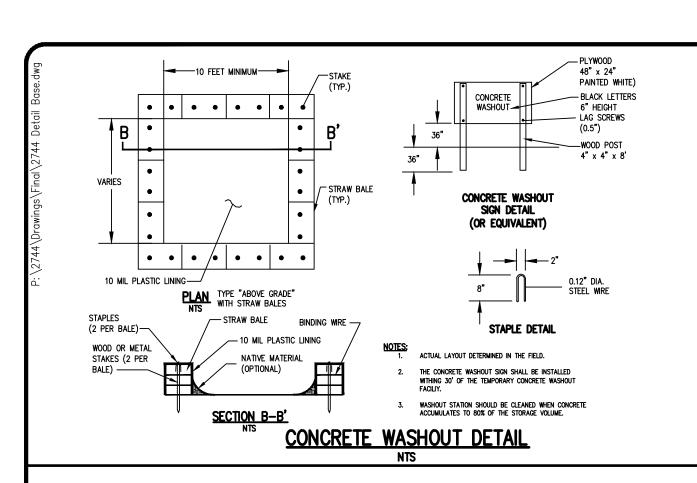

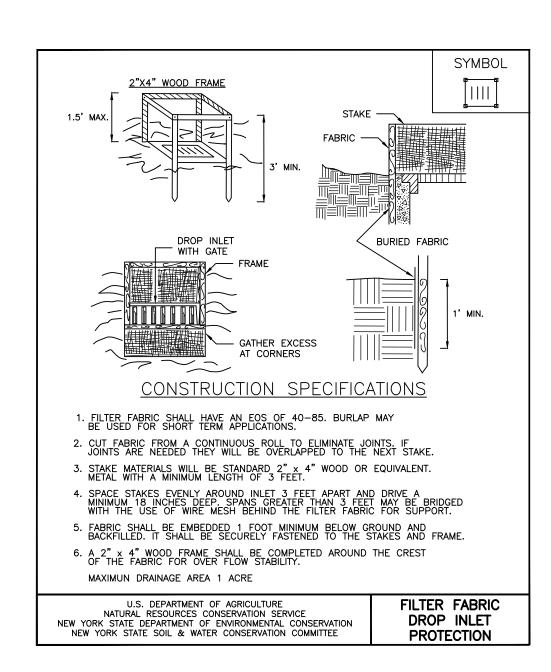

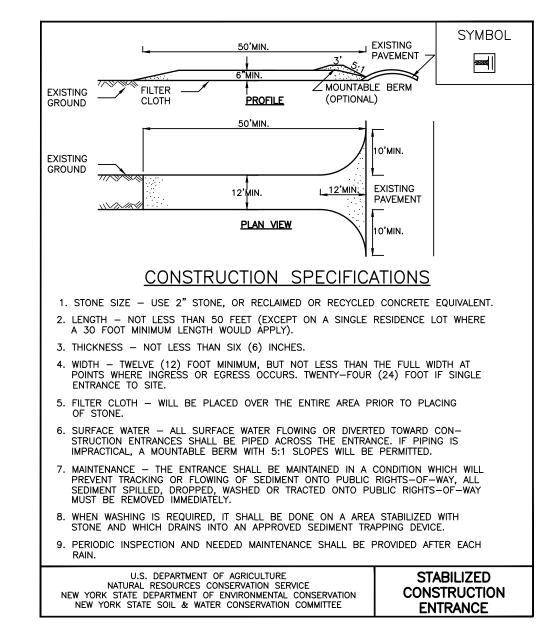Drawing Alteration
The following is an excerpt from the
New York State Education Law Article
145 Section 7209 and applies to this

drawing:
"It is a violation of this law for any person, unless he is acting under the direction of a licensed professional engineer or land surveyor to alter any item in any way. If an item bearing the seal of an engineer or land surveyor is altered, the altering engineer or land surveyor shall affix to the item his seal and the notation "altered by" followed by his signature and the date of such alteration, and a specific description of the alteration."

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GINEERS • SURVEYORS • LANDSCAPE

10 LIFT BRIDGE LANE EAST
FAIRPORT, NEW YORK 14450

MANAWAW BMEDG COM



A AT ST. JOSEPH'S PARK
CHESTER, MONROE COUNTY, NEW YORK STATE
ALTA VISTA HOUSING LLC
954 CLIFTORD AVE.
ROCHESTER, NY 14621

LOCATION

PROJECT MANAGER

JL. SWEDROCK
PROJECT ENGINEER
RR. SPURR
DRAWN BY
VJ. SCHLAGETER

VJ. SCHLAGETER

SCALE DATE ISSUED

N.T.S. DECEMBER 07, 202


PROJECT NO.

DRAWING NO.

awing no. **15**

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This plan has not received final approval of all reviewing agencies. This plan is subject to revisions until all approvals are obtained and should not be used for construction



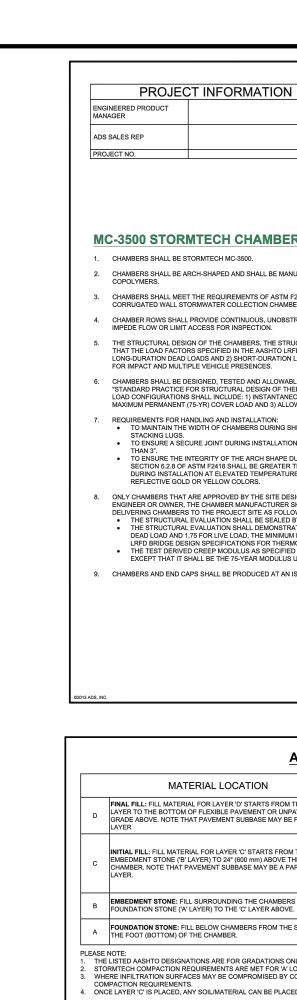



SiteASSIST" FOR STORMTECH INSTRUCTIONS, DOWNLOAD THE INSTALLATION APP

ALTA VISTA PROJECT COPY

MC-3500 STORMTECH CHAMBER SPECIFICATIONS

- CHAMBERS SHALL BE ARCH-SHAPED AND SHALL BE MANUFACTURED FROM VIRGIN, IMPACT-MODIFIED POLYPROPYLENE COPOLYMERS.
- CHAMBERS SHALL MEET THE REQUIREMENTS OF ASTM F2418-16a, "STANDARD SPECIFICATION FOR POLYPROPYLENE (PP) CORRUGATED WALL STORMWATER COLLECTION CHAMBERS" CHAMBER CLASSIFICATION 45x76 DESIGNATION SS.
- CHAMBER ROWS SHALL PROVIDE CONTINUOUS, UNOBSTRUCTED INTERNAL SPACE WITH NO INTERNAL SUPPORTS THAT WOULD IMPEDE FLOW OR LIMIT ACCESS FOR INSPECTION.
- 5. THE STRUCTURAL DESIGN OF THE CHAMBERS, THE STRUCTURAL BACKFILL, AND THE INSTALLATION REQUIREMENTS SHALL ENSURE THAT THE LOAD FACTORS SPECIFIED IN THE AASHTO LRFD BRIDGE DESIGN SPECIFICATIONS, SECTION 12.12, ARE MET FOR: 1) LONG-DURATION DEAD LOADS AND 2) SHORT-DURATION LIVE LOADS, BASED ON THE AASHTO DESIGN TRUCK WITH CONSIDERATION FOR IMPACT AND MULTIPLE VEHICLE PRESENCES.
- CHAMBERS SHALL BE DESIGNED, TESTED AND ALLOWABLE LOAD CONFIGURATIONS DETERMINED IN ACCORDANCE WITH ASTM F2787,
 "STANDARD PRACTICE FOR STRUCTURAL DESIGN OF THERMOPLASTIC CORRUGATED WALL STORMWATER COLLECTION CHAMBERS".
 LOAD CONFIGURATIONS SHALL INCLUDE: 1) INSTANTANEOUS (<4 MIN) ASAHTO DESIGN LUCK LIVE LOAD ON MINIMUM COVER 2)
 MAXIMUM PERMANENT (75-YR) COVER LOAD AND 3) ALLOWABLE COVER WITH PARKED (1-WEEK) AASHTO DESIGN TRUCK.
- REQUIREMENTS FOR HANDLING AND INSTALLATION:

 TO MAINTAIN THE WIDTH OF CHAMBERS DURING SHIPPING AND HANDLING, CHAMBERS SHALL HAVE INTEGRAL, INTERLOCKING TO MAINTAIN THE WIDTH OF CHAMBERS DURING SHIPPING AND HANDLING, CHAMBERS SHALL HAVE INTEGRAL, INTERLOCKING STACKING LUGS.
 TO ENSURE A SECURE JOINT DURING INSTALLATION AND BACKFILL, THE HEIGHT OF THE CHAMBER JOINT SHALL NOT BE LESS THAN 3". ITHAN 3".

 TO ENSURE THE INTEGRITY OF THE ARCH SHAPE DURING INSTALLATION, a) THE ARCH STIFFNESS CONSTANT AS DEFINED IN SECTION 6.2.8 OF ASTM F2418 SHALL BE GREATER THAN OR EQUAL TO 500 LBS/IN/IN. AND b) TO RESIST CHAMBER DEFORMATION DURING INSTALLATION AT ELEVATED TEMPERATURES (ABOVE 73° F / 23° C), CHAMBERS SHALL BE PRODUCED FROM REFLECTIVE GOLD OR YELLOW COLORS.
- ONLY CHAMBERS THAT ARE APPROVED BY THE SITE DESIGN ENGINEER WILL BE ALLOWED. UPON REQUEST BY THE SITE DESIGN ENGINEER OR OWNER, THE CHAMBER MANUFACTURER SHALL SUBMIT A STRUCTURAL EVALUATION FOR APPROVAL BEFORE DELIVERING CHAMBERS TO THE PROJECT SITE AS FOLLOWS:

 THE STRUCTURAL EVALUATION SHALL BE SEALED BY A REGISTERED PROFESSIONAL ENGINEER.

 THE STRUCTURAL EVALUATION SHALL DEMONSTRATE THAT THE SAFETY FACTORS ARE GREATER THAN OR EQUAL TO 1.95 FOR DEAD LOAD AND 1.75 FOR LIVE LOAD, THE MINIMUM REQUIRED BY ASTM F2787 AND BY SECTIONS 3 AND 12.12 OF THE AASHTO LRFD BRIDGE DESIGN SPECIFICATIONS FOR THERMOPLASTIC PIPE.

 THE TEST DERIVED CREEP MODULUS AS SPECIFIED IN ASTM F2418 SHALL BE USED FOR PERMANENT DEAD LOAD DESIGN EXCEPT THAT IT SHALL BE THE 75-YEAR MODULUS USED FOR DESIGN.
- 9. CHAMBERS AND END CAPS SHALL BE PRODUCED AT AN ISO 9001 CERTIFIED MANUFACTURING FACILITY.

ROCHESTER, NY IMPORTANT - NOTES FOR THE BIDDING AND INSTALLATION OF MC-3500 CHAMBER SYSTEM

- STORMTECH MC-3500 CHAMBERS SHALL NOT BE INSTALLED UNTIL THE MANUFACTURER'S REPRESENTATIVE HAS COMPLETED A
 PRE-CONSTRUCTION MEETING WITH THE INSTALLERS.
- 2. STORMTECH MC-3500 CHAMBERS SHALL BE INSTALLED IN ACCORDANCE WITH THE "STORMTECH MC-3500/MC-4500 CONSTRUCTION GUIDE". 3. CHAMBERS ARE NOT TO BE BACKFILLED WITH A DOZER OR AN EXCAVATOR SITUATED OVER THE CHAMBERS.
- AMBEROANE. NO 10 BE SACKFILLE WITHOUS:

 STONESHOOTER LOCATED OFF THE CHAMBER BED.

 BACKFILL AS ROWS ARE BUILT USING AN EXCAVATOR ON THE FOUNDATION STONE OR SUBGRADE.


 BACKFILL FROM OUTSIDE THE EXCAVATION USING A LONG BOOM HOE OR EXCAVATOR.
- 4. THE FOUNDATION STONE SHALL BE LEVELED AND COMPACTED PRIOR TO PLACING CHAMBERS. 5. JOINTS BETWEEN CHAMBERS SHALL BE PROPERLY SEATED PRIOR TO PLACING STONE.
- 6. MAINTAIN MINIMUM 6" (150 mm) SPACING BETWEEN THE CHAMBER ROWS.
- 7. INLET AND OUTLET MANIFOLDS MUST BE INSERTED A MINIMUM OF 12" (300 mm) INTO CHAMBER END CAPS. 8. EMBEDMENT STONE SURROUNDING CHAMBERS MUST BE A CLEAN, CRUSHED, ANGULAR STONE MEETING THE AASHTO M43 DESIGNATION OF #3
- 9. STONE MUST BE PLACED ON THE TOP CENTER OF THE CHAMBER TO ANCHOR THE CHAMBERS IN PLACE AND PRESERVE ROW SPACING.
- 10. THE CONTRACTOR MUST REPORT ANY DISCREPANCIES WITH CHAMBER FOUNDATION MATERIALS BEARING CAPACITIES TO THE SITE DESIGN
- 11. ADS RECOMMENDS THE USE OF "FLEXSTORM CATCH IT" INSERTS DURING CONSTRUCTION FOR ALL INLETS TO PROTECT THE SUBSURFACE STORMWATER MANAGEMENT SYSTEM FROM CONSTRUCTION SITE RUNOFF.
- NOTES FOR CONSTRUCTION EQUIPMENT 1. STORMTECH MC-3500 CHAMBERS SHALL BE INSTALLED IN ACCORDANCE WITH THE "STORMTECH MC-3500/MC-4500 CONSTRUCTION GUIDE".
- 2. THE USE OF EQUIPMENT OVER MC-3500 CHAMBERS IS LIMITED:


 NO EQUIPMENT IS ALLOWED ON BARE CHAMBERS.


 NO RUBBER TIRED LOADER, DUMP TRUCK, OR EXCAVATORS ARE ALLOWED UNTIL PROPER FILL DEPTHS ARE REACHED IN ACCORDANCE WITH THE "STORMTECH MC-3500 CONSTRUCTION GUIDE".


 WEIGHT LIMITS FOR CONSTRUCTION EQUIPMENT CAN BE FOUND IN THE "STORMTECH MC-3500 MC-4500 CONSTRUCTION GUIDE".
- 3. FULL 36" (900 mm) OF STABILIZED COVER MATERIALS OVER THE CHAMBERS IS REQUIRED FOR DUMP TRUCK TRAVEL OR DUMPING. USE OF A DOZER TO PUSH EMBEDMENT STONE BETWEEN THE ROWS OF CHAMBERS MAY CAUSE DAMAGE TO CHAMBERS AND IS NOT AN ACCEPTABLE BACKFILL METHOD. ANY CHAMBERS DAMAGED BY USING THE "DUMP AND PUSH" METHOD ARE NOT COVERED UNDER THE STORMTECH STANDARD WARRANTY.


CONTACT STORMTECH AT 1-888-892-2694 WITH ANY QUESTIONS ON INSTALLATION REQUIREMENTS OR WEIGHT LIMITS FOR CONSTRUCTION EQUIPMENT.

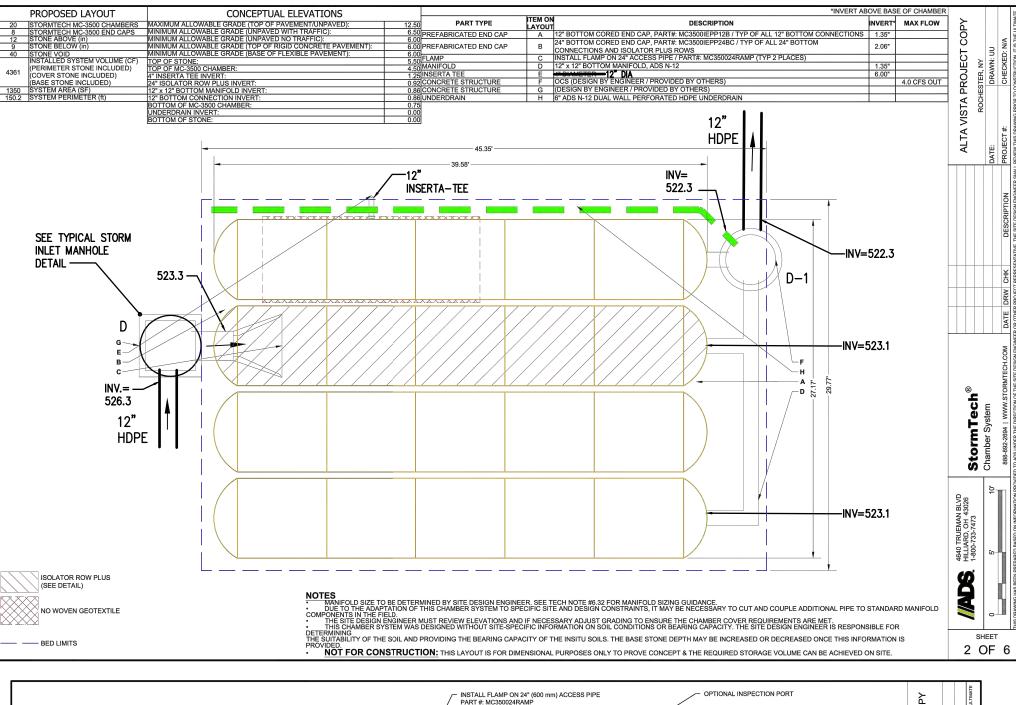

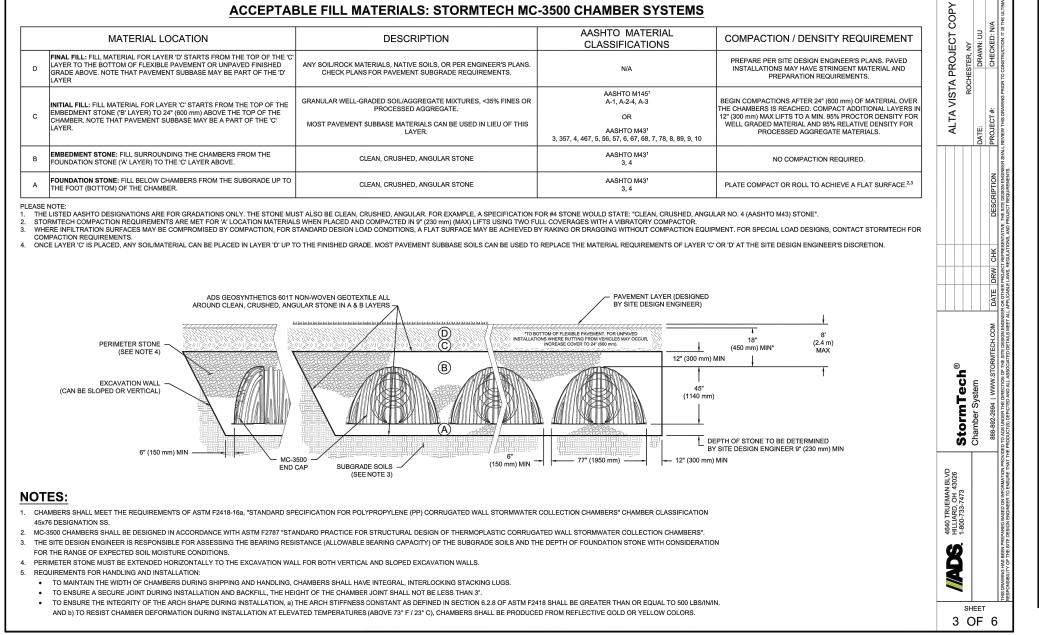

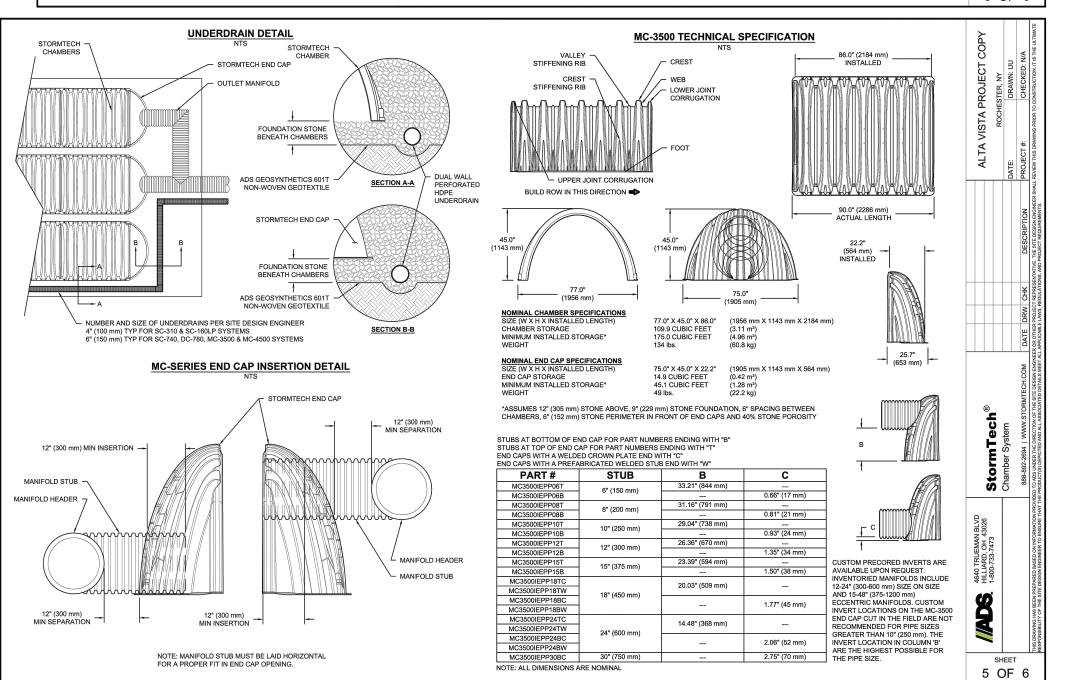

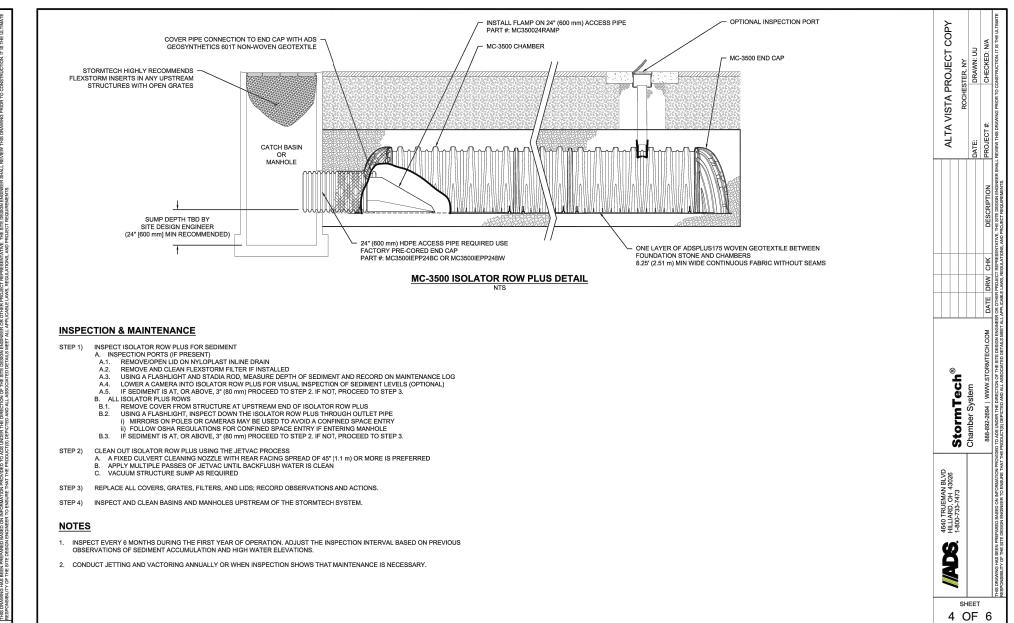

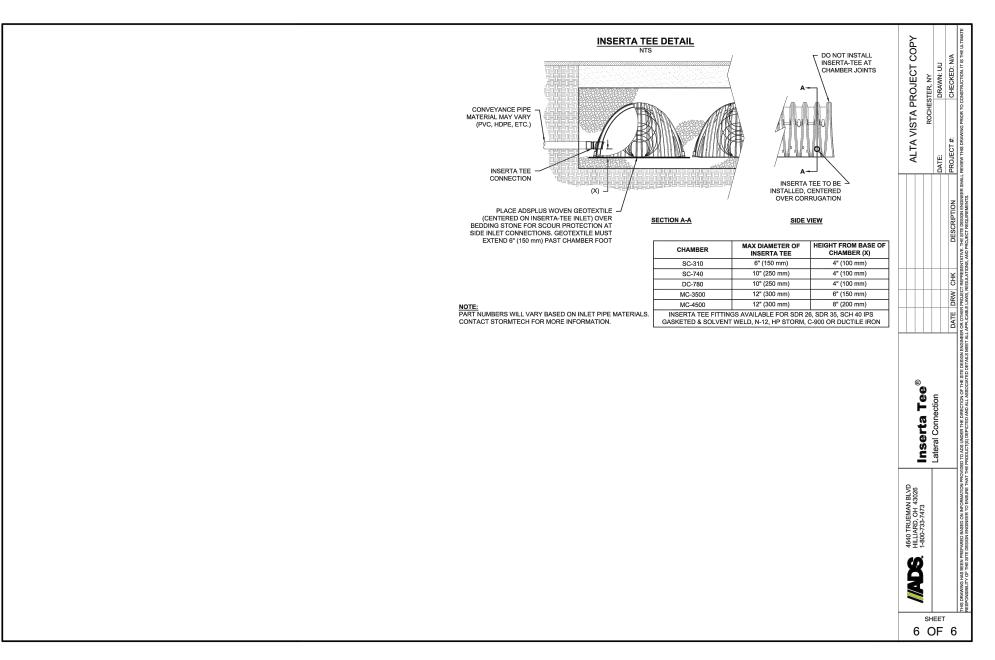

Drawing Alteration The following is an excerpt from the New York State Education Law Article 145 Section 7209 and applies to this drawing: "It is a violation of this law for any person, unless he is acting under the direction of a licensed professional engineer or land surveyor to alter any

item in any way. If an item bearing the seal of an engineer or land surveyor is altered, the altering engineer or land surveyor shall offix to the item his seal and the notation "altered by" followed by his signature and the date of such alteration, and a specific description of the alteration."

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		REVISIONS	DATE	

S



PROJECT MANAGER JL. SWEDROCK PROJECT ENGINEER RR. SPURR DRAWN BY VJ. SCHLAGETER DATE ISSUED SCALE DECEMBER 07, 202 PROJECT NO.

(SHEET 5 of 5)

DRAWING NO.

PROPOSED UNDERGROUND

3" ORIFICE ELEVATION = 522.3 9"HX6"W ORIFICE = 524.55

SEE STORMTECH DETAILS

PROPOSED 6'

DIA. STORM

(SEE DETAIL)

MANHOLE

6' WIDE WEIR

INV.=526.3

BOTTOM OF 2'HX6'W WEIR = 526.31-YR PONDING ELEVATION = 523.7210-YR PONDING ELEVATION = 525.16

100-YR PONDING ELEVATION = 526.26

TR=529.0

ELEVATION VIEW

STORMTECH OUTLET STRUCTURE DETAIL

6"WIDE

OPENING

—12" HDPE

OUTLET PIPE

INV.=522.3

HOLE

INV.= 522.3


INV=524.55

(SWMF)

STORMWATER CHAMBER SYSTEM

BOTTOM OF STORMTECH ELEVATION $=\pm 521.5$

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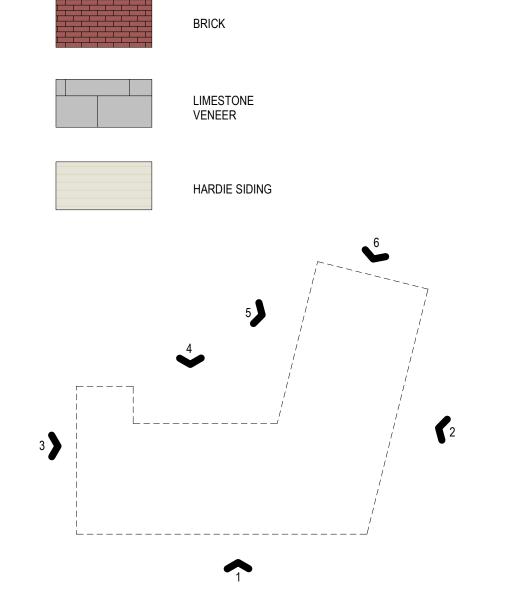


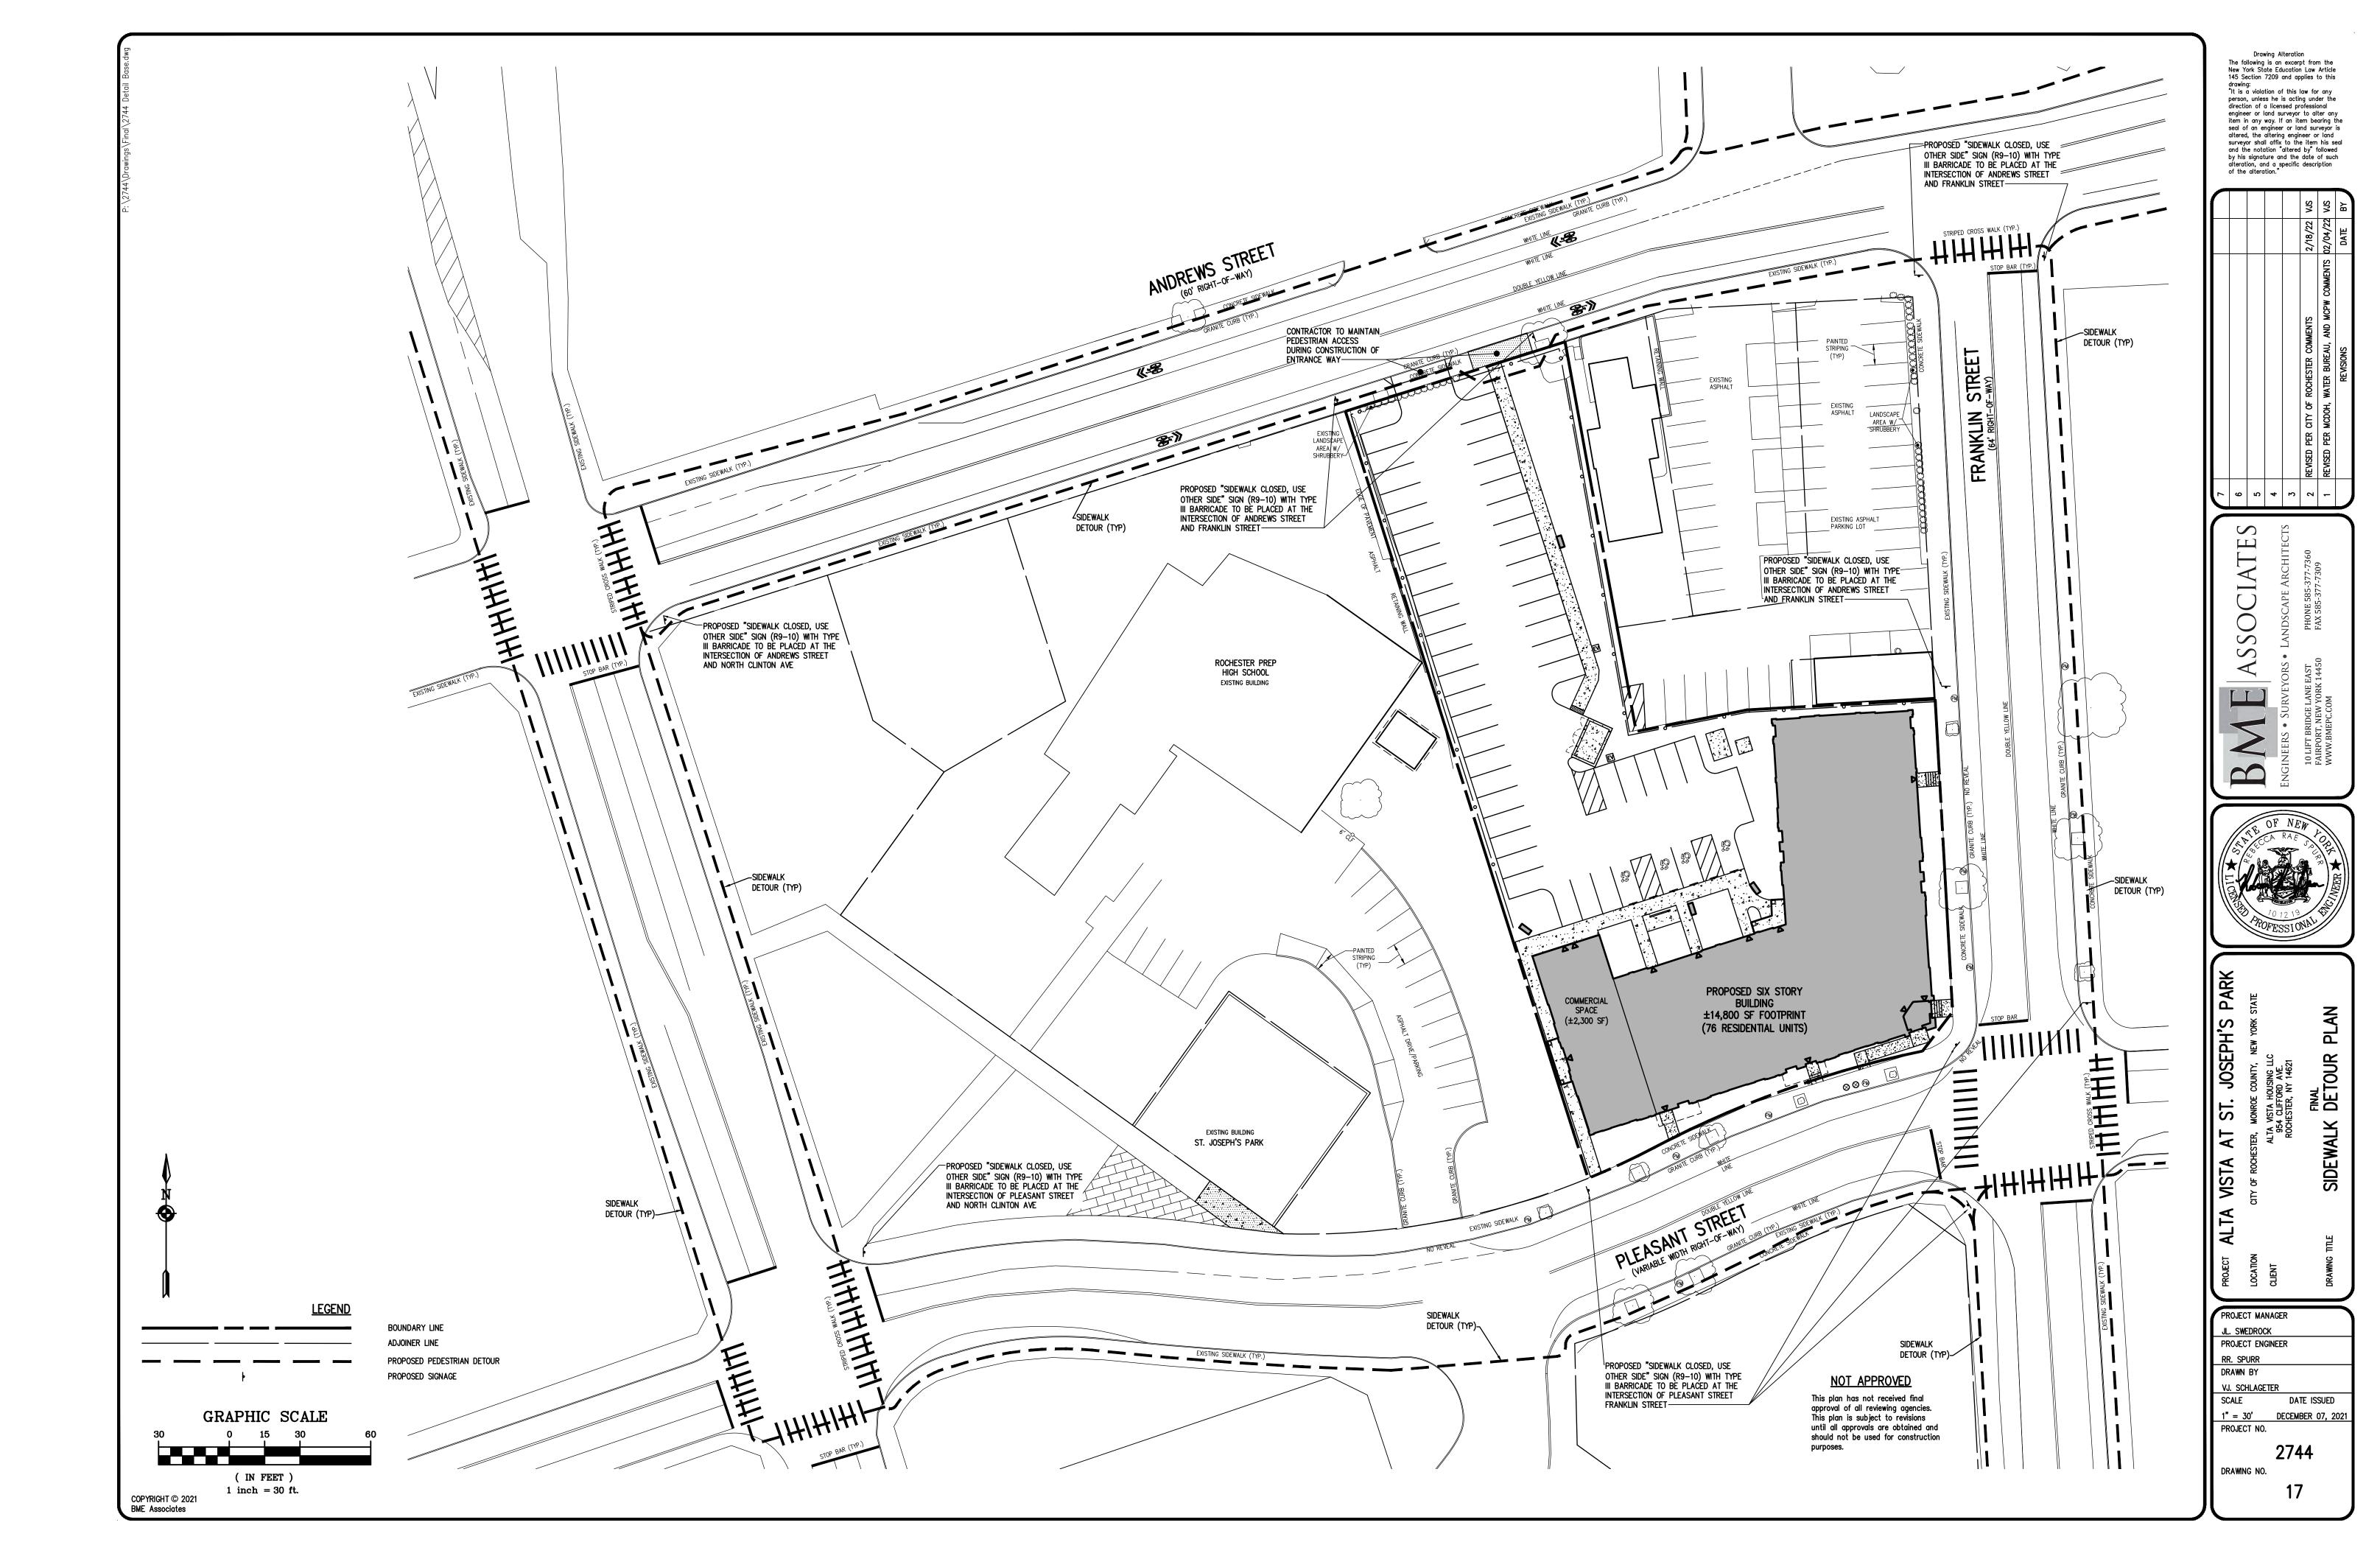





2 EAST ELEVATION - 1/8" = 1'-0"



MATERIALS LEGEND

_____ FOURTH FLOOR 32' - 0"

_____ <u>SECOND FLOOR</u> 12' - 0"




B.O. PARAPET 63' - 9" SIXTH FLOOR 52' - 0" FIFTH FLOOR 42' - 0" FOURTH FLOOR 32' - 0" THIRD FLOOR 22' - 0" SECOND FLOOR 12' - 0" 1 NORTH ELEVATION 2 - 1/8" = 1'-0"

3 NORTH ELEVATION - 1/8" = 1'-0"







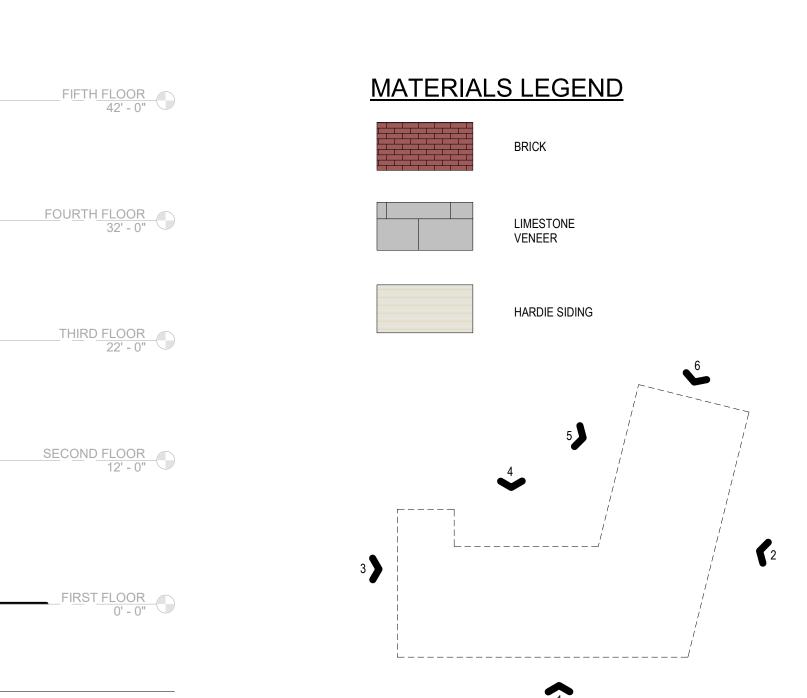

T.O. PARAPET 66' - 5"

1st flr Building Façade		2nd flr Building Façade	
Req'd Min	40%	Req'd Min	25%
Req'd Max	75%	Req'd Max	60%
1st flr building façade SF	3360	2nd flr building façade SF	2890
Window SF	1139	Window SF	765
Props'd Window Coverage	33.9%	Props'd Window Coverage	26.5%
Evaluation	Variance	Evaluation	ok
1st flr Rear Façade		2nd flr Rear Façade	
Req'd Min	20%	Req'd Min	20%
Req'd Max	100%	Req'd Max	100%
1st flr Rear façade SF	2316	2nd flr Rear façade SF	1930
Window SF	477	Window SF	438
Props'd Window Coverage	20.6%	Props'd Window Coverage	22.7%
Evaluation	ok	Evaluation	ok
1st flr Side (N) Façade		2nd flr Side (N) Façade	
Req'd Min	20%	Req'd Min	20%
Req'd Max	100%	Req'd Max	100%
1st flr Side 1 (N) façade SF	720	2nd flr Side 1 (N) façade SF	600
Window SF	120	Window SF	80
Props'd Window Coverage	16.7%	Props'd Window Coverage	13.3%
Evaluation	Variance	Evaluation	Variance
1st flr Side (W) Façade		2nd flr Side (W) Façade	
Req'd Min	20%	Req'd Min	20%
Req'd Max	100%	Req'd Max	100%
1st flr Side 2 (S) façade SF	924	2nd flr Side 2 (S) façade SF	600
Window SF	245	Window SF	120
Props'd Window Coverage	26.5%	Props'd Window Coverage	20.0%
Evaluation	ok	Evaluation	ok

3rd flr Building Façade		4th flr Building Façade
Req'd Min	25%	Req'd Min
Req'd Max	60%	Req'd Max
3rd flr building façade SF	2890	4th flr building façade SF
Window SF	740	Window SF
Props'd Window Coverage	25.6%	Props'd Window Coverage
Evaluation	ok	Evaluation
3rd flr Rear Façade		4th flr Rear Façade
Req'd Min	20%	Req'd Min
Req'd Max	100%	Req'd Max
3rd flr Rear façade SF	1930	4th flr Rear façade SF
Window SF	511	Window SF
Props'd Window Coverage	26.5%	Props'd Window Coverage
Evaluation	ok	Evaluation
3rd flr Side (N) Façade		4th flr Side (N) Façade
		, , , , , , , , , , , , , , , , , , , ,
Req'd Min	20%	Req'd Min
Req'd Min Req'd Max	20% 100%	
·		Req'd Min
Req'd Max 3rd flr Side 1 (N) façade SF	100%	Req'd Min Req'd Max
Req'd Max	100%	Req'd Min Req'd Max 4th flr Side 1 (N) façade SF
Req'd Max 3rd flr Side 1 (N) façade SF Window SF	100% 600 80	Req'd Min Req'd Max 4th flr Side 1 (N) façade SF Window SF
Req'd Max 3rd flr Side 1 (N) façade SF Window SF Props'd Window Coverage Evaluation	100% 600 80 13.3%	Req'd Min Req'd Max 4th flr Side 1 (N) façade SF Window SF Props'd Window Coverage Evaluation
Req'd Max 3rd flr Side 1 (N) façade SF Window SF Props'd Window Coverage Evaluation 3rd flr Side (W) Façade	100% 600 80 13.3% Variance	Req'd Min Req'd Max 4th flr Side 1 (N) façade SF Window SF Props'd Window Coverage Evaluation 4th flr Side (W) Façade
Req'd Max 3rd flr Side 1 (N) façade SF Window SF Props'd Window Coverage Evaluation	100% 600 80 13.3%	Req'd Min Req'd Max 4th flr Side 1 (N) façade SF Window SF Props'd Window Coverage Evaluation
Req'd Max 3rd flr Side 1 (N) façade SF Window SF Props'd Window Coverage Evaluation 3rd flr Side (W) Façade	100% 600 80 13.3% Variance	Req'd Min Req'd Max 4th flr Side 1 (N) façade SF Window SF Props'd Window Coverage Evaluation 4th flr Side (W) Façade
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Req'd Max 3rd flr Side 1 (N) façade SF Window SF Props'd Window Coverage Evaluation 3rd flr Side (W) Façade Req'd Min Req'd Max 3rd flr Side 2 (S) façade SF	100% 600 80 13.3% Variance 20% 100% 600	Req'd Min Req'd Max 4th flr Side 1 (N) façade SF Window SF Props'd Window Coverage Evaluation 4th flr Side (W) Façade Req'd Min Req'd Max 4th flr Side 2 (S) façade SF

25%

60%

2890

740

25.6%

ok

20%

100%

1930

511

26.5%

ok

20%

100%

600

80

13.3%

Variance

20%

100%

600

80

13.3%

Variance

5th flr Building Façade		6th fir Building Façade
Req'd Min	25%	Req'd Min
Req'd Max	60%	Req'd Max
3rd flr building façade SF	2890	4th flr building façade SF
Window SF	740	Window SF
Props'd Window Coverage	25.6%	Props'd Window Coverage
Evaluation	ok	Evaluation
5th flr Rear Façade		6th flr Rear Façade
Req'd Min	20%	Req'd Min
Req'd Max	100%	Req'd Max
3rd flr Rear façade SF	1930	4th flr Rear façade SF
Window SF	511	Window SF
Props'd Window Coverage	26.5%	Props'd Window Coverage
Evaluation	ok	Evaluation
5th flr Side (N) Façade		6th flr Side (N) Façade
Req'd Min	20%	Req'd Min
Req'd Max	100%	Req'd Max
3rd flr Side 1 (N) façade SF	600	4th flr Side 1 (N) façade SF
Window SF	80	Window SF
Props'd Window Coverage	13.3%	Props'd Window Coverage
Evaluation	Variance	Evaluation
File (L. C. L. (MA) Francis		CIL (L. C. L. (MA) F L.
5th flr Side (W) Façade		6th flr Side (W) Façade
Req'd Min	20%	Req'd Min
Req'd Max		•
	100%	Req'd Max
3rd flr Side 2 (S) façade SF	100%	Req'd Max 4th flr Side 2 (S) façade SF
3rd flr Side 2 (S) façade SF Window SF		·
	600	4th flr Side 2 (S) façade SF

25%

60%

2890

740

25.6%

ok

20%

100%

1930

511

26.5%

ok

20%

100%

600

80

13.3%

Variance

20%

100%

600

80

13.3%

Variance

IN/EX Architecture P.C.

133 South Fitzhugh Street Rochester, NY 14608

March 8, 2022

City of Rochester Bureau of Buildings and Zoning 30 Church Street, Room 125B Rochester, NY 14614

Attn: Anna L. Keller, Senior Community Housing Planner

Re: ALTA Vista 2744

Site Plan Review

PRC Response to Comments

Dear Anna:

On behalf of the project applicant, ALTA Vista Housing LLC, we have reviewed the PRC comments for the above-referenced project, dated February 16, 2022, and have the following responses for the City's consideration:

Massing

The material layout does not reinforce a vertical fenestration pattern.

Requests:

1) Revise building design accordingly.

The height of the cornice was increased at the projecting portions of the façade, defined by the piers extending the full six stories, to create a vertical delineation in two locations on each facade. The 6-story stone corner element was expanded on both Pleasant and Franklin Streets to provide an even stronger presence.

Transparency

It is necessary for the proposed project to align with the purpose of the zoning district by designing the building and configuring the site with the public realm in mind. The PRC recommends providing transom windows above current proposed windows and doors on all first floor facades and/or increasing the size of the proposed doors.

Requests:

1) Transparency requirements for all first floor facades must be met.

The transparency for the street facades was increased from 23% to 33.9%. Any additional changes to the window pattern would disrupt and draw unwanted attention. More importantly, as a residential building, safety and privacy are important to tenants that have apartments along the first floor. The double doors were removed at the street level and changed to double casements instead to help with security and also control possible dust and snow concerns at the grade plane. Additional windows were also added to the North façade.

2) Transparency requirements for all facades facing the landmark site must be met.

Additional windows were added to the South West corner of the West façade as suggested in the review. Additional windows were added to the second floor of the commercial space to create more transparency. Additional windows were also added to the North façade.

IN/EX Architecture P.C.

133 South Fitzhugh Street Rochester, NY 14608

Commercial Entrance

The project site is adjacent to St Joseph's Park, a landmark site. The project plans include a 2,810 square foot commercial, multi-purpose room intended to be used for special events occurring at the adjacent landmark park. The PRC stated that the detailing of the proposed building, specifically the façade that faces the landmark site is important due to the proximity and relationship to the landmark site. Given that a new commercial space is proposed in the CCD-B district pedestrian access is needed to strengthen and maintain street-level activity and pedestrian circulation.

Requests:

- 1) Provide renderings that demonstrate how the proposed building, specifically the west façade relates to the adjacent landmark site. Be sure to include any other improvements that strengthen the connection between the two structures.
 - Additional windows were added to the first and second floor of the commercial space to provide a better visual connection to St. Joseph Church. The existing walkway will have dedicated lighting to create a guided pathway between the commercial space and St. Joseph's Church.
- 2) Provide an entrance to the commercial space with direct pedestrian access from the street.

The Landmark Society has ownership of St. Joseph's Church and holds several functions throughout the year. The commercial space allows them to expand their options to host events throughout the year and provide additional hosting benefits. There is currently a 10 year lease agreement in place and there is no indication that this relationship will not continue well into the future. The tenant has been involved in design meetings and have indicated that this orientation provides the best possible set up for their hosting needs.

Design

Additional detailing is requested on the tower situated on the Corner of Franklin St and Pleasant St. This tower should serve as a prominent architectural feature of the proposed building.

The 6-story stone corner element was expanded on both Pleasant and Franklin Streets to provide an even stronger presence with additional transparency added.

The PRC is unable to comment on the brick pilasters with the provided renderings and thus requests new renderings in order to determine if their massing is satisfactory or whether a modification or alternative is preferable.

It is the belief of the project team that the stepping of the façade and brick pilasters due their part to provide vertical articulation of the façade during the daylight hours and will have lighting to provide that effect at night.

The project cannot support the financial cost of 5 stories of brick

If you have any additional comments or require any additional information, please contact our office.

Sincerely,

Tason Simmons

IN/EX Architecture

c: Eugenio Marlin; ALTA Vista Housing LLC, Chris Roland, Edgemere Development



Neighborhood and Business Development City Hall Room 125B, 30 Church Street Rochester, New York 14614-1290 www.cityofrochester.gov

4 March 2022

Mike McCracken Hospitality Syracuse 290 Elwood Davis Road, Suite 320 Syracuse, NY 13088

Re: Site Plan Review (SP-01-21-22)
1737 Mt. Hope Avenue, 20 Elmerston Road, 35 Shelbourne Road
C-2 Community Center District

Dear Mr. McCracken:

We appreciate the thorough and detailed response to our preliminary findings. This office remains concerned about the appropriateness of this design given the numerous waivers from the current zoning code required in order to make it work on this very restricted site, as well as its inability to meet the draft new code for Drive-Through Restaurants. This draft code is not yet adopted, but aligns the current zoning with the Rochester 2034 Comprehensive Plan, which is adopted. Therefor it is appropriate for consideration in this review.

However, we will be proceeding to Project Review Committee in accordance with the Site Plan Review process. In preparation for that meeting, we offer the following additional commentary. The current and alternate schemes proposed fail to address the desired changes to the site. These include, but are not limited to:

- Direct pedestrian access.
- Building frontage on Mt. Hope Avenue.
- Minimization of conflict points with internal vehicular circulation including:
 - Elimination of cars entering the drive through from two possible directions.
 - Establishment of a by-pass lane.
- Elimination of drive-through elements between the building and the public streets.

After review of the materials presented, it is clear that a plan could be provided that meets all or most of these requests. It is also clear that, in meeting all of them, there are significant detriments to the goals of the development and developer. This brings into question whether this site is workable at all and continues to lead this office towards denial.

We believe there are reasonable considerations that could greatly improve the site with minimal detriment to the development that have not been explored. These include, but are not limited to, the items below. These items are not necessarily additive:

 One-way traffic to eliminate conflict points. While the applicant has shown multiple examples of projects with conflict points, in all cases they are sites adjacent to multiple parking and access aisles that allow alternative routes, and the sites Preliminary Site Plan Review SP-01-21-22 1737 Mt. Hope Avenue Page 2

themselves offer enough clear visibility of the conflict point for a potential customer to see the conflict point well before they are stuck in the queue line because additional cars have come in behind them, and cars are blocking their access to the drive aisle to leave.

- Reduction of the number order lanes.
- Elimination of Shelbourne Road access except for truck access. This access could be gated and limited to use by delivery trucks.
- Use of a non-standard building layout/design to address the non-standard site constraints, including corner frontage to keep the existing curb cut on Mt. Hope, provide direct pedestrian access and eliminate the vehicular elements between the building and the street. The applicant has used the example of the Lake Avenue project to show the need for pedestrians to cross at least one driveway curb cut to get to the Taco Bell. This is true, however we continue to contend that walking along a sidewalk and crossing driveways/curb cuts along that sidewalk is inherently different from crossing internal drive aisles within a site. The use of curbing on the site plan does mitigate this difference. But direct pedestrian access remains a code requirement and a desired part of the site design.
- · Shifting of the building further back on the site.


We hope we are able to resolve these major issues and find a site plan that uses the new C-2 zoning to its advantage and meets the requirements for a C-2 site. We look forward to further discussion at the Project Review Committee. If you have any further questions regarding this proposal, please contact my office.

Sincerely.

Roseanne Khaleel Manager of Zoning

cc: Stephanie Albright, P.E., ADP Anna Keller, COR

Marcia Barry, COR

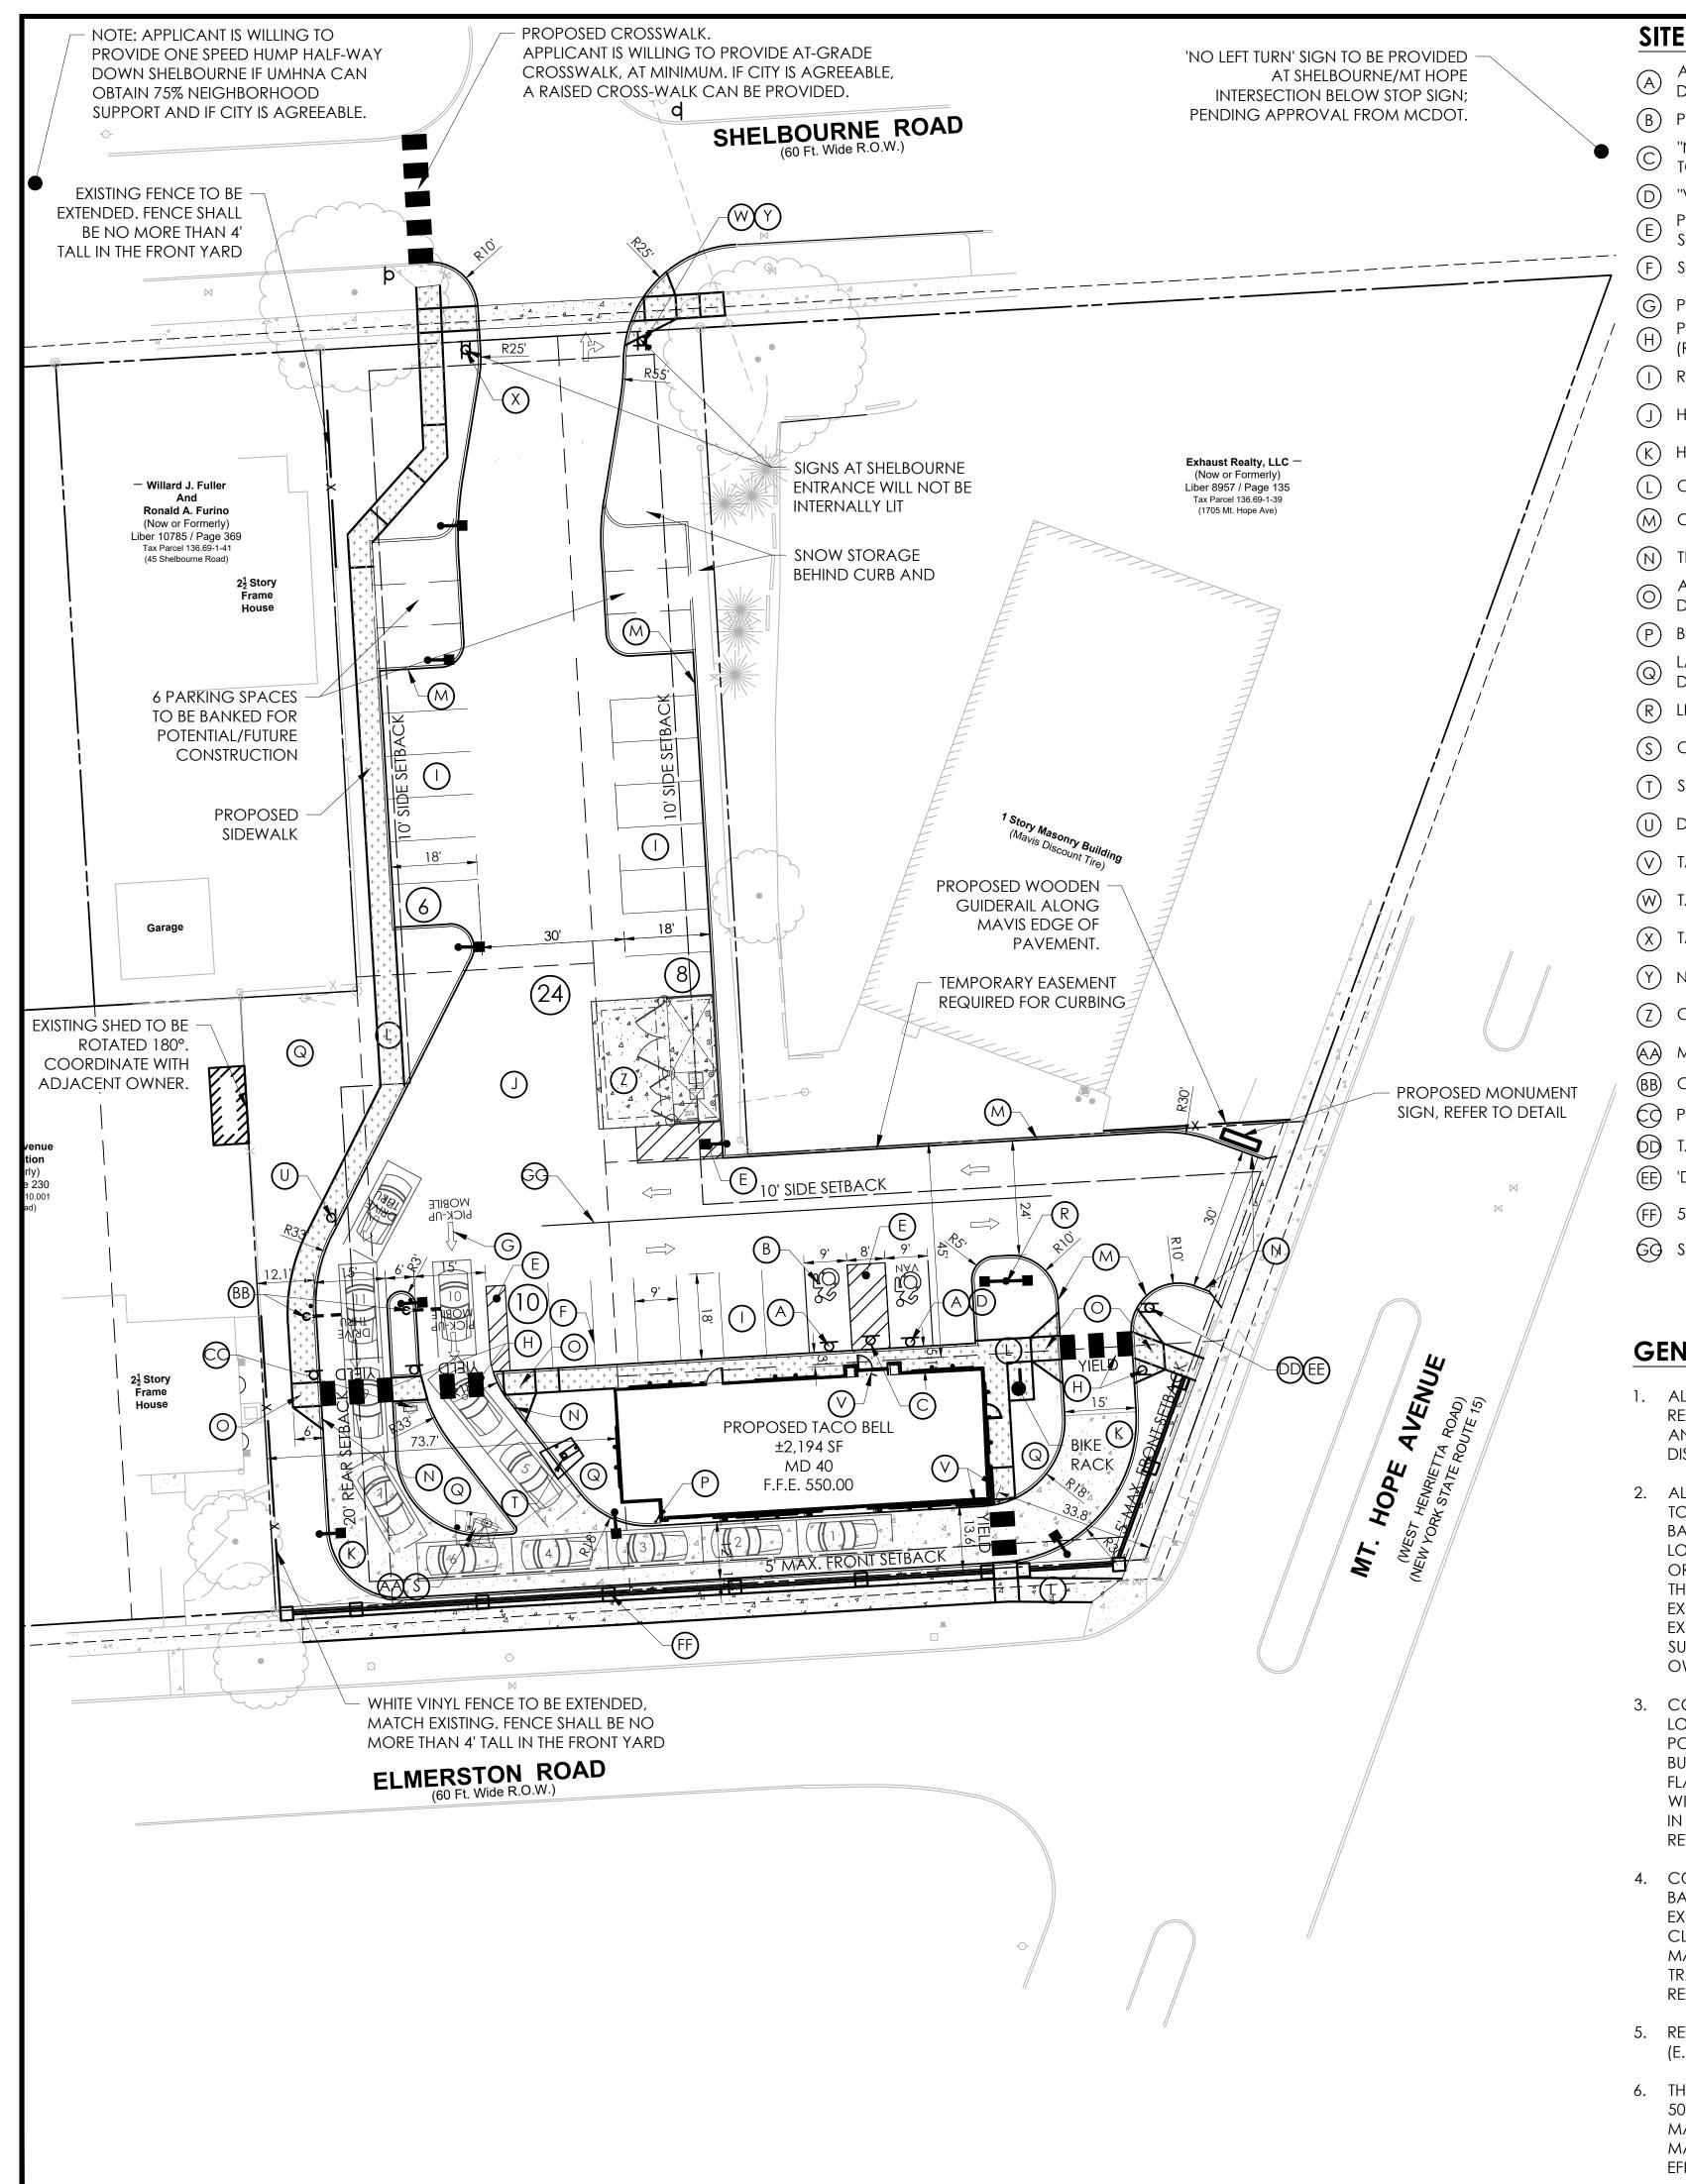

SITE LEGEND:


- ACCESSIBLE PARKING SIGN, POST & BOLLARD (REFER TO
- (B) PAINTED ACCESSIBLE PARKING SYMBOL (REFER TO DETAIL)
- "NO PARKING ANY TIME" SIGN, POST & BOLLARD (REFER TO DETAIL)
- "VAN ACCESSIBLE" STRIPING AND SIGN (REFER TO DETAIL)
- PAINTED PARKING ISLAND AREA TO BE STRIPED WITH 4" SYSL @ 2'-0" O.C. AND AT 45° TO PARKING SPACE.
- (F) SYSL/4" PARKING STALL STRIPING
- PAVEMENT MARKINGS ARROWS (REFER TO DETAIL)
- PEDESTRIAN CROSSWALK, YIELD TEXT, AND SIGNAGE (REFER TO DETAIL)
- (I) REGULAR DUTY PAVEMENT (REFER TO DETAIL)
- (${\sf J}$) Heavy Duty Pavement (refer to Detail)
- (K) HEAVY DUTY CONCRETE (REFER TO DETAIL)
- (L) CONCRETE SIDEWALK (REFER TO DETAIL)
- M CONCRETE CURB (REFER TO DETAIL)
- N TRANSITION CURB (REFER TO DETAIL)
- ADA RAMP AND DETECTABLE WARNING (REFER TO O DETAIL)
- (P) BOLLARDS (REFER TO ARCH. PLAN DETAIL)
- LAWN/MULCH AREA (REFER TO PLANTING PLAN FOR Q DELINEATION)
- (R) LIGHT POLE (REFER TO DETAIL)
- (S) CANOPY & SPEAKER BOX (REFER TO DETAIL)
- (T) SPEAKER BOX (REFER TO DETAIL)
- (U) DRIVE THRU SIGN (PROVIDED BY SIGN VENDOR)
- (V) TACO BELL LOGO SIGN (PROVIDED BY SIGN VENDOR)
- (W) TACO BELL EXIT SIGN (PROVIDED BY SIGN VENDOR)
- (X) TACO BELL ENTER SIGN (PROVIDED BY SIGN VENDOR)
- (Y) NO LEFT TURN SIGN
- (Z) CONCRETE DUMPSTER PAD (REFER TO ARCH. PLANS)
- (A) MENU BOARD (REFER TO DETAIL)
- CLEARANCE BAR (REFER TO DETAIL)
- PREVIEW BOARD (REFER TO DETAIL)
- TACO BELL 'THANK YOU' SIGN (PROVIDED BY SIGN VENDOR)
- 'DO NOT ENTER' SIGN (PROVIDED BY SIGN VENDOR)
- (FF) 5' HIGH SOLID WALL (REFER TO DETAIL)
- SINGLE YELLOW SOLID LINE/4" WIDE

GENERAL NOTES:

- ALL IMPROVEMENTS SHALL BE IN ACCORDANCE WITH THE MOST RECENT STANDARDS AND SPECIFICATIONS OF THE CITY OF ROCHESTER AND/OR THE APPROPRIATE WATER, SEWER AND/OR DRAINAGE DISTRICTS, AND/OR OTHER AUTHORITIES HAVING JURISDICTION.
- 2. ALL EXISTING BUILDING(S), SITE, ROADWAY, UTILITY, BOUNDARY, AND TOPOGRAPHY INFORMATION SHOWN ON THIS PLAN IS REPRESENTED BASED ON USE OF THE LISTED REFERENCES. CONTRACTOR TO VERIFY LOCATION AND LIMITS OF WORK PRIOR TO STARTING. ANY CHANGES OR CONFLICTS DISCOVERED SHALL BE BROUGHT TO THE ATTENTION OF THE OWNER AND ENGINEER. IF CONTRACTOR DOES NOT ACCEPT EXISTING TOPOGRAPHY AS SHOWN ON THE PLANS, WITHOUT EXCEPTION, HE SHALL HAVE MADE, AT HIS EXPENSE, A TOPOGRAPHIC SURVEY BY A REGISTERED LAND SURVEYOR AND SUBMIT IT TO THE OWNER FOR REVIEW.
- 3. CONTRACTOR SHALL REFER TO ARCHITECTURAL PLANS FOR EXACT LOCATIONS AND DIMENSIONS OF VESTIBULE, SLOPED PAVING, EXIT PORCHES, RAMPS, PRECISE BUILDING DIMENSIONS, AND EXACT BUILDING UTILITY ENTRANCE LOCATIONS. ALL PAVING, CURBING, FLATWORK, SIDEWALKS, FENCING, BOLLARDS, ETC., WHICH CONFLICT WITH NEW CONSTRUCTION ARE TO BE DEMOLISHED AND DISPOSED OF IN ACCORDANCE WITH ANY LOCAL, STATE, OR FEDERAL REGULATIONS.
- 4. CONTRACTOR MUST PROTECT THE PUBLIC AT ALL TIMES WITH FENCING, BARRICADES, ENCLOSURES, ETC. CONTRACTOR SHALL MAINTAIN ALL EXISTING PARKING, SIDEWALKS, DRIVES, ETC. OUTSIDE OF WORK LIMITS CLEAR AND FREE FROM ANY CONSTRUCTION ACTIVITY AND/OR MATERIAL TO ENSURE EASY AND SAFE PEDESTRIAN AND VEHICULAR TRAFFIC TO AND FROM THE SITE. SIDEWALKS WITHIN R.O.W. SHALL REMAIN OPEN AT ALL TIMES DURING CONSTRUCTION.
- 5. REFER TO THE SURVEY FOR THE PROPERTY BOUNDARY INFORMATION (E.G. LOT AREA, BEARINGS, DISTANCES, ETC).
- 6. THE SITE IS IN FLOOD ZONE X, AREAS DETERMINED TO BE OUTSIDE 500-YEAR FLOODPLAIN, AS SHOWN ON FLOOD STUDY INSURANCE MAP OF CITY OF ROCHESTER PUBLISHED BY FEDERAL EMERGENCY MANAGEMENT AGENCY, COMMUNITY PANEL NO. 36055C0351G, MAP EFFECTIVE DATE 08/28/08.

REFERENCE:

- PICTOMETRY AERIAL IMAGERY
- ALTA/NSPS LAND TITLE SURVEY LANDS OF 1737 MT HOPE AVE AND 35 SHELBOURNE RD, PROJECT NUMBER 2021.045.001, PREPARED BY JACOBS LAND SURVEYING, LAST REVISED OCTOBER 12, 2021.

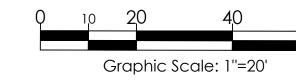

AS REQUIRED BY NEW YORK STATE LAW, CONTRACTOR SHALL CONTACT "DIG SAFELY NEW YORK" (UFPO) @ 1-800-962-7962 FOR LOCATION STAKE-OUT OF ALL UTILITIES, AT LEAST 2 FULL WORKING DAYS PRIOR TO ANY EXCAVATION.

LEGEND OF IMPROVEMENTS

	
BACK OF CURB FACE OF CURB	FACE OF CURB/BACK OF CURB
	SUBJECT PARCEL PROPERTY LINE
	SETBACK LINE
• + + + + + + + + + + + + + + + + + + +	PROPOSED BUILDING CONCRETE SIDEWALK (REFER TO DETAIL)
A d	HEAVY DUTY CONCRETE (REFER TO DETAIL)
	HEAVY DUTY PAVEMENT (REFER TO DETAIL)

TO DETAIL)

LIGHT POLES

PEDESTRIAN CROSSWALK (REFER

SITE DATA:

PROPOSED IMPERVIOUS:

OCAL JURISDICTION:	City of Rochester
	C-2 Community Center District and
ONING CLASSIFICATION:	R-1 Low Density Residential
PROPOSED ZONING:	C-2 Community Center District
PERMITTED USES:	Restaurants, without drive thru
PECIAL PERMITTED USES:	Drive Thrus
CURRENT OWNER:	1737 Mt Hope Avenue Realty
	Corporation and 35 Shelbourne,
	LLC
UTURE OWNER:	Fairlane Drive
PROPERTY ACREAGE:	± 0.76 Ac (Lot consolidation req'd)
EXISTING IMPERVIOUS:	± 0.63 Ac

± 0.57 Ac

EXISTING PARCEL DATA:

ADDRESS	SECTION/BLOCK/LOT	ZONING	ACREAGE
35 SHELBOURNE RD	136.69-1-40	C-2 (NOTE 1)	0.272 AC
20 ELMERSON RD	136.77-1-11.001	C-2 (NOTE 1)	0.224 AC
1737 MT. HOPE AVE	136.77-1-12.001	C-2	0.262 AC
NOTES:			TOTAL = 0.76 AC


1. CITY COUNCIL APPROVED THE REZONING AT THEIR 11/09/21 MEETING.

BULK REQUIREMENTS	REQUIRED	EXISTING	PROPOSED
MAX. FRONT YARD	5 FT	25 FT (MT HOPE), 22.7 FT (ELMERSTON)	33.7 FT (MT HOPE 13.5' ELMERSTON
REAR YARD (WEST) (PER R-1 DISTRICT)	20 FT	87 FT	73.7 FT
SIDE YARD (NORTH) (PER R-1 DISTRICT)	10' MIN. WITH A COMBINED WIDTH OF 25 FT.	0 FT	45 FT
MAXIMUM BUILDING AREA	6,000 SF	33,103 SF	2,194 SF
MINIMUM BUILDING HEIGHT	20 FT	11.1 FT (MIN.)	23 FT
DRIVE THRU LOCATION	PROHIBITED IN THE FRONT YARD	N/A	FRONT YARD
DRIVE THRU SCREENING	DRIVE THRU AND QUEUING LANES SHALL BE SCREENED FROM RESIDENTIAL PROPERTIES.	N/A	
MINIMUM PARKING REQUIREMENT	6 PER 1,000 SF OF NET FLOOR AREA (13 SPACES)	37 SPACES	24 SPACES (6 BANKED)
MAXIMUM PARKING REQUIREMENT	110% OF MINIMUM PARKING. PARKING ANALYSIS PLAN AND SPECIAL PERMIT REQUIRED TO EXCEED MAXIMUM. (14 SPACES)	37 SPACES	24 SPACES (6 BANKED)
BICYCLE PARKING	10% OF THE VEHICLE PARKING REQUIREMENTS, WITH A MINIMUM OF 2 BICYCLES	0	7

SITE NOTES:

- 1. ALL NEW PAINTED PAVEMENT MARKINGS SUCH AS DIRECTIONAL ARROWS AND LETTERING SHALL BE PAINTED USING TEMPLATES.
- 2. ALL DIMENSIONS AND RADII ARE TO THE FACE OF CURB UNLESS OTHERWISE NOTED.
- 3. THE SETBACK LINES AND NOTES RELATED TO SETBACKS SHOWN HEREIN ARE INTENDED TO SHOW APPLICABLE ZONING REQUIREMENTS OF THE CITY OF ROCHESTER AS OF THE DATE OF THIS PLAN AND ARE NOT INTENDED TO IMPOSE ANY ADDITIONAL RESTRICTIONS OTHER THAN SAID ZONING REQUIREMENTS.
- 4. REFER TO LIGHTING PLAN, SHEET C5, FOR LIGHT POLE AND BUILDING MOUNTED LIGHT LOCATIONS, AND FIXTURE TYPE.

	Issued:		Date:
Α	City of Rochester		11/12/21
В	City of Rochester		02/10/22
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	Revisions:		Date:
1	Per City Site Plan comn	nents	02/10/22
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	B C D E F G H 1 2 3 4 5 6 7	A City of Rochester B City of Rochester C D E F G H Revisions: 1 Per City Site Plan comm 2 3 4 5 6 7	A City of Rochester B City of Rochester C D E F G H Revisions: 1 Per City Site Plan comments 2 3 4 5 6 7

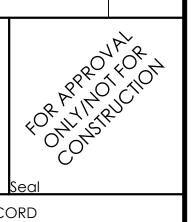

CIVIL ENGINEER OF RECORD Name: Stephanie L. Albright New York License No.: 087051 Exp. Date. December 31, 2023 Firm Reg. No.: 0014815 Exp. Date: December 31, 2023

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Engineer of Record with any need for additional dimensions or





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Taco Bell - Rochester NY

1737 Mt. Hope Ave City of Rochester


Monroe County

Project Name & Location:

Site Plan

Drawing Name: Project No. Date: 06/10/21 20-0531 MD40 Type:

Drawn By: SLA Scale: 1" = 20' Drawing No.

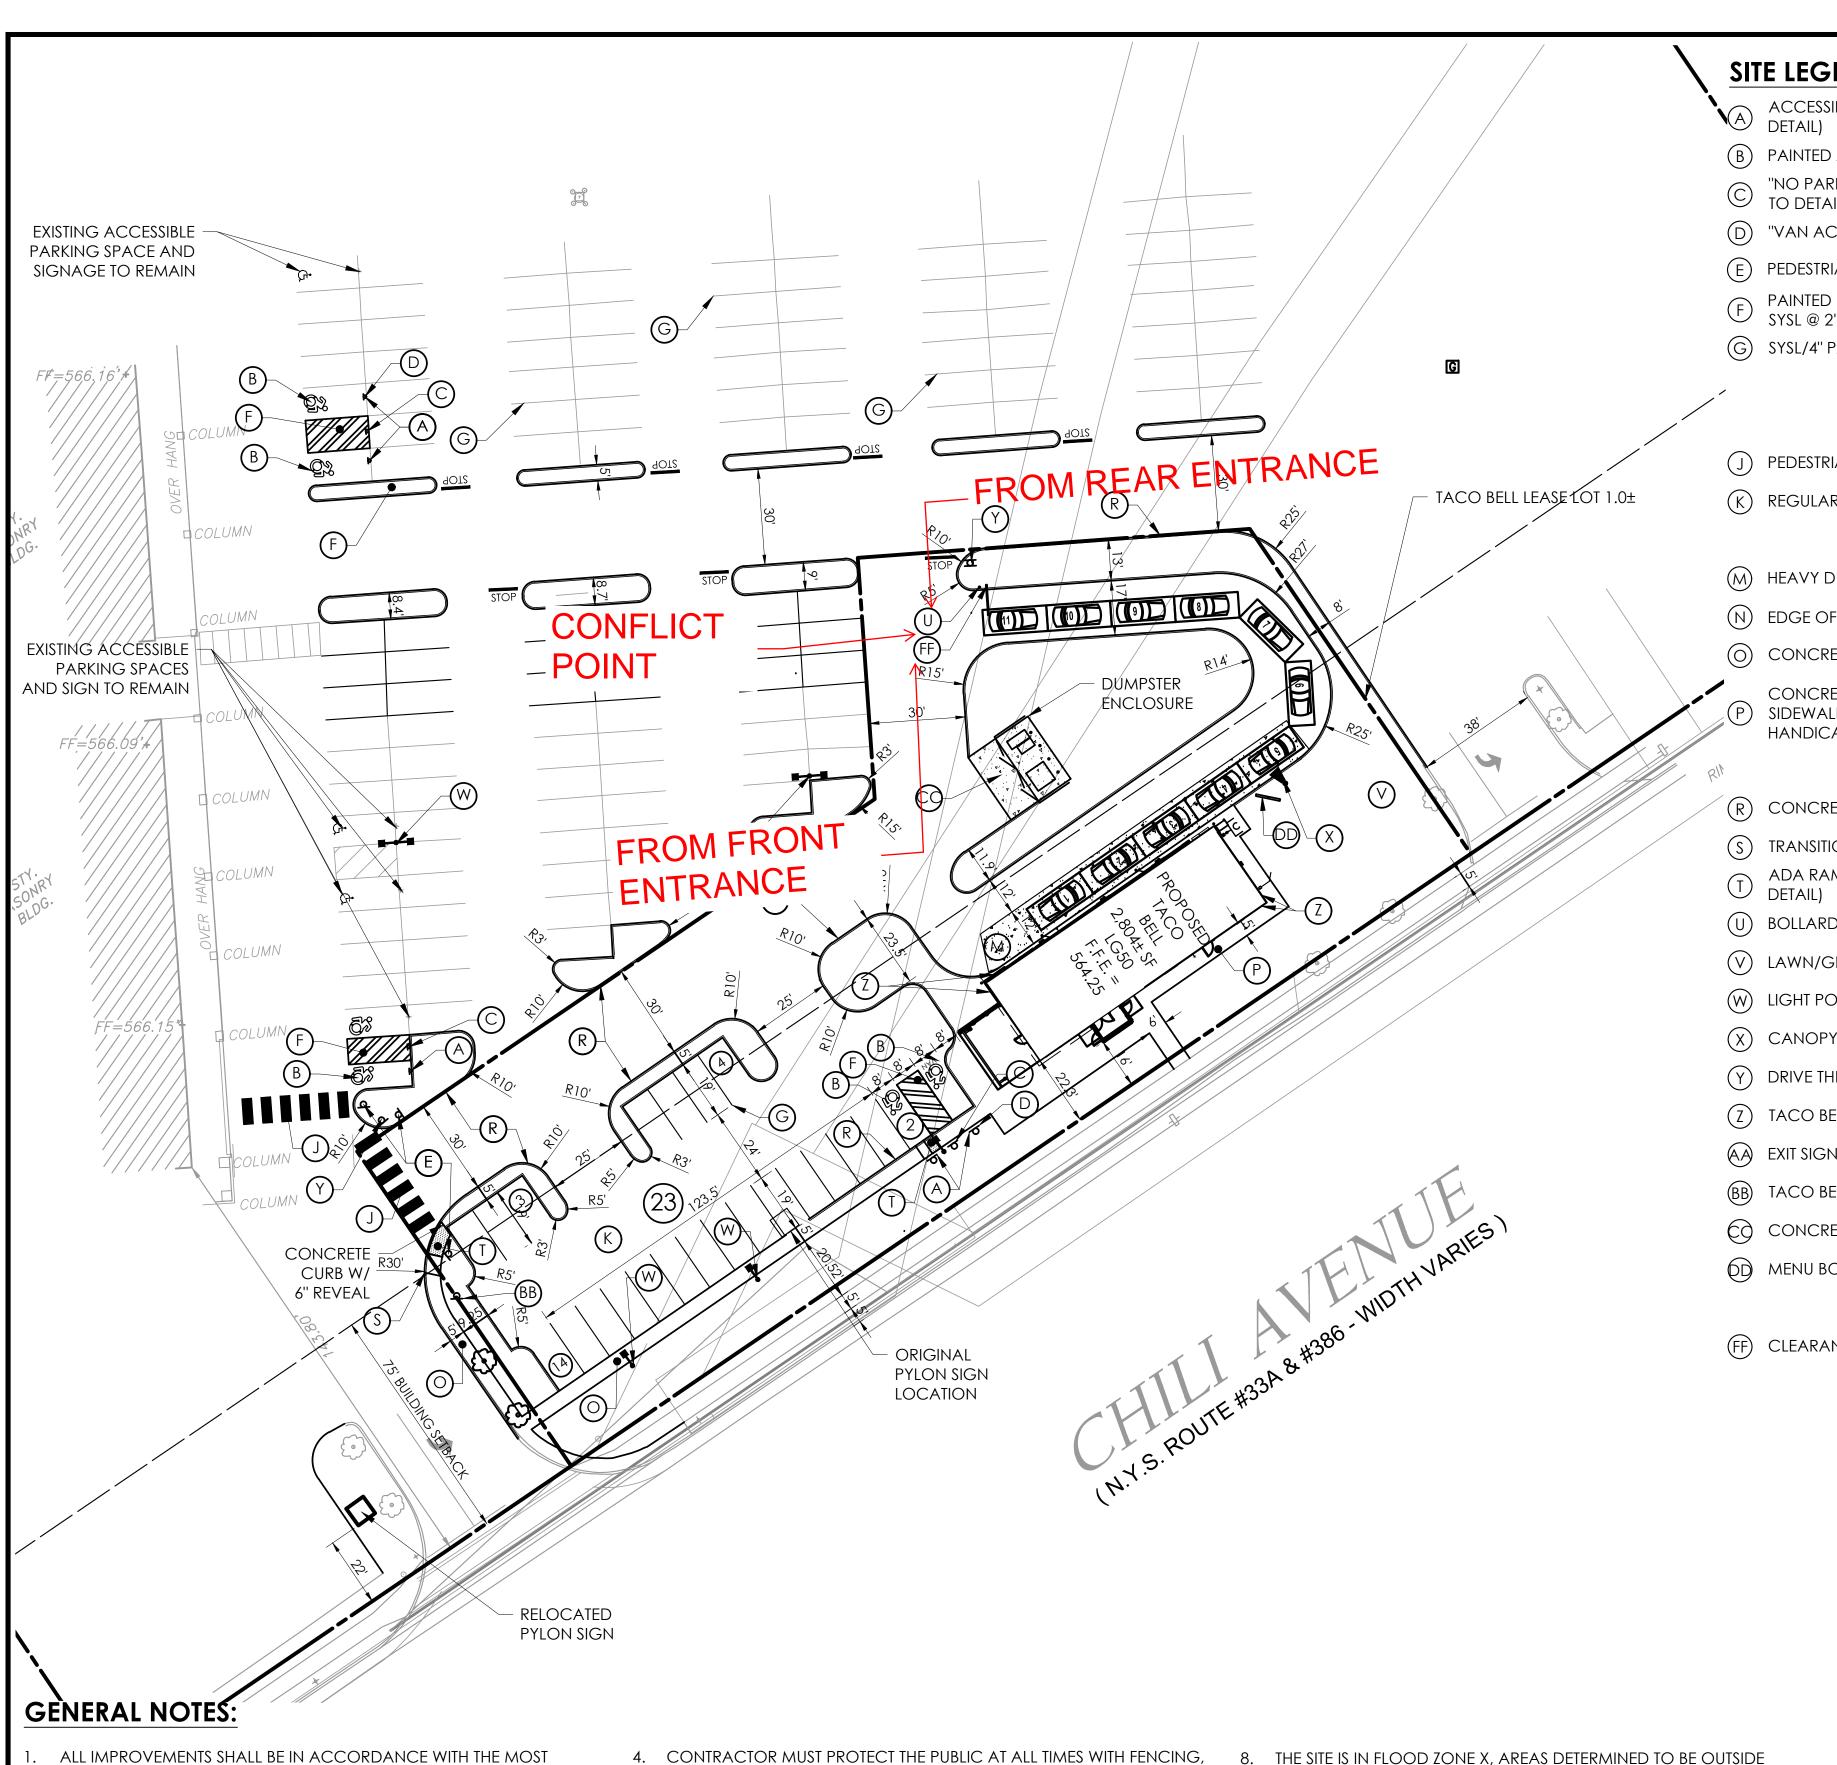

SITE LEGEND:

- ACCESSIBLE PARKING SIGN, POST & BOLLARD (REFER TO DETAIL)
- (B) PAINTED ACCESSIBLE PARKING SYMBOL (REFER TO DETAIL)
- "NO PARKING ANY TIME" SIGN, POST & BOLLARD (REFER TO DETAIL)
- (D) "VAN ACCESSIBLE" SIGN (REFER TO DETAIL)
- (E) PEDESTRIAN CROSSING SIGN (REFER TO DETAIL)
- PAINTED PARKING ISLAND AREA TO BE STRIPED WITH 4" SYSL @ 2'-0" O.C. AND AT 45° TO PARKING SPACE.
- G SYSL/4" PARKING STALL STRIPING
- J PEDESTRIAN CROSSWALK (REFER TO DETAIL)
- (K) REGULAR DUTY PAVEMENT (REFER TO DETAIL)
- M HEAVY DUTY CONCRETE (REFER TO DETAIL)
- (N) EDGE OF PAVEMENT
- O CONCRETE SIDEWALK (REFER TO DETAIL)
- CONCRETE SIDEWALK (REFER TO ARCH. PLANS). SIDEWALK ADJACENT TO CANOPY & IN FRONT OF HANDICAP PARKING SHALL BE FLUSH WITH PAVEMENT.
- (R) CONCRETE CURB (REFER TO DETAIL)
- (S) TRANSITION CURB (REFER TO DETAIL)
- ADA RAMP AND DETECTABLE WARNING (REFER TO
- (U) BOLLARDS (REFER TO ARCH. PLAN DETAIL)
- (V) LAWN/GRASS AREA
- (W) LIGHT POLE (REFER TO DETAIL)
- (X) CANOPY AND SPEAKER BOX (REFER TO ARCH. PLAN)
- (Y) DRIVE THRU SIGN (REFER TO DETAIL)
- (Z) TACO BELL LOGO SIGN (REFER TO DETAIL)
- (A) EXIT SIGN (REFER TO DETAIL)
- (BB) TACO BELL ENTRANCE (REFER TO DETAIL)
- CONCRETE DUMPSTER PAD (REFER TO DETAIL)
- (REFER TO DETAIL)
- (FF) CLEARANCE BAR (REFER TO DETAIL)

SITE DATA:

LOCAL JURISDICTION: TOWN OF CHILI ZONING CLASSIFICATION: GENERAL BUSINESS PERMITTED USES: **EATING ESTABLISHMENTS**

REFERENCE:

SURVEY PROVIDED BY RAVI

LAST UPDATED ON 04/03/17

ENGINEERING & LAND SURVEYING, P.C.

BULK REQUIREMENTS	REQUIRED	EXISTING	PROPOSED	VARIANCE
FRONT YARD	75 ft	N/A	16'± (1)	YES
SIDE YARD	None			NO
REAR YARD	N/A			NO
PARKING	1 space per table or 1 for each 200 SQFT of floor area or 1 space per 4 seats whichever is greater (50 seats / 14 tables = 14 spaces (greatest)	N/A	23	NO
PARKING STALL WIDTH	9.5 FT		9.5 FT	NO
PARKING STALL LENGTH	19 FT		19 FT	NO

- 1. SETBACK VARIANCE GRANTED 04/26/19.

PERVIOUS/LAWN AREAS; WETLANDS ARE NOT EXPECTED TO BE

SITE NOTES:

- 1. ALL NEW PAINTED PAVEMENT MARKINGS SUCH AS DIRECTIONAL ARROWS AND LETTERING SHALL BE PAINTED USING TEMPLATES. REPAINT (TWO COATS) EXISTING DIRECTIONAL ARROWS, STOP BARS, AND OTHER PAVEMENT MARKINGS ON ENTIRE SITE TO MATCH EXISTING.
- ALL WORK SHALL BE COORDINATED WITH THE CLIENT CONSTRUCTION MANAGER AND PLAZA OWNER/MANAGER 48 HOURS IN ADVANCE, AND VEHICULAR, TRUCK AND PEDESTRIAN ACCESS TO THE STORE SHALL BE MAINTAINED AT ALL TIMES.

- 3. ALL DIMENSIONS AND RADII ARE TO THE FACE OF CURB UNLESS OTHERWISE NOTED.
- THE SETBACK LINES AND NOTES RELATED TO SETBACKS SHOWN HEREIN ARE INTENDED TO SHOW APPLICABLE ZONING REQUIREMENTS OF THE TOWN OF CHILI AS OF THE DATE OF THIS PLAN AND ARE NOT INTENDED TO IMPOSE ANY ADDITIONAL RESTRICTIONS OTHER THAN SAID ZONING REQUIREMENTS.
- 5. REFER TO LIGHTING PLAN, SHEET C9, FOR LIGHT POLE AND BUILDING MOUNTED LIGHT LOCATIONS, FIXTURE TYPE, AND PHOTOMETRICS.

ABBREVIATIONS:

- 1. SYSL/4" SINGLE YELLOW SOLID LINE / 4" WIDE EACH
- 2. TYP. TYPICAL
- 3. P.D.C. PROTECT DURING CONSTRUCTION
- 4. SF SQUARE FEET

		1000001	20
	Α	initial town submittal	07/07/17
	В	TOWN RESUBMITTAL	03/06/19
	\cup	ZBA	03/19/19
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		Revisions:	Date:
	1	UPDATED BUILDING FOOTPRINT	03/05/19
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|2| Per Developers restriping Layout |03/19/1|

Issued:

Graphic Scale: 1"=30'

EDGE OF PAVEMENT/BACK OF

AS REQUIRED BY NEW YORK STATE LAW,

CONTRACTOR SHALL CONTACT "DIG SAFELY NEW YORK" (UFPO) @ 1-800-962-7962 FOR LOCATION

STAKE-OUT OF ALL UTILITIES, AT LEAST 2 FULL WORKING DAYS PRIOR TO ANY EXCAVATION.

LEGEND OF EXISTING FEATURES

LEGEND OF IMPROVEMENTS

— — SETBACK LINE

& LAND SURVEYING, P.C.

REFER TO THE SURVEY PREPARED BY RAVI ENGINEERING


SUBJECT PARCEL PROPERTY LINE

LIGHT POLES

PROPOSED BUILDING

CONCRETE SIDEWALK (REFER TO

PEDESTRIAN CROSSWALK (REFER

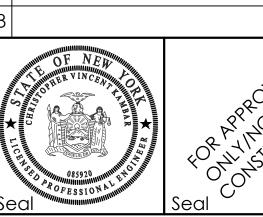

CIVIL ENGINEER OF RECORD Name: Christopher, V. Kambar New York License No.: 085920 Exp. Date.: October 31, 2019 Firm Reg. No.: 0008742

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Hospitality Syracuse, Inc. 290 Elwood Davis Road Suite 320 Liverpool, NY 13088

Taco Bell - Chili, NY

3240 Chili Ave

City of Rochester

Monroe County, NY

Project Name & Location:

Site	Plan

Drawing Name: Project No. Date: 07/07/17 16-0166 LG50 Type:

Drawn By: JWD

Scale: 1" = 30' Drawing No.

LOCATIONS AND DIMENSIONS OF VESTIBULE, SLOPED PAVING, EXIT PORCHES, RAMPS, PRECISE BUILDING DIMENSIONS, AND EXACT BUILDING UTILITY ENTRANCE LOCATIONS. ALL PAVING, CURBING, FLATWORK, SIDEWALKS, FENCING, BOLLARDS, ETC., WHICH CONFLICT WITH NEW CONSTRUCTION ARE TO BE DEMOLISHED AND DISPOSED OF IN ACCORDANCE WITH ANY LOCAL, STATE, OR FEDERAL

RECENT STANDARDS AND SPECIFICATIONS OF THE TOWN OF CHILI

AND/OR THE APPROPRIATE WATER, SEWER AND/OR DRAINAGE

2. ALL EXISTING BUILDING(S), SITE, ROADWAY, UTILITY, BOUNDARY, AND

TOPOGRAPHY INFORMATION SHOWN ON THIS PLAN IS REPRESENTED

BASED ON USE OF THE LISTED REFERENCES. CONTRACTOR TO VERIFY

THE OWNER AND ENGINEER. IF CONTRACTOR DOES NOT ACCEPT

SURVEY BY A REGISTERED LAND SURVEYOR AND SUBMIT IT TO THE

CONTRACTOR SHALL REFER TO ARCHITECTURAL PLANS FOR EXACT

EXISTING TOPOGRAPHY AS SHOWN ON THE PLANS, WITHOUT

OWNER FOR REVIEW.

LOCATION AND LIMITS OF WORK PRIOR TO STARTING. ANY CHANGES

EXCEPTION, HE SHALL HAVE MADE, AT HIS EXPENSE, A TOPOGRAPHIC

OR CONFLICTS DISCOVERED SHALL BE BROUGHT TO THE ATTENTION OF

DISTRICTS, AND/OR OTHER AUTHORITIES HAVING JURISDICTION.

REGULATIONS.

BARRICADES, ENCLOSURES, ETC. CONTRACTOR SHALL MAINTAIN ALL EXISTING PARKING, SIDEWALKS, DRIVES, ETC. OUTSIDE OF WORK LIMITS CLEAR AND FREE FROM ANY CONSTRUCTION ACTIVITY AND/OR MATERIAL TO ENSURE EASY AND SAFE PEDESTRIAN AND VEHICULAR TRAFFIC TO AND FROM THE SITE.


5. APD ENGINEERING AND ARCHITECTURE, PLLC (APD) IS ONLY RESPONSIBLE FOR THE PROPOSED SITE IMPROVEMENTS RELATED TO THIS BUILDING CONSTRUCTION, AS SHOWN ON THE PLANS. APD DID NOT PERFORM THE ORIGINAL SITE DESIGN OR SURVEY AND ACCEPTS NO RESPONSIBILITY FOR EXISTING SITE CONDITIONS OR FEATURES THAT WERE DESIGNED AND BUILT PREVIOUS TO THE PREPARATION OF THESE PLANS. CONTRACTOR SHALL REVIEW EXISTING SITE FEATURES PRIOR TO PREPARATION OF BID.

6. ANY EXISTING STRIPING WHICH IS TO REMAIN IN PLACE AND WHICH MAY BECOME OBSCURED OR DAMAGED DUE TO THE CONSTRUCTION OF IMPROVEMENTS SHALL BE REPLACED AND/OR REPAINTED AS NECESSARY.

REFER TO THE SURVEY FOR THE PROPERTY BOUNDARY INFORMATION (E.G. LOT AREA, BEARINGS, DISTANCES, ETC).


500-YEAR FLOODPLAIN, AS SHOWN ON FLOOD STUDY INSURANCE MAP OF TOWN OF CHILI PUBLISHED BY FEDERAL EMERGENCY MANAGEMENT AGENCY, COMMUNITY PANEL NO. 307, MAP EFFECTIVE DATE 08/28/08.

9. DUE TO PREVIOUS DEVELOPMENT ON-SITE AND MINIMAL PRESENT.

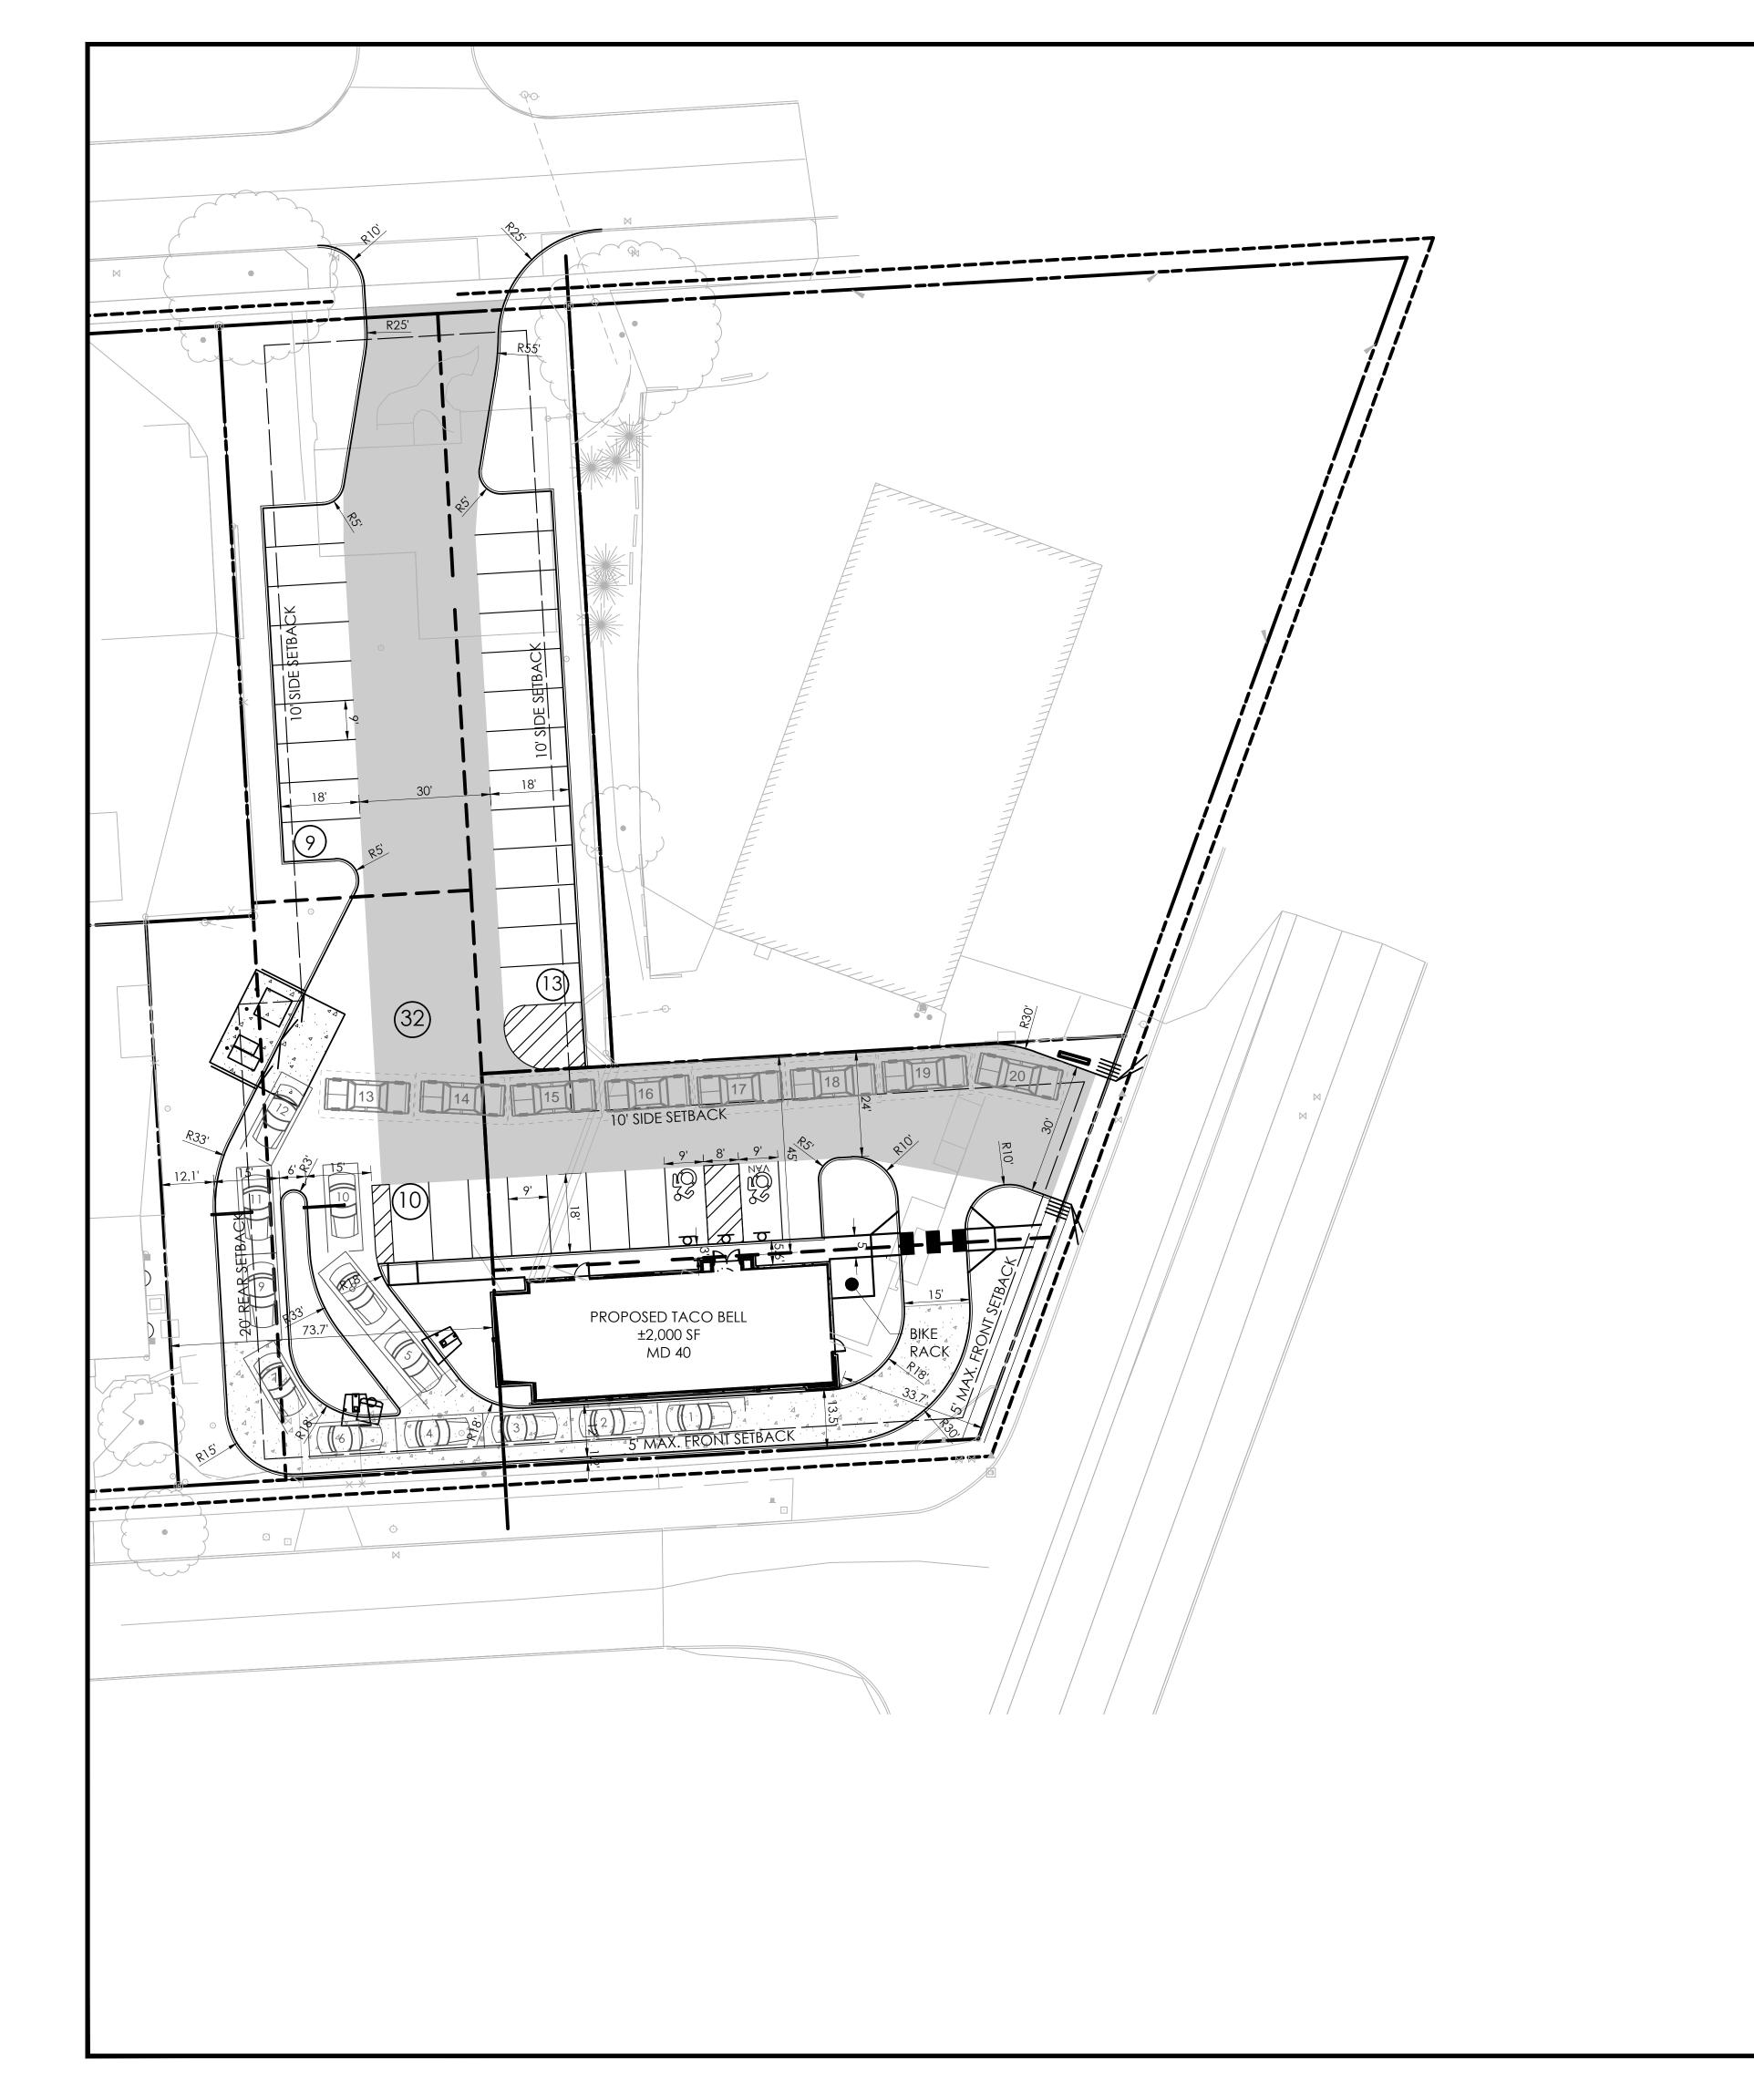

REFERENCE:

- 1. PICTOMETRY AERIAL IMAGERY 2. ALTA/NSPS LAND TITLE SURVEY
 - LANDS OF 1737 MT HOPE AVE AND 35 SHELBOURNE RD, PROJECT NUMBER 2021.045.001, PREPARED BY JACOBS LAND SURVEYING, LAST REVISED JUNE 8, 2021.

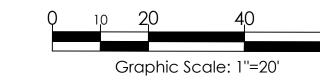


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LEGEND OF IMPROVEMENTS

BACK OF CURB FACE OF CURB/BACK OF CURB SUBJECT PARCEL PROPERTY LINE — — SETBACK LINE PROPOSED BUILDING TRANSFORMER PAD

CONCRETE SIDEWALK (REFER TO HEAVY DUTY PAVEMENT (REFER TO DETAIL)

BUILDING EXPANSION AREA

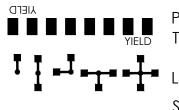

PEDESTRIAN CROSSWALK (REFER TO DETAIL)

SITE SIGN, PAINTED STOP BAR & "STOP" LETTERING

Revisions: Date: CIVIL ENGINEER OF RECORD Name: Christopher, V. Kambar New York License No.: 085920 Exp. Date: October 31, 2022 Firm Reg. No.: 0014815

Issued:

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Exp. Date: December 31, 2023

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Hospitality Syracuse, Inc.

290 Elwood Davis Road Suite 320 Liverpool, NY 13088

Taco Bell - Rochester NY

Mt. Hope and Elmerston Rd City of Rochester Monroe County Project Name & Location:

Site Plan

Drawing Name:


Project No. Date: 06/10/20 20-0531 Type: MD40


Drawn By: SLA Drawing No.

SITE DATA:

LOCAL JURISDICTION:	City of Rochester
ZONING CLASSIFICATION:	C-2 Community Center District
PERMITTED USES:	Restaurants, without drive thru
Special permitted uses:	Drive Thrus
CURRENT OWNER:	1737 Mt Hope Avenue Realty
	Corporation and 35 Shelbourne,
	LLC
FUTURE OWNER:	Fairlane Drive
PROPERTY ACREAGE:	± 0.76 Ac (Lot consolidation req'd)

BULK REQUIREMENTS	REQUIRED	EXISTING	PROPOSED	Variance Required
MAX. FRONT YARD	5 FT	25 FT (MT HOPE), 22.7 FT (ELMERSTON)	33.7 FT (MT HOPE), 13.5' ELMERSTON	YES
REAR YARD (WEST) (PER R-1 DISTRICT)	20 FT	87 FT	73.7 FT	NO
SIDE YARD (NORTH) (PER R-1 DISTRICT)	10' MIN. WITH A COMBINED WIDTH OF 25 FT.	0 FT	45 FT	NO
MAXIMUM BUILDING AREA	6,000 SF	33,103 SF	XX SF N	
MINIMUM BUILDING HEIGHT	20 FT	11.1 FT (MIN.)	23 FT	NO
DRIVE THRU LOCATION	PROHIBITED IN THE FRONT YARD	N/A	FRONT YARD	YES
DRIVE THRU SCREENING	DRIVE THRU AND QUEUING LANES SHALL BE SCREENED FROM RESIDENTIAL PROPERTIES.	N/A		
MINIMUM PARKING REQUIREMENT	6 PER 1,000 SF OF NET FLOOR AREA	37 SPACES	32 SPACES	NO
MAXIMUM PARKING REQUIREMENT	110% OF MINIMUM PARKING. PARKING ANALYSIS PLAN AND SPECIAL PERMIT REQUIRED TO EXCEED MAXIMUM.	37 SPACES	32 SPACES	YES
BICYCLE PARKING	10% OF THE VEHICLE PARKING REQUIREMENTS, WITH A MINIMUM OF 2 BICYCLES	0	2	NO

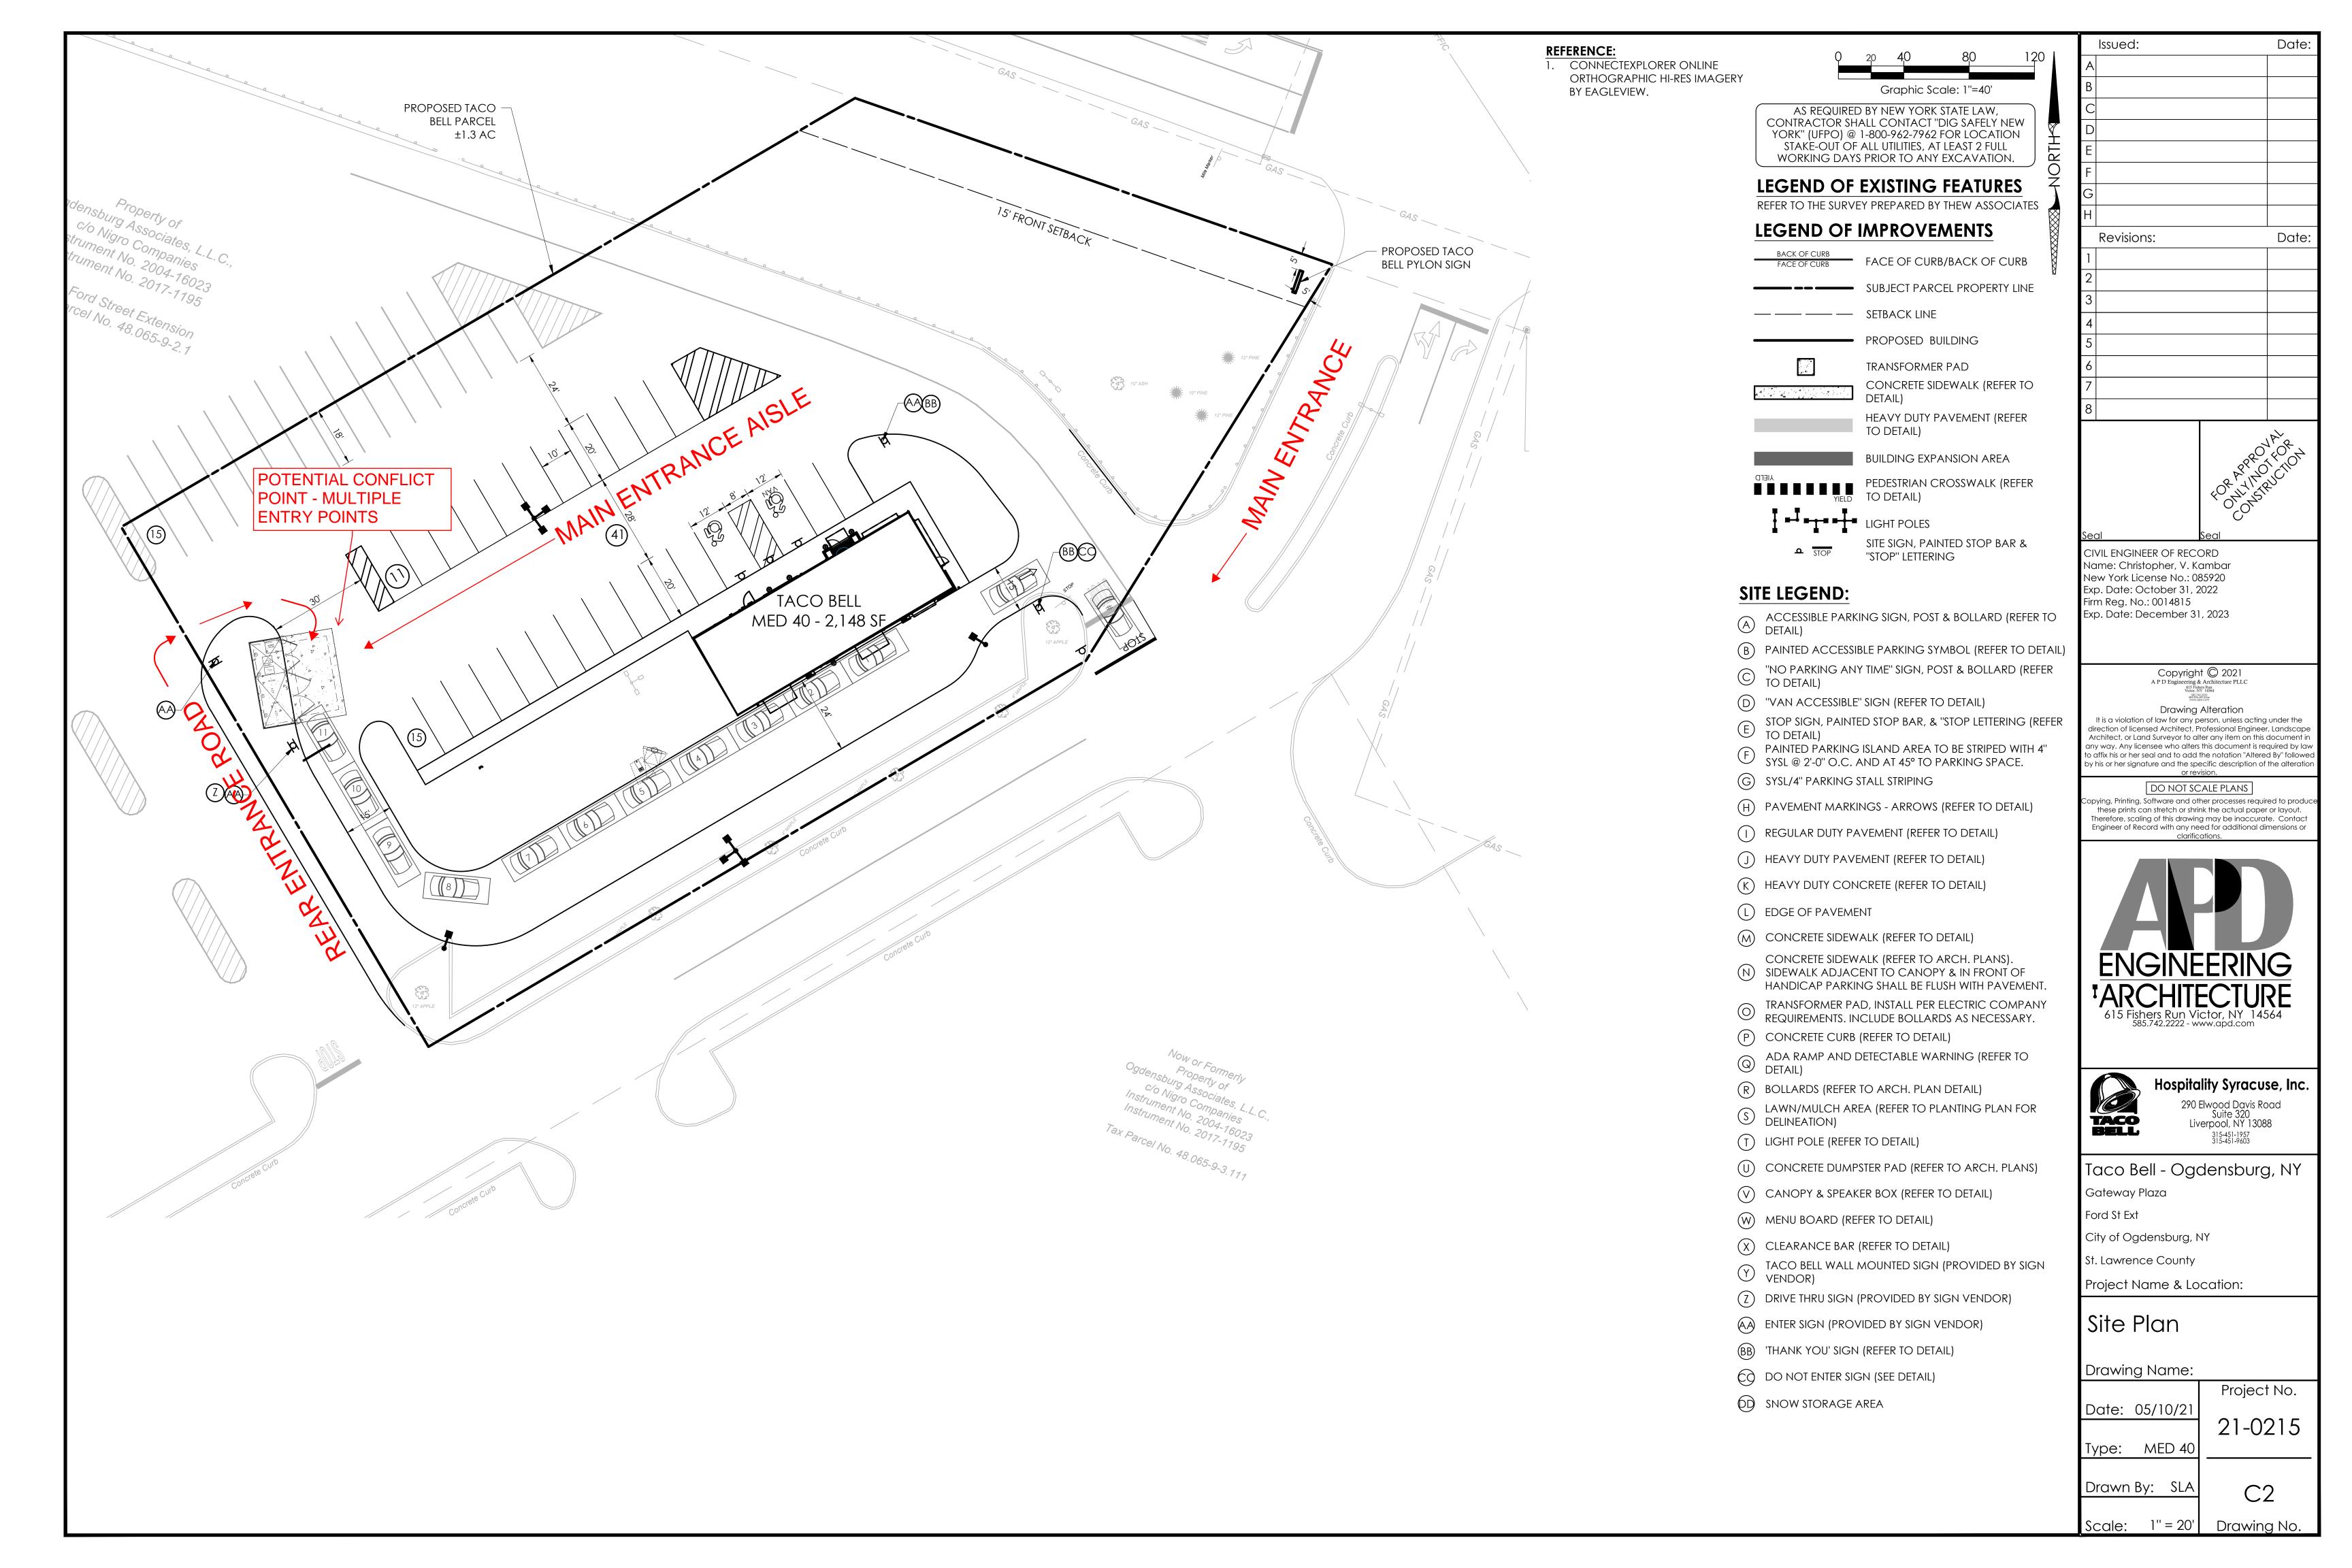

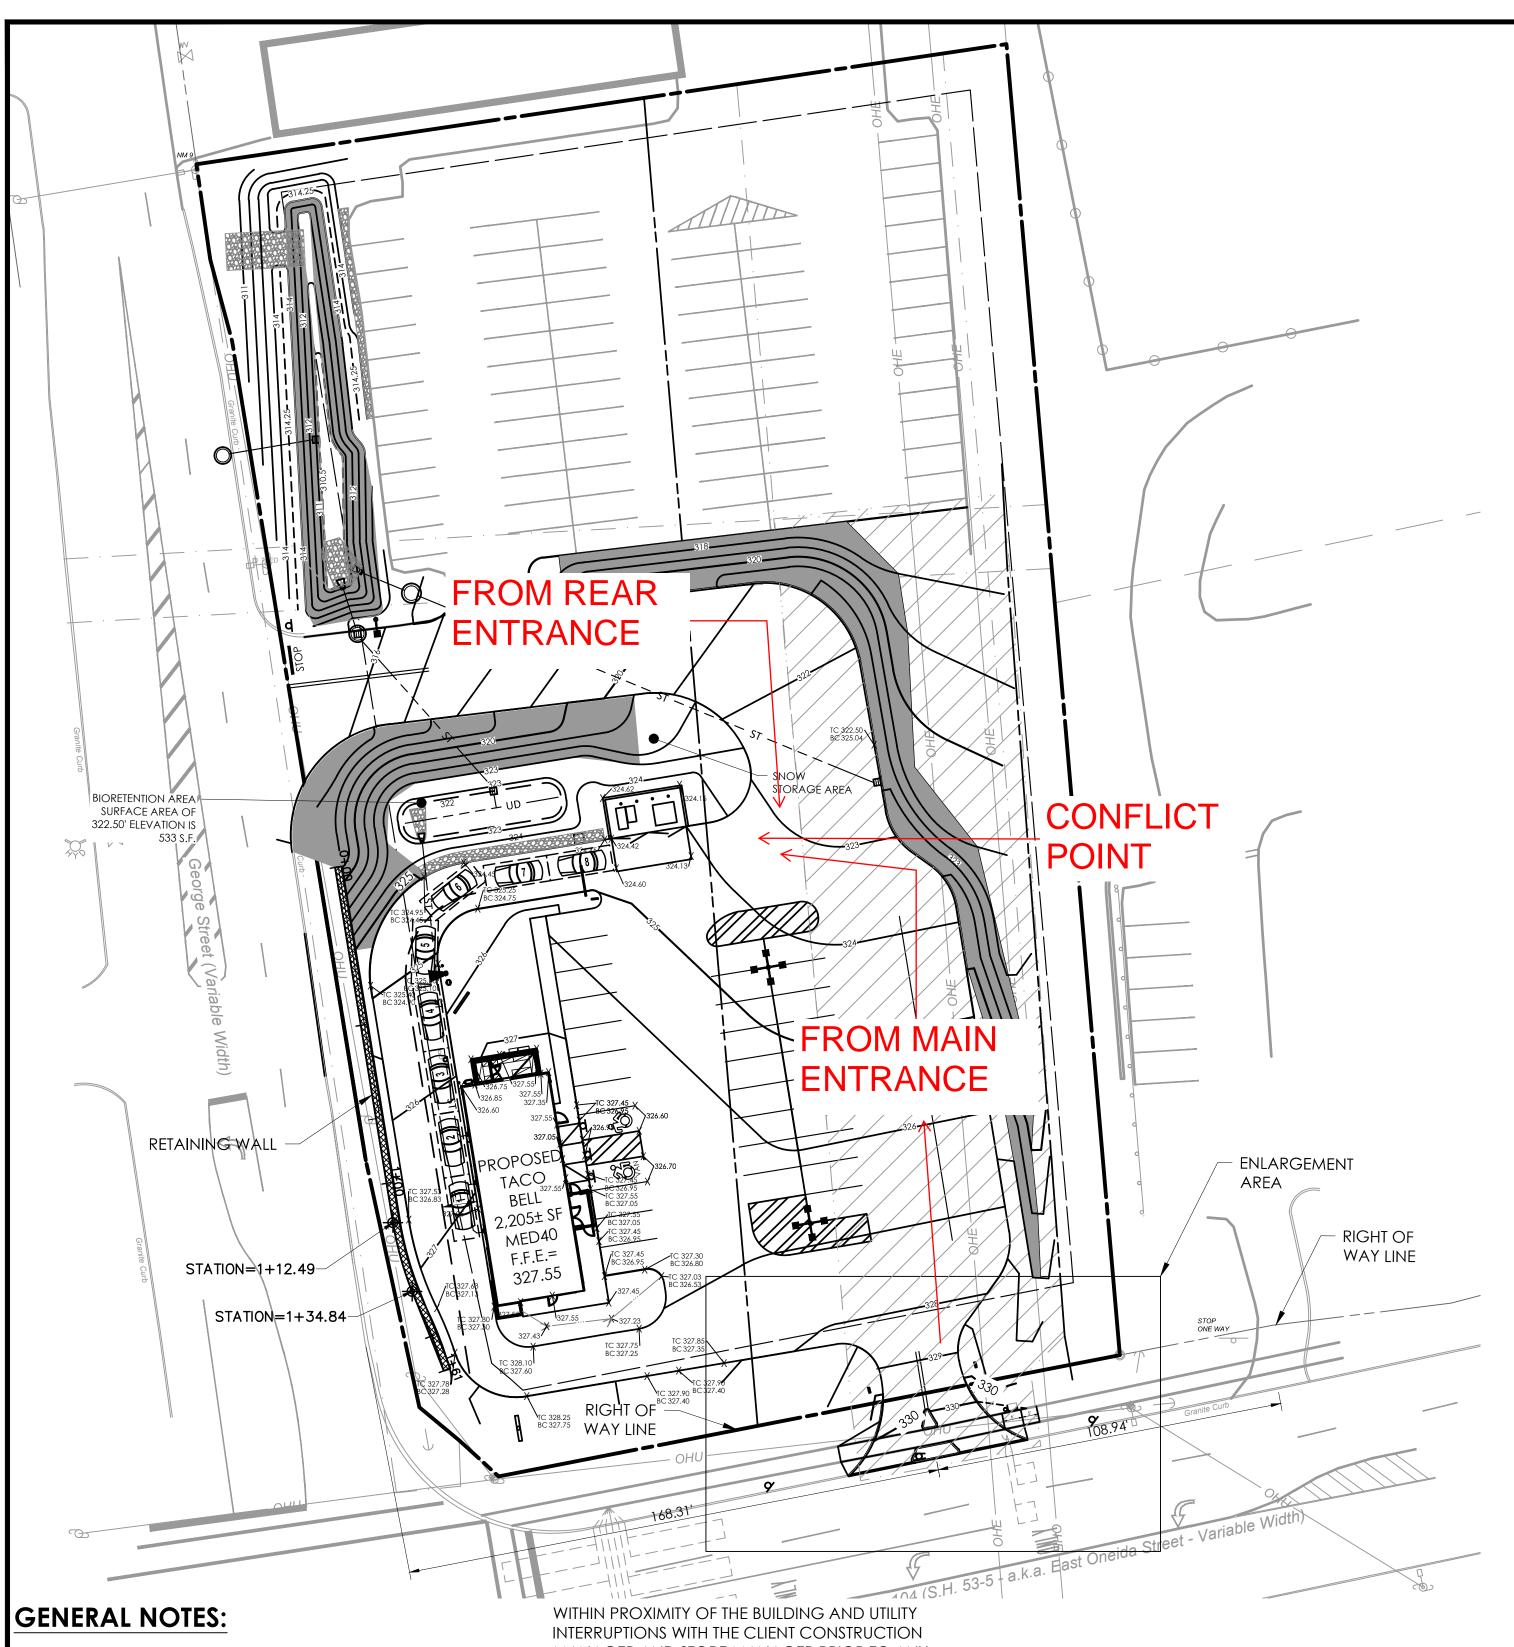

- ALL IMPROVEMENTS SHALL BE IN ACCORDANCE WITH THE MOST RECENT STANDARDS AND SPECIFICATIONS OF THE NEW YOUR STATE DEPARTMENT OF TRANSPORTATION AND/OR THE APPROPRIATE WATER, SEWER AND/OR DRAINAGE DISTRICTS, AND/OR OTHER AUTHORITIES HAVING JURISDICTION.
- ALL EXISTING BUILDING(S), SITE, ROADWAY, UTILITY, BOUNDARY, AND TOPOGRAPHY INFORMATION SHOWN ON THIS PLAN IS REPRESENTED BASED ON USE OF THE LISTED REFERENCES. CONTRACTOR TO VERIFY LOCATION AND LIMITS OF WORK PRIOR TO STARTING. ANY CHANGES OR CONFLICTS DISCOVERED SHALL BE BROUGHT TO THE ATTENTION OF THE OWNER AND ENGINEER. IF CONTRACTOR DOES NOT ACCEPT EXISTING TOPOGRAPHY AS SHOWN ON THE PLANS, WITHOUT EXCEPTION, HE SHALL HAVE MADE, AT HIS EXPENSE, A TOPOGRAPHIC SURVEY BY A REGISTERED LAND SURVEYOR AND SUBMIT IT TO THE OWNER FOR REVIEW.
- CONTRACTOR MUST PROTECT THE PUBLIC AT ALL TIMES WITH FENCING, BARRICADES, ENCLOSURES, ETC. CONTRACTOR SHALL MAINTAIN ALL EXISTING PARKING, SIDEWALKS, DRIVES, ETC. OUTSIDE OF WORK LIMITS CLEAR AND FREE FROM ANY CONSTRUCTION ACTIVITY AND/OR MATERIAL TO ENSURE EASY AND SAFE PEDESTRIAN AND VEHICULAR TRAFFIC TO AND FROM THE SITE. CONTRACTOR SHALL COORDINATE/PHASE ALL CONSTRUCTION ACTIVITY

MANAGER AND STORE MANAGER PRIOR TO ANY CONSTRUCTION TO ESTABLISH CUSTOMER ACCESS AND TRAFFIC FLOW DURING ALL PHASES OF WORK TO MINIMIZE DISTURBANCE AND INCONVENIENCE.

ANY EXISTING STRIPING WHICH IS TO REMAIN IN PLACE AND WHICH MAY BECOME OBSCURED OR DAMAGED DUE TO THE CONSTRUCTION OF IMPROVEMENTS SHALL BE REPLACED AND/OR REPAINTED AS NECESSARY.

REFER TO THE SURVEY FOR THE PROPERTY BOUNDARY INFORMATION (E.G. LOT AREA, BEARINGS, DISTANCES, ETC).

THE SITE IS IN FLOOD ZONE X, AREAS DETERMINED TO BE OUTSIDE 500-YEAR FLOODPLAIN, AS SHOWN ON FLOOD STUDY INSURANCE MAP OF OSWEGO COUNTY PUBLISHED BY FEDERAL EMERGENCY MANAGEMENT AGENCY, COMMUNITY PANEL NO. 0278, MAP EFFECTIVE DATE 06/18/13.

DUE TO PREVIOUS DEVELOPMENT ON-SITE AND MINIMAL PERVIOUS/LAWN AREAS; WETLANDS ARE NOT EXPECTED TO BE PRESENT.

ABBREVIATIONS:

- 1. DYSL/4" DOUBLE YELLOW SOLID LINE / 4" WIDE EACH
- 2. TYP. TYPICAL
- 3. P.D.C. PROTECT DURING CONSTRUCTION
- 4. SF SQUARE FEET

SITE NOTES:

REFERENCE: SURVEY PREPARED BY THEW ASSOCIATES LAND SURVEYORS, LAST UPDATED 04/23/18

- 1. ALL NEW PAINTED PAVEMENT MARKINGS SUCH AS DIRECTIONAL ARROWS AND LETTERING SHALL BE PAINTED USING TEMPLATES. REPAINT (TWO COATS) EXISTING DIRECTIONAL ARROWS, STOP BARS, AND OTHER PAVEMENT MARKINGS ON ENTIRE SITE TO MATCH EXISTING.
- 2. ALL WORK SHALL BE COORDINATED WITH THE CLIENT CONSTRUCTION MANAGER AND STORE MANAGER 48 HOURS IN ADVANCE, AND VEHICULAR, TRUCK AND PEDESTRIAN ACCESS TO THE STORE SHALL BE MAINTAINED AT ALL TIMES.
- 3. CONTRACTOR SHALL PROVIDE TOUCH-UP PAINT FOR ALL FIRE HYDRANTS, BOLLARDS, LIGHT POLE BASES, VALVE COVERS, AND CURBS WHICH ARE CURRENTLY PAINTED WITHIN THE PROJECT LIMITS. CONTRACTOR SHALL REVIEW EXISTING SITE FEATURES PRIOR TO PREPARATION OF BID. COST SHALL BE INCLUDED IN THE BASE BID.
- 4. ALL DIMENSIONS AND RADII ARE TO THE FACE OF CURB UNLESS OTHERWISE NOTED.
- 5. THE SETBACK LINES AND NOTES RELATED TO SETBACKS SHOWN HEREIN ARE INTENDED TO SHOW APPLICABLE ZONING REQUIREMENTS OF THE CITY OF OSWEGO AS OF THE DATE OF THIS PLAN AND ARE NOT INTENDED TO IMPOSE ANY ADDITIONAL RESTRICTIONS OTHER THAN SAID ZONING REQUIREMENTS.
- CONTRACTOR IS RESPONSIBLE FOR ANY/ALL DAMAGE TO NYSDOT SIGNAL EQUIPMENT. ANY DAMAGE WILL REQUIRE THE REPLACE OF EQUIPMENT TO NYSDOT SPECIFICATIONS, INCLUDING NO SPLICING OF LOOP WIRES OUTSIDE THE PULL BOX. RESET OR RELOCATE THE TRAFFIC MANHOLE AS NEEDED.
- CONTRACTOR SHALL RESTORE ANY DAMAGED STRIPING ON THE DOT RIGHT OF WAY IN ACCORDANCE WITH NYSDOT STANDARDS AND SPECIFICATIONS.
- EXISTING CATCHBASIN TO BE PROTECTED DURING CONSTRUCTION. CONTRACTOR IS RESPONSIBLE FOR ANY/ALL DAMAGES TO THE STORMDRAIN APPURTENANCES. ANY DAMAGED ITEMS SHALL BE REPAIRED OR REPLACED IN KIND TO NYSDOT STANDARDS AND SPECIFICATIONS.
- CONTRACTOR SHALL ENSURE CONCRETE SIDEWALK (INCLUDE WALKWAY ACROSS DRIVE AISLE) MEETS ALL ADA CRITERIA. THIS SHALL INCLUDE, BUT IS NOT LIMITED TO, A MAXIMUM OF 2% CROSS-SLOPE, 5% SLOPE IN THE DIRECTION OF TRAVEL FOR A WALKWAY, AND 8.33% LONGITUDINAL SLOPE FOR A RAMP.

OF SURFACE

TC 330.83±/ BC 330.24±/

DRAINAGE

AS REQUIRED BY NEW YORK STATE LAW, CONTRACTOR SHALL CONTACT "DIG SAFELY NEW YORK" (UFPO) @ 1-800-962-7962 FOR LOCATION STAKE-OUT OF ALL UTILITIES, AT LEAST 2 FULL WORKING DAYS PRIOR TO ANY EXCAVATION.



LEGEND OF EXISTING FEATURES REFER TO THE SURVEY PREPARED BY THEW ASSOCIATES

LEGEND OF IMPROVEMENTS EDGE OF DAVIENTIDACE OF BACK OF CLIDS

FACE OF CURB	CURB
	SUBJECT PARCEL PROPERTY LINE
	SETBACK LINE
	PROPOSED BUILDING CONCRETE SIDEWALK (REFER TO DETAIL)
	ASPHALT PAVEMENT SECTION

(REFER TO DETAIL) LIGHT POLES

WAYTINE LIMITS OF EXISTING CONCRETE 3SIDEWALK REMOVAL. ADJUST LIMITS AS NECESSARY TO ENSURE A MINIMUM 2% SLOPE FOR THE FIRST 5' AT THE TOP OF THE RAMP CURB TRANSITION, TC 331.06±(EX) BC 330.58±(EX) FROM 6" TO 0" REVEAL LIMITS OF EXISTING CONCRETE CURB REMOVAL

NEW YORK STATE ROUTE 104

SEE SITE NOTE 9.

SEE SITE NOTE 6.

SEE SITE NOTE 8.

: 40

ENLARGEMENT: WORK WITHIN NYS DOT ROW

SCALE: 1" = 10'

NYS DOT SITE LEGEND:

SEE SITE NOTE 6.

CURB TRANSITION,

FROM 6" TO 0" REVEAL

LIMITS OF EXISTING

REMOVAL

CONCRETE SIDEWALK

CURB TRANSITION

REMOVAL

FROM 6" TO 0" REVEAL

LIMITS OF EXISTING CONCRETE CURB


> 6" REVEAL STONE CURB, GRANITE TYPE A (ITEM 609.0201) OR MATCH EXISTING (REFER TO DETAIL)

"DO NOT ENTER"/"NO

LEFT TURN SIGN

- (B) 1" REVEAL STONE CURB, GRANITE TYPE A (ITEM 609.0201)
- SIDEWALK RAMP (REFER TO NYSDOT STANDARD DETAIL
- 5' WIDE, 6" CONCRETE SIDEWALK (ITEM 608.0101) (REFER TO NYSDOT STANDARD DETAIL 608-03)
- (E) 6" CONCRETE DRIVEWAY APRON (ITEM 608.01101015)
- CURBED RAISED CONCRETE ISLAND, 6" CURB REVEAL, 4" PCC CAP. (REFER TO NYSDOT STANDARD DETAIL 608-01)
- EXISTING POWER TOWER TO BE PROTECTED DURING CONSTRUCTION. CONTRACTOR SHALL COORDINATE WITH TOWER OWNER BEFORE CONSTRUCTION BEGINS.
- BOLLARD (REFER TO DETAIL), CONTRACTOR SHALL (H) COORDINATE WITH TOWER OWNER PRIOR TO INSTALLATION
- REMOVE AND REUSE EXISTING NO PARKING ANY TIME SIGN AND POLE
- (K) LAWN

(J) NO PARKING ANY TIME SIGN

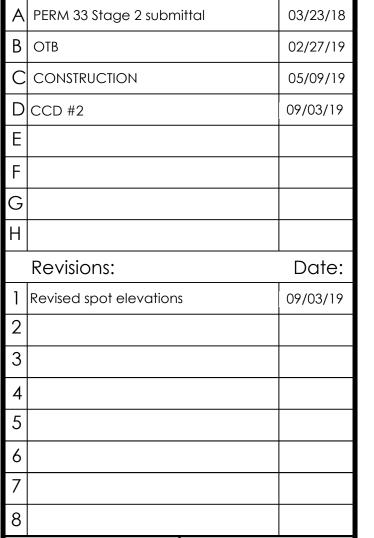



New York License No.: 085920


Exp. Date.: October 31, 2019 Firm Reg. No.: 0008742

CIVIL ENGINEER OF RECORD Name: Christopher, V. Kambar

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> 615 Fishers Run Victor, NY 14564 585.742.2222 585.924.4914.fax

> > www.apd.com

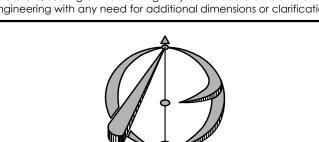

290 Elwood Davis Road Suite 320 Liverpool, NY 13088

Taco Bell - Oswego, NY

Highway Improvement Plans

151 George Street

City of Oswego Oswego County, NY


Project Name & Location:

Highway Site Plan

Drawing Name: Project No. Date: 03/09/18 16-0528 Final Type:

Drawn By: SPA HSP Scale: 1" = 30'

Drawing No.

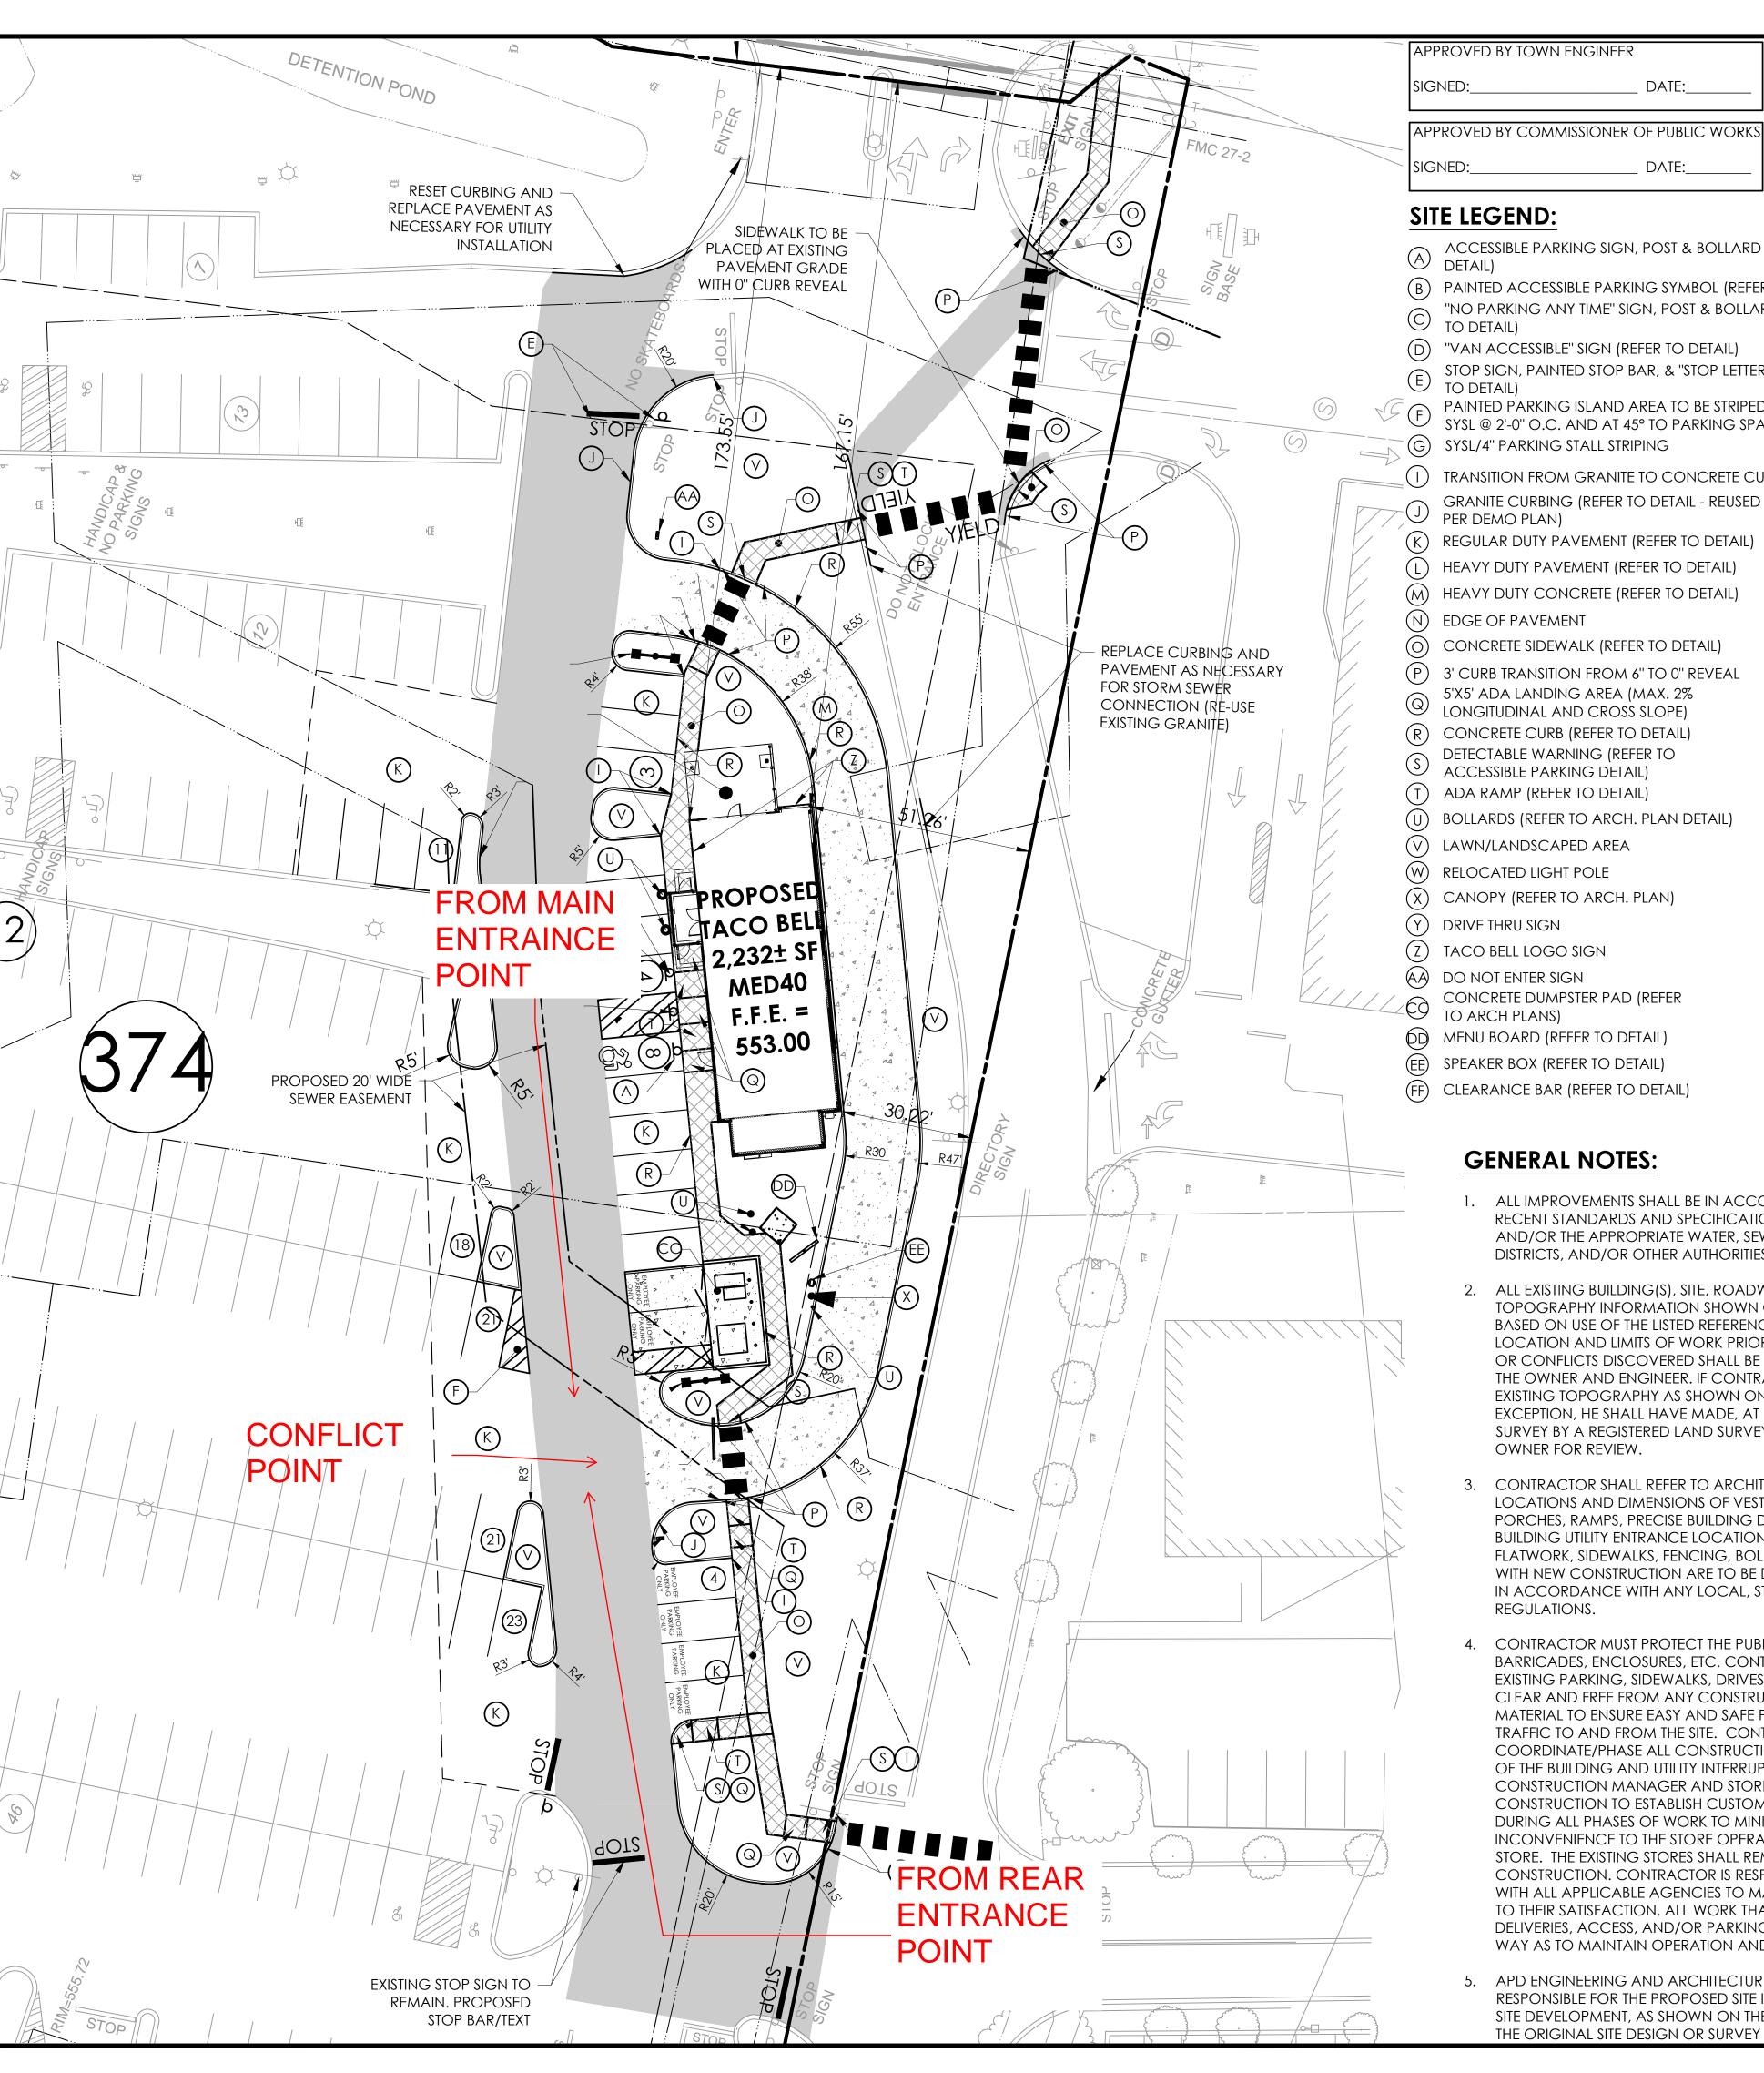

APPROVED BY TOWN ENGINEER APPROVED BY COMMISSIONER OF PUBLIC WORKS

- ACCESSIBLE PARKING SIGN, POST & BOLLARD (REFER TO
- (B) PAINTED ACCESSIBLE PARKING SYMBOL (REFER TO DETAIL) "NO PARKING ANY TIME" SIGN, POST & BOLLARD (REFER
- (D) "VAN ACCESSIBLE" SIGN (REFER TO DETAIL)
 - STOP SIGN, PAINTED STOP BAR, & "STOP LETTERING (REFER
- PAINTED PARKING ISLAND AREA TO BE STRIPED WITH 4" SYSL @ 2'-0" O.C. AND AT 45° TO PARKING SPACE G(G) SYSL/4" PARKING STALL STRIPING
- TRANSITION FROM GRANITE TO CONCRETE CURB
- PER DEMO PLAN)
- (K) REGULAR DUTY PAVEMENT (REFER TO DETAIL)
- HEAVY DUTY PAVEMENT (REFER TO DETAIL)
- HEAVY DUTY CONCRETE (REFER TO DETAIL)
- EDGE OF PAVEMENT
- CONCRETE SIDEWALK (REFER TO DETAIL)
- (P) 3' CURB TRANSITION FROM 6" TO 0" REVEAL
- 5'X5' ADA LANDING AREA (MAX. 2% LONGITUDINAL AND CROSS SLOPE)
- (R) CONCRETE CURB (REFER TO DETAIL) DETECTABLE WARNING (REFER TO
- ACCESSIBLE PARKING DETAIL)
- BOLLARDS (REFER TO ARCH. PLAN DETAIL)
- (V) LAWN/LANDSCAPED AREA
- (W) RELOCATED LIGHT POLE
- CANOPY (REFER TO ARCH. PLAN)

- CONCRETE DUMPSTER PAD (REFER
- (EE) SPEAKER BOX (REFER TO DETAIL)

GENERAL NOTES:

- ALL IMPROVEMENTS SHALL BE IN ACCORDANCE WITH THE MOST RECENT STANDARDS AND SPECIFICATIONS OF THE TOWN OF PERINTON AND/OR THE APPROPRIATE WATER, SEWER AND/OR DRAINAGE DISTRICTS, AND/OR OTHER AUTHORITIES HAVING JURISDICTION.
- 2. ALL EXISTING BUILDING(S), SITE, ROADWAY, UTILITY, BOUNDARY, AND TOPOGRAPHY INFORMATION SHOWN ON THIS PLAN IS REPRESENTED BASED ON USE OF THE LISTED REFERENCES. CONTRACTOR TO VERIFY LOCATION AND LIMITS OF WORK PRIOR TO STARTING. ANY CHANGES OR CONFLICTS DISCOVERED SHALL BE BROUGHT TO THE ATTENTION OF THE OWNER AND ENGINEER. IF CONTRACTOR DOES NOT ACCEPT EXISTING TOPOGRAPHY AS SHOWN ON THE PLANS, WITHOUT EXCEPTION, HE SHALL HAVE MADE, AT HIS EXPENSE, A TOPOGRAPHIC SURVEY BY A REGISTERED LAND SURVEYOR AND SUBMIT IT TO THE OWNER FOR REVIEW.
- B. CONTRACTOR SHALL REFER TO ARCHITECTURAL PLANS FOR EXACT LOCATIONS AND DIMENSIONS OF VESTIBULE, SLOPED PAVING, EXIT PORCHES, RAMPS, PRECISE BUILDING DIMENSIONS, AND EXACT BUILDING UTILITY ENTRANCE LOCATIONS. ALL PAVING, CURBING, FLATWORK, SIDEWALKS, FENCING, BOLLARDS, ETC., WHICH CONFLICT WITH NEW CONSTRUCTION ARE TO BE DEMOLISHED AND DISPOSED OF IN ACCORDANCE WITH ANY LOCAL, STATE, OR FEDERAL REGULATIONS.
- 4. CONTRACTOR MUST PROTECT THE PUBLIC AT ALL TIMES WITH FENCING, BARRICADES, ENCLOSURES, ETC. CONTRACTOR SHALL MAINTAIN ALL EXISTING PARKING, SIDEWALKS, DRIVES, ETC. OUTSIDE OF WORK LIMITS CLEAR AND FREE FROM ANY CONSTRUCTION ACTIVITY AND/OR MATERIAL TO ENSURE EASY AND SAFE PEDESTRIAN AND VEHICULAR TRAFFIC TO AND FROM THE SITE. CONTRACTOR SHALL COORDINATE/PHASE ALL CONSTRUCTION ACTIVITY WITHIN PROXIMITY OF THE BUILDING AND UTILITY INTERRUPTIONS WITH THE CLIENT CONSTRUCTION MANAGER AND STORE MANAGER PRIOR TO ANY CONSTRUCTION TO ESTABLISH CUSTOMER ACCESS AND TRAFFIC FLOW DURING ALL PHASES OF WORK TO MINIMIZE DISTURBANCE AND INCONVENIENCE TO THE STORE OPERATION AND THE CUSTOMERS OF STORE. THE EXISTING STORES SHALL REMAIN IN OPERATION DURING CONSTRUCTION. CONTRACTOR IS RESPONSIBLE FOR COORDINATING WITH ALL APPLICABLE AGENCIES TO MAINTAIN EMERGENCY ACCESS TO THEIR SATISFACTION. ALL WORK THAT WILL IMPACT TRUCK DELIVERIES, ACCESS, AND/OR PARKING SHALL BE PHASED IN SUCH A WAY AS TO MAINTAIN OPERATION AND ACCESS TO THE STORE.
- 5. APD ENGINEERING AND ARCHITECTURE, PLLC (APD) IS ONLY RESPONSIBLE FOR THE PROPOSED SITE IMPROVEMENTS RELATED TO THIS SITE DEVELOPMENT, AS SHOWN ON THE PLANS. APD DID NOT PERFORM THE ORIGINAL SITE DESIGN OR SURVEY AND ACCEPTS NO

ABBREVIATIONS:

SYSL/4" - SINGLE YELLOW SOLID LINE / 4" WIDE EACH

TOWN OF PERINTON

REFERENCE:

EXISTING FEATURES PLAN, VI-100, LAST

REVISED ON 3/8/18, PREPARED BY

COSTICH ENGINEERING

DATE:

DATE:_

DATE:

- 2. TYP. TYPICAL P.D.C. - PROTECT DURING CONSTRUCTION
- 4. SF SQUARE FEET

*GREENSPACE WAIVER PER 3/7/12 PB MEETING

APPROVED BY TOWN ATTORNEY

APPROVED BY FIRE CHIEF

APPROVED BY PLANNING BOARD CHAIRMAN

SIGNED:

SIGNED:

SITE DATA

LOCAL JURISDICTION:

ZONING CLASSIFICATION:	CO (COMMERCIAL)			
PERMITTED USES:	RESTAURANTS			
BULK REQUIREMENTS	REQUIRED	EXISTING	PROPOSED	Variance Required
FRONT YARD	85 FT	122.5'±	122.5' FT	No
REAR YARD	30 FT	186.4'±	186.4'± FT	No
SIDE YARD	30 FT	61.5'±	30.82 FT	No
MINIMUM LOT AREA	40,000 SQ FT	394,653.6 SQ FT	394,653.6 SQ FT	No
MINIMUM LOT WIDTH	200 FT	N/A	N/A	No
MAXIMUM SITE/BUILDING	30%	18% ±	19%±	No
MINIMUM GREENSPACE AREA	MIN 35% OF THE PARCEL	25.6%	25.4%	No*
PARKING REQUIREMENT	1 SPACE PER 225 GROSS LEASABLE FLOOR AREA: 73,317± SF / 225 = 325.85 = 326 SPACES	411 SPACES	374 SPACES	No
ADA PARKING	SHALL BE PROVIDED IN A LOCATION AND NUMBER IN ACCORDANCE WITH THE NEW YORK STATE UNIFORM FIRE PREVENTION AND BUILDING CODE. PARKING LOTS 374*.02=7.48 ADA SPACES	25 SPACES	27 SPACES	No
PARKING STALL WIDTH	9 FT	9 FT	9 FT	No
PARKING STALL LENGTH	18 FT	18 FT	18 FT	No
AISLE WIDTH	24 FT	VARIES (24' MIN.)	24 FT (MIN.)	No

RESPONSIBILITY FOR EXISTING SITE CONDITIONS OR FEATURES THAT WERE DESIGNED AND BUILT PREVIOUS TO THE PREPARATION OF THESE PLANS. CONTRACTOR SHALL REVIEW EXISTING SITE FEATURES PRIOR TO

6. ANY EXISTING STRIPING WHICH IS TO REMAIN IN PLACE AND WHICH MAY BECOME OBSCURED OR DAMAGED DUE TO THE CONSTRUCTION OF IMPROVEMENTS SHALL BE REPLACED AND/OR REPAINTED AS NECESSARY.

- 7. REFER TO THE SURVEY FOR THE PROPERTY BOUNDARY INFORMATION (E.G. LOT AREA, BEARINGS, DISTANCES, ETC).
- 8. THE SITE IS IN FLOOD ZONE X, AREAS DETERMINED TO BE OUTSIDE 500-YEAR FLOODPLAIN, AS SHOWN ON FLOOD STUDY INSURANCE MAP OF TOWN OF PERINTON PUBLISHED BY FEDERAL EMERGENCY MANAGEMENT AGENCY, COMMUNITY PANEL NO. 0379, MAP EFFECTIVE DATE 8/28/08.
- 9. DUE TO PREVIOUS DEVELOPMENT ON-SITE AND MINIMAL PERVIOUS/LAWN AREAS; WETLANDS ARE NOT EXPECTED TO BE PRESENT.

SITE NOTES:

PREPARATION OF BID.

- 1. ALL NEW PAINTED PAVEMENT MARKINGS SUCH AS DIRECTIONAL ARROWS AND LETTERING SHALL BE PAINTED USING TEMPLATES. REPAINT (TWO COATS) EXISTING DIRECTIONAL ARROWS, STOP BARS, AND OTHER PAVEMENT MARKINGS ON ENTIRE SITE TO MATCH EXISTING.
- 2. ALL WORK SHALL BE COORDINATED WITH THE CLIENT CONSTRUCTION MANAGER AND STORE MANAGER 48 HOURS IN ADVANCE, AND VEHICULAR, TRUCK AND PEDESTRIAN ACCESS TO THE STORE SHALL BE MAINTAINED AT ALL TIMES.
- CONTRACTOR SHALL PROVIDE TOUCH-UP PAINT FOR ALL FIRE HYDRANTS, BOLLARDS, LIGHT POLE BASES, VALVE COVERS, AND CURBS WHICH ARE CURRENTLY PAINTED WITHIN THE PROJECT LIMITS. CONTRACTOR SHALL REVIEW EXISTING SITE FEATURES PRIOR TO PREPARATION OF BID. COST SHALL BE INCLUDED IN THE BASE BID.
- 4. ALL DIMENSIONS AND RADII ARE TO THE FACE OF CURB UNLESS OTHERWISE NOTED. ALL RADII ARE 5' UNLESS NOTED OTHERWISE.
- 5. THE SETBACK LINES AND NOTES RELATED TO SETBACKS SHOWN HEREIN ARE INTENDED TO SHOW APPLICABLE ZONING REQUIREMENTS OF THE TOWN OF PERINTON AS OF THE DATE OF THIS PLAN AND ARE NOT INTENDED TO IMPOSE ANY ADDITIONAL RESTRICTIONS OTHER THAN SAID ZONING REQUIREMENTS.

		133000.	Daic.
	Α	INITIAL PLANNING BOARD SUBMITTAL	03/16/18
	В	ISSUED FOR BID	06/04/18
	С	issued for construction	07/17/18
	D	issued for construction	9/6/18
NOKIH	Е	CCD #2	11/01/18
Š	F		
	G		
	Н		
		Revisions:	Date:
	1	PER TOWN COMMENTS	03/29/18
KI	2	PER INTERNAL QCQA REVIEW	05/17/18
	3	PER INTERNAL REVIEW	06/01/18
	4	REVISED XFRMR LOC. PER INSTALLED GREASE INTERCEPTOR LOCATION	11/01/18
	5		
	6		

Issued:

Graphic Scale: 1"=20'

EDGE OF PAVEMENT/BACK OF

AS REQUIRED BY NEW YORK STATE LAW, CONTRACTOR SHALL CONTACT "DIG SAFELY NEW

YORK" (UFPO) @ 1-800-962-7962 FOR LOCATION STAKE-OUT OF ALL UTILITIES, AT LEAST 2 FULL

WORKING DAYS PRIOR TO ANY EXCAVATION.

LEGEND OF EXISTING FEATURES

SUBJECT PARCEL PROPERTY LINE

DETAIL)

LIGHT POLES

"STOP" LETTERING

(REFER TO DETAIL)

PROPOSED BUILDING

APPROXIMATE PAVING LIMITS

CONCRETE PAVEMENT (REFER TO

CONCRETE SIDEWALK (REFER TO

SITE SIGN, PAINTED STOP BAR &

CROSSWALK AND YIELD TEXT

HEAVY DUTY PAVEMENT (REFER TO DETAIL

REFER TO THE SURVEY PREPARED BY COSTICH

LEGEND OF IMPROVEMENTS

— — — SETBACK LINE

ENGINEERING

BACK OF CURB




Date:

CIVIL ENGINEER OF RECORD Name: Christopher, V. Kambar New York License No.: 085920 Exp. Date.: October 31, 2019 Firm Reg. No.: 0008742

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> > www.apd.com



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315-451-1957 315-451-9603

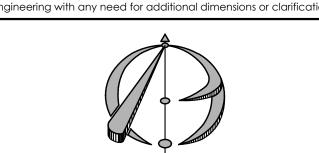TACO BELL - PERINTON HILLS PLAZA, NY

6687 PITTSFORD PALMYRA ROAD

SUITE 70

TOWN OF PERINTON

MONROE COUNTY, NY 14450

Project Name & Location:

Site Plan

Drawing Name:


Date: 03/08/18 17-0275 Final Type:

Drawn By: JWD

11'=20'

Drawing No.

Project No.

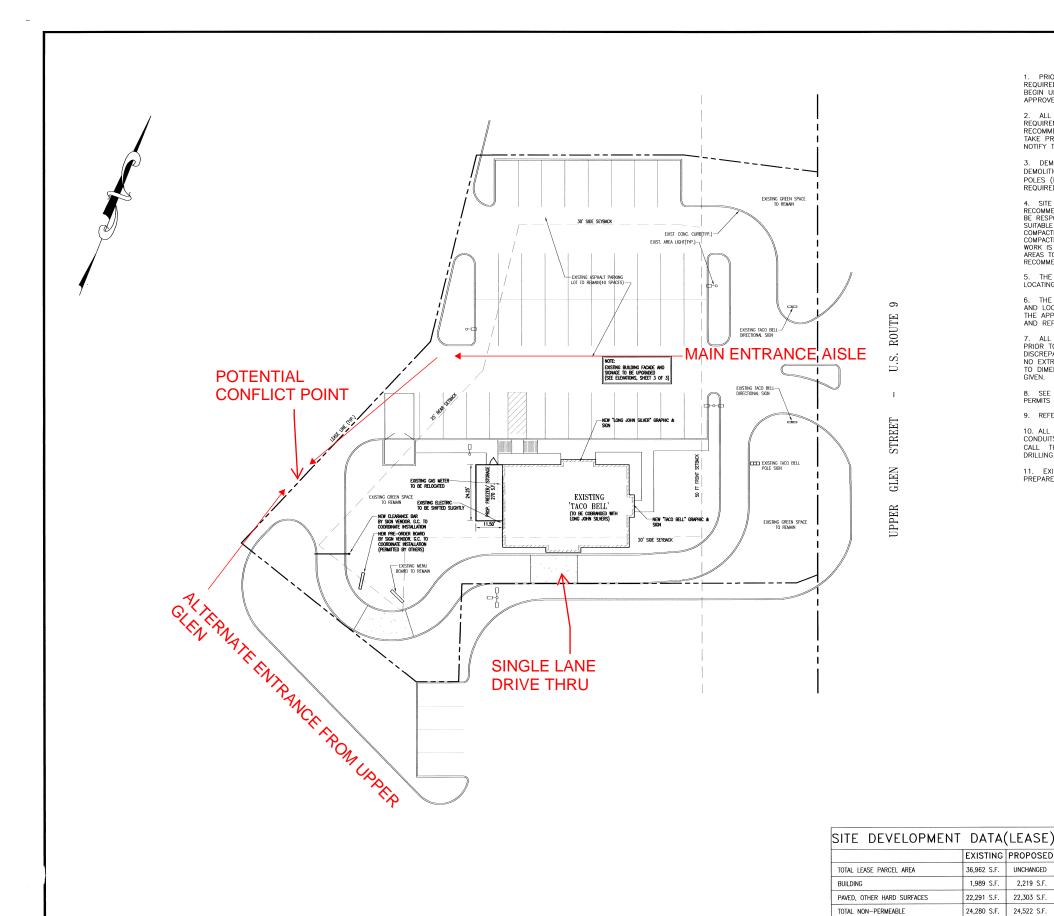

GRAPHIC SCALE

SITE PLAN NOTES

- 1. PRIOR TO STARTING CONSTRUCTION THE CONTRACTOR SHALL BE RESPONSIBLE TO MAKE SURE THAT ALL REQUIRED PERMITS AND APPROVALS HAVE BEEN OBTAINED. NO CONSTRUCTION OR FABRICATION SHALL BEGIN UNTIL THE CONTRACTOR HAS RECEIVED AND THOROUGHLY REVIEWED ALL PLANS AND OTHER DOCUMENTS APPROVED BY ALL OF THE PERMITTING AUTHORITIES.
- 2. ALL WORK SHALL BE PERFORMED IN ACCORDANCE WITH THESE PLANS, SPECIFICATIONS AND THE REQUIREMENTS AND STANDARDS OF THE LOCAL GOVERNING AUTHORITY. THE SOILS REPORT AND RECOMMENDATIONS SET FORTH THEREIN ARE A PART OF THE REQUIRED CONSTRUCTION DOCUMENTS AND TAKE PRECEDENCE UNLESS SPECIFICALLY NOTED OTHERWISE ON THE PLANS. THE CONTRACTOR SHAL NOTIFY THE CONSTRUCTION MANAGER OF ANY DISCREPANCY BETWEEN SOILS REPORT & PLANS ETC..
- DEMOLITION/SITE CLEARING: SEE CIVIL DWG'S AND GEOTECHICNAL REPORT FOR EXTENT OF SITE DEMOLITION. THIS WORK SHALL INCLUDE REMOVAL OF ALL EXISTING PAVEMENTS, CURBS (U.O.N.), LIGHT POLES (INCLUDING FTG'S.), VEGETATION (INCLUDING STUMPS), UTILITIES (NOT OTHERWISE REUSED), ETC. AS
- 4. SITE GRADING SHALL BE PERFORMED IN ACCORDANCE WITH THESE PLANS & SPECIFICATIONS AND THE RECOMMENDATIONS SET FORTH IN THE SOILS REPORT REFERENCED IN THIS PLAN SET. THE CONTRACTOR SHALL BE RESPONSIBLE FOR REMOVING & REPLACING ALL SOFT, YIELDING OR UNSUITABLE MATERIALS AND REPLACING WITH SUITABLE MATERIALS AS SPECIFIED IN THE SOILS REPORT. ALL EXCAVATED OR FILED AREAS SHALL BE COMPACTED AND MOISTURE CONDITIONED AS SPECIFIED IN THE SOILS REPORT. CONTRACTOR SHALL SUBMIT A COMPACTION REPORT PREPARED BY A QUALIFIED SOILS ENGINEER, REGISTERED WITHIN THE STATE WHERE THE WORK IS PERFORMED, VERIFYING THAT ALL FILLED AREAS AND SUBGRADE AREAS WITHIN THE BUILDING PAD AREA AND AREAS TO BE PAYED HAVE BEEN COMPACTED IN ACCORDANCE WITH THESE PLANS AND SPECS, AND THE RECOMMENDATIONS SET EORTH IN THE SOILS REPORT RECOMMENDATIONS SET FORTH IN THE SOILS REPORT.
- 5. THE A.L.T.A. SURVEY SHALL BE CONSIDERED A PART OF THESE PLANS. THE G.C. IS RESPONSIBLE FOR LOCATING IMPROVEMENTS PER THESE PLANS.
- 6. THE LOCATIONS OF UNDERGROUND FACILITIES SHOWN ON THESE PLANS ARE BASED ON FIELD SURVEYS AND LOCAL UTILITY COMPANY RECORDS. IT SHALL BE THE CONTRACTORS RESPONSIBILITY TO CONTACT THE APPROPRIATE UTILITY COMPANY. NO COMPENSATION SHALL BE PAID TO THE CONTRACTOR FOR DAMAGE AND REPAIR TO THESE FACILITIES CALLED BY LIES WOOD. AND REPAIR TO THESE FACILITIES CAUSED BY HIS WORK FORCE.
- ALL DIMENSIONS AND GRADES SHOWN ON THE PLANS SHALL BE FIELD VERIFIED BY THE CONTRACTOR PRIOR TO CONSTRUCTION. CONTRACTOR SHALL NOTIFY THE CONSTRUCTION MANAGER IF

 ANY
 DISCREPANCIES EXIST, PRIOR TO PROCEEDING WITH CONSTRUCTION, FOR NECESSARY PLAN OR GRADE CHANGES.
 NO EXTRA COMPENSATION SHALL BE PAID TO THE CONTRACTOR FOR WORK
 HAVING TO BE REDONE DUE) EXTRA COMPENSATION SHALL BE PAID TO THE CONTRACTOR FOR WORK. HAVING TO BE REDONE DUE. DIMENSIONS OR GRADES SHOWN INCORRECTLY ON THESE PLANS IF SUCH NOTIFICATION HAS NOT BEEN
- 8. SEE CIVIL PLANS FOR ALL WORK IN STREET RIGHT OF WAY. HIGHWAY (IF APPLICABLE) AND CITY ENCROACHMENT PERMITS TO BE OBTAINED AND PAID FOR BY THE GENERAL CONTRACTOR.
- 9. REFER TO BUILDING ELEVATIONS, SHEET 3, FOR BUILDING SIGNAGE.
- 10. ALL UTILITY LOCATIONS ARE APPROXIMATE. IT IS THE RESPONSIBILITY OF THE CONTRACTOR TO LOCATE—CONDUITS, PRODUCT PIPING, ETC. PRIOR TO COMMENCEMENT OF EXCAVATION OF ANY TYPE. CONTRACTOR TO CALL THE NEW YORK ONE CALL SYSTEM(1-800-962-7962 TOLL FREE) 48 HOURS BEFORE DIGGING, DRILLING, OR BLASTING.
- 11. EXISTING INFORMATION SHOWN HEREON TAKEN FROM A PLAN ENTITLED "SITE LAYOUT" FOR TACO BELL, PREPARED BY CLOUGH, HARBOUR & ASSOCIATES, DATED JULY, 1994.

GENERAL

THESE PLANS AND SPECIFICATIONS ARE SUBJECT TO MODIFICATION DURING CONSTRUCTION WHEN CONDITIONS DEVELOP THAT WERE NOT APPARENT DURING THE DESIGN AND PREPARATION OF THESE PLANS. ALL MODIFICATIONS MUST BE APPROVED BY LOCAL JURISDICTION PRIOR TO CONSTRUCTION AND/OR

BEFORE COMMENCEMENT OF WORK, THE CONTRACTOR SHALL REVIEW ALL PLANS AND SPECIFICATIONS AND THE JOB SITE. THE CONTRACTOR SHALL NOTIFY THE OWNER AND THE ENGINEER WHO PREPARED THE PLANS OF ANY DISCREPANCIES THAT MAY REQUIRE MODIFICATION TO THESE PLANS OR OF ANY FIELD CONFLICTS

IN THE EVENT OF ANY DISCREPANCY RETWEEN ANY DRAWING AND THE FIGURES WRITTEN THEREON, THE FIGURES SHALL BE TAKEN AS CORRECT.

THERETO IS NOT SUFFICIENTLY DETAILED OR EXPLAINED ON THESE PLANS, THE CONTRACTOR SHALL CONTACT THE ENGINEER FOR SUCH FURTHER EXPLANATIONS AS MAY BE NECESSARY.

CONTRACTOR AGREES THAT IN ACCORDANCE WITH GENERALLY ACCEPTED CONSTRUCTION PRACTICES, CONTRACTOR WILL BE REQUIRED TO ASSUME SOLE AND COMPLETE RESPONSIBILITY FOR JOB SITE CONDITIONS DURING THE COURSE OR CONSTRUCTION OF THE PROJECT, INCLUDING SAFETY OF ALL PERSONS AND PROPERTY. THIS REQUIREMENT SHALL BE MADE TO APPLY CONTINUOUSLY AND NOT BE LIMITED TO NORMAL WORKING HOURS. CONTRACTOR FURTHER AGREES TO DEFEND, INDEMNIFY, AND HOLD THE OWNER AND DESIGN PROFESSIONAL HARMLESS OF ANY AND ALL LIABILITY, REAL OR ALLEGED IN CONNECTION WITH THE PERFORMANCE OF WORK ON THIS PROJECT, ACCEPTING LIABILITY ARISING FROM THE SOLE NEGLIGENCE OF THE OWNER OR DESIGN PROFESSIONAL.

CONTRACTOR SHALL OBTAIN ENCROACHMENT PERMITS PRIOR TO COMMENCING CONSTRUCTION INVOLVING RIGHT OF WAYS, AND FOR THE CONSTRUCTION. MODIFICATION, OR CONNECTION TO FACILITIES. ALL WORKMANSHIP EQUIPMENT AND MATERIALS SHALL CONFIRM TO LOCAL JURISDICTION STANDARDS AND

TRAFFIC CONTROL SHALL BE PROVIDED IN ACCORDANCE WITH LOCAL

1,989 S.F.

12.682 S.F.

65.7%

TOTAL GREEN SPACE

PERCENT NON-PERMEABLE

2,219 S.F.

22,303 S.F.

24,522 S.F.

12,440 S.F.

66.3%

THE CONTRACTOR SHALL PROVIDE ALL LIGHTS, SIGNS, BARRICADES, FLAGMEN, OR OTHER DEVICES NECESSARY TO PROVIDE FOR PUBLIC SAFETY.

WHERE SOIL OR GEOLOGIC CONDITIONS ENCOUNTERED IN GRADING OPERATIONS ARE DIFFERENT FROM THOSE ANTICIPATED IN THE SOIL AND GEOLOGICAL INVESTIGATION REPORT, OR WHERE CONDITIONS WARRANT CHANGES TO THE RECOMMENDATIONS CONTAINED THEREIN, A REVISED SOIL OR GEOLOGIC REPORT SHALL BE SUBMITTED FOR APPROVAL AND SHALL BE ACCOMPANIED BY AN ENGINEER'S OPINION AS TO THE SAFETY OF THE SITE FROM THE POSSIBILITY OF LAND SLIPPAGE, SETTLEMENT AND SEISMIC ACTIVITY.

LESTER M. STEIN
ARCHITECT
1321 NORTH NEW STREET
BETHLEHEN, PA 18018
(610) 865-8101

STEIN

L.M.

BOHLER ENGINEERING •

SITE

. DATE DESCRIPTION 9/26/02 REMOVED BUILDING S 10/21/02 PREPAY WINDOW BUMP 4/22/03 PREPAY WINDOW REMOV


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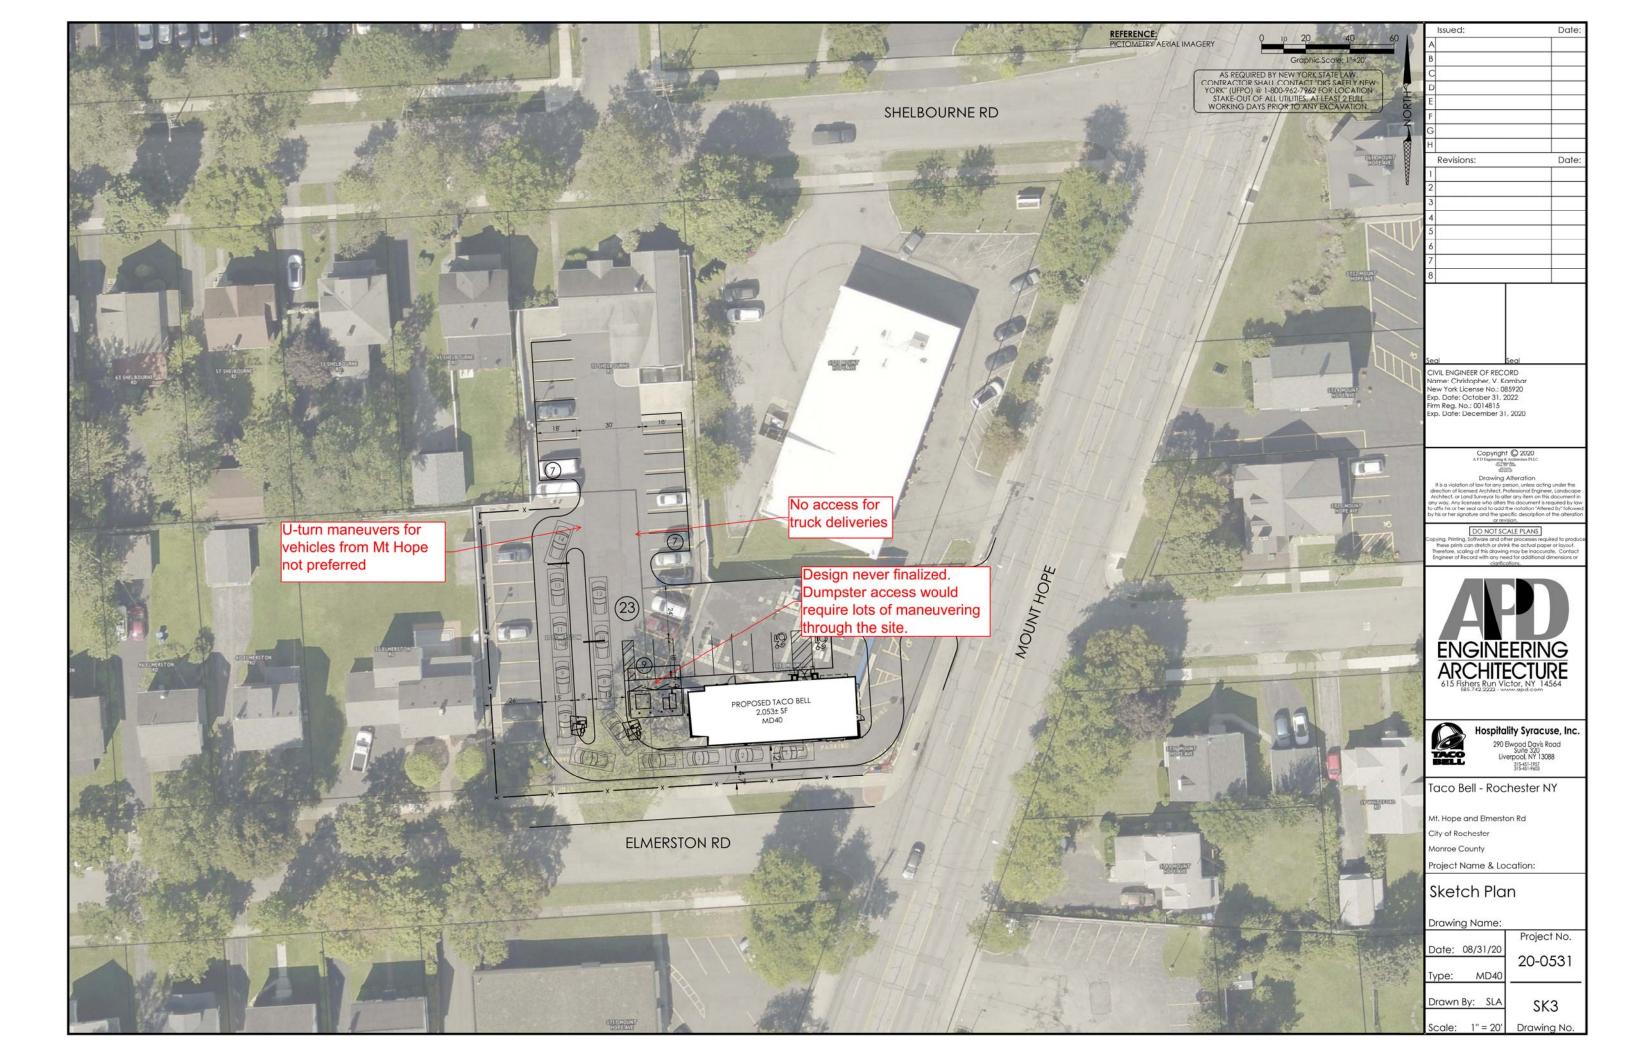
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PROTOTYPE ISSUE DATE 7/22/02 SITE NUMBER


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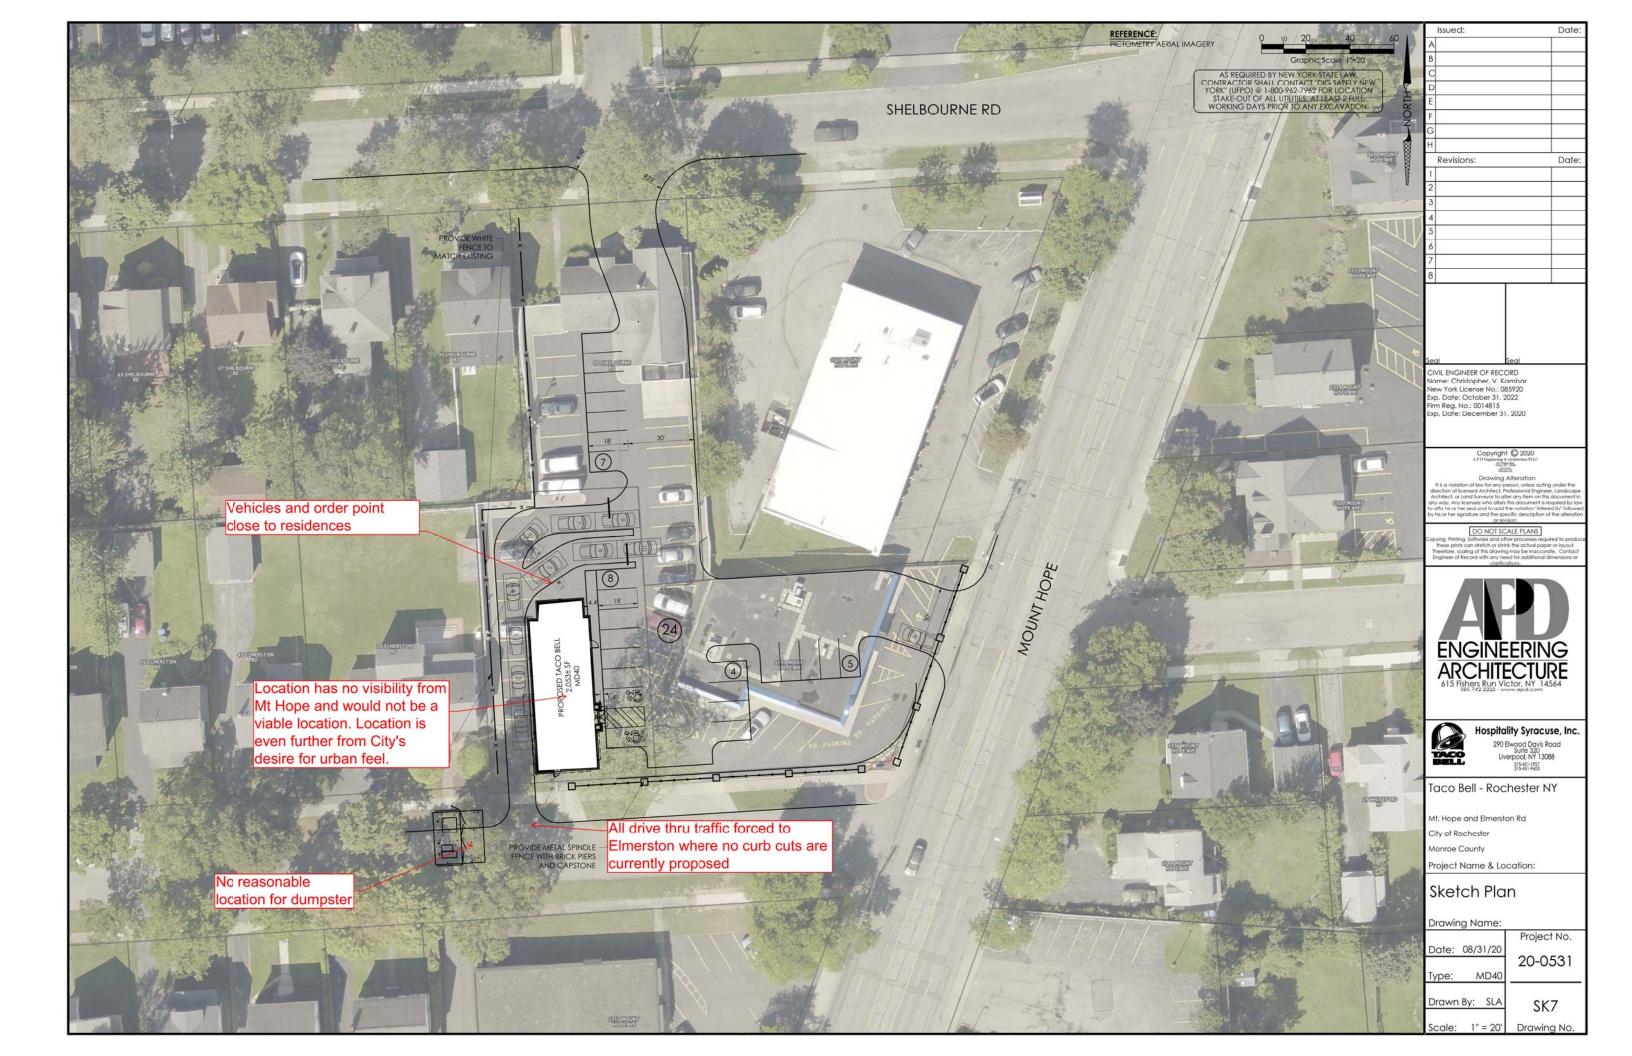









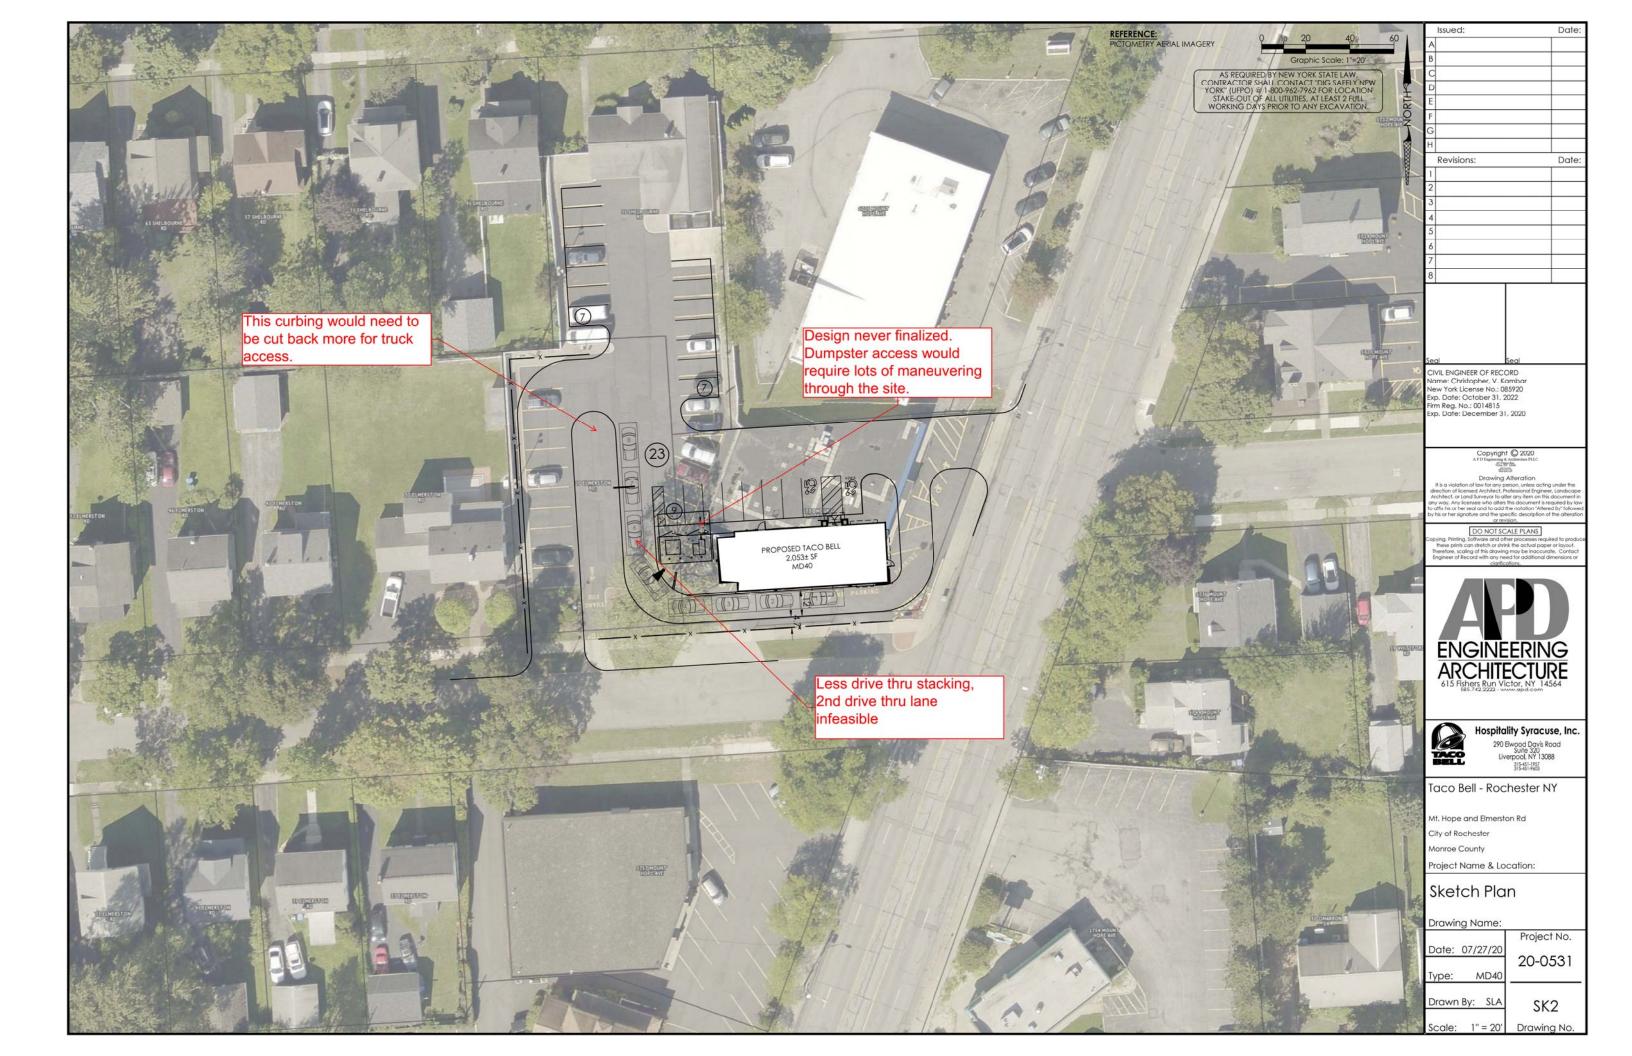

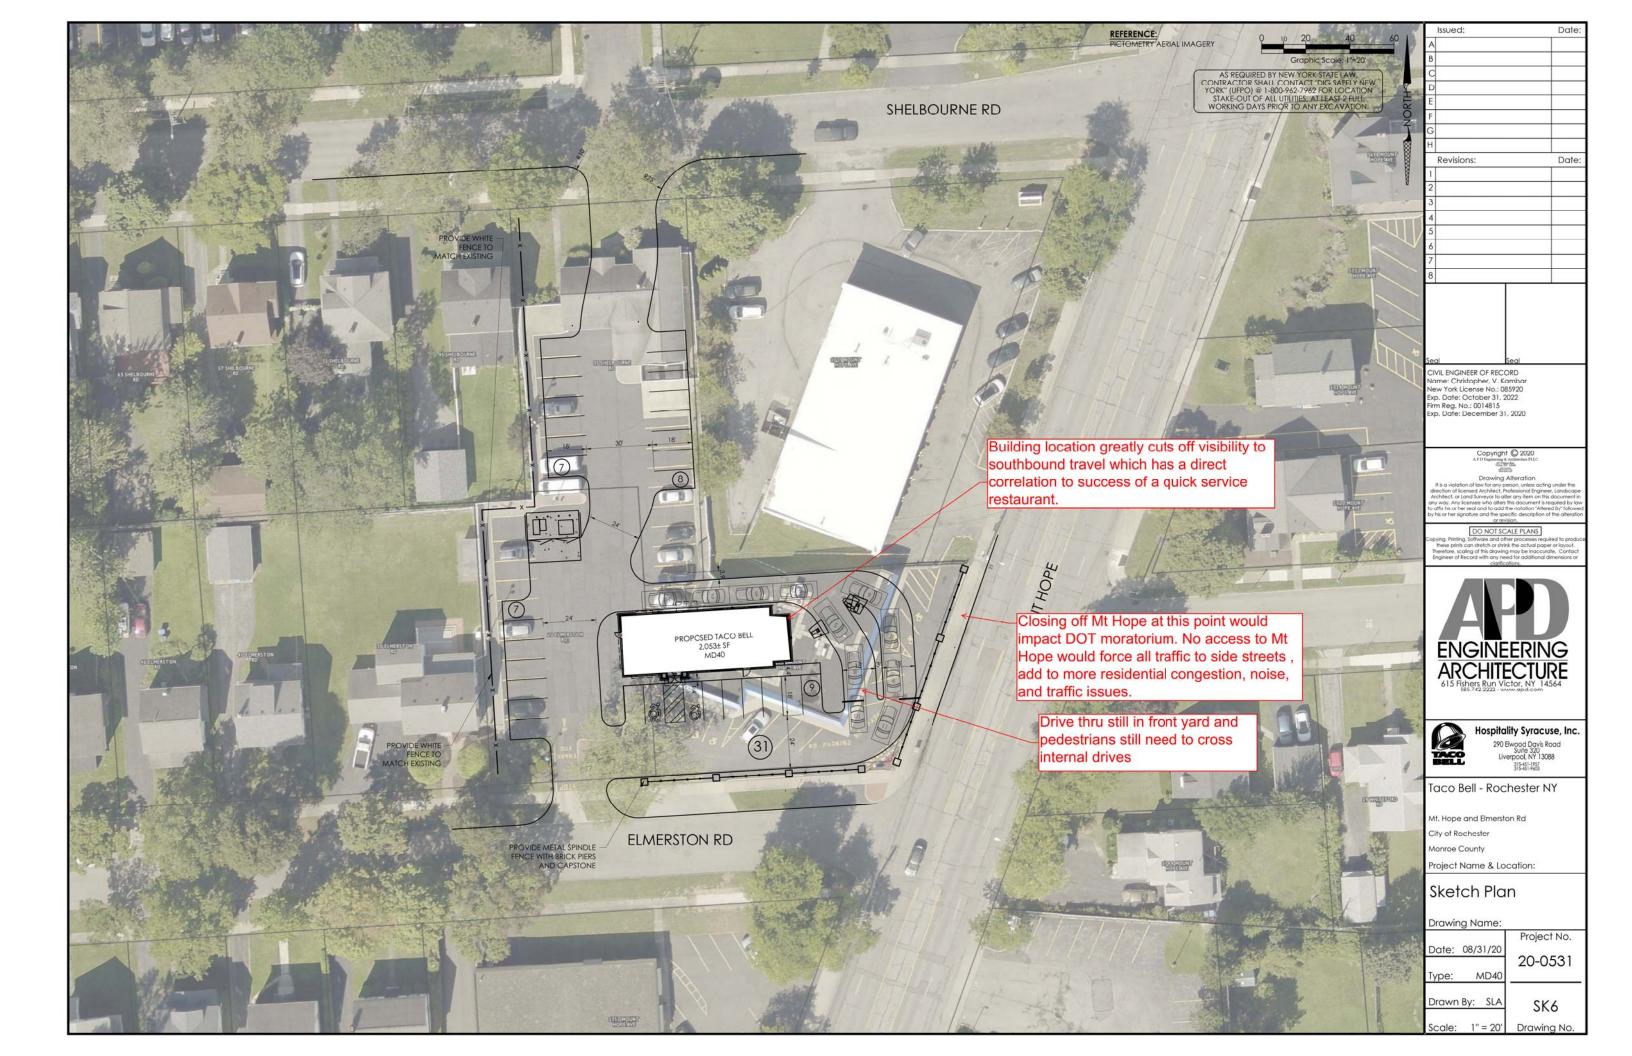

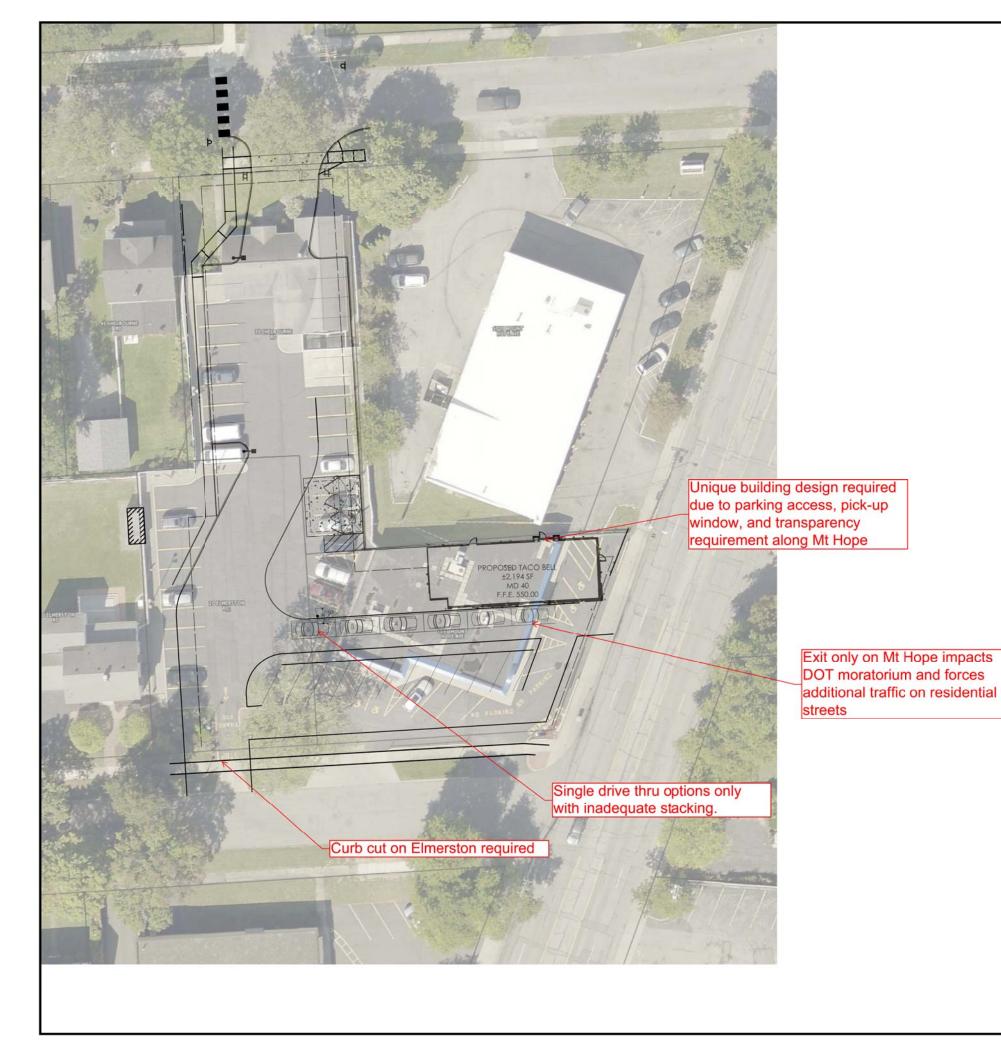

REFERENCE: PICTOMETRY AERIAL IMAGERY

AS REQUIRED BY NEW YORK STATE LAW, CONTRACTOR SHALL CONTACT "DIG SAFELY NEW YORK" (UPPO) @ 1-800-982-7962 FOR LOCATION STAKE-OUT OF ALL UTILITIES, AT LEAST 2 FULL WORKING DAYS PRIOR TO ANY EXCAVATION.

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CIVIL ENGINEER OF RECORD Name: Christopher, V. Kambar New York License No.: 085920 Exp. Date: October 31, 2022 Firm Reg. No.: 0014815 Exp. Date: December 31, 2020

ENGINEERING ARCHITECTURE



Hospitality Syracuse, Inc.

290 Elwood Davis Road Suite 320 Liverpool, NY 13088 315-451-1957 315-451-7603

Taco Bell - Rochester NY

Mt. Hope and Elmerston Rd City of Rochester

Monroe County


Project Name & Location:


Site Plan

Drawing Name:

Project No. Date: 07/27/20 20-0531

Drawn By: SLA

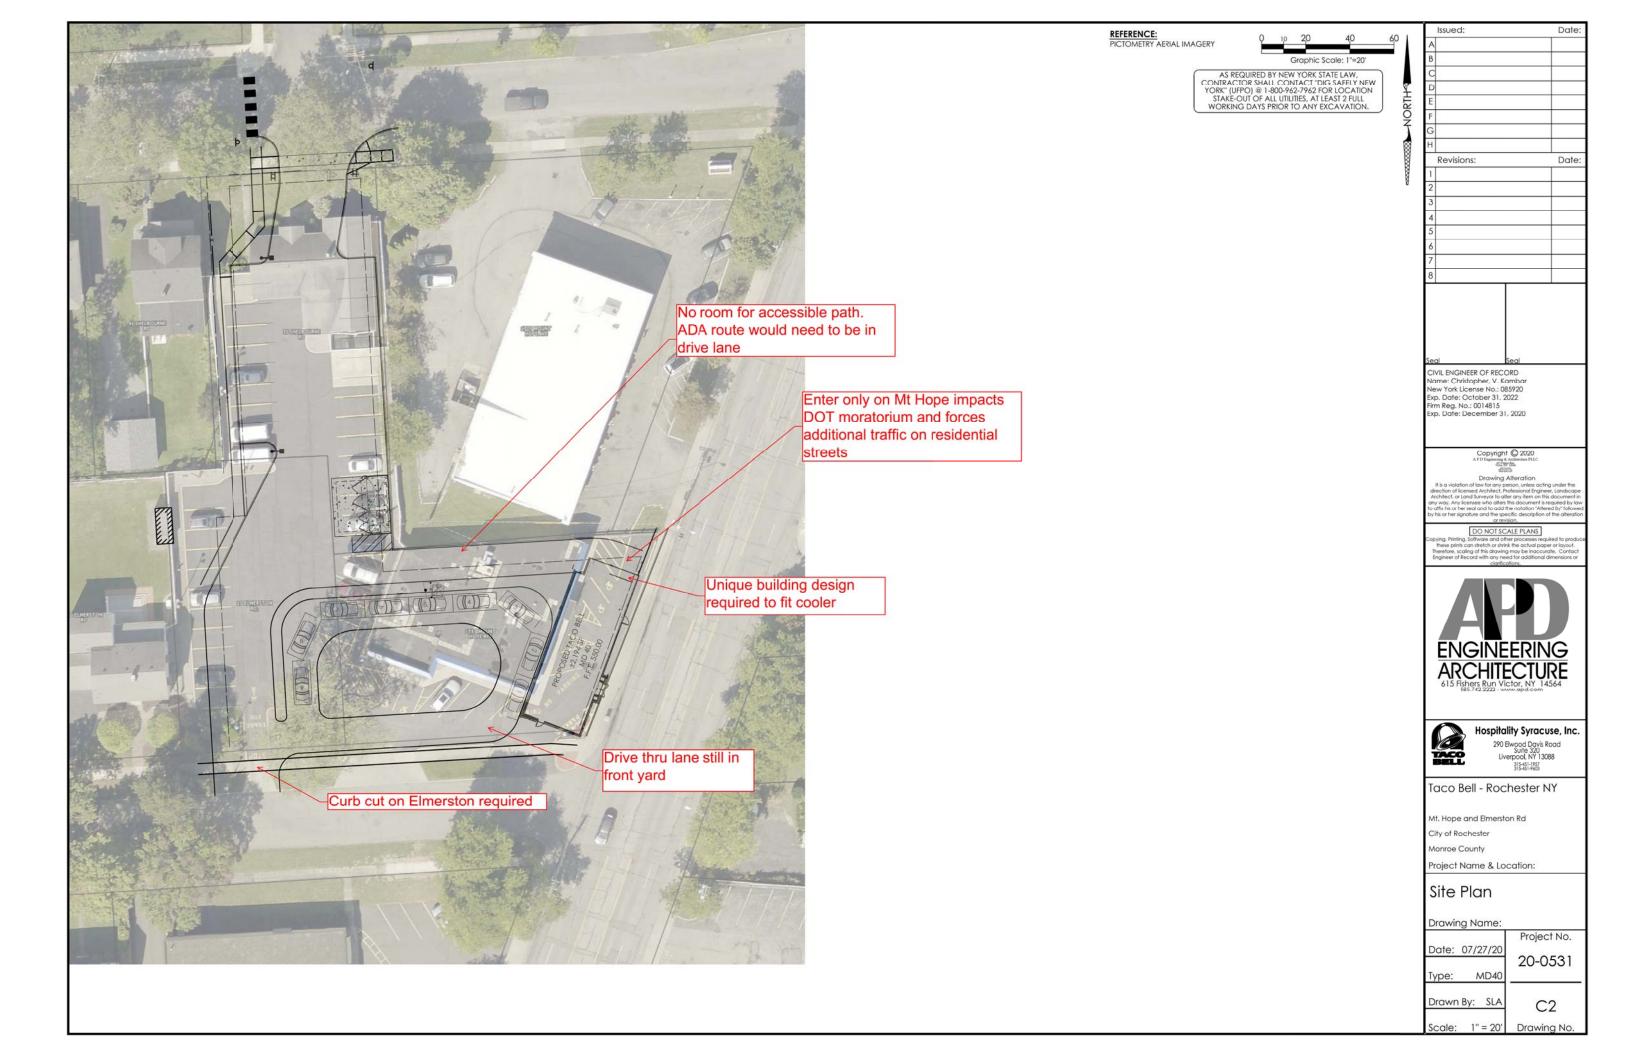

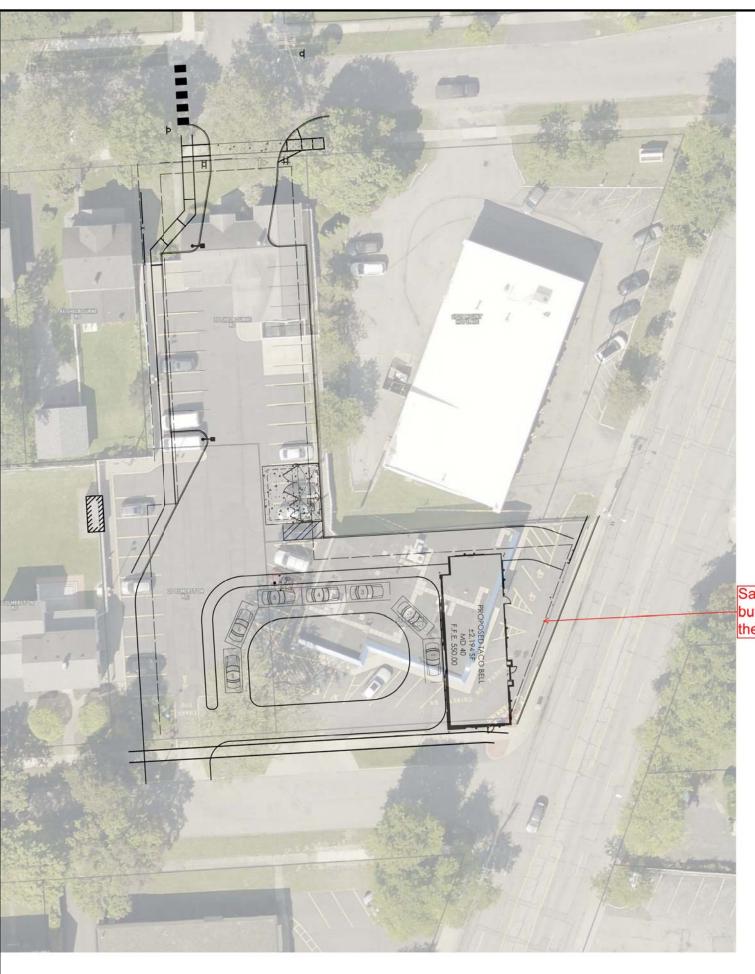

Same general comments as the last plan, but building is rotated along Elmerston and there is less stacking

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REFERENCE: PICTOMETRY AERIAL IMAGERY

CIVIL ENGINEER OF RECORD Name: Christopher, V. Kambar New York License No.: 085920 Exp. Date: October 31, 2022 Firm Reg. No.: 0014815 Exp. Date: December 31, 2020





Hospitality Syracuse, Inc.
290 Elwood Davis Road
Suite 320
Liverpool. NY 13088

Taco Bell - Rochester NY

Mt. Hope and Elmerston Rd

City of Rochester

Monroe County

Project Name & Location:

Site Plan


Drawing Name:

Project No. Date: 07/27/20

20-0531

Type: MD40

Drawn By: SLA

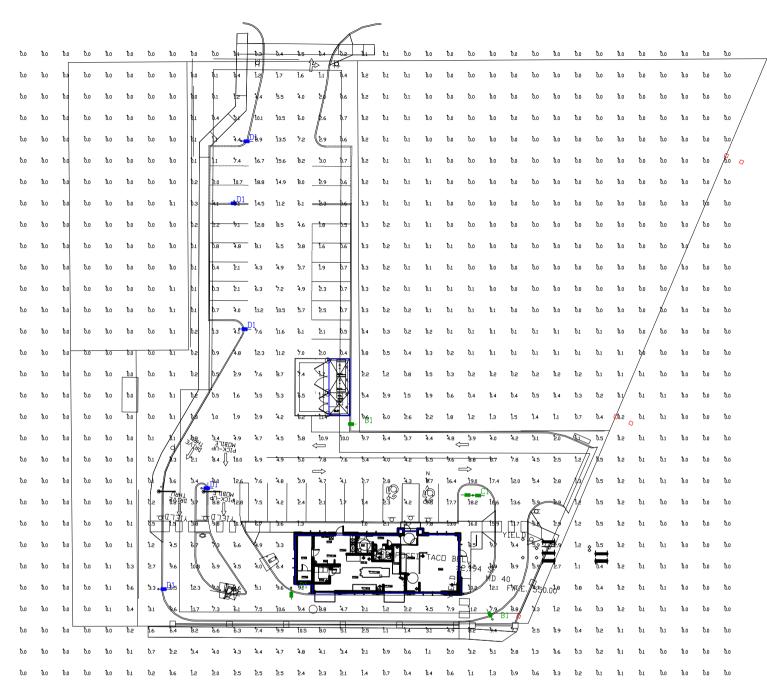



Luminaire Scheo	Luminaire Schedule								
Symbol	Qty	Label	Arrangement	Description	LLD	LDD	LLF	Arr. Lum. Lumens	Arr. Watts
-	3	B1	SINGLE	ENM4-PT-FT-LED-25L-30-SINGLE-15' MH	1.000	1.000	1.000	22806	227.9
	1	C1	D180°	ENM4-PT-FT-LED-25L-30-D180-15' MH	1.000	1.000	1.000	45612	455.8
_	5	D1	SINGLE	ENM4-PT-FT-LED-25L-30-IL-SINGLE-15' MH	1.000	1.000	1.000	17223	227.1

Calculation Summary							
Label	CalcType	Units	Avg	Max	Min	Avg/Min	Max/Min
ALL CALC POINTS	Illuminance	Fc	1.82	19.0	0.0	N.A.	N.A.
INSIDE CURB	Illuminance	Fc	5.98	19.0	0.3	19.93	63.33

Based on the information provided, all dimensions and luminaire locations shown represent recommended positions. The engineer and/or architect must determine the applicability of the layout to existing or future field conditions

This lighting plan represents illumination levels calculated from laboratory data taken under controlled conditions in accordance with The Illuminating Engineering Society (IES) approved nethods. Actual performance of any narufacturer's luminates nay vary due to changes in electrical voltage, tolerance in langs/ELD's and other variable field conditions. Calculations do not include obstructions such as buildings, curbs, landscaping, or any other architectural elements unless noted. Fixture nomenclature noted does not include nounting hardware or poles. This drawing is for photometric evaluation purposes only and should not be used as a construction document or as a final document for ordering product.

Total Project Watts Total Watts = 2275




TACO BELL
MT HOPE & ELMERSTON RD
ROCHESTER,NY

BYSAN(NVE) DATE:8-19-21 REV-2-7-22 SHEET 1

OF 1

SCALE: 1*=20'

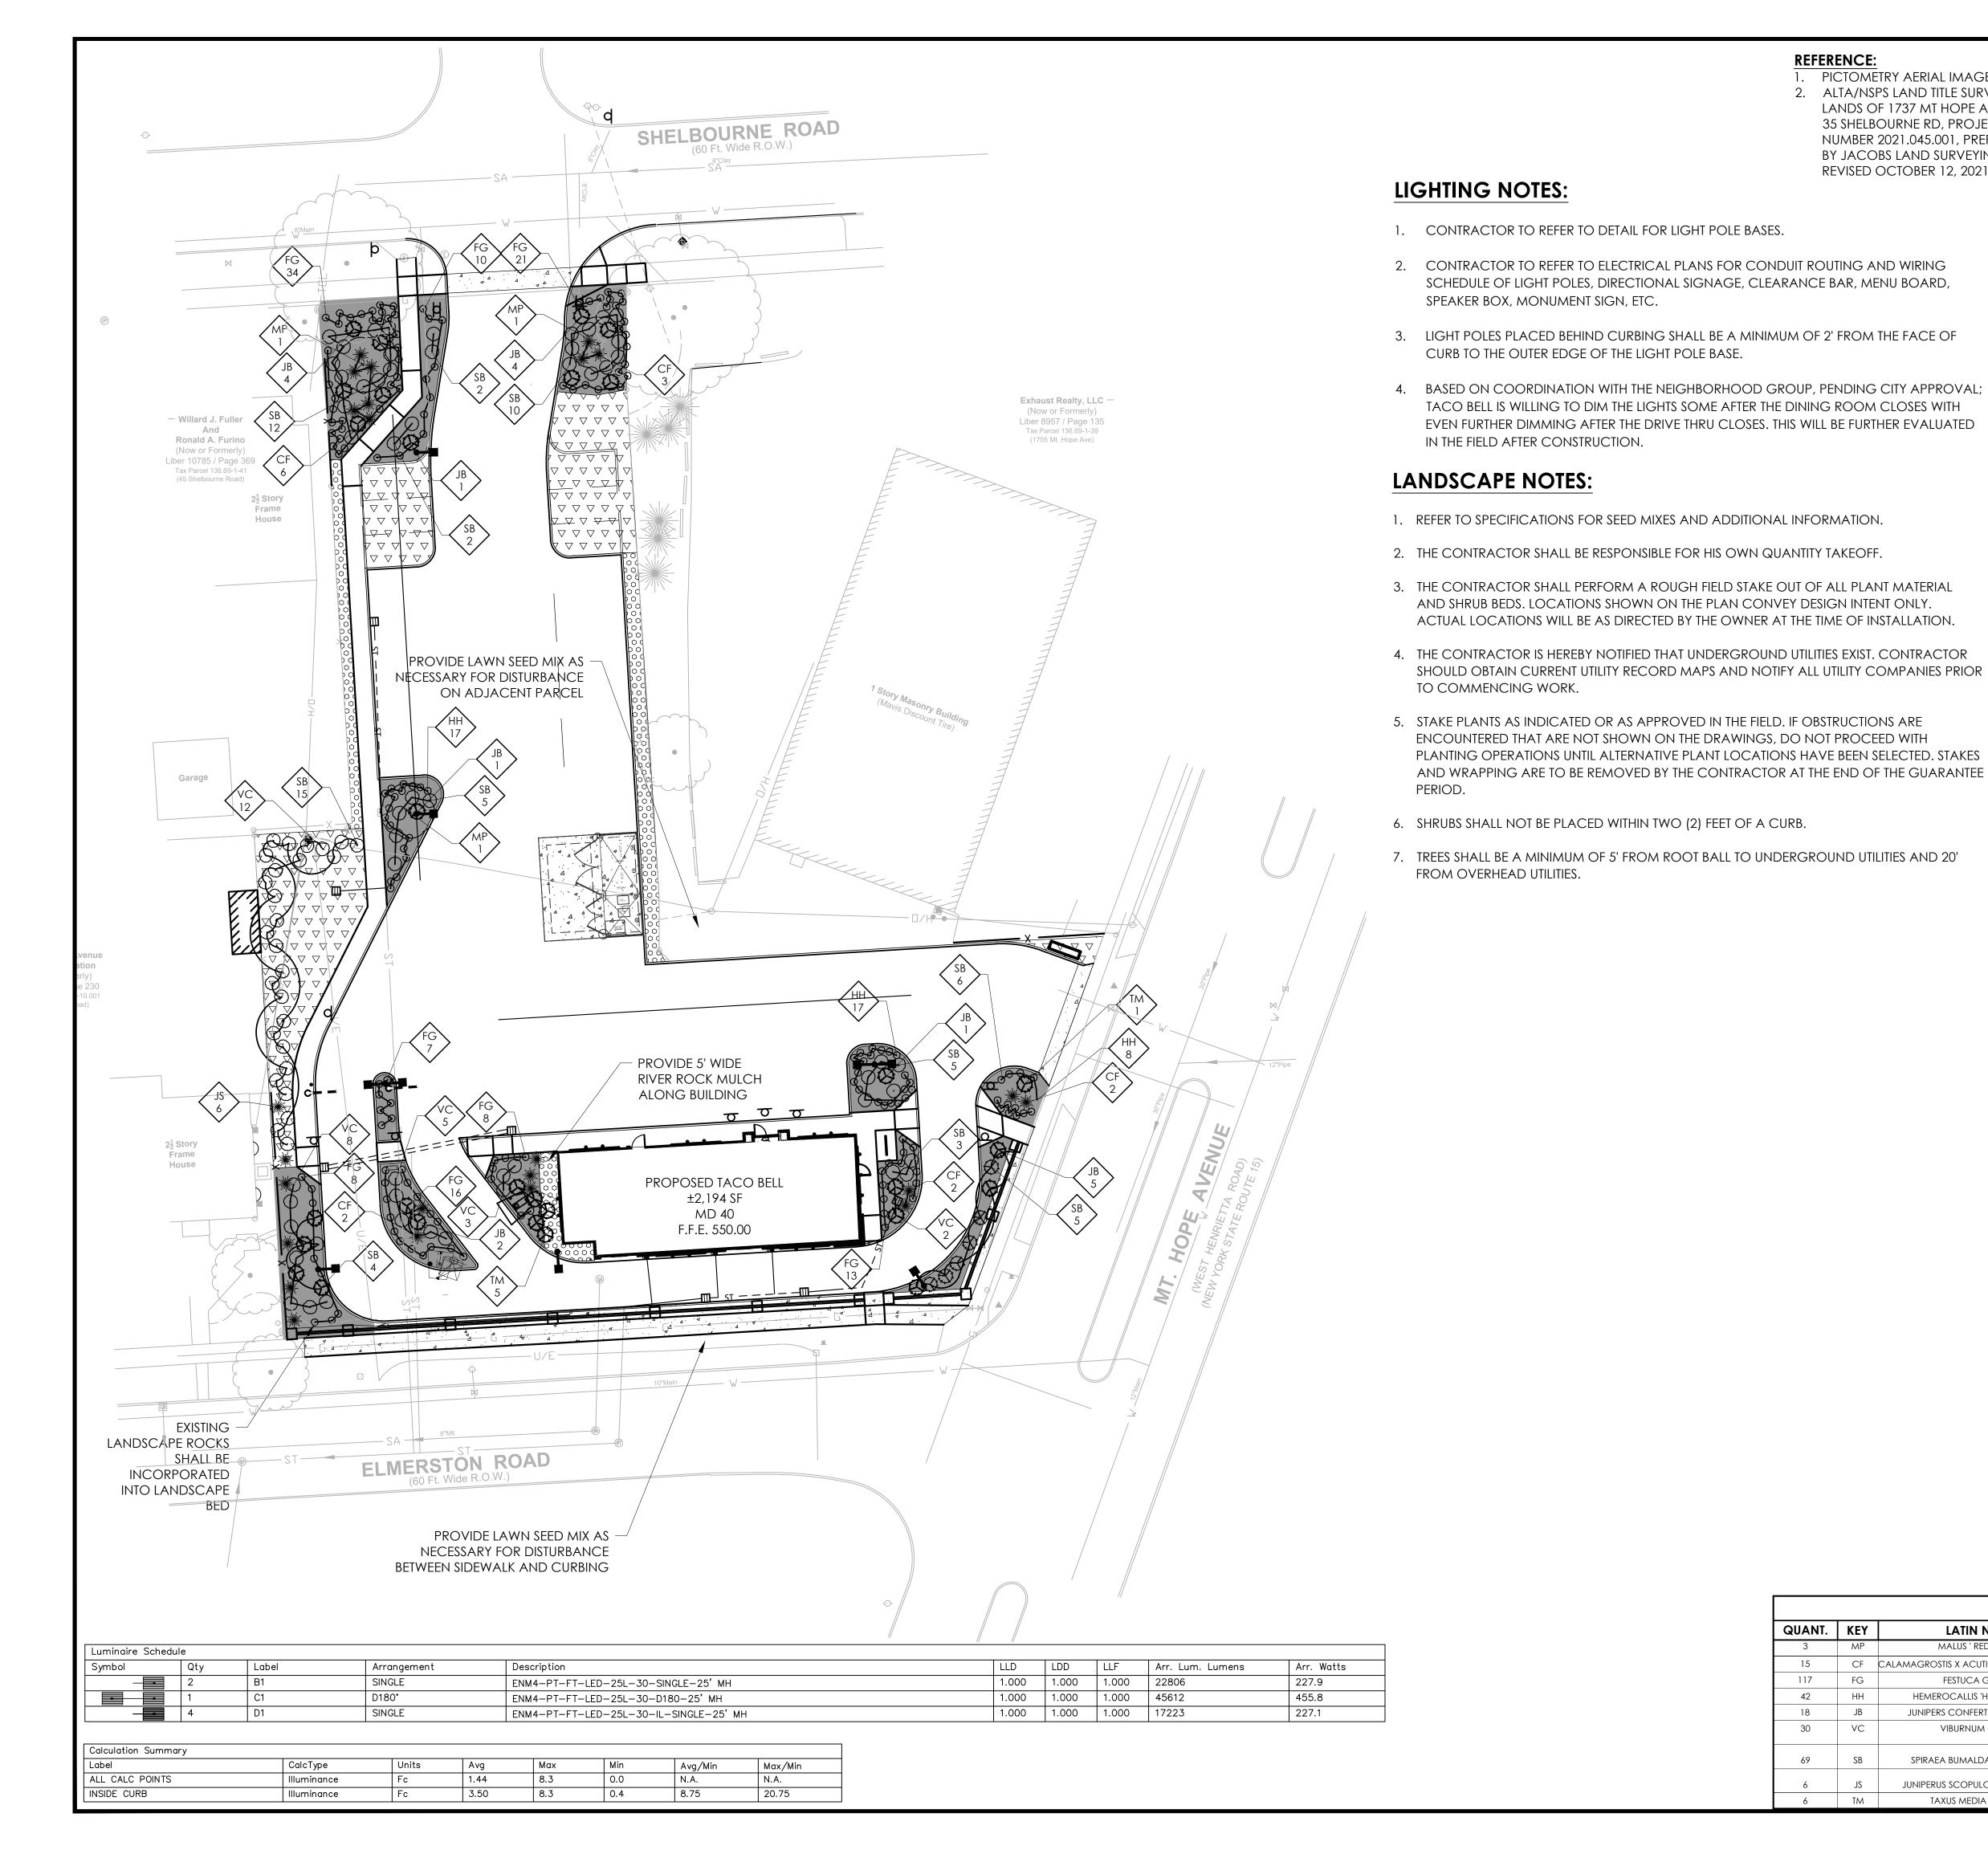

REFERENCE:

- PICTOMETRY AERIAL IMAGERY 2. ALTA/NSPS LAND TITLE SURVEY 35 SHELBOURNE RD, PROJECT
 - LANDS OF 1737 MT HOPE AVE AND NUMBER 2021.045.001, PREPARED BY JACOBS LAND SURVEYING, LAST REVISED OCTOBER 12, 2021.

Graphic Scale: 1"=20'


AS REQUIRED BY NEW YORK STATE LAW, CONTRACTOR SHALL CONTACT "DIG SAFELY NEW YORK" (UFPO) @ 1-800-962-7962 FOR LOCATION STAKE-OUT OF ALL UTILITIES, AT LEAST 2 FULL WORKING DAYS PRIOR TO ANY EXCAVATION.

LEGEND OF IMPROVEMENTS

SUBJECT PARCEL PROPERTY LINE PROPOSED BUILDING —— E —— E —— UNDERGROUND ELECTRIC ——T——T—— UNDERGROUND TELEPHONE ——G——G—— GAS SERVICE SANITARY SEWER LATERAL & ---- UD --- UNDERDRAIN ---- ST --- STORM LATERAL = = = = STORM SEWER & STRUCTURES YYYYY PROPOSED STEEP SLOPES LIGHT POLES SHRUBS/BUSHES **DECIDUOUS TREE CONIFER TREE** □ □ □ □ □ □ LAWN SEED MIX

BARK MULCH BED

RIVER ROCK MULCH BED

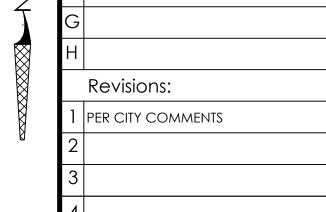

Issued:

City of Rochester

City of Rochester

11/12/21

02/10/22

Date:

02/10/22

CIVIL ENGINEER OF RECORD Name: Stephanie L. Albright New York License No.: 087051 Exp. Date. December 31, 2023 Firm Reg. No.: 0014815 Exp. Date: December 31, 2023

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Drawing Alteration

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DO NOT SCALE PLANS

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Hospitality Syracuse, Inc.

290 Elwood Davis Road Suite 320 Liverpool, NY 13088

Taco Bell - Rochester NY

1737 Mt. Hope Ave City of Rochester

Monroe County

Project Name & Location:

Planting and Lighting Plan Drawing Name:

Project No.		
	06/10/21	ate:
20-0531		
	MD40	уре:

Drawn By: SLA Drawing No.

PLANT LIST QUANT. | KEY **LATIN NAME COMMON NAME** CAL. ROOTS | HT. OR. SP MALUS ' RED BARON' B&B CF CALAMAGROSTIS X ACUTIFLORA 'KARL FOERSTER' KARL FOERSTER FEATHER REED GRASS #2 CONT. 24" HT, 4' O.C 117 FESTUCA GLAUCA ELIJAH BLUE FESCUE #2 CONT. 12" HT, 18" O.C 42 HEMEROCALLIS 'HAPPY RETURNS' HAPPY RETURNS DAYLILY #2 CONT. 2' O.C. JUNIPERS CONFERTA 'BLUE PACIFIC' BLUE PACIFIC JUNIPER #2 CONT. 18" SP, 4' O.C 24" HT (AT 30 KOREANSPICE VIBURNMUM B&B VIBURNUM CARLESII PLANTING), 5' O. #2 CONT. |PLANTING), 3' O. SPIRAEA BUMALDA 'GOLD FLAME' GOLD FLAME SPIREA 24" HT (MIN. A JUNIPERUS SCOPULORUM SKYROCKET SKYROCKET JUNIPER B&B PLANTING), 4' O B&B 18"-24" HT. / 4' SP TAXUS MEDIA 'EVERLOW' **EVERLOW YEW**



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APD Engineering & Architecture
615 Fishers Run
Victor, NY 14564
5857427222
5859246974 Eas
www.negot.com

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NOT FOR CONSTRUCTION

Hospitality Syracuse, Inc.

290 Elwood Davis Road Suite 320 Liverpool, NY 13088 315-451-1957 315-451-9603

PROJECT NUMBER: 20-053
BUILDING TYPE: MED4
PLAN VERSION: DEC 202
SITE NUMBER: XX

TACO BELL

1737 MT. HOPE AVE ROCHESTER, NY 14620

STORE NUMBER:



EXTERIOR

ELEVATIONS

Δ4

DATF.

11-02-2021



APD Project No. 20-0531

February 10, 2022

City of Rochester – Bureau of Buildings and Zoning Attn: Anna Keller City Hall, 30 Church St, Room 125B Rochester NY 14614

RE: Proposed Taco Bell, 1737 Mount Hope – Parking Demand Analysis (SP-01-21-22)

Dear Ms. Khaleel,

The above-mentioned site is currently the location of the $\pm 4,470$ SF Rowe Photo building with 39 parking spaces. Taco Bell is proposing to construct a $\pm 2,200$ SF restaurant with drive thru facilities and 24 parking spaces at 1737 Mt Hope Avenue. Taco Bell is also proposing 6 banked parking spaces for potential/future use.

The project will demolish the existing building on-site, reduce parking spaces, and increase green space.

Taco Bell typically has 7-8 employees per shift with approximately 4 additional employees at shift change. While we acknowledge some employees may walk, bike, or bus; it is feasible to have 12 employee vehicles in the parking lot at one time. The dining room will have seating for 40 customers.

Similar locations around the Rochester/Syracuse region and corresponding parking spaces. As can be seen in the list below, the 24 proposed parking spaces is not excessive in this market area.

- Chili 23 spaces (located in a plaza with shared parking)
- 1436 W Ridge Rd, Greece 36 spaces
- 1008 Lehigh Station Rd, Henrietta 33 spaces
- 16687 Pittsford Palmyra Rd, Perinton 19 spaces along restaurant (located in plaza with shared parking)
- 3900 Dewey Ave 25 spaces
- 8095 Oswego St, Liverpool 57 spaces
- 3716 Brewerton Rd, N. Syracuse 41 spaces
- 3500 W Genesee St, Syracuse 33 spaces

During the winter months, some of the northern parking spaces will likely be used for additional snow storage as well.

Should you have any questions, comments, or are in need of additional information, please feel free to contact me (salbright@apd.com, 585-742-0204)

Sincerely,

Stephanie Albright, P.E. Senior Civil Engineer

Scalaria allighe

cc: M. McCracken (Hospitality Syracuse, Inc.)

B. Brugg, Esq. (Woods Oviatt)



APD Project No. 20-0531

February 10, 2022

City of Rochester – Bureau of Buildings and Zoning Attn: Roseanne Khaleel City Hall, 30 Church St, Room 125B Rochester NY 14614

RE: Proposed Taco Bell, 1737 Mount Hope – Response to site plan comments (SP-01-21-22)

Dear Ms. Khaleel,

We are in receipt of your Site Plan Review comments for the proposed Taco Bell at 1737 Mt Hope Avenue dated January 2, 2022. We have also received the Code Compliance Review spreadsheet as prepared by Ms. Marcia Barry on December 15, 2021. We appreciate that the City is willing to work with us to help alleviate the site plan concerns. The Zoom meeting on January 20, 2022 was very helpful.

We are including several of the conceptual layouts that we considered prior to the site plan that we are working with now. There are significant concerns with all the other layouts that make them infeasible. These site plans are included for your review.

We have reviewed the City's concerns and have modified the site plan to the maximum extent practical. Several of the concerns are created by the unique L-shaped lot configuration and the site being on a corner lot. The recent DOT improvements to Mt Hope Avenue also further restrict the site plan options due to the existing curb cut location and the moratorium on modifications to the pavement/curbing within this corridor.

Environmental clean-up on this site has already been completed within the pavement areas of the site. Additional environmental clean-up is proposed within the Rowe Photo building footprint, once it has been demolished.

The location of our proposed curb cut on Shelbourne Rd is aligned with Norfolk St and is at the transition of commercial vs residential properties. This street connection and width are required for delivery trucks to exit the site. Any potential development with delivery vehicles on this site would likely require a curb cut on Shelbourne as well. A site plan configuration allowing for a delivery vehicle to completely turn around on-site and exit on Mt Hope is not feasible. The 30' drive lane provides sufficient room for the delivery trucks, emergency vehicles, refuse vehicles, and allows for vehicles to back out of their parking spaces.


Six parking spaces have been removed from the northern portion of the site. These parking spaces can be banked for future construction in the event Taco Bell determines additional

spaces are needed. This will provide additional green space and snow storage with the initial construction. A parking demand analysis is provided for City review.

The fencing along Elmerston Rd has been upgraded to provide 5' of a solid wall and it has also been extended along the Mt Hope sidewalk limits. This wall will be constructed of materials to match the building and will to shield the drive thru lane. This layout is similar to the Starbucks in College Town (both drive thru location and wall). There are no feasible options to completely remove the drive thru from the front yard, so a shielding wall will be provided to mitigate. Once we receive feedback from the City regarding the screen wall feasibility, we can provide additional renderings and details to show the extent of mitigation this wall will offer.

With the site located on a corner lot, it prevents any site plan option with a drive thru that doesn't have queueing, drive thru, or exit lane within the front lane. The current configuration has been analyzed to have the maximum queueing available on-site to minimize any impact to the surrounding streets. We feel that this location with nearby drive thru restaurants will be a benefit to the community.

The Burger King on the corner of Culver and Humboldt is another similar situation with a quick service restaurant on a corner lot with drive thru features in the front yard. The entire drive thru is visible from Humboldt with no screening.

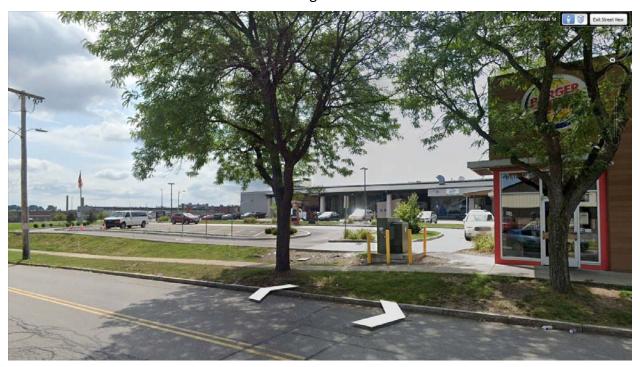


Burger King – 21 Humboldt St

The development of a drive thru use on a corner lot prevents the option of providing unrestricted pedestrian access to the building. The only site plan option to provide this pedestrian access would be to have an exit onto Elmerston. Due to the close proximity of the Mt Hope/Elmerston intersection, providing a direct exit to either road would not be desirable



or allowed for safety reasons. Furthermore, pedestrians are ultimately crossing the same number of driveways to enter the building. Below are examples of the site design for this project shown on the left, along with the proposed Taco Bell (358 Lake Ave) on the right for comparison. It could be argued that crossing an internal drive lane is safer than crossing the main exiting lane as cars would be more distracted observing the traffic flow on a main drive then on-site circulation. To aide in safety for pedestrian crossing, yield text and a pedestrian crossing sign have also been added to the site plan in lieu of only crosswalk striping. We disagree with the statement that the site plan is not pedestrian friendly. We are providing connections to the Shelbourne, Mt Hope, and Elmerston sidewalk networks. The overall site design was thought out with pedestrian access in mind to minimize pedestrian/vehicular conflict points.

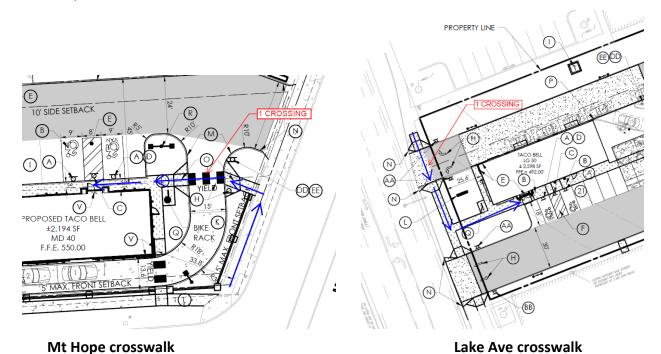

We have reviewed several Taco Bell site plans that are currently in operation with two site entrances and therefore have similar on-site conflict points at the drive entrance. These site plans are provided with this submittal for City review. To the best of their knowledge, Hospitality Syracuse has not had any accidents at this merge point, and no concerns have been expressed to the local managers of these locations. Both the McDonald's and Starbucks have similar conflict points for their drive thru lanes as well access from Celebration Drive and the private access drives as can be seen below. These restaurants however to not provide clear access paths across Celebration Dr and the drive thru lanes as you will find within the Taco Bell design.



McDonalds and Starbucks at College Town

The current Taco Bell site plan provides for 12 queueing vehicles in the two drive thru lanes. An additional 8 vehicles would need to be queued toward Mt. Hope before these vehicles would impact the drive thru exiting traffic. Hospitality Syracuse operates over 100 restaurants and through their experience feels that the available queueing space for this site will not create any long-term on-site congestion. For comparison, Wendy's can only stack 9 vehicles and Burger King can only stack 7 cars (as can be seen below) before queueing on Mt Hope begins.







Wendys - 1550 Mt Hope Ave

Burger King - 1780 Mt Hope Ave

A center lane and striping has been added to the Taco Bell plans to provide maximum maneuverability for vehicles parked along the building to back out of their parking spaces.

If the City feels strongly about the merging of the two ordering points into one pick up lane, we would be agreeable to removing one of the ordering lanes.

The Taco Bell directional signs on Shelbourne will not be internally lit. A note has been added to the site plan to indicate this. **This will remove the waiver associated with 120-177(9).**

The request to provide a drive thru bypass lane is not feasible for this project due to the minimum width along Mt. Hope. It should be noted that this is not a code requirement and is also not provided at other nearby restaurants including Starbucks and McDonalds. Emergency vehicles have full access to the site through the parking lot and/or the adjacent streets. Similar developments like the Burger King on Alexander have recently been approved without a bypass lane (see below).



347 Monroe Ave



The building location and drive thru exit lane has been designed to maximize stacking during the peak hour after the pick-up window. The drive thru exit lane (after pick up window) has sufficient space to queue 4-5 vehicles before it would impact the drive thru operations. This is a greater distance than is provided at either Burger King or Wendy's (from pick-up window to Mt Hope). While the vehicles exiting will need to alternate between the main drive and the drive thru exit, we don't foresee any specific impacts here.

The Code requires space for 6 cars stacking after the order point and 4 spaces from the pick-up window to the order point. The proposed site plan has 5 stacking spaces from the point for the western drive thru lane and 3 for the mobile drive thru lane for a total of 8 stacking spaces. The drive thru lane shares 4 spaces between the pick-up window and the order point. The code doesn't clarify the requirements when a second drive thru lane exits. **We feel that the total stacking provided** meets the intent of the code and that a waiver for 120-174 should not be required.

Based on the code requirement, 63 shrubs and 40 trees are required for the project. Code allows for 3 shrubs to be planted in lieu of 1 tree. The current planting plan proposed 9 trees and a total of 297 shrubs/ornamental grasses. We acknowledge that not all of these plantings meet the 24" requirement at the time of planting; but in most cases this is due to a lower mature height for these species. We feel that this updated plan will remove two of the listed waivers.

An updated lighting plan has been prepared to utilize the dark sky compliant (LSI ENM4) at 15' high (see image below). This is a more decorative light fixture that will tie into the neighborhood community. The light source is contained completely within the fixture and will have minimal spillage along the property line. These fixtures do have an internal louvre that helps minimize light spillage behind the fixture, but they don't cut off the light quite as quickly as the more commercial looking LED fixtures. By lowering the poles to 15' these fixtures will now be completely below the adjacent elevation of 2nd floor residential windows.



The building elevation has been updated to show a parapet height of 20' minimum. The front façade has a glass door and adjacent window to total 51% transparency between 2' and 8' from the ground. The City requirement is to provide a minimum of 70% transparency. It should be noted that it appears there was a miscalculation on the City Code review requirement, the total frontage area is 172.75 SF (between 2' and 8' above grade). The 70% requirement would be 130.93 SF and we are proposing 87.6 SF. Based on the tower element and the structural elements, it isn't feasible to meet the 70% requirement. The windows will be clear (no tinting) and nothing will be placed in front of the windows to block them. This area is the front dining room and only chairs/tables will be placed in



front of the windows. As can be seen below, the McDonalds on Mt Hope has spandrel glass and less therefore far under the requires 70% transparency required.



1422-32 Mt Hope Ave

The building design for this Mt Hope location has been significantly upgraded from a typical location to fit in with the neighborhood. As can be been below, the elevation on the left is the restaurant that was recently constructed in New Hartford, NY; compared to the proposed elevation for Mt Hope on the right.



New Hartford NY

Mt Hope Ave, Rochester NY

Enclosures:

The following documents are being provided via email for your review.

- 1. Revised Site Plan incorporating the above referenced items
- 2. Other locations site plans showing multi-entrance to drive thru lane
- 3. Prior sketch plans with mark-ups
- 4. Updated photometric plan
- 5. Updated landscape plan
- 6. Updated building elevation showing 20' minimum
- 7. Parking demand analysis

We look forward to continued collaboration with the City. Should you have any questions, comments, or are in need of additional information, please feel free to contact me (salbright@apd.com, 585-742-0204)

Sincerely,

Scaphania allighe

Stephanie Albright, P.E. Senior Civil Engineer

cc: M. McCracken (Hospitality Syracuse, Inc.)

B. Brugg, Esq. (Woods Oviatt)



Neighborhood and Business Development 30 Church St. Rm. 125-B Rochester, NY 14614 www.cityofrochester.gov

Project Review Committee (PRC) Agenda

Date: Wednesday, April 27, 2022

Time: 4:00 p.m.

Location: City Hall, NBD Commissioner's Conference Room

30 Church St. Rm. 223-B Rochester, NY 14614


Case Number:	1
File Number:	SP-001-21-22
Case Type:	Major Site Plan Review
Address:	1737 Mt Hope Av, 20 Elmerston Rd, and 35 Shelbourne Rd
Zoning:	C-2 Community Center District
Quadrant	Southwest
Applicant:	Mike McCracken, Hospitality Syracuse
Request:	To construct a one story +/- 2,000 square foot, two lane drive-through restaurant and a 32 space parking lot. The proposal includes the rezoning of 20 Elmerston Rd, and 35 Shelbourne Rd from R-1 to C-2, and the demolition of a 4,300 square foot commercial building and a 1,470 square foot single family dwelling.
Review Requirement:	120-191D(3)(c)[4] Construction of any principal building in the C-1, C-2, H-V or PMV Districts that does not meet City-wide design standards set forth in this chapter; 120-191D(3)(a)[1] New construction that does not meet the City-wide design standards set forth in this chapter; 120-191D(3)(b)[2] Prior to demolition, any site preparation, development or redevelopment where demolition is proposed in the C-1, C-2, and Village Center Districts; 120-191D(3)(b)[3][d] Conversion to or from any of the following vehicle-related uses or the development or redevelopment of any sites devoted to such uses, including: drive-through facilities and uses.
Enforcement:	No
SEQR:	Unlisted
Lead Agency:	Manager of Zoning
Contact:	Marcia Barry, siteplanreview@cityofrochester.gov

Case Number:	2
File Number:	SP-012-21-22
Case Type:	Minor Site Plan Review
Address:	242, 246 Ormond St, and 3 Leopold St
Zoning:	M-1 Industrial District
Quadrant	Northeast
Applicant:	John Cooper, Rochester Storage QOZ, LLC
Request:	To establish a self-service storage operation consisting of 130 containers to be used as individual storage units and to be placed on the project site (not within a fully enclosed building). Proposal includes resubdividing the subject properties.
Review Requirement:	120-191D(3)(a)[10]Projects involving or abutting a designated landmark or those involving or abutting a site listed or eligible for listing on the State or National Register of Historic Places.
Enforcement:	No
SEQR:	Unlisted
Lead Agency:	Manager of Zoning
Contact:	Anna Keller, siteplanreview@cityofrochester.gov

Case Number:	3
File Number:	SP-033-21-22
Case Type:	Major Site Plan Review
Address:	99, 102, 119-125, 129-131, 133, 139, 141 W Main St, 10, 16 S Washington St, and 19-29 S Plymouth Av
Zoning:	CCD-M Center City Main Street District
Quadrant	Southwest
Applicant:	David Gleghorn, H.E.L.P. Development Corporation
Request:	To construct a 191,000 sq. ft., five-story, mixed use building (161 residential units plus tenant amenity space and 3,271 sq. ft. of commercial space) with 102 below grade parking spaces. The project site is comprised of 10 parcels that are proposed to be combined into one lot with a total area of 1.16 acres. Work scope includes the closure of three curb cuts, the creation of one curb cut, and the abandonment of the Melvin Al and Scott Al rights-of-way.
Review Requirement:	120-191D(3)(c)[2] Applications in the CCD that include major deviations from the design criteria.
Enforcement:	No
SEQR:	Unlisted
Lead Agency:	Manager of Zoning
Contact:	Anna Keller, siteplanreview@cityofrochester.gov

Case Number:	4
File Number:	SP-020-21-22
Case Type:	Major Site Plan Review
Address:	11 Cairn St
Zoning:	M-1 Industrial District
Quadrant	Southwest
Applicant:	Premier Metal Group, LLC
Request:	To construct a one-story, 12,250 square foot building with two loading bays, a recessed loading dock, and a 13 space parking lot to serve the metal scrapping/reclamation business.
Review Requirement:	120-191D(3)(c)[1]All Type I actions as identified in § 48-4 of the City Code, excluding applications requiring certificates of appropriateness.
Enforcement:	No
SEQR:	Unlisted
Lead Agency:	Manager of Zoning
Contact:	Kate Powers, siteplanreview@cityofrochester.gov

Case Number:	5
File Number:	SP-010-21-22
Case Type:	Major Site Plan Review
Address:	786 N Goodman St
Zoning:	C-2 Community Center
Quadrant	Southeast
Applicant:	Trish Rissone, ESL Federal Credit Union
Request:	To construct a one-story, 5,600 square foot bank building with a four-lane drive-through and a 36-space parking lot. Work scope includes demolition of a one-story, 1,806 square foot commercial building.
Review Requirement:	120-191D(3)(c)[4]Construction of any principal building in the C-1, C-2, H-V or PMV Districts that does not meet City-wide design standards set forth in this chapter.
Enforcement:	No
SEQR:	Unlisted
Lead Agency:	Manager of Zoning
Contact:	Anna Keller, siteplanreview@cityofrochester.gov

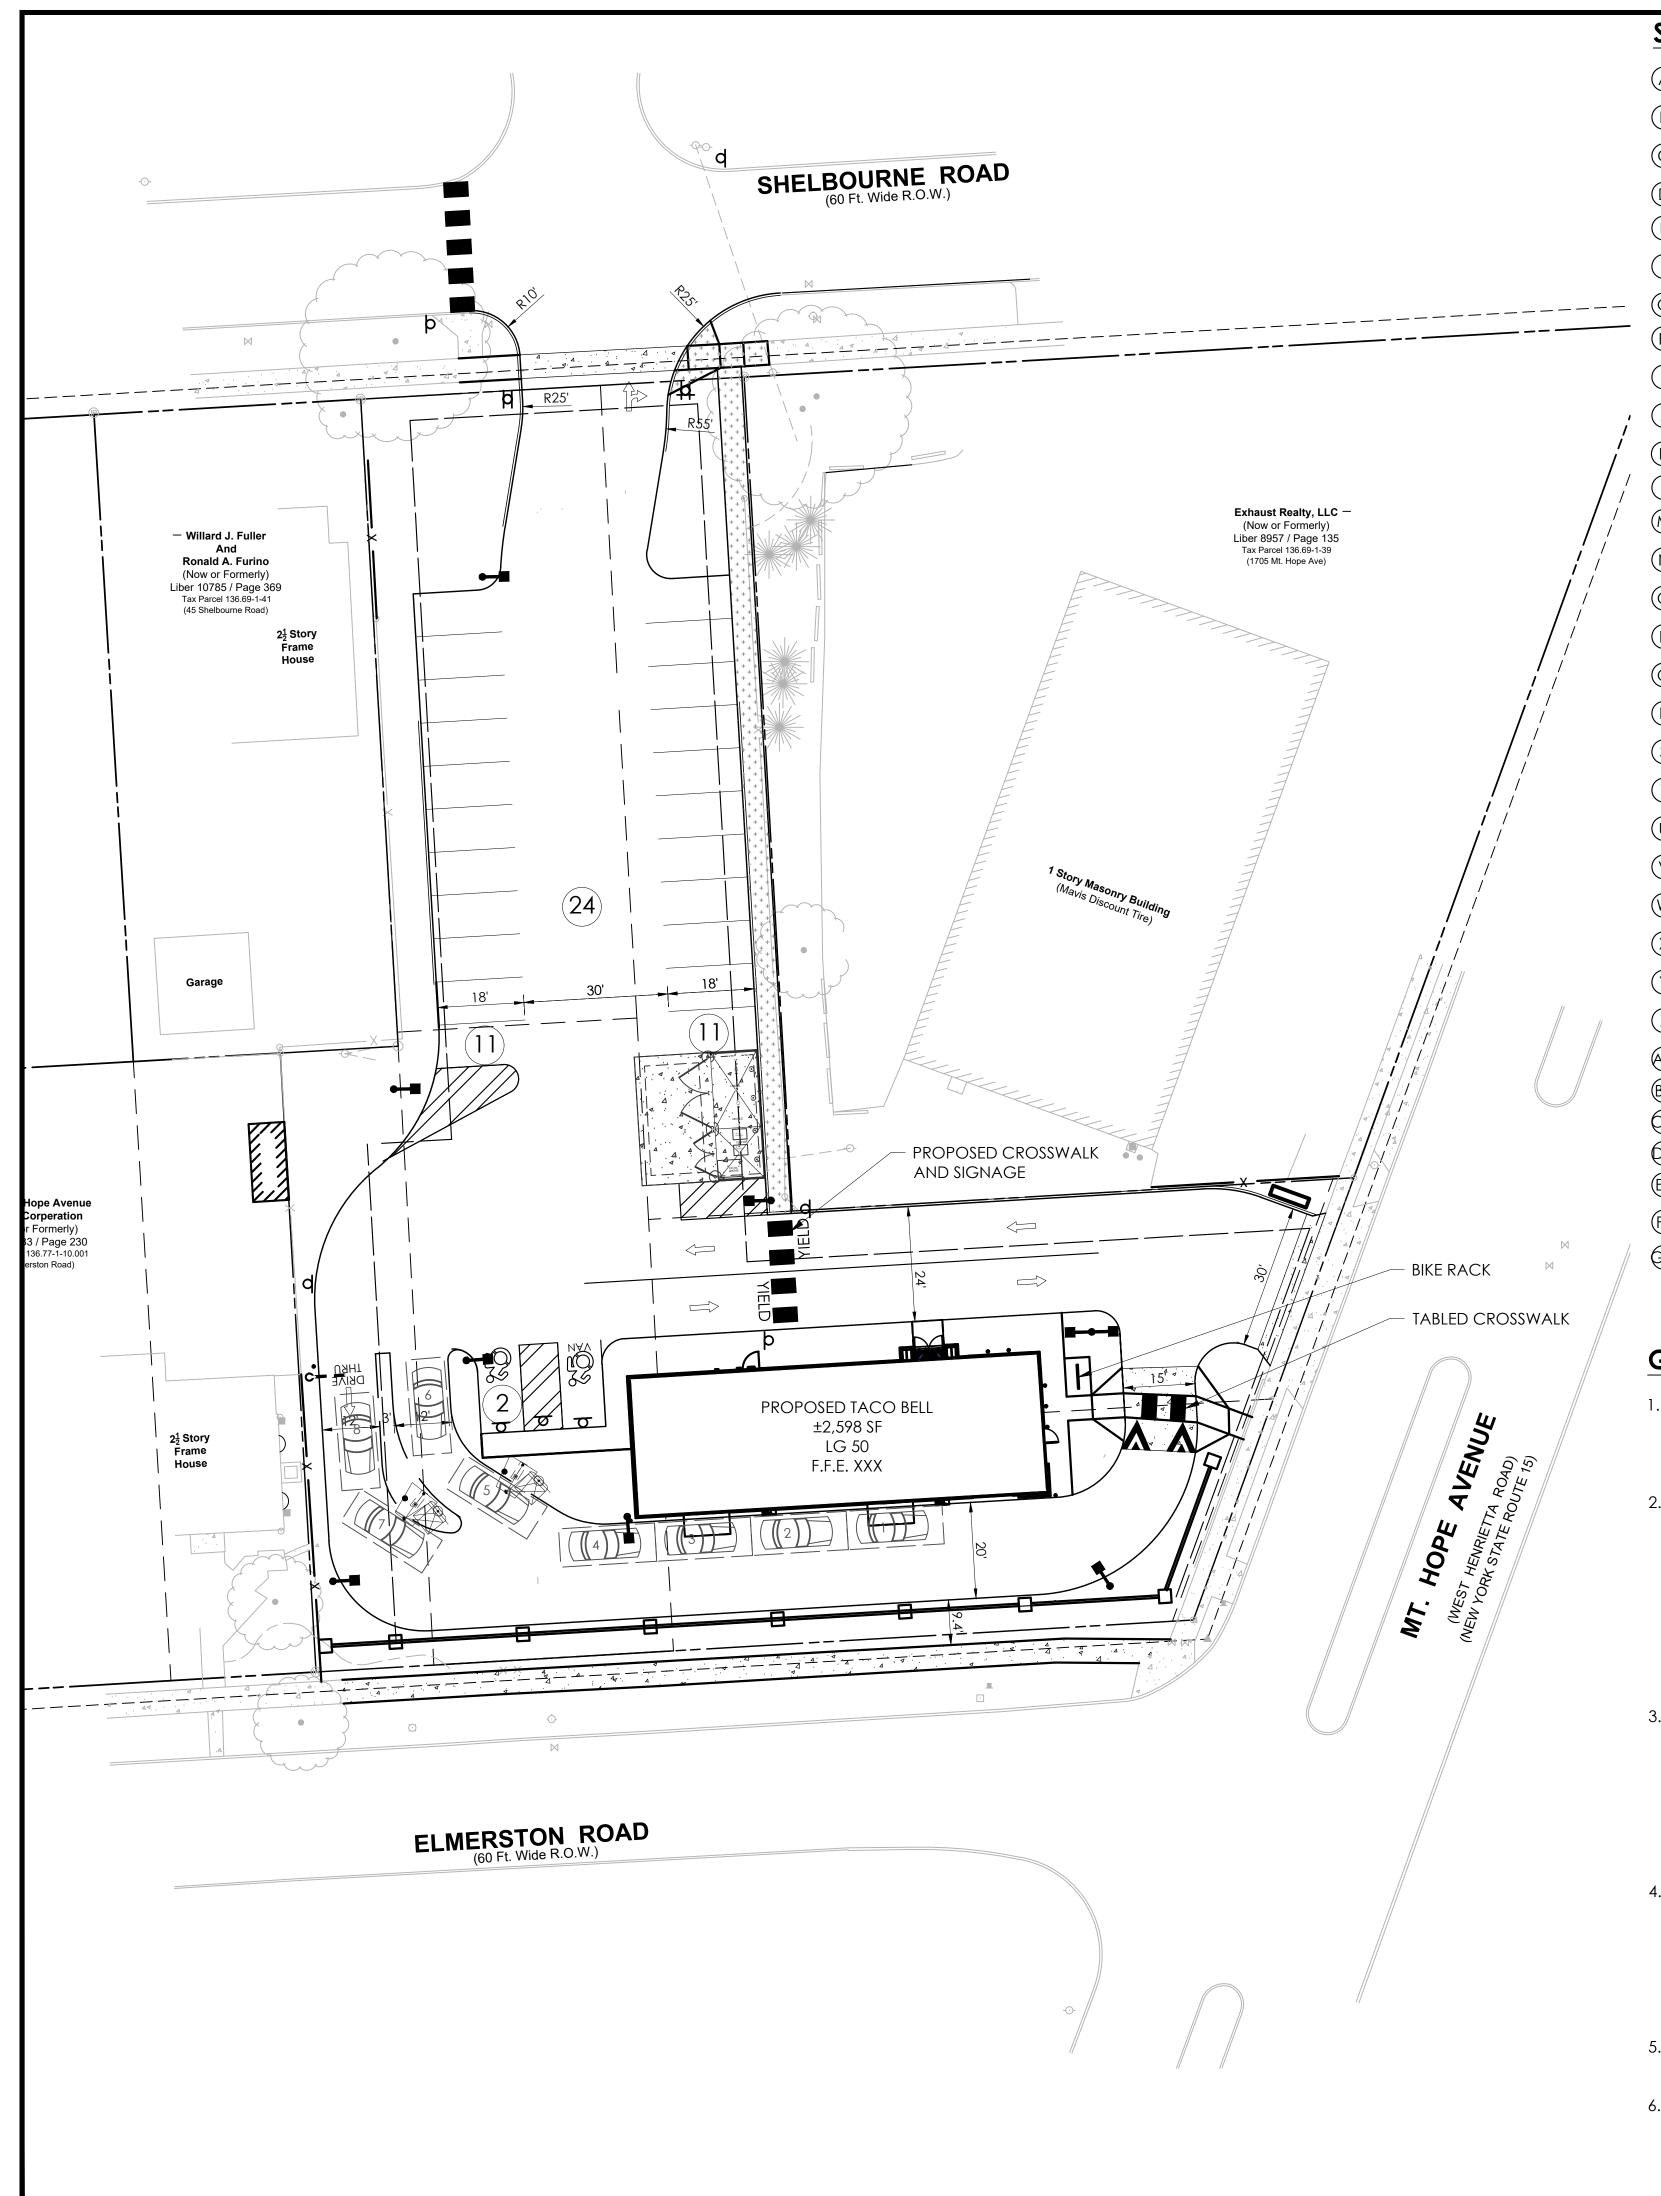

SITE LEGEND:

- ACCESSIBLE PARKING SIGN, POST & BOLLARD (REFER TO
- (B) PAINTED ACCESSIBLE PARKING SYMBOL (REFER TO DETAIL)
- "NO PARKING ANY TIME" SIGN, POST & BOLLARD (REFER TO DETAIL)
- "VAN ACCESSIBLE" STRIPING AND SIGN (REFER TO DETAIL)
- PAINTED PARKING ISLAND AREA TO BE STRIPED WITH 4" SYSL @ 2'-0" O.C. AND AT 45° TO PARKING SPACE.
- (F) SYSL/4" PARKING STALL STRIPING
- (G) PAVEMENT MARKINGS ARROWS (REFER TO DETAIL)
- TABLED CROSSWALK AND SIGNAGE (REFER TO DETAIL)
- (I) REGULAR DUTY PAVEMENT (REFER TO DETAIL)
- (J) HEAVY DUTY PAVEMENT (REFER TO DETAIL)
- (K) HEAVY DUTY CONCRETE (REFER TO DETAIL)
- CONCRETE SIDEWALK (REFER TO DETAIL)
- CONCRETE CURB (REFER TO DETAIL)
- (N) TRANSITION CURB (REFER TO DETAIL)
- ADA RAMP AND DETECTABLE WARNING (REFER TO O DETAIL)
- (P) BOLLARDS (REFER TO ARCH. PLAN DETAIL)
- LAWN/MULCH AREA (REFER TO PLANTING PLAN FOR Q DELINEATION)
- (R) LIGHT POLE (REFER TO DETAIL)
- (S) CANOPY & SPEAKER BOX (REFER TO DETAIL)
- (T) SPEAKER BOX (REFER TO DETAIL)
- (U) DRIVE THRU SIGN (PROVIDED BY SIGN VENDOR)
- (V) TACO BELL LOGO SIGN (PROVIDED BY SIGN VENDOR)
- (W) TACO BELL EXIT SIGN (PROVIDED BY SIGN VENDOR)
- (X) TACO BELL ENTER SIGN (PROVIDED BY SIGN VENDOR)
- (Y) NO LEFT TURN SIGN
- (Z) CONCRETE DUMPSTER PAD (REFER TO ARCH. PLANS)
- (A) MENU BOARD (REFER TO DETAIL)
- CLEARANCE BAR (REFER TO DETAIL)
- PREVIEW BOARD (REFER TO DETAIL)
- (D) TACO BELL 'THANK YOU' SIGN (PROVIDED BY SIGN VENDOR)
- 'DO NOT ENTER' SIGN (PROVIDED BY SIGN VENDOR)
- (FF) 5' HIGH SOLID WALL (REFER TO DETAIL)
- G SINGLE YELLOW SOLID LINE/4" WIDE

GENERAL NOTES:

- ALL IMPROVEMENTS SHALL BE IN ACCORDANCE WITH THE MOST RECENT STANDARDS AND SPECIFICATIONS OF THE CITY OF ROCHESTER AND/OR THE APPROPRIATE WATER, SEWER AND/OR DRAINAGE DISTRICTS, AND/OR OTHER AUTHORITIES HAVING JURISDICTION.
- 2. ALL EXISTING BUILDING(S), SITE, ROADWAY, UTILITY, BOUNDARY, AND TOPOGRAPHY INFORMATION SHOWN ON THIS PLAN IS REPRESENTED BASED ON USE OF THE LISTED REFERENCES. CONTRACTOR TO VERIFY LOCATION AND LIMITS OF WORK PRIOR TO STARTING. ANY CHANGES OR CONFLICTS DISCOVERED SHALL BE BROUGHT TO THE ATTENTION OF THE OWNER AND ENGINEER. IF CONTRACTOR DOES NOT ACCEPT EXISTING TOPOGRAPHY AS SHOWN ON THE PLANS, WITHOUT EXCEPTION, HE SHALL HAVE MADE, AT HIS EXPENSE, A TOPOGRAPHIC SURVEY BY A REGISTERED LAND SURVEYOR AND SUBMIT IT TO THE OWNER FOR REVIEW.
- 3. CONTRACTOR SHALL REFER TO ARCHITECTURAL PLANS FOR EXACT LOCATIONS AND DIMENSIONS OF VESTIBULE, SLOPED PAVING, EXIT PORCHES, RAMPS, PRECISE BUILDING DIMENSIONS, AND EXACT BUILDING UTILITY ENTRANCE LOCATIONS. ALL PAVING, CURBING, FLATWORK, SIDEWALKS, FENCING, BOLLARDS, ETC., WHICH CONFLICT WITH NEW CONSTRUCTION ARE TO BE DEMOLISHED AND DISPOSED OF IN ACCORDANCE WITH ANY LOCAL, STATE, OR FEDERAL REGULATIONS.
- 4. CONTRACTOR MUST PROTECT THE PUBLIC AT ALL TIMES WITH FENCING, BARRICADES, ENCLOSURES, ETC. CONTRACTOR SHALL MAINTAIN ALL EXISTING PARKING, SIDEWALKS, DRIVES, ETC. OUTSIDE OF WORK LIMITS CLEAR AND FREE FROM ANY CONSTRUCTION ACTIVITY AND/OR MATERIAL TO ENSURE EASY AND SAFE PEDESTRIAN AND VEHICULAR TRAFFIC TO AND FROM THE SITE. SIDEWALKS WITHIN R.O.W. SHALL REMAIN OPEN AT ALL TIMES DURING CONSTRUCTION.
- 5. REFER TO THE SURVEY FOR THE PROPERTY BOUNDARY INFORMATION (E.G. LOT AREA, BEARINGS, DISTANCES, ETC).
- 6. THE SITE IS IN FLOOD ZONE X, AREAS DETERMINED TO BE OUTSIDE 500-YEAR FLOODPLAIN, AS SHOWN ON FLOOD STUDY INSURANCE MAP OF CITY OF ROCHESTER PUBLISHED BY FEDERAL EMERGENCY MANAGEMENT AGENCY, COMMUNITY PANEL NO. 36055C0351G, MAP EFFECTIVE DATE 08/28/08.

REFERENCE:

- PICTOMETRY AERIAL IMAGERY ALTA/NSPS LAND TITLE SURVEY
- LANDS OF 1737 MT HOPE AVE AND 35 SHELBOURNE RD, PROJECT NUMBER 2021.045.001, PREPARED BY JACOBS LAND SURVEYING, LAST REVISED OCTOBER 12, 2021.

SITE NOTES:

OTHERWISE NOTED.

SAID ZONING REQUIREMENTS.

1. ALL NEW PAINTED PAVEMENT MARKINGS SUCH AS DIRECTIONAL

2. ALL DIMENSIONS AND RADII ARE TO THE FACE OF CURB UNLESS

ARROWS AND LETTERING SHALL BE PAINTED USING TEMPLATES.


3. THE SETBACK LINES AND NOTES RELATED TO SETBACKS SHOWN HEREIN

INTENDED TO IMPOSE ANY ADDITIONAL RESTRICTIONS OTHER THAN

4. REFER TO LIGHTING PLAN, SHEET C5, FOR LIGHT POLE AND BUILDING

MOUNTED LIGHT LOCATIONS, AND FIXTURE TYPE.

ARE INTENDED TO SHOW APPLICABLE ZONING REQUIREMENTS OF THE CITY OF ROCHESTER AS OF THE DATE OF THIS PLAN AND ARE NOT

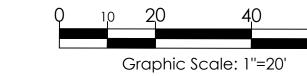

AS REQUIRED BY NEW YORK STATE LAW, CONTRACTOR SHALL CONTACT "DIG SAFELY NEW YORK" (UFPO) @ 1-800-962-7962 FOR LOCATION STAKE-OUT OF ALL UTILITIES, AT LEAST 2 FULL WORKING DAYS PRIOR TO ANY EXCAVATION.

LEGEND OF IMPROVEMENTS


BACK OF CURB	FACE OF CURB/BACK OF CURB
	SUBJECT PARCEL PROPERTY LINE
	SETBACK LINE
	PROPOSED BUILDING CONCRETE SIDEWALK (REFER TO DETAIL)
4	HEAVY DUTY CONCRETE (REFER TO DETAIL)

HEAVY DUTY PAVEMENT (REFER TO DETAIL) PEDESTRIAN CROSSWALK (REFER

LIGHT POLES

11/12/2 City of Rocheste City of Rochester Date Revisions: Per City Site Plan comments

Issued:

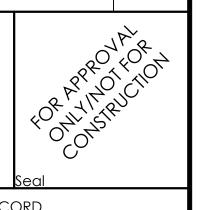

CIVIL ENGINEER OF RECORD Name: Stephanie L. Albright New York License No.: 087051 Exp. Date. December 31, 2023 Firm Reg. No.: 0014815 Exp. Date: December 31, 2023

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Hospitality Syracuse, Inc

Project No.

290 Elwood Davis Road Suite 320 Liverpool, NY 13088 315-451-1957 315-451-9603

Taco Bell - Rochester NY

1737 Mt. Hope Ave City of Rochester

Monroe County

Project Name & Location:

Site Plan - Opt 1

Drawing Name:

Date: 06/10/21 20-0531 Type:

Drawn By: SLA Drawing No. Scale: 1" = 20'

TYLin

City of Rochester Bureau of Buildings and Zoning 30 Church St. Rm. 125B Rochester, NY 14614

ATTN: Anna Keller

RE: 242, 246 Ormond St, and 3 Leopold St

Dear Ms. Keller,

On February 16th, we participated in a virtual Project Review Committee meeting to discuss our client's proposed development of the vacant parking lot located at 246 Ormond Street. Having had previous discussions with the City and having previously revised the site plan in accordance with suggestions made by the City, there were three outstanding items remaining for resolution.

- 1. Non-conforming features with respect to the following local laws:
 - a. Code Section 120-158B(1) which requires "active building elevations" on new structures including windows;
 - Code Section 120-158B(4) which requires repeating architectural patterns with two or more of the following elements: color change, texture change, material change, or a wall articulation change such as a reveal, recess, offset, or pilaster;
 - c. Code Section 120-158C which requires the front facade and to have a direct pedestrian connection to the street (a front entrance).

As was discussed in the meeting, these provisions of local law do not appear to have considered structures of the type that the owner is proposing (free-standing self-storage steel structures). We presented a sketch showing pilasters to create reveals and recesses having a contrasting color (item c) while acknowledging that items a & b would be difficult to overcome, likely needing a variance.

Jim Yarrington suggested that in lieu of trying to make these storage structures look more like a conventional building, that the installation of an ornamental fence at the right of way might make the project more appealing overall.

Our client was receptive to that idea and is now prepared have us revise the drawings to show a spike-topped black aluminum fence along Ormond Street. The fencing at all interior lot lines would remain galvanized chain-link but could be black in color to match the front fence if that is preferred by the City.

2. Matt Vanderwall advised us that the adjacent building owned by our client located at 444 Central Avenue is currently in violation of a City ordinance due to the broken/boarded up window openings. Matt suggested that his department might consider a variance on the Ormond Street property from the other ordinances (items a & b) more favorably if the owner were willing to correct the deficiencies on the Central Avenue building within a specified period of time.

The subject building is currently used as a self-storage facility where each tenant maintains security on the entry doors to their leasehold space. Consequently, the owner does not have access to the interior storage spaces and no practical ability to affect the displacement of each tenant's storage goods in order to gain access to the interior of the window openings. To overcome this challenge, our client is proposing to install applied window coverings at all 128 openings, consisting of tinted Lexan panels contained within a frame complete with mullions and muntin bars in the larger openings, maintaining the appearance of a typical spandrel glass panel. This will allow the material in the existing openings to remain without disruption to the tenants. The work would be complete per the following schedule:

LOCATION	2022	2023	2024	2025
South Elevation	X			
West Elevation		X		
North Elevation			Х	
East Elevation				Х

3. Lighting Plan.

The City is looking for a lighting plan for general illumination of the 246 Ormand Street site where the storage boxes will be placed.

Attached with this submittal is a lighting plan with photometrics for review.

SUMMARY

The owner's investment in this property was part of a QOZ (qualified opportunity zone) fund, where he had to commit to investing a large sum of money into improvements. He has already spent over \$150,000 for improvements, including:

- Tuckpointing the entire building
- Painting the window frames on the south elevation first floor
- New signage and removal of old awnings

Remaining improvements on the Ormond Street site will need to be made within 2.5 years of purchasing the property, or by January 2023 in order to take advantage of the tax credits. It is therefore important to obtain reasonable assurance that the approvals he is seeking are forthcoming. In order to meet these deadlines, he will need to commit to purchasing goods and services to complete this project.

If this approach to the project is acceptable to the City, we will immediately prepare the variance for your consideration.

Respectfully,

TYLin International Engineering and Architecture, P.C.

James R. Burton

Associate Vice President

C:

John Copper,

Vauus R Centar

Rochester Storage QOZ, LLC

Andrew Collini,

TYLin

Nathan Buczek,

TYLin

ENC:

Lighting Plan w/ Photometrics

LOCATION MAP:

CENTER CITY COURTYARD

20213147.0004

99-141 West Main Street Rochester, NY 14614 MARCH, 2022

DRAWING INDEX:

GENERAL
G-000 COVER PAGE


C-101 FIRST FLOOR SITE PLAN

C-103 SITE AND GRADING EXISTING CONDITIONS

ARCHITECTURAL

A-101 FIRST FLOOR PLAN
A-102 SECOND FLOOR PLAN
A-103 THIRD FLOOR PLAN
A-104 FOURTH FLOOR PLAN
A-105 FIFTH FLOOR PLAN
A-201 EXTERIOR ELEVATIONS
A-202 EXTERIOR ELEVATIONS
A-203 EXTERIOR ELEVATIONS
A-204 CONTEXTUAL ELEVATION



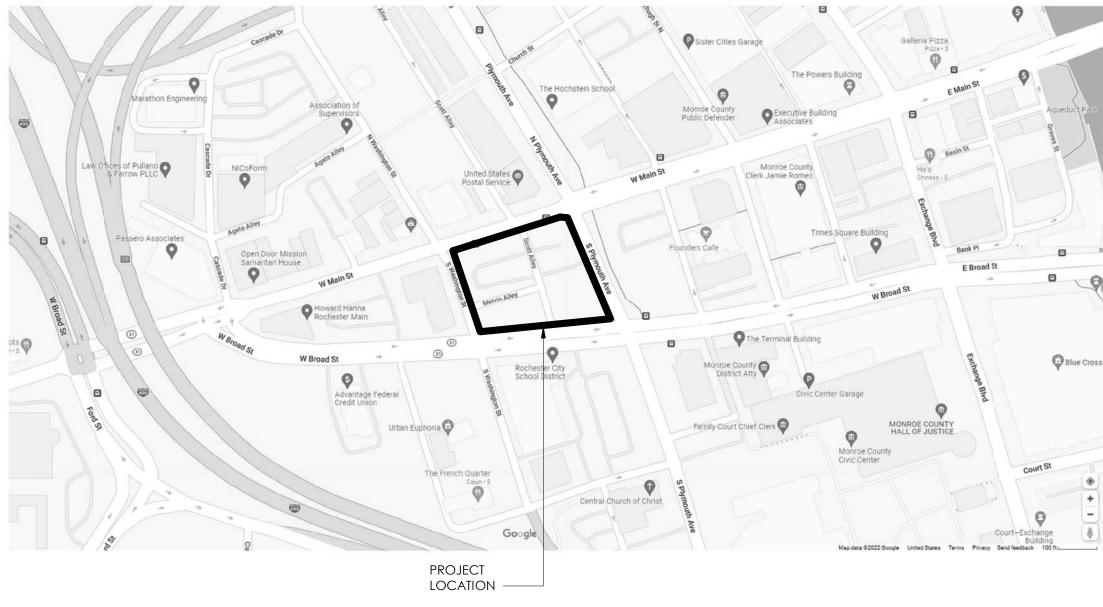

CLIENT:
HELP USA
115 E. 13TH STREET
NEW YORK, NY 10003

ARCHITECTURAL, CIVIL & STRUCTURAL:



242 WEST MAIN ST., SUITE ROCHESTER, NY 14614

(585) 325-1000 FAX: (585) 325-1691




Mechanical/Electrical Engineering Consultants


Rochester | Buffalo | Syracuse | Capital District


300 TROLLEY BOULEVARD ROCHESTER, NY 14606

585.288.5590 www.meengineering.com

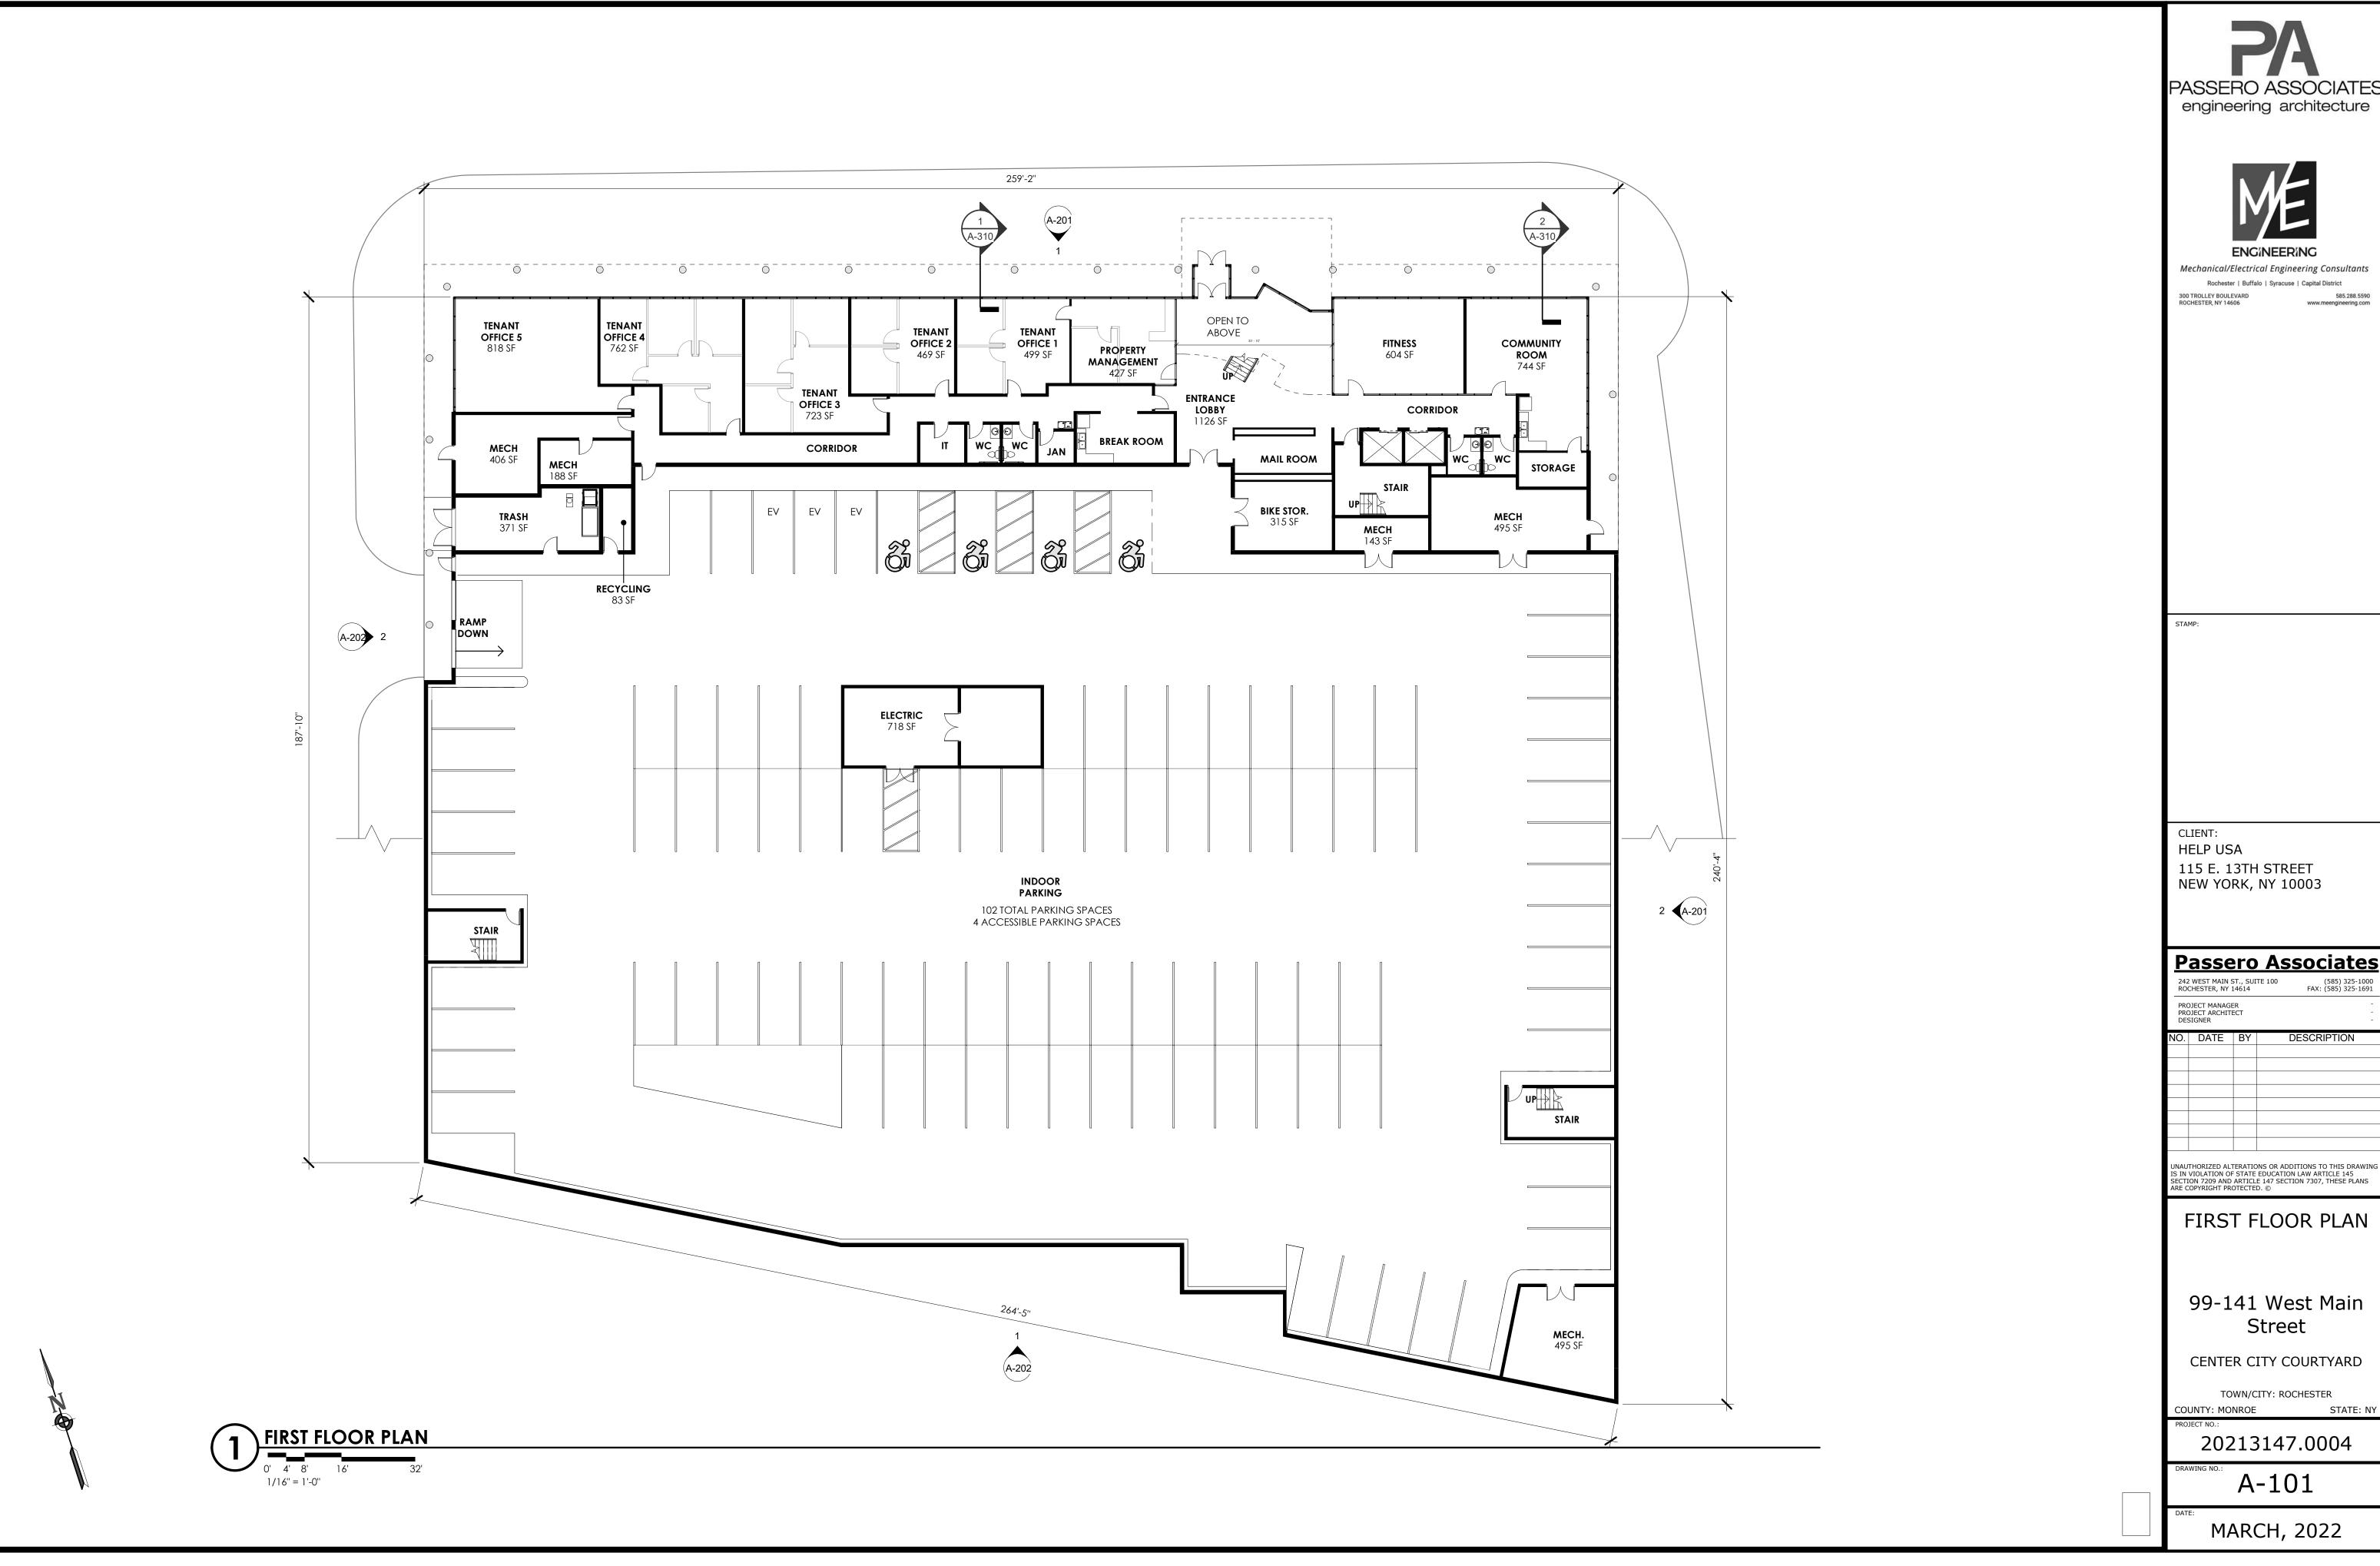

engineering architecture

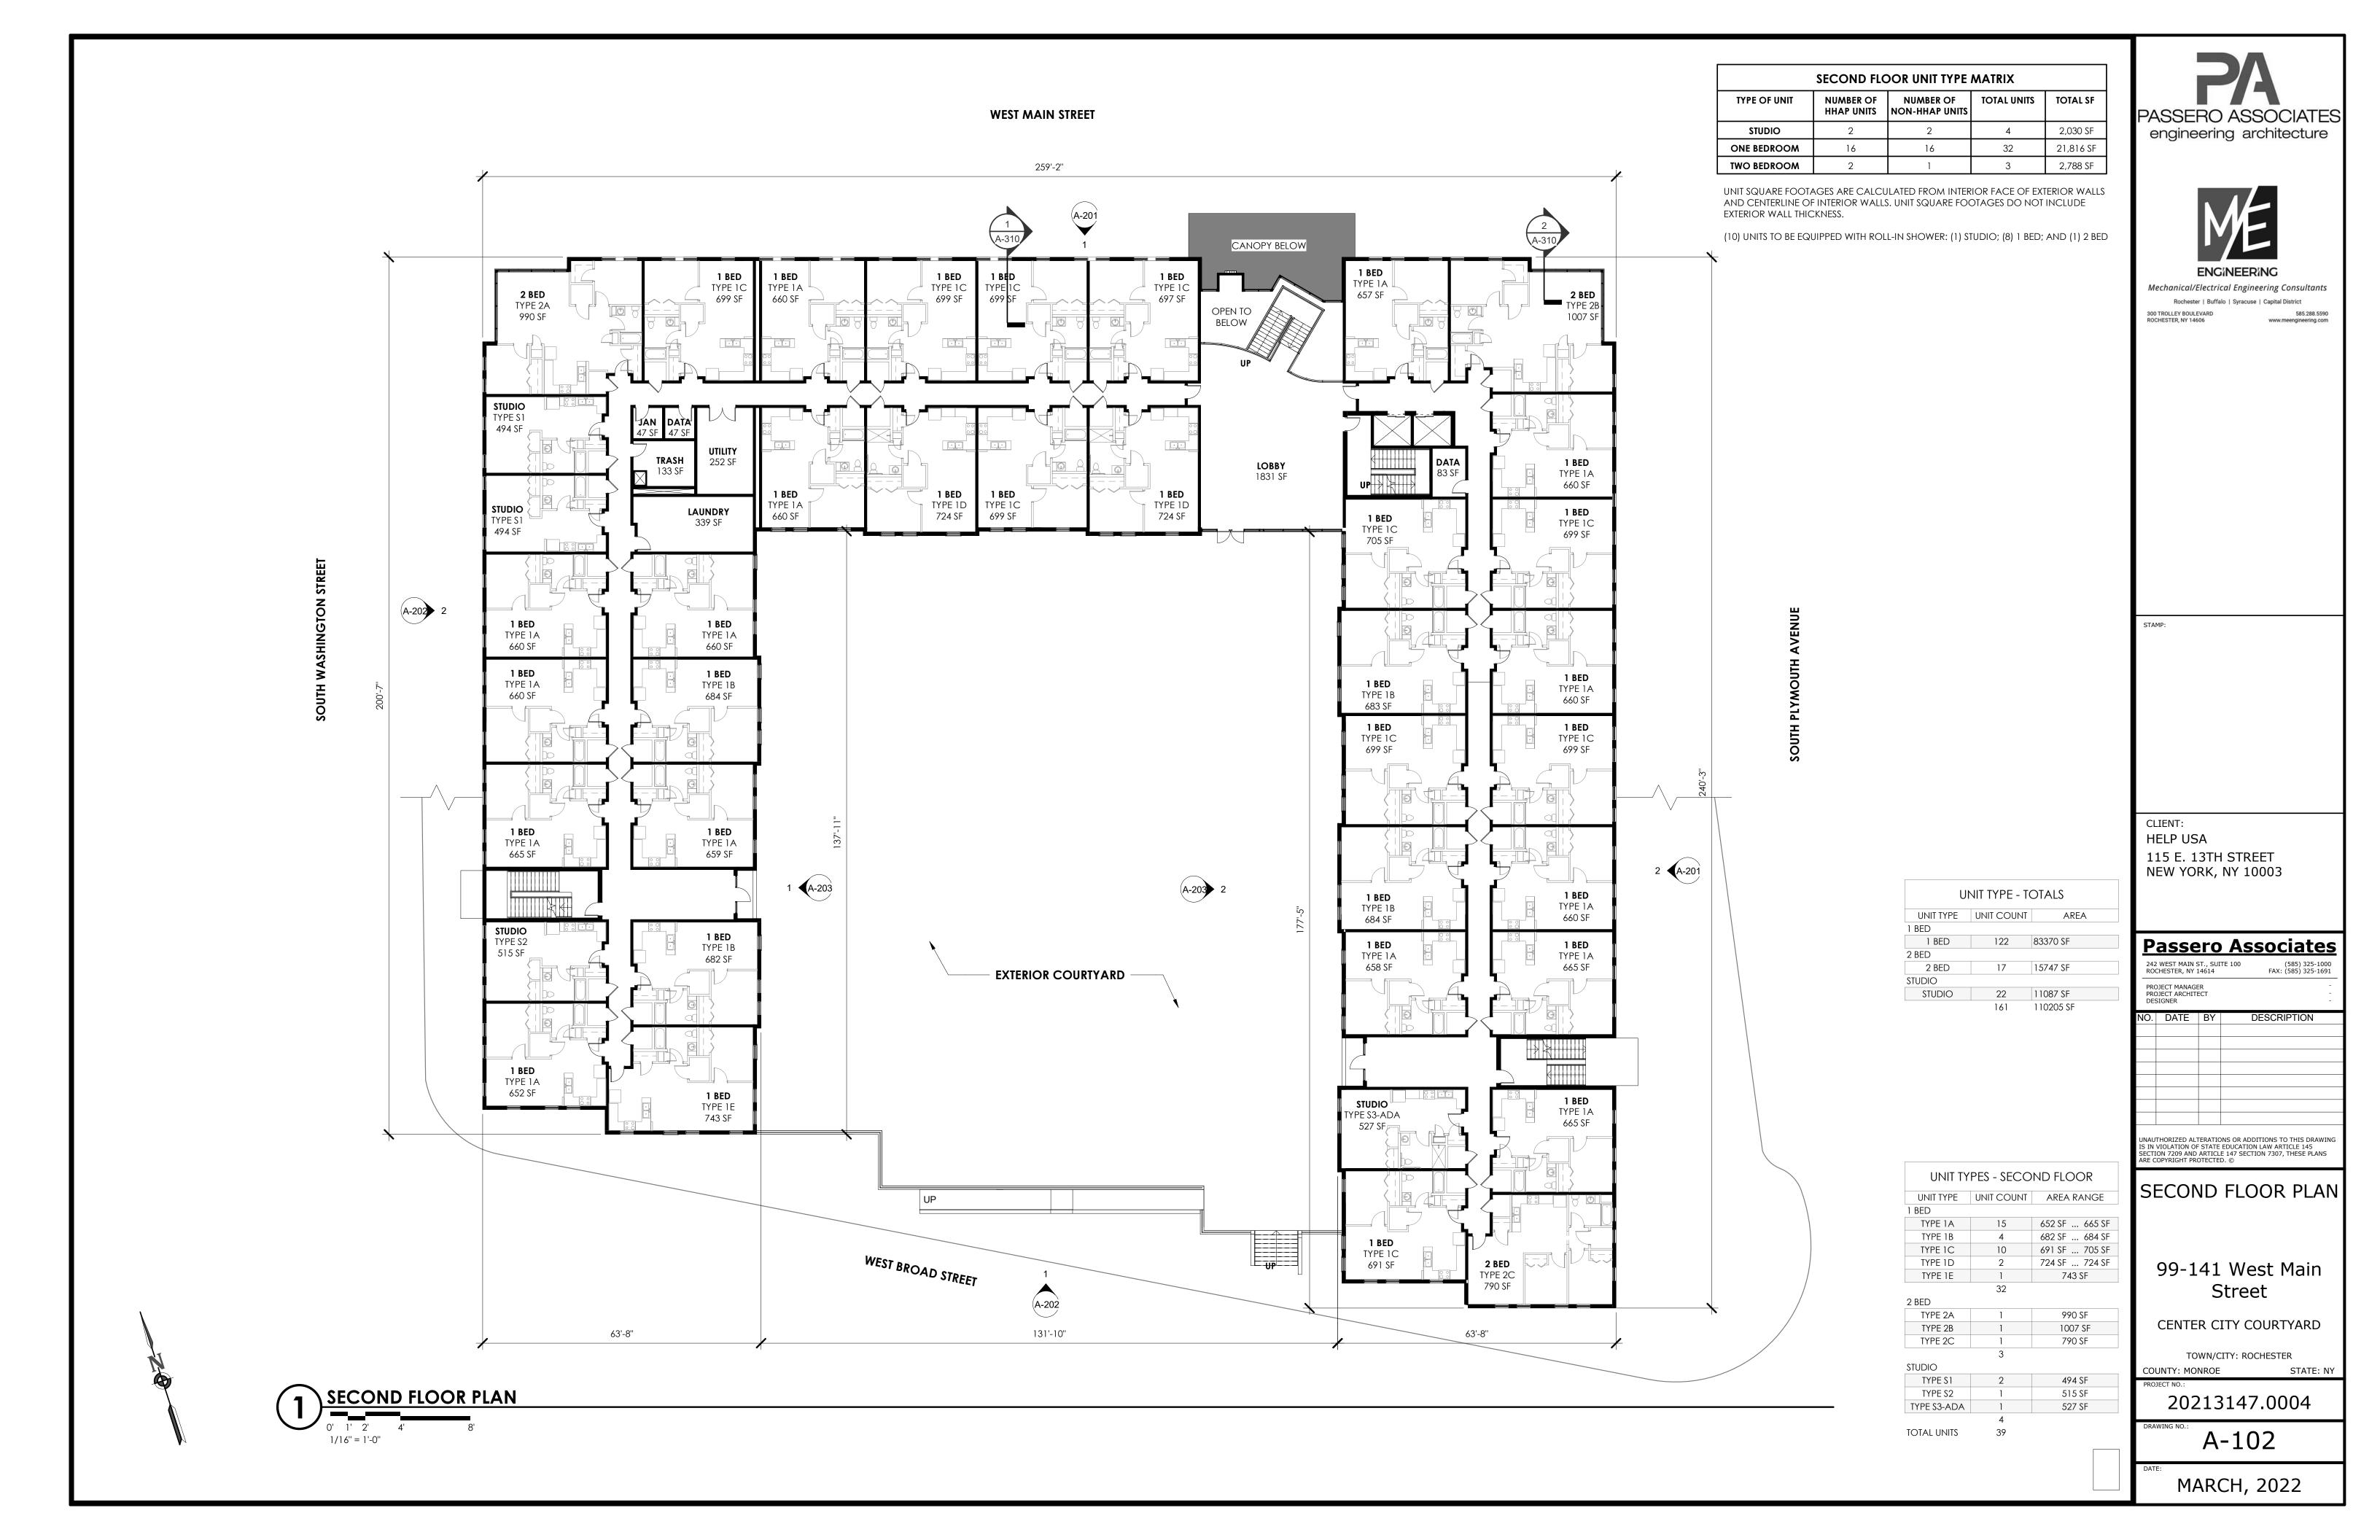


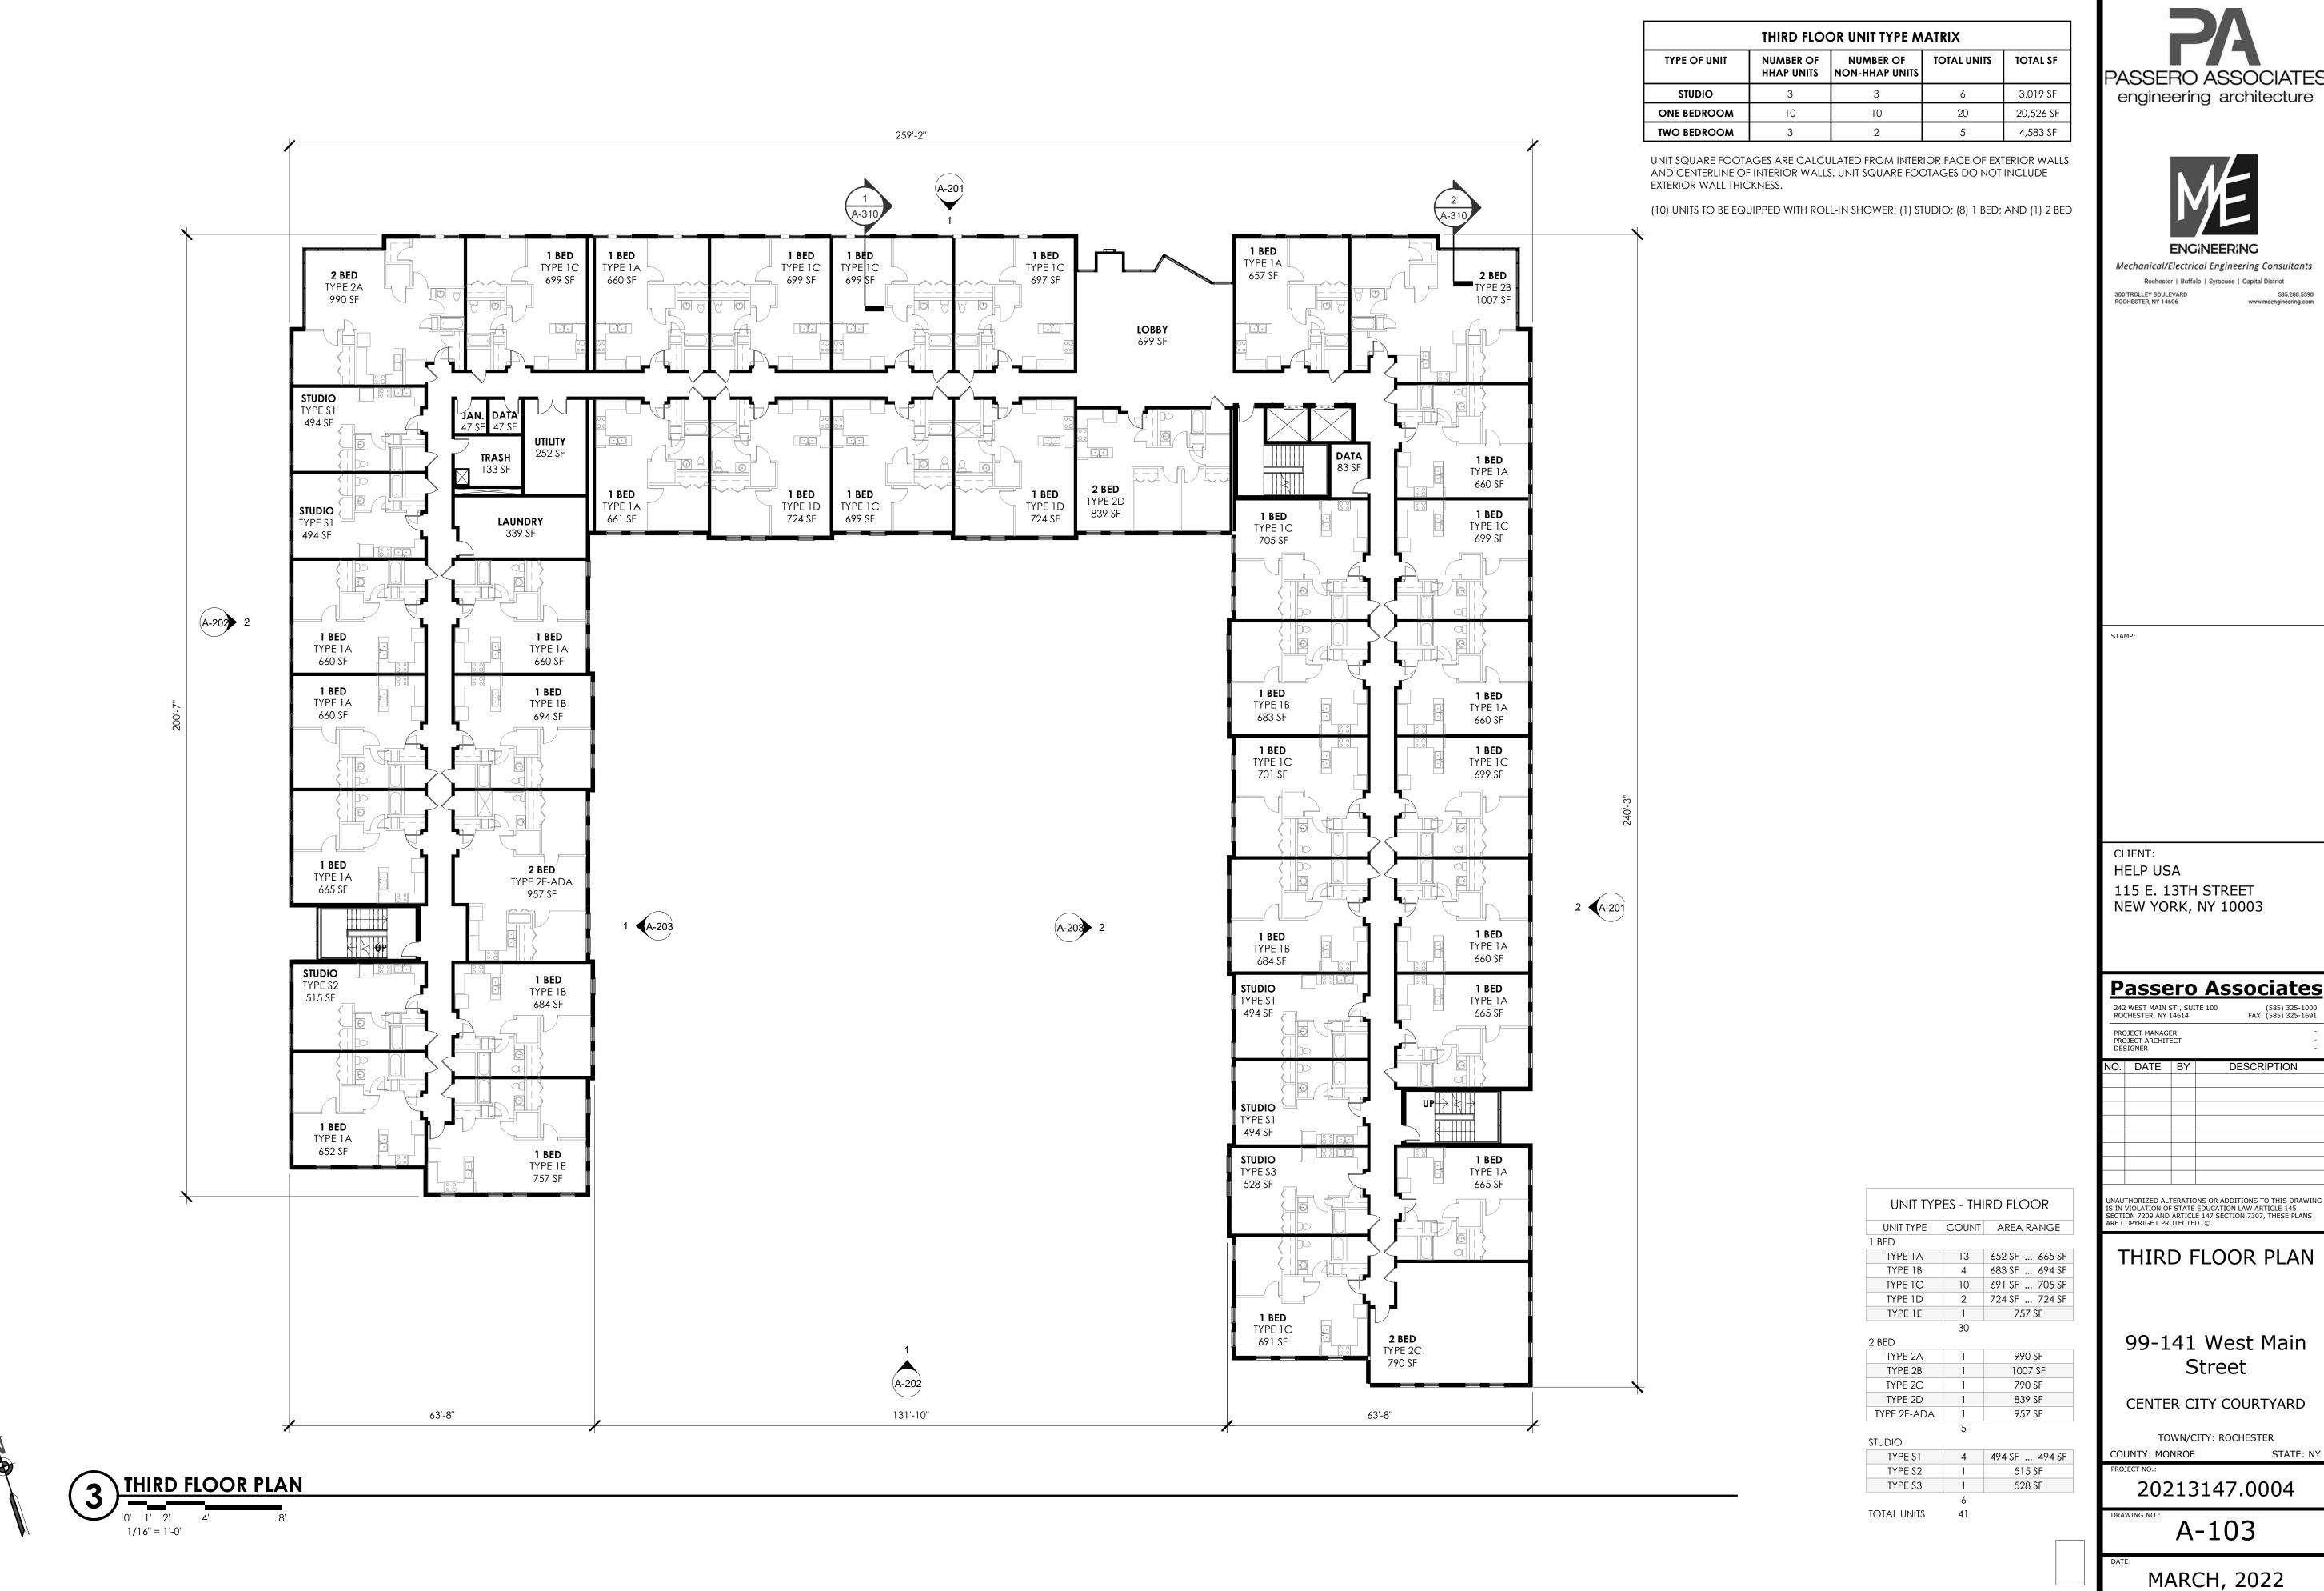




Mechanical/Electrical Engineering Consultants

99-141 West Main

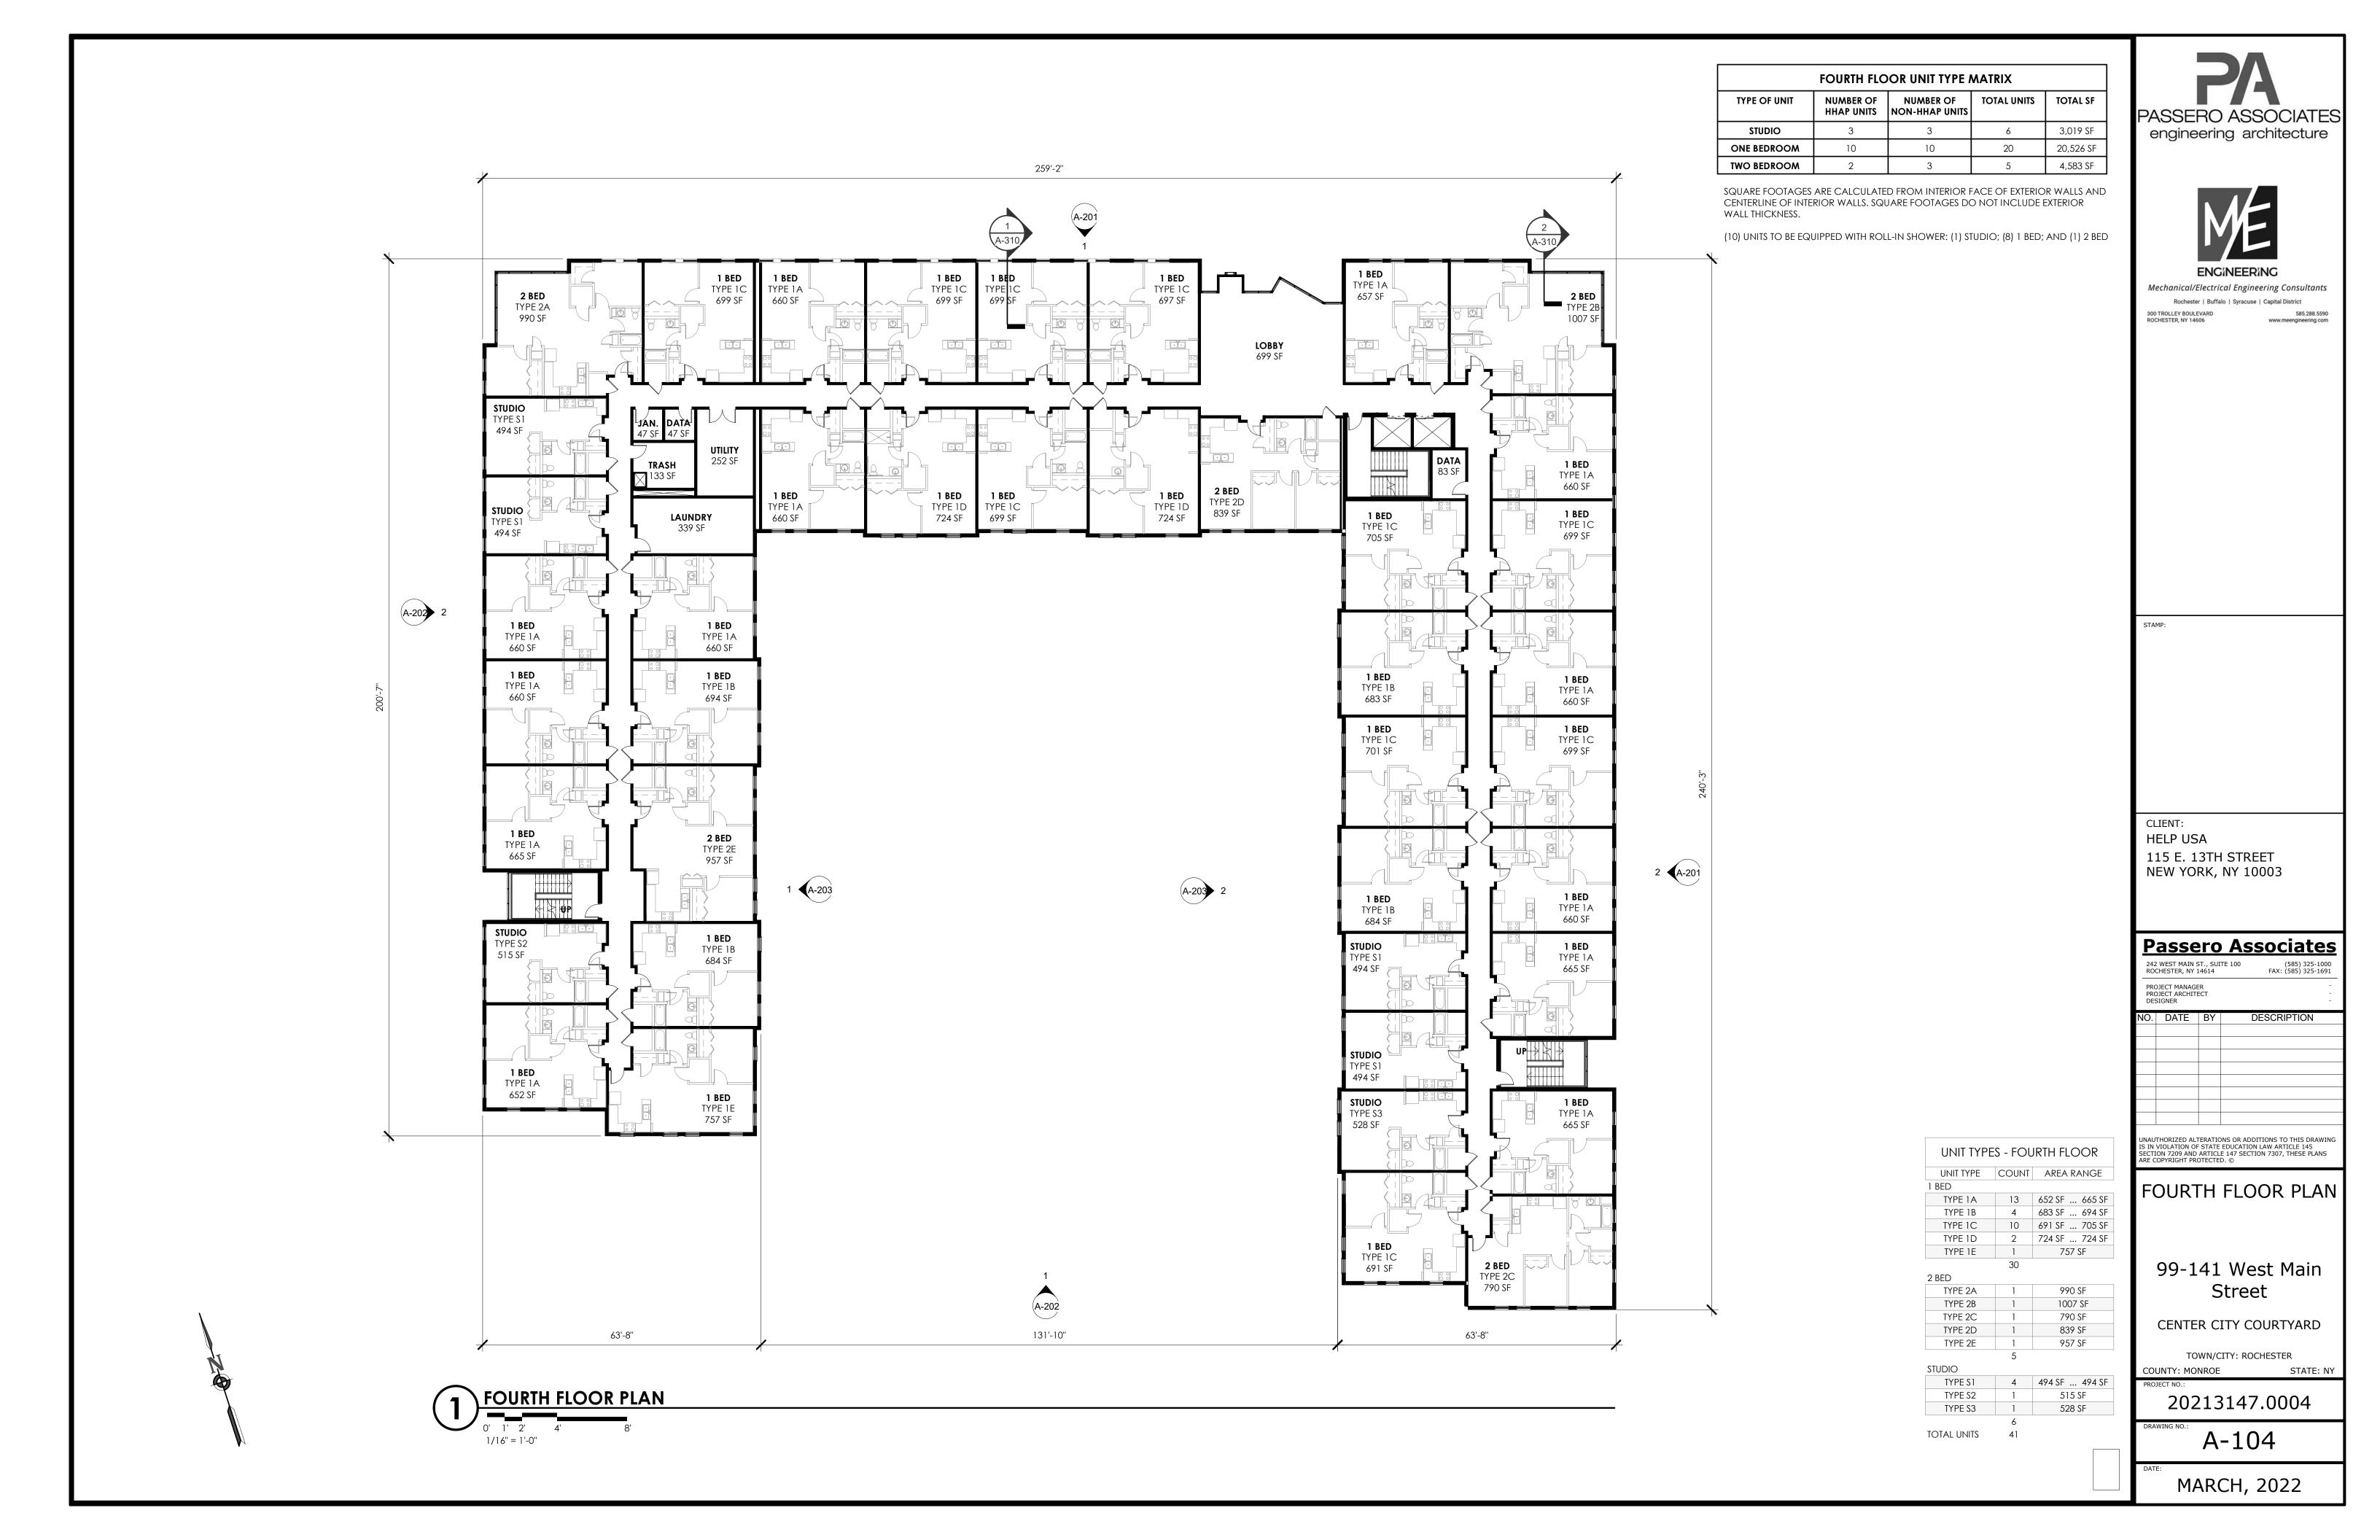

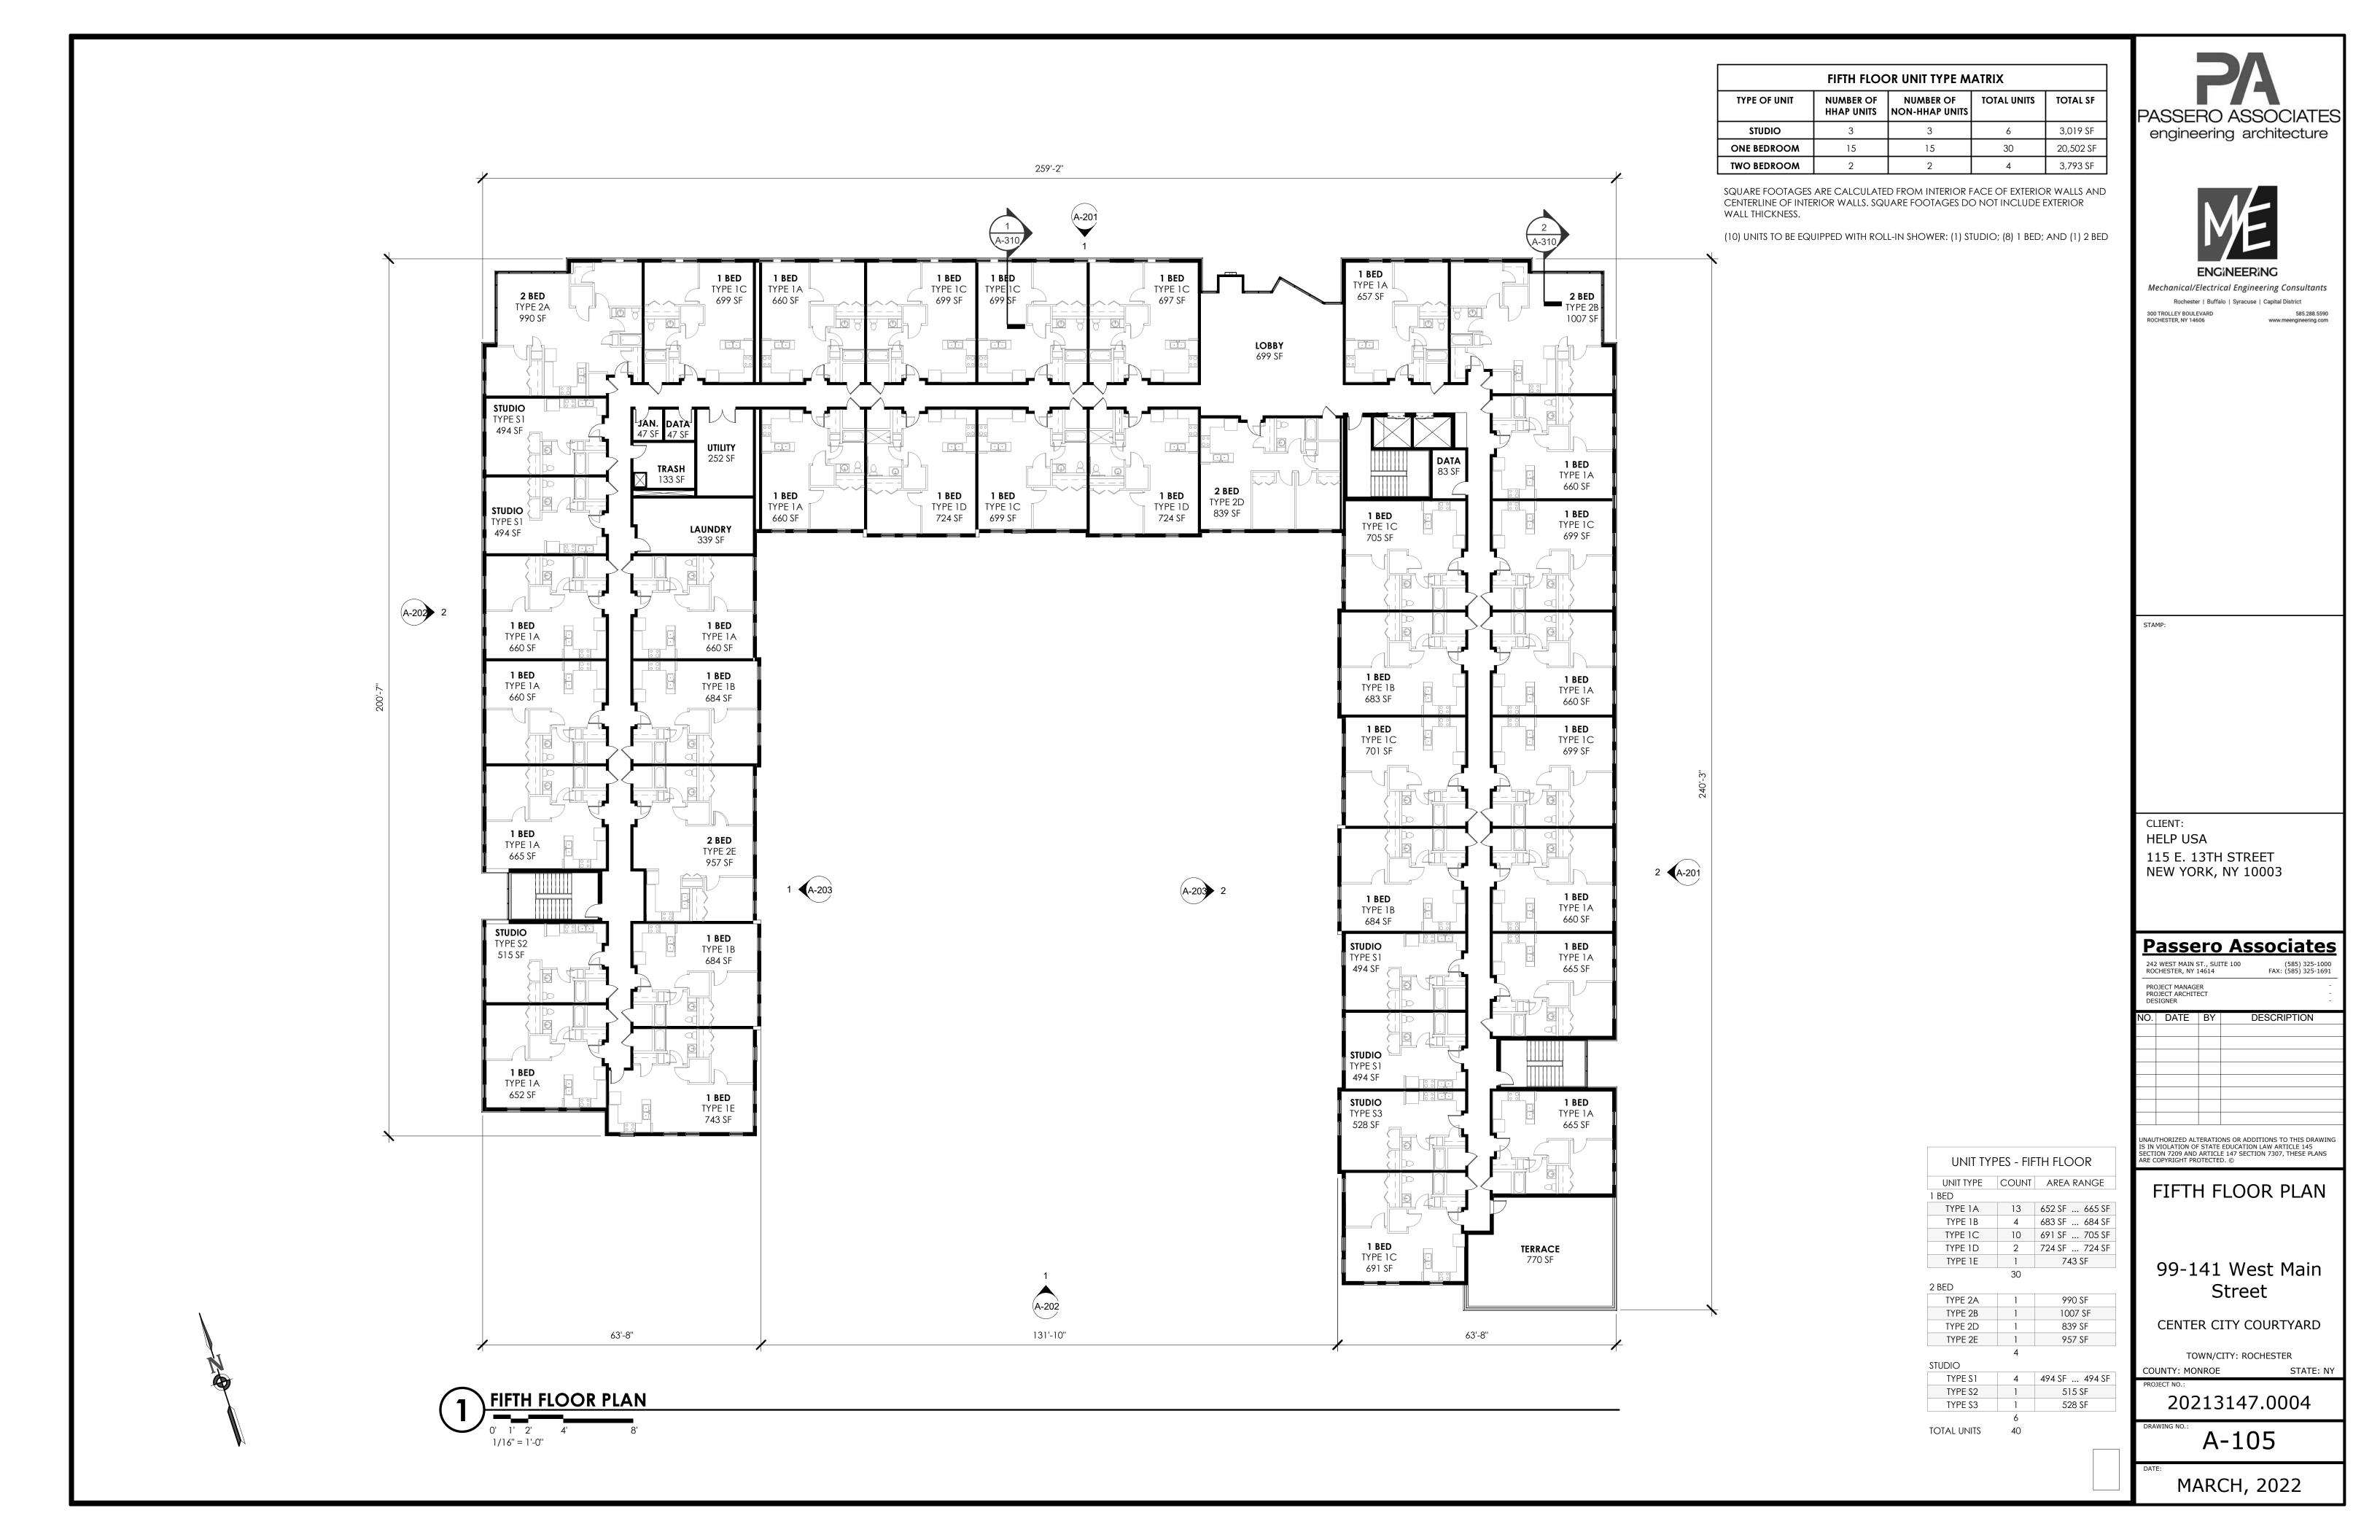







3/32" = 1'-0"



PASSERO ASSOCIATES engineering architecture



Mechanical/Electrical Engineering Consultants

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300 TROLLEY BOULEVARD 585.288.5590
ROCHESTER, NY 14606 www.meengineering.com

STAMP:

CLIENT:
HELP USA
115 E. 13TH STREET
NEW YORK, NY 10003

Passero Associates

242 WEST MAIN ST., SUITE 100 ROCHESTER, NY 14614

PROJECT MANAGER PROJECT ARCHITECT DESIGNER

IO. DATE BY DESCRIPTION

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EXTERIOR ELEVATIONS

99-141 West Main Street

CENTER CITY COURTYARD

TOWN/CITY: ROCHESTER
COUNTY: MONROE ST

ROJECT NO.:

20213147.0004

A-203

MARCH, 2022



NORTH CONTEXTUAL ELEVATION (MAIN ST)

N.T.S.





2 EAST CONTEXTUAL ELEVATION (PLYMOUTH AVE)
N.T.S.



3 SOUTH CONTEXTUAL ELEVATION (BROAD ST)
N.T.S.



WEST CONTEXTUAL ELEVATION (WASHINGTON ST)

N.T.S.

PASSERO ASSOCIATES engineering architecture



echanical/Electrical Engineering Consultants

Rochester | Buffalo | Syracuse | Capital District

STAMP:

CLIENT: HELP USA 115 E. 13TH STREET NEW YORK, NY 10003

Passero Associates

242 WEST MAIN ST., SUITE 100 ROCHESTER, NY 14614

PROJECT MANAGER PROJECT ARCHITECT DESIGNER

DATE BY DESCRIPTION

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CONTEXTUAL ELEVATIONS

99-141 West Main Street

CENTER CITY COURTYARD

TOWN/CITY: ROCHESTER

ECT NO.:

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A-204

MARCH, 2022

